
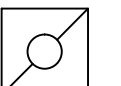
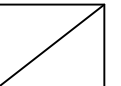
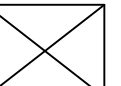






three inches = one foot
one and one half inches = one foot
one inch = one foot
three quarters inch = one foot
one half inch = one foot
three eighths inch = one foot
one quarter inch = one foot
one eighth inch = one foot

LEGEND	
	SPRINKLER
	2X2 LIGHT FIXTURE
	CEILING SUPPLY
	CEILING RETURN
	CUBICLE CURTAIN TRACK
	CEILING LIFT TRACK

NOTES:

1. REPLACE DROP CEILING WITH NEW AS SHOWN, IN AREAS OPENING TO THE CORRIDOR, ALIGN THE NEW CEILING TO THE CORRIDOR CEILING AS SHOWN. MAINTAIN EXISTING LAYOUT ON SPRINKLER HEADS, LOCATIONS SHOWN ARE APPROXIMATE.
2. AIR SUPPLY AND RETURN REGISTERS ARE FOR EXISTING DUCTWORK, INTENTION IS ONLY TO ALIGN TO NEW CEILING GRID. REPLACE ALL REGISTERS IN ROOM H-010 TO MATCH NEW USED IN ROOMS RENOVATED.
3. SIZE ON ALL AIR SUPPLIES AND RETURNS TO MATCH EXISTING.
4. HEIGHT OF ALL DROP CEILINGS AND SOFFITS IS TO BE 8'-6".
5. DEMOLISH EXISTING CEILING LIFT TRACKS, RETAIN CHARGER, CHARGER STATION, AND MOTOR. INSTALL NEW TRACK AT LOCATION SHOWN. DESIGN OF MOUNTING AND INSTALLATION TO BE BY MANUFACTURER APPROVED INSTALLER. INSTALLATION TO INCLUDE LOAD TEST. SUBMIT SHOP DRAWINGS FOR APPROVAL.
6. ALL DIMENSIONS SHOWN ARE APPROXIMATE, CONTRACTOR IS TO VERIFY IN FIELD.
7. MAINTAIN EXISTING SOFFIT CEILINGS AND CEILING MOUNTED FIXTURES IN ROOMS H013, H014, AND H015.
8. CENTER ALL SPRINKLER HEADS, SPEAKERS, AIR REGISTERS, AND OTHER DEVICES ON A CEILING TILE.
9. REINSTALL EXISTING CEILING MOUNTED SPEAKERS IN THEIR APPROXIMATE CURRENT LOCATION. PROVIDE ADDITIONAL ELECTRICAL WORK AS NECESSARY TO ALIGN TO NEW GRID.

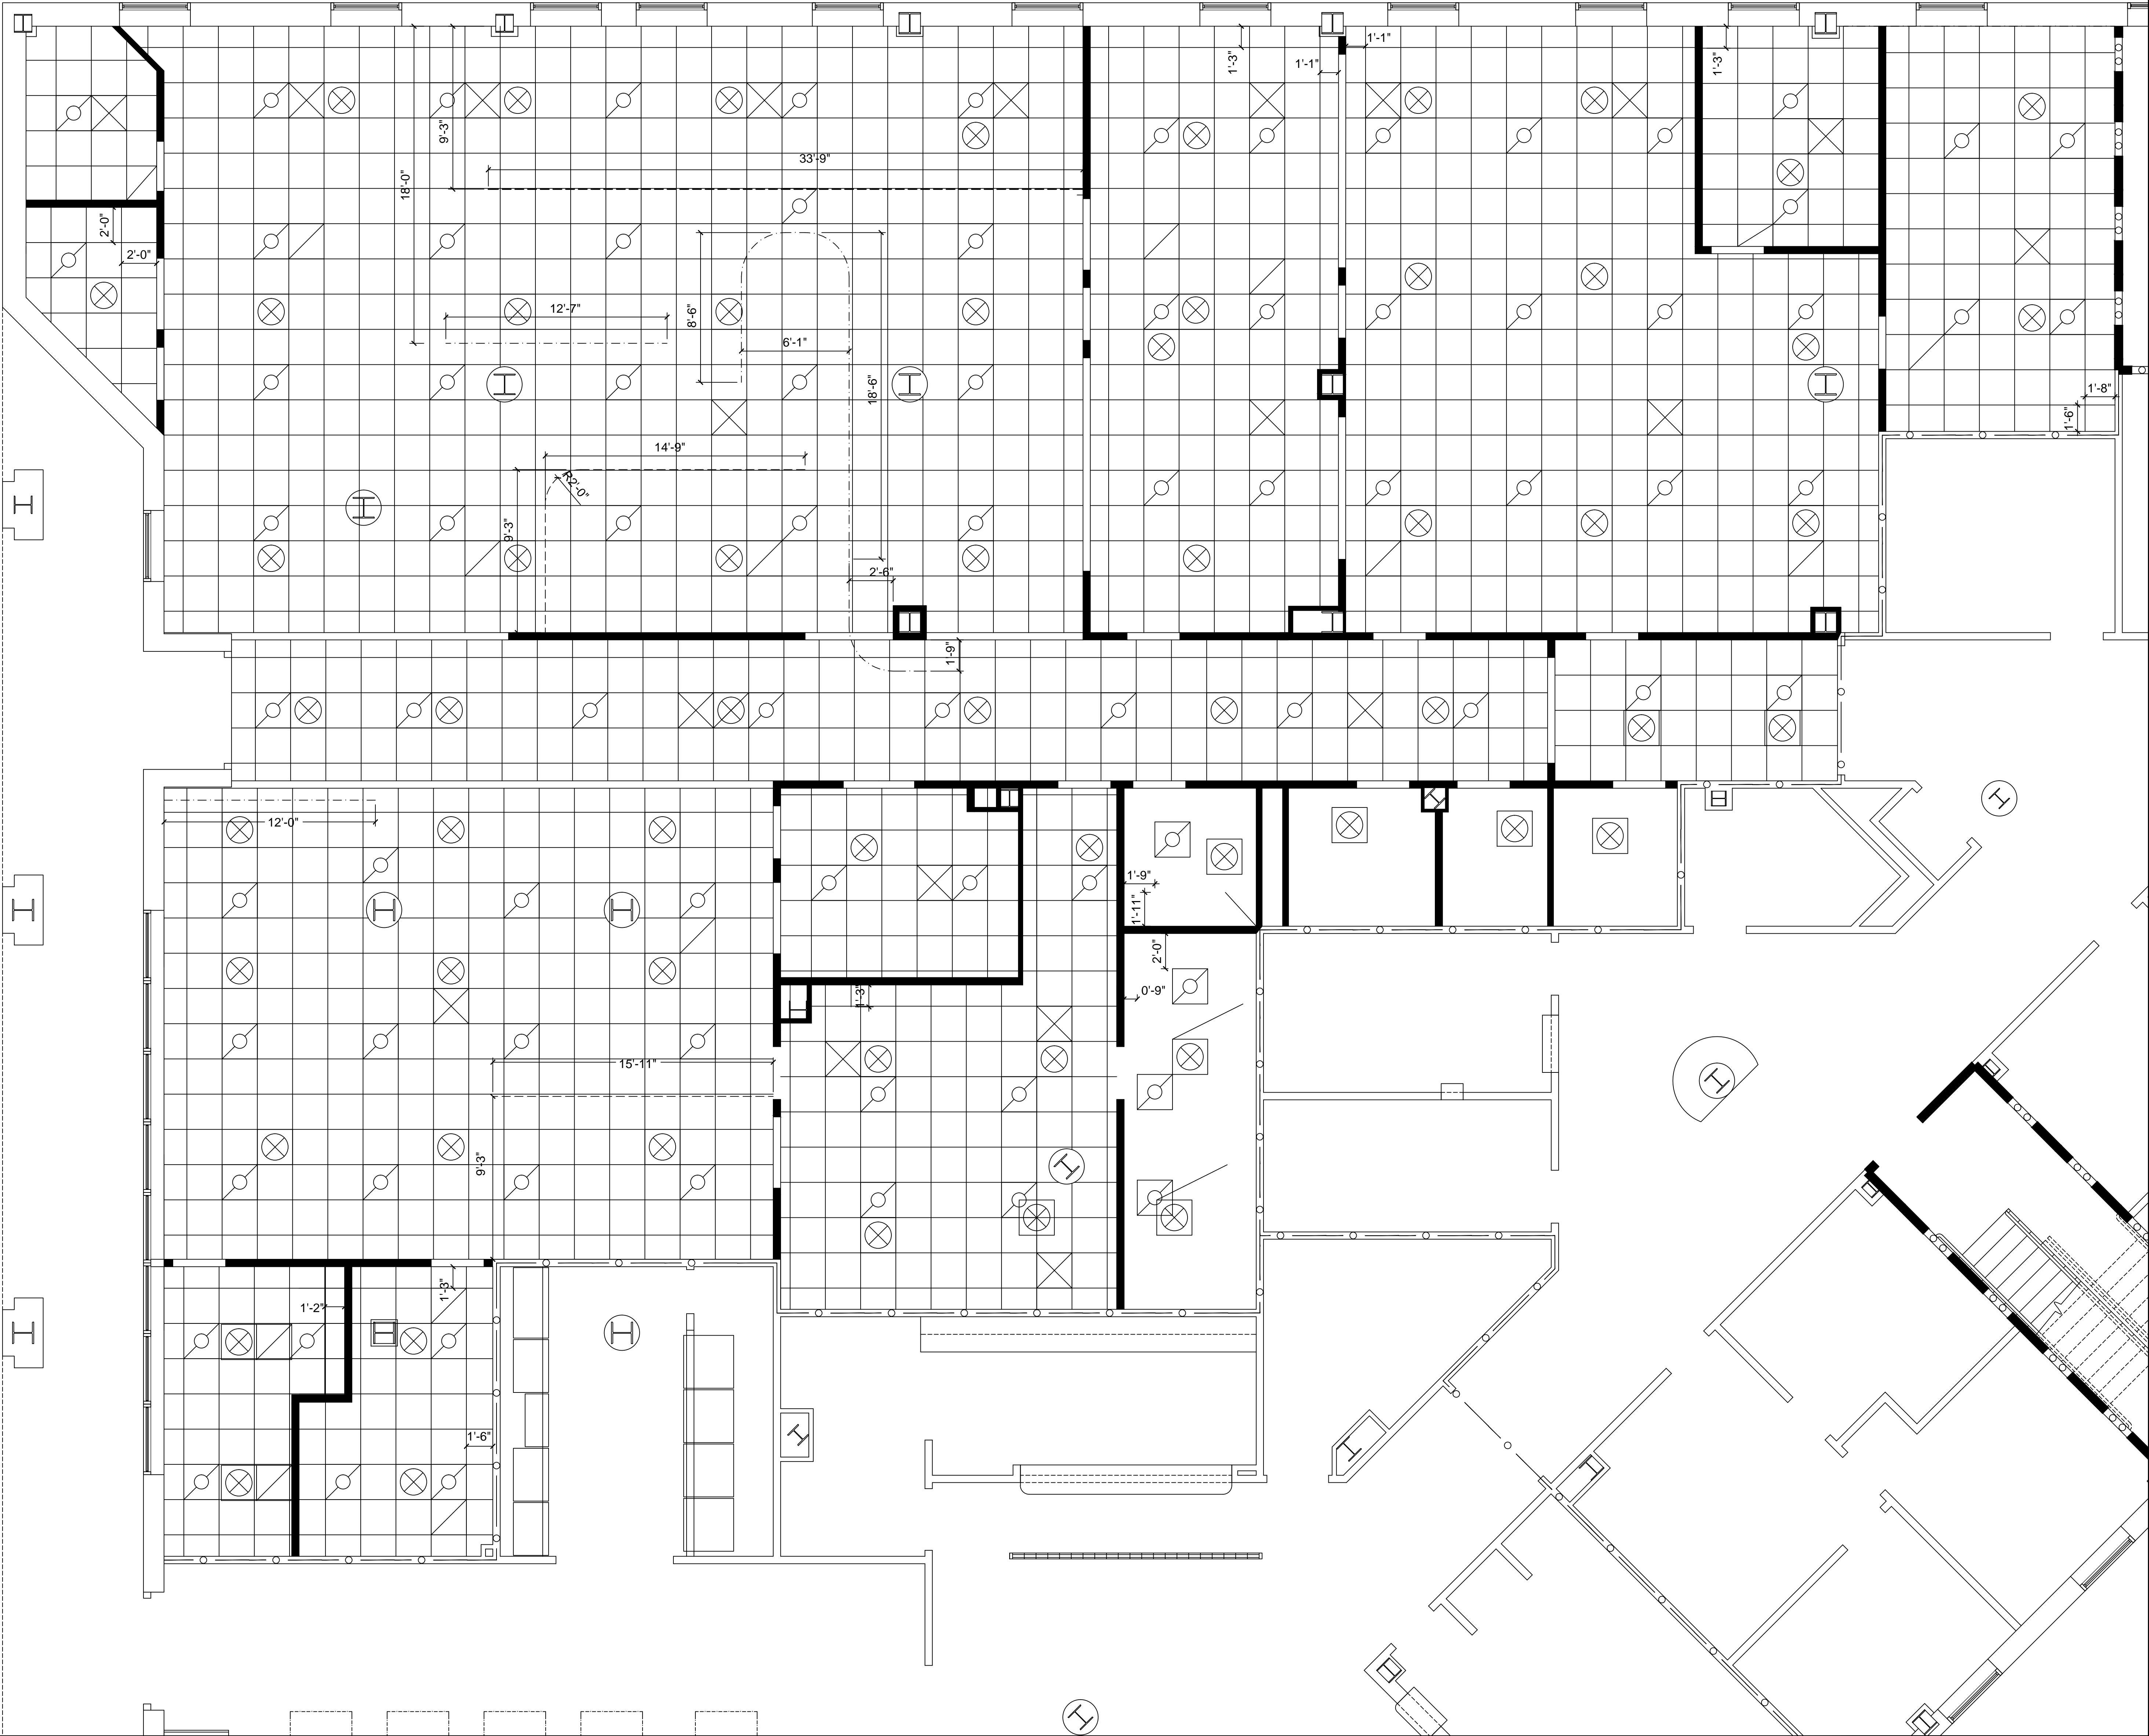

<div>Contract Documents2-20-2012 INITIAL DRAWING12-15-2010 Revisions:Date:</div>		CONSULTANTS:	ARCHITECT/ENGINEERS:	NORTH: <div>↗ N</div>	APPROVED: <div></div> <div></div> <div></div> <div></div> <div>APPROVED:</div>	Drawing Title <div>REFLECTED CEILING PLAN GROUND FLOOR 1/8" = 1'</div>	Project Title <div>PHYSICAL THERAPY OFFICES</div>	Project Number <div>620A4-11-224</div>	Engineering Service 
					APPROVED:Director, VAHVHCS:	Location <div>CASTLE POINT, NEW YORK</div>	Building(s) Number <div>15H</div>	Drawing Number <div>15H-AS-2</div>	
					APPROVED:Chief of Engineering	Date <div>12-15-2010</div>	Checked <div></div>	Drawn <div>JEF</div>	
								SHEET 15 OF 28	