
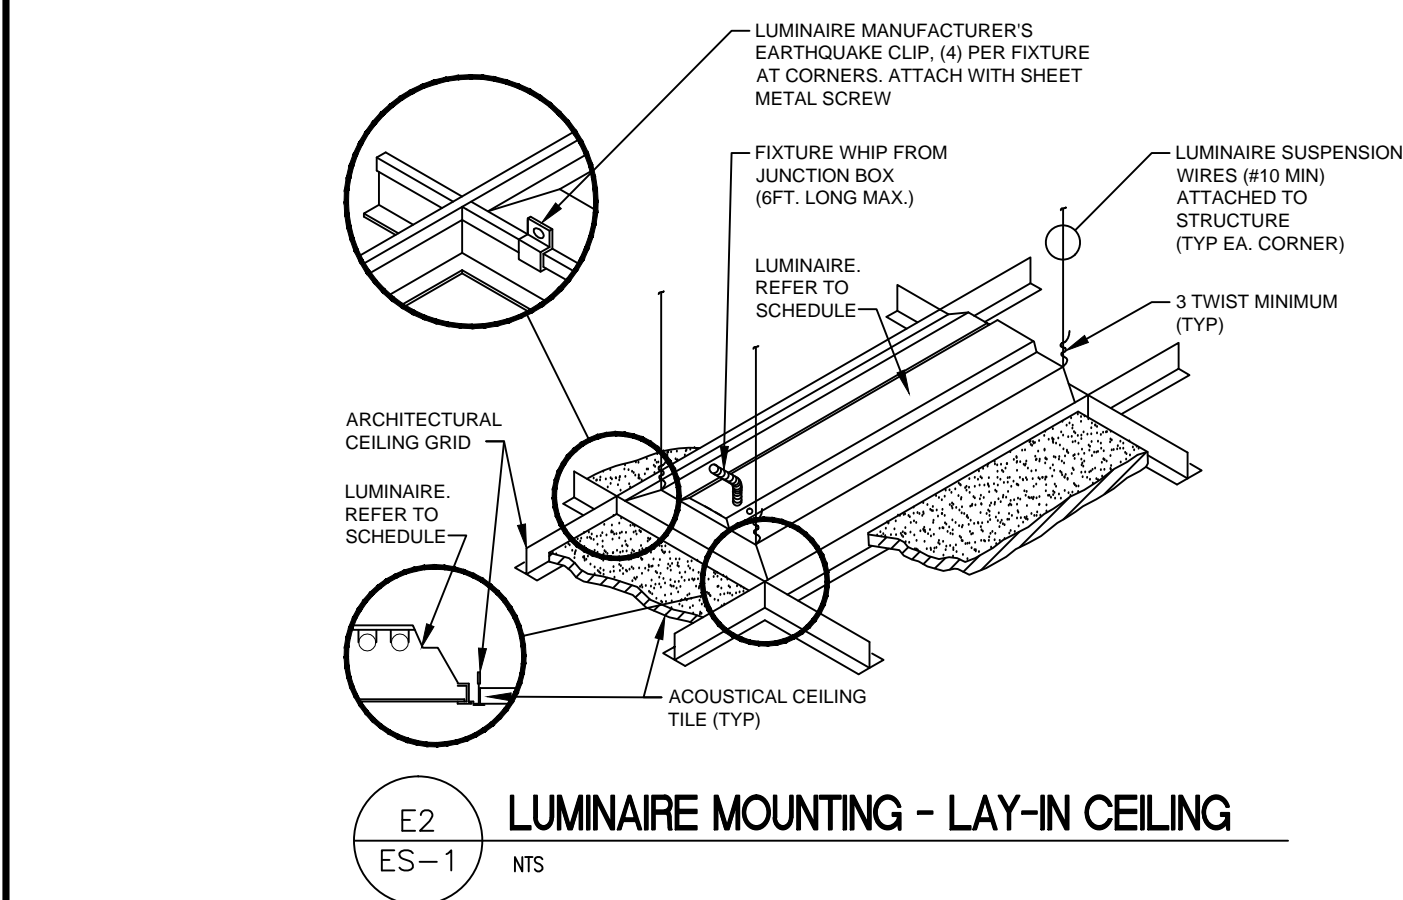


three inches = one foot
one and one half inches = one foot
one inch = one foot
three quarters inch = one foot
one half inch = one foot
three eighths inch = one foot
one quarter inch = one foot
one eighth inch = one foot

LEGEND	
\$ #	LIGHT SWITCH, # INDICATES LIGHTS CONTROLLED
□ #	2X2 LIGHT FIXTURE, TYPE A, # INDICATES SWITCH CONTROLLING. #A INDICATES ALWAYS ON

- NOTES:
- IT IS PERMISSIBLE TO REUSE EXISTING LIGHTING CONDUIT WHERE POSSIBLE.
 - LIGHTING CIRCUITS 5,6,7,9,10,11,12 ARE TO USE OCCUPANCY SENSING SWITCHES.
 - LIGHTING SWITCHES 5,6,7,12 CONTROL THE EXISTING LIGHTING IN THESE ROOMS.

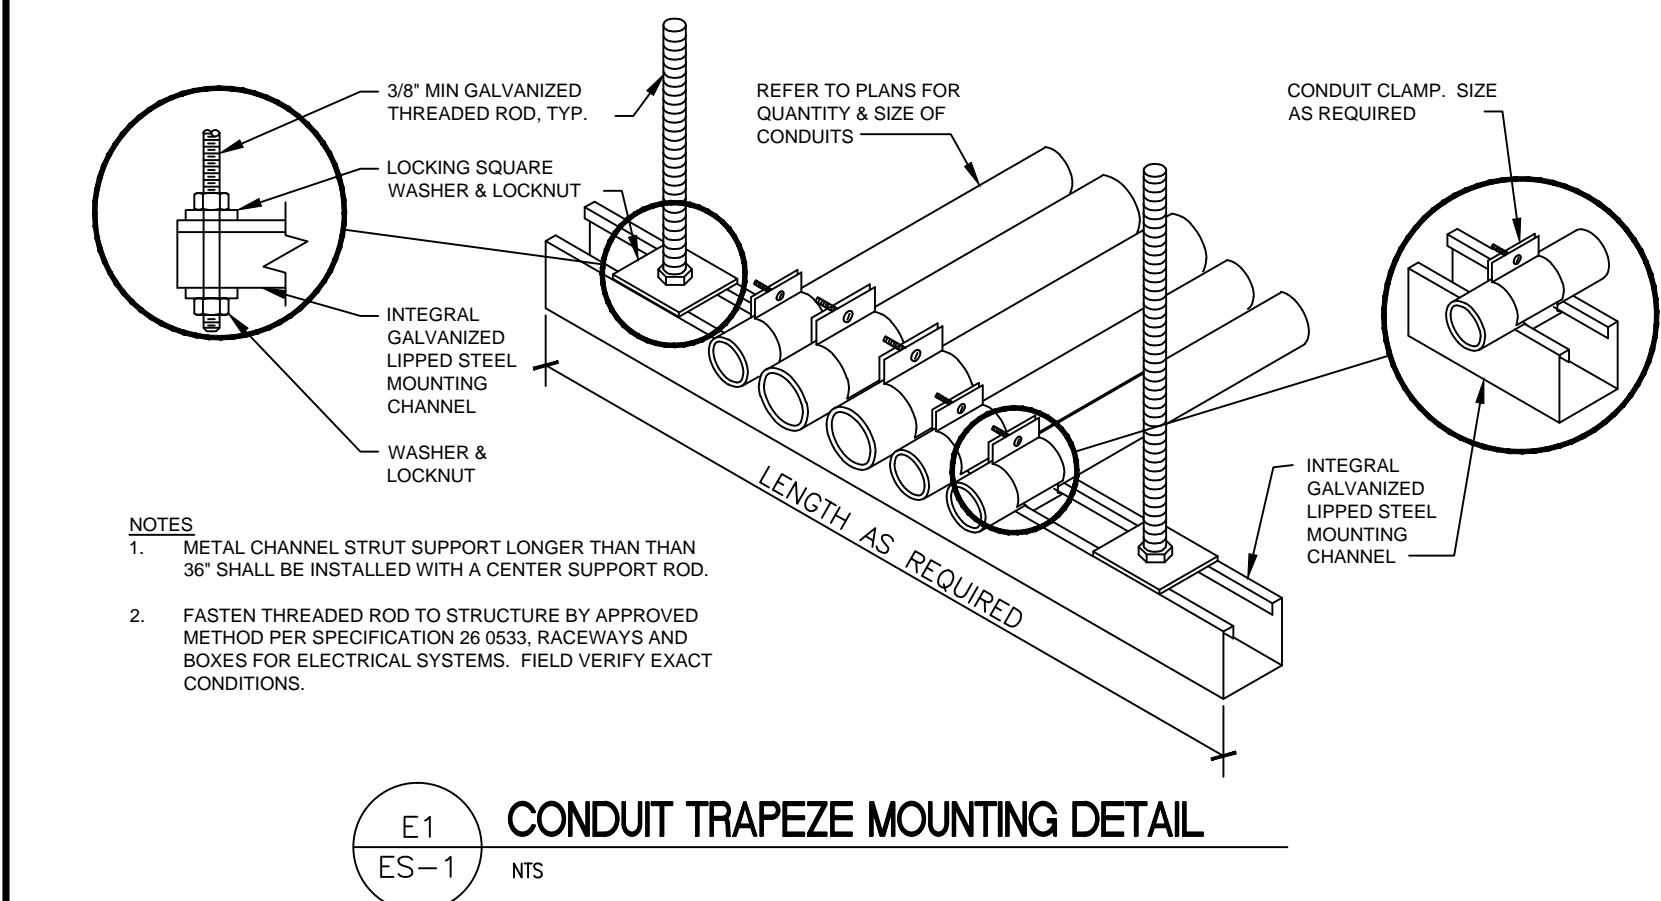

LIGHTING FIXTURE SCHEDULE						
Type	Symbol	Volts	No. of Lamps	Lamp Type	Total Watts	Description
A	□	120	2	PHILIPS P/N 20423-0 FB32T8/U (CRI=85 OR BETTER) 4100K	50	-2'X2' RECESSED FLUORESCENT WITH ACRYLIC LENS & ELECTRONIC BALLAST - LEGION CAT # 72- 2U32 EBO OR APPROVED EQUAL

CONSULTANTS:		ARCHITECT/ENGINEERS:		NORTH:		APPROVED:		Drawing Title		Project Title		Project Number		Engineering Service Department of Veterans Affairs	
						APPROVED:		LIGHTING PLAN		PHYSICAL THERAPY PHASING		620A4-11-224			
						APPROVED:		GROUND FLOOR				Building(s) Number			
						APPROVED:		1/4" = 1'				18D			
Contract Documents		2-20-2012						Approved: Director, VAHVHCS:		Location		Drawing Number			
INITIAL DRAWING		12-15-2010						APPROVED: Chief of Engineering		CASTLE POINT, NEW YORK		18-ES-1			
Revisions:		Date:						APPROVED:		Date		Checked		Drawn	
										12-15-2010		JEF		SHEET 8 OF 28	