






three inches = one foot  
 one and one half inches = one foot  
 one inch = one foot  
 three quarters inch = one foot  
 one half inch = one foot  
 three eighths inch = one foot  
 one quarter inch = one foot  
 one eighth inch = one foot  
 one sixteenth inch = one foot

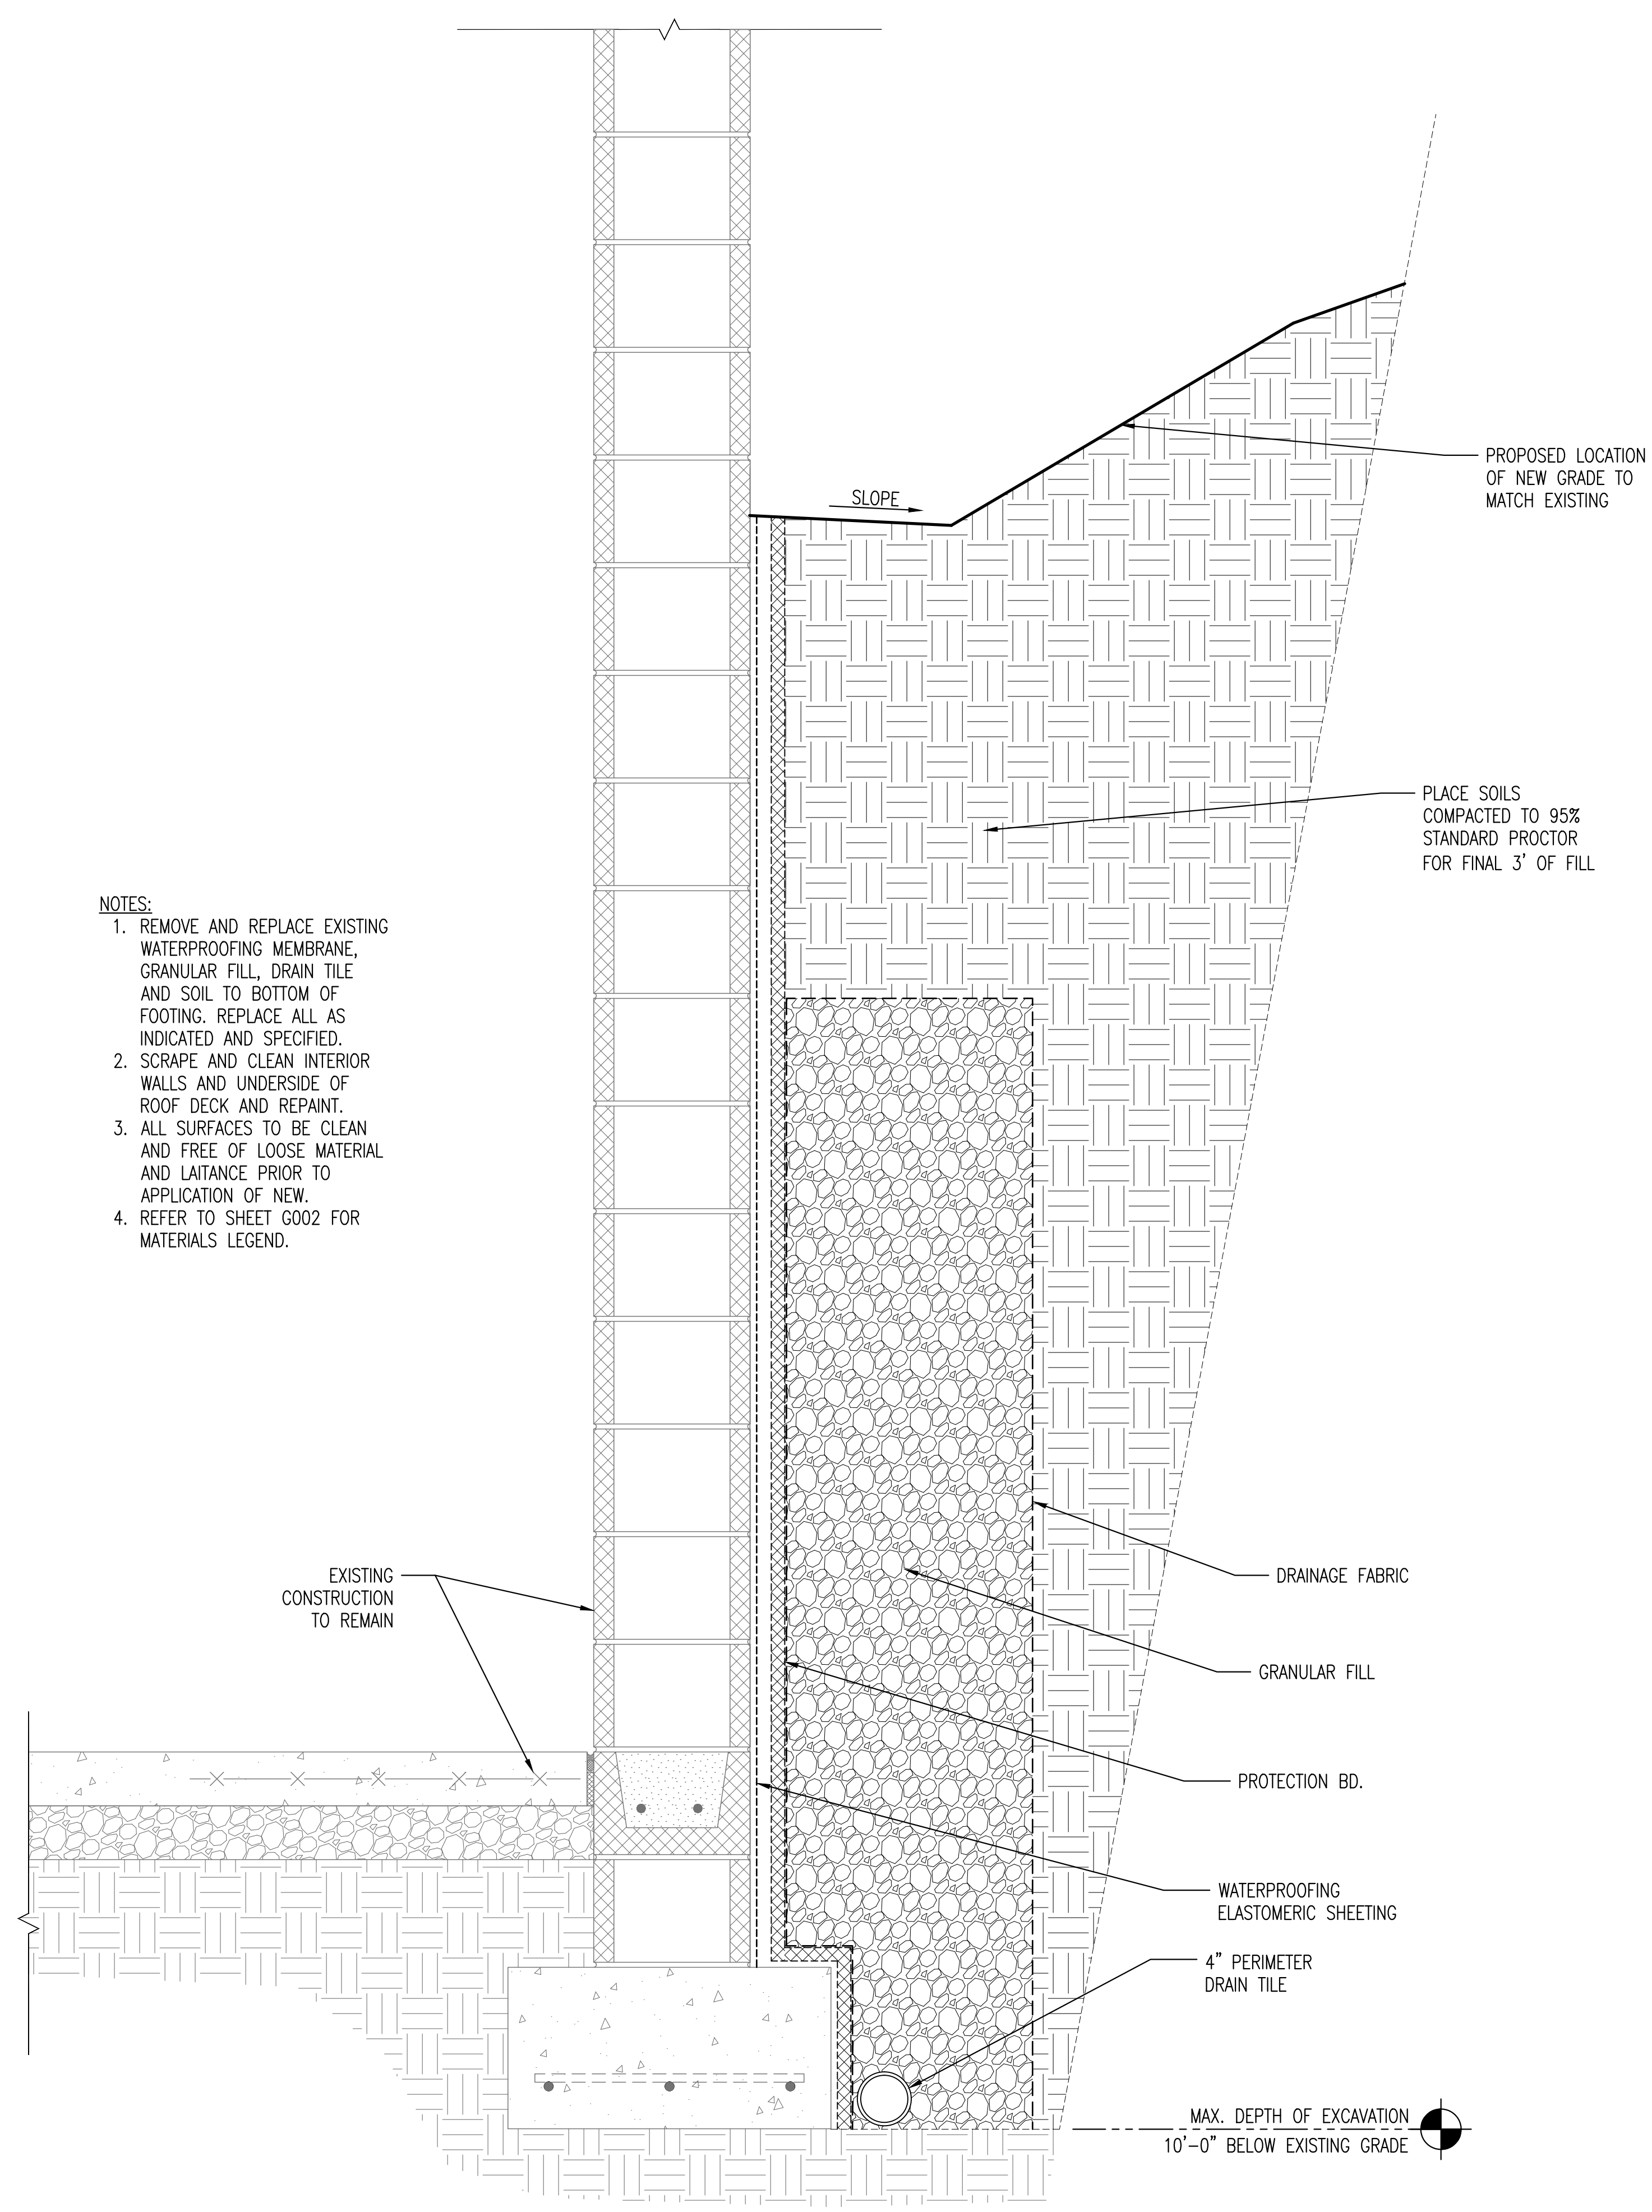


**3 WALL DETAIL**  
 A101 1 1/2" = 1'-0"  
 SCALE: 1-1/2" = 1'-0"


- NOTES:**
1. REMOVE AND REPLACE EXISTING WATERPROOFING MEMBRANE, GRANULAR FILL, DRAIN TILE AND SOIL TO BOTTOM OF FOOTING. REPLACE ALL AS INDICATED AND SPECIFIED.
  2. SCRAPE AND CLEAN INTERIOR WALLS AND UNDERSIDE OF ROOF DECK AND REPAINT.
  3. ALL SURFACES TO BE CLEAN AND FREE OF LOOSE MATERIAL AND LAITANCE PRIOR TO APPLICATION OF NEW.
  4. REFER TO SHEET G002 FOR MATERIALS LEGEND.

PROPOSED LOCATION OF NEW GRADE TO MATCH EXISTING


PLACE SOILS COMPACTED TO 95% STANDARD PROCTOR FOR FINAL 3' OF FILL

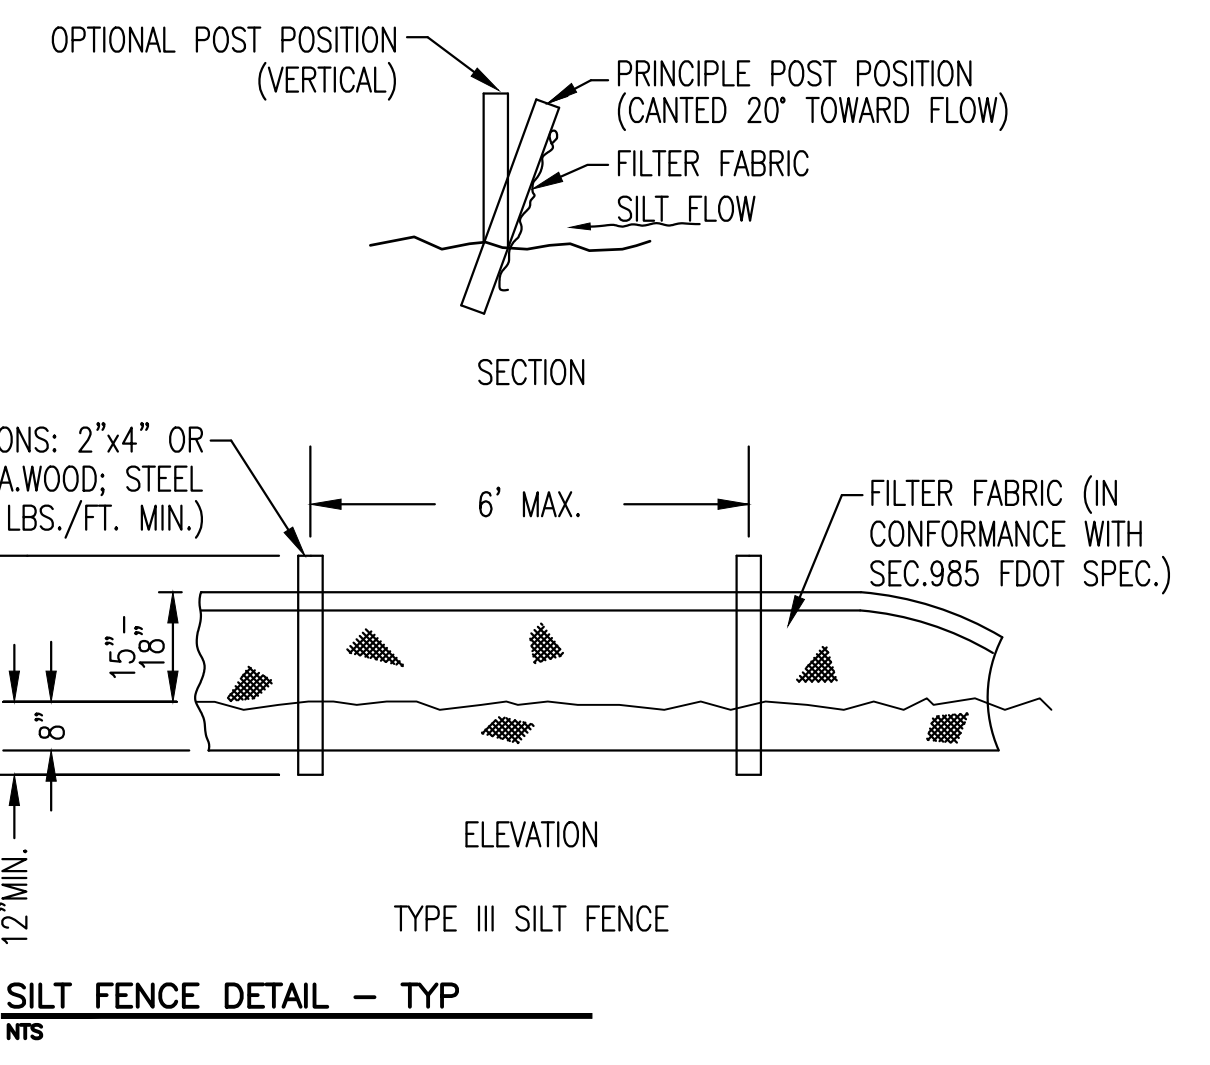

**SILT FENCE DETAIL - TYP**

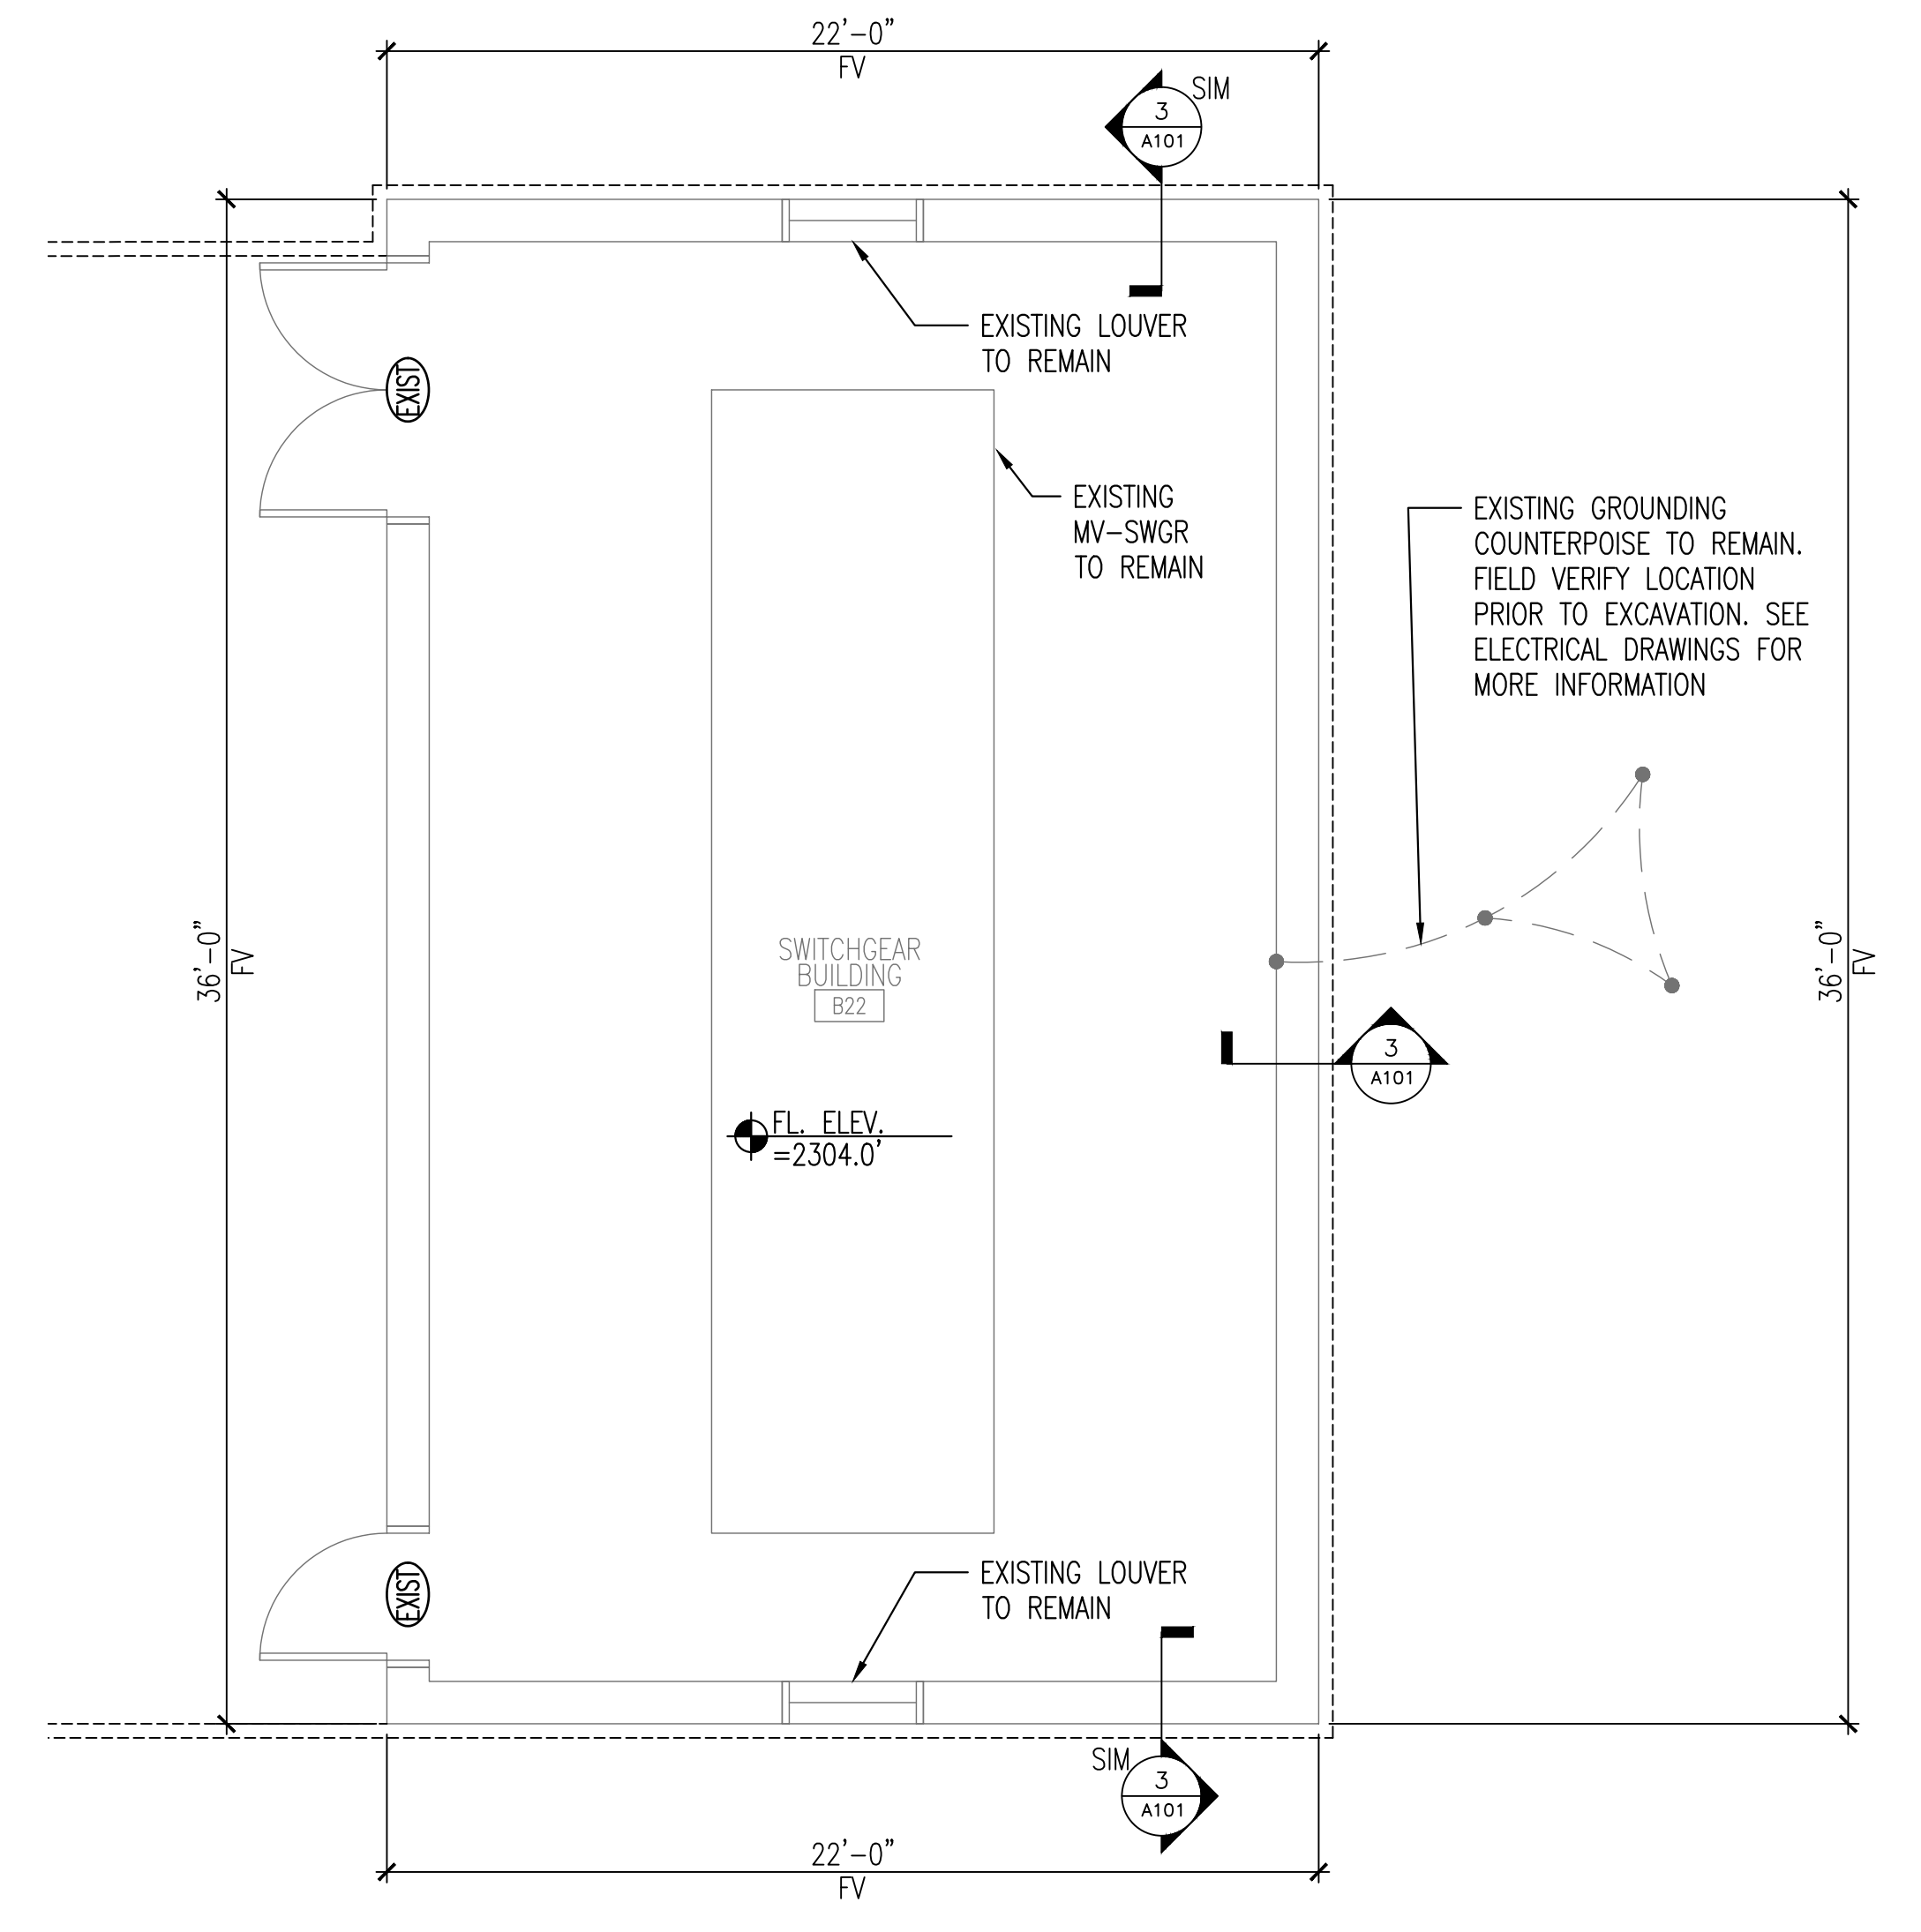


**2 BUILDING 22 FLOOR PLAN**  
 A101 1/4" = 1'-0"  
 SCALE: 1/4" = 1'-0"

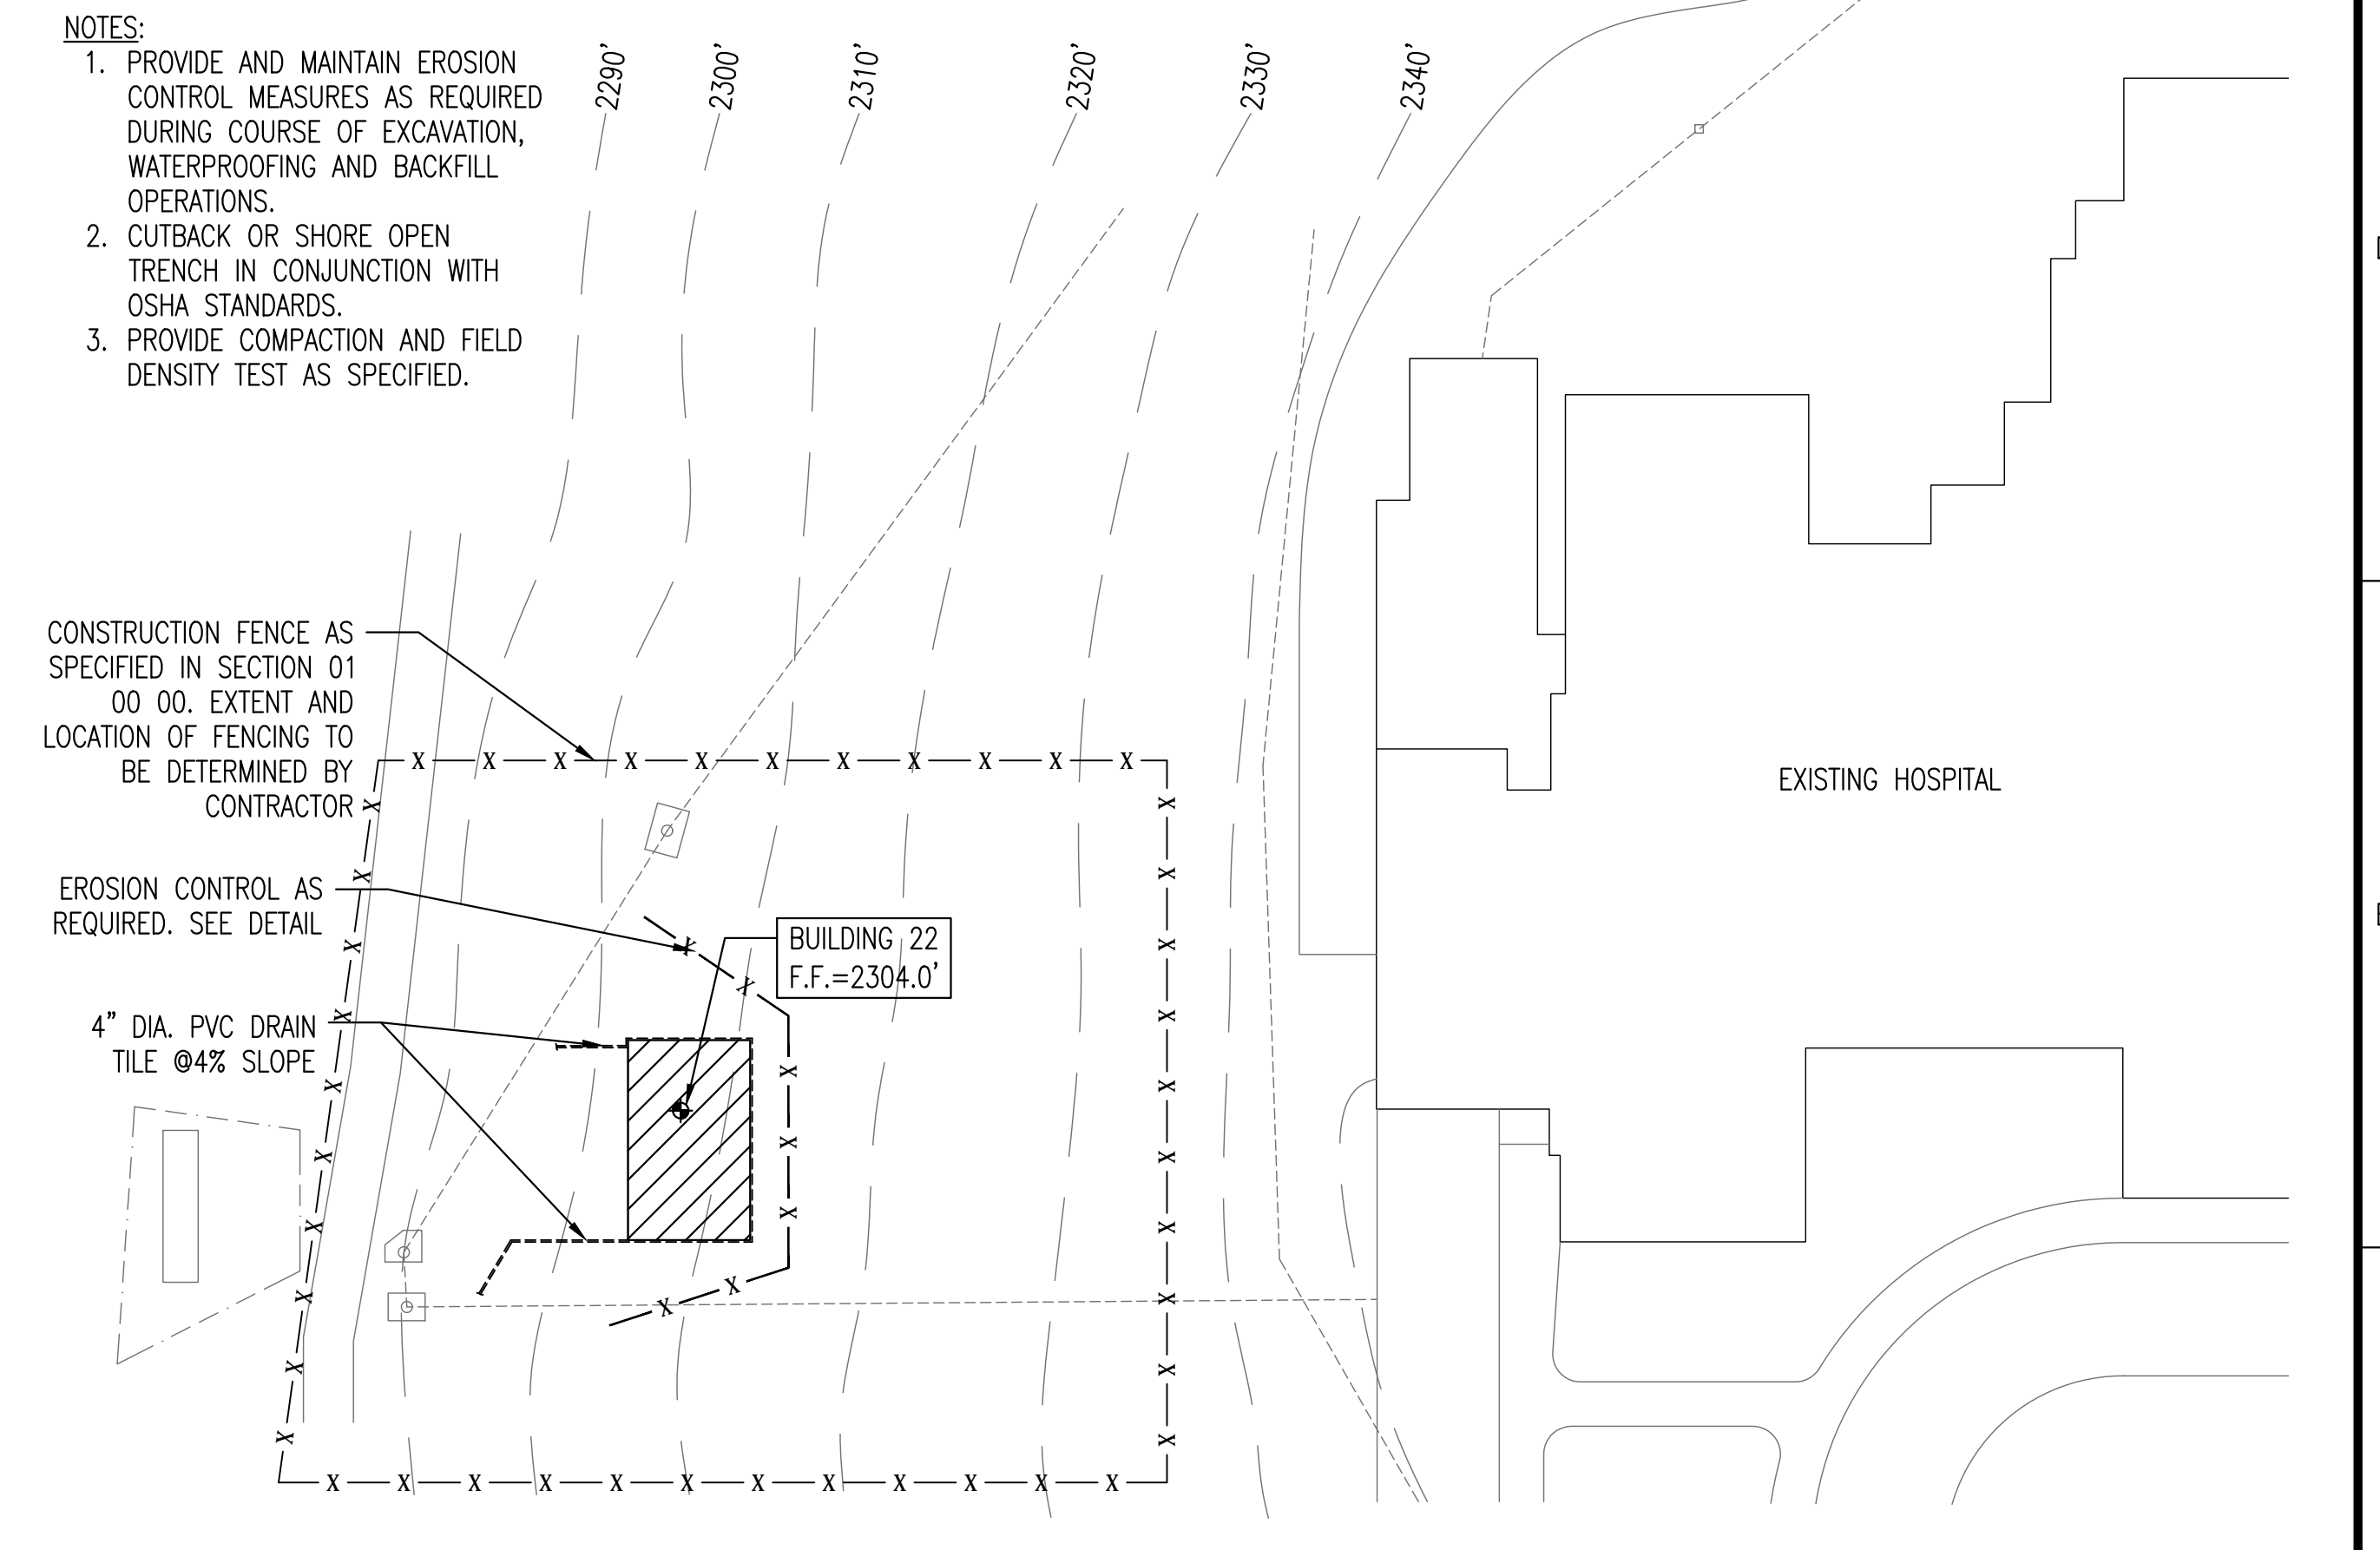

**1 PARTIAL SITE PLAN**  
 A101 NOT TO SCALE  
 SCALE: 1" = 30'


- NOTES:**
1. PROVIDE AND MAINTAIN EROSION CONTROL MEASURES AS REQUIRED DURING COURSE OF EXCAVATION, WATERPROOFING AND BACKFILL OPERATIONS.
  2. CUTBACK OR SHORE OPEN TRENCH IN CONJUNCTION WITH OSHA STANDARDS.
  3. PROVIDE COMPACTION AND FIELD DENSITY TEST AS SPECIFIED.

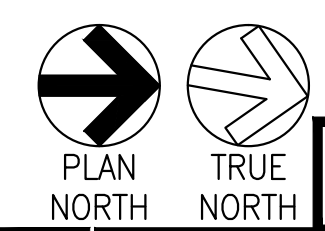

**FINAL SUBMITTAL**

Revisions:	Date:

**CONSULTANTS:**

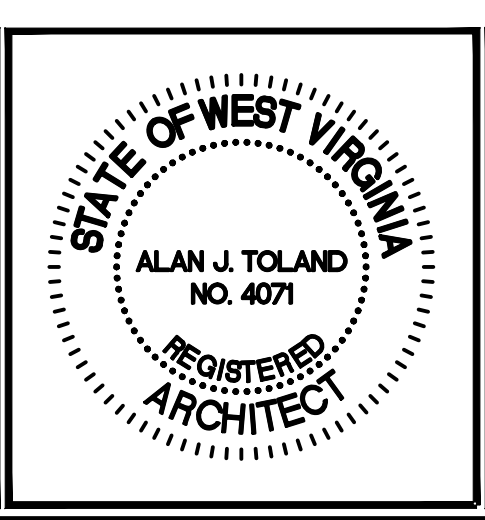

**ARCHITECT:**

**TOLAND MIZELL MOLNAR**

590 MEANS STREET NW  
 STE. 200  
 ATLANTA, GA 30318

Drawing Title:  
**SITE PLAN, FLOOR PLAN AND DETAILS**

Approved: Project Director

Project Title:  
**CORRECT ELECTRICAL DEFICIENCIES**

Location:  
**BECKLEY, WV**

Date: 3-10-2017  
 Checked: AT  
 Drawn: SJ

Project Number:  
**517-16-114**

Building Number:  
**22**

Drawing Number:  
**A101**

Sheet 3 of 5

**OFFICE OF CONSTRUCTION AND FACILITIES MANAGEMENT**

Department of Veterans Affairs



