

ONE INCH = FORTY FEET (1" = 40')

THREE INCHES = ONE FOOT

ONE AND ONE HALF INCHES = ONE FOOT


THREE QUARTERS INCH = ONE FOOT

ONE HALF INCH = ONE FOOT

ONE QUARTER INCH = ONE FOOT

ONE EIGHT INCH = ONE FOOT

ONE SIXTEENTH INCH = ONE FOOT

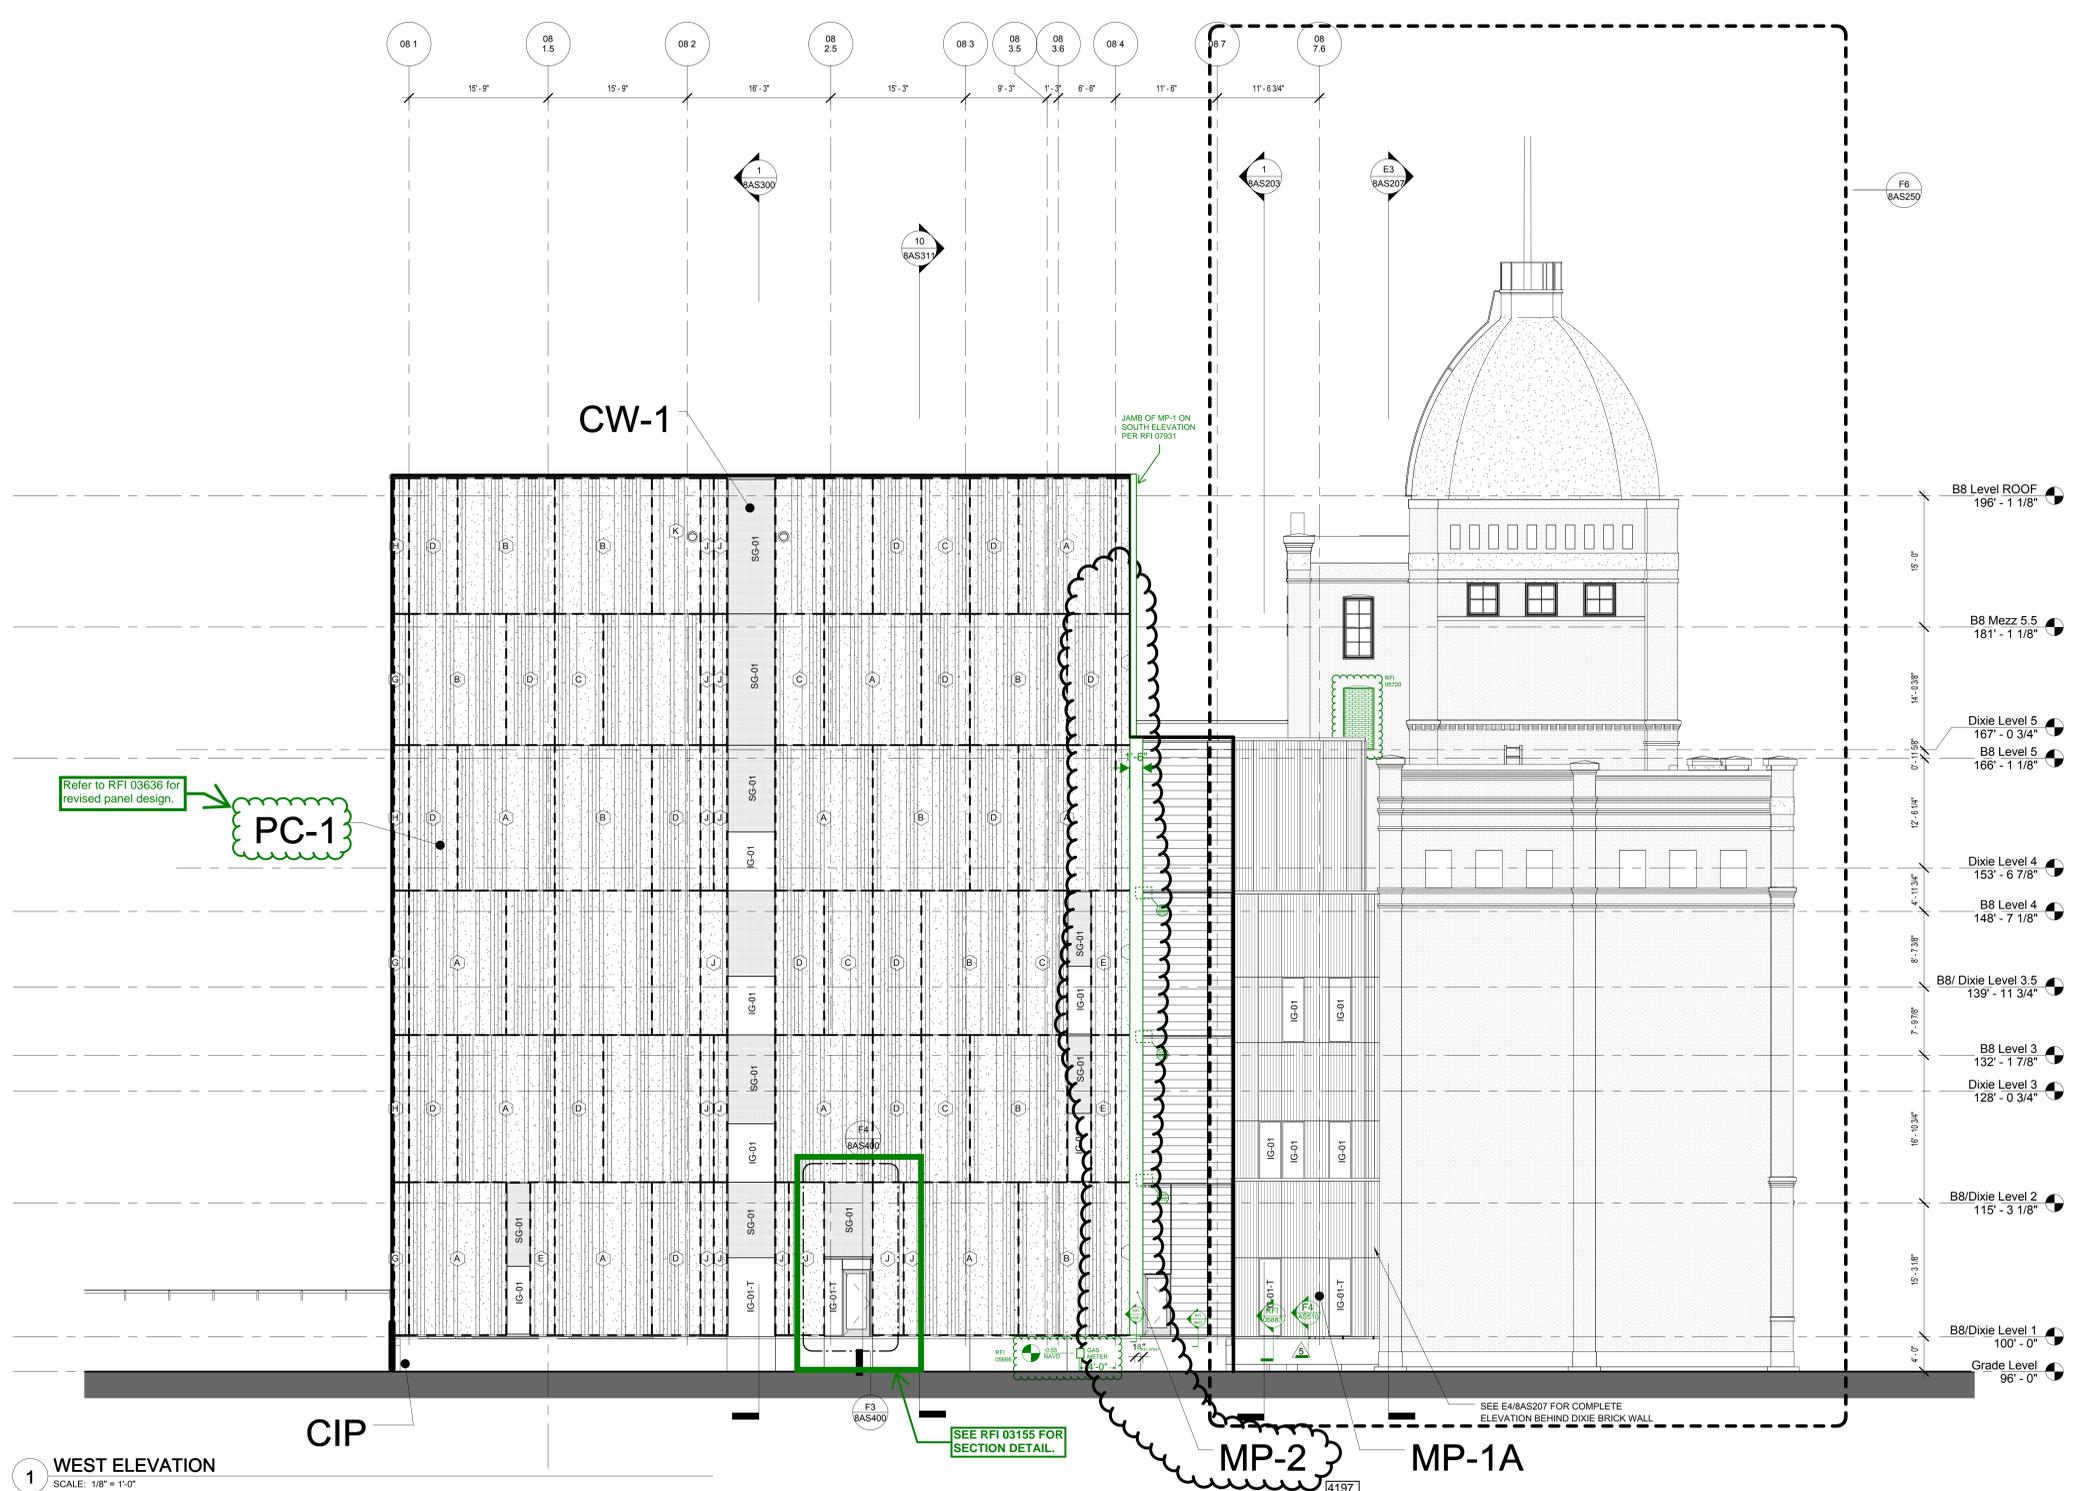

1 WEST ELEVATION
SCALE: 1/8" = 1'-0"

EXTERIOR MATERIALS LEGEND

MATERIAL TYPES

- INSULATED LAMINATED VISION
- INSULATED LAMINATED SPANDREL
- METAL PANEL (MP-1, MP-1A)
- METAL PANEL (MP-2)
- PRECAST
- STUCCO / E.I.F.S. (SEE NOTE ON ELEV.)
- MECHANICAL LOUVER
- MASONRY CAVITY WALL (BR-1)

GLAZING TYPES

- IG-01 INSULATED LAMINATED VISION
- IG-01x-T INSUL. LAMINATED VISION TEMPERED
- SG-01 INSUL. LAMINATED SPANDREL
- SG-01x-T INSUL. LAMINATED SPANDREL TEMPERED
- SGS-1 LAMINATED GLASS SPANDREL

SYMBOLS LEGEND


- PRECAST (WALL TYPE PC-1) PATTERN TYPE INDICATOR. SEE SHEET 8AS506 FOR PANEL TYPES
- O.D. OVERFLOW DRAIN (SECONDARY)
- O.S. OVER FLOW SCUPPER
- M.E.P. FP PENETRATIONS THROUGH ENCLOSURE
- LIGHTING OVER EXIT

WALL TYPES LEGEND

WALL TYPE MARK	REFER TO SHEET
MP-1	8AS501
MP-2	8AS502
BR-1	8AS503
PC-1	8AS504
CW-1	8AS505

1. CURTAINWALL: WALL TYPE CW-1 IS TYPICAL U.N.O.
2. DASHED LINES ON PC-1 DENOTE AREA OF INDICATED PATTERN. NOT PANELIZATION. SUBCONTRACTOR TO OPTIMIZE PANEL LAYOUT WITHIN JOINTS SHOWN.

- ### DIMENSION NOTES
- ALL DIMENSION STRINGS FROM CL OF JT. TO CL OF JT. EXCEPT AT ENDS OF EXTERIOR WALL & U.N.O.
 - REFER TO PLANS FOR CW, VERT. FRAMING LOCATIONS. REFER TO ELEVATIONS FOR GLASS TYPE
 - REFER TO PLANS FOR WINDOW LOCATIONS IN METAL PANEL & PRECAST SYSTEMS. REFER TO ELEVATIONS FOR LOCATIONS OF JOINTS IN THESE SYSTEMS.
 - VERIFY IN FIELD LOCATION OF ALL EXISTING DIXIE BUILDING ELEMENTS

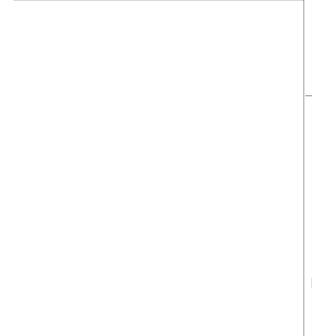

REVISIONS:	DATE
RFI 4197.1	11/25/2014
5 Bulletin 19-VE	2/28/2014

CONSULTANTS:
 DESMAN ASSOCIATES / PARKING
 CODE CONSULTANTS, INC. / CODE CONSULTANT
 THE SEXTANT GROUP / AV & ACOUSTICAL
 HAMMER DESIGN ASSOCIATES / FOOD SERVICE
 PYBURN & ODOM / ABATEMENT
 TATA & HOWARD / TANK CONSULTANT
 I.S.C. GROUP, INC. / IRRIGATION
 DAN EUSER WATER ARCHITECTURE, INC. / WATER FEATURE

ARCHITECT/ENGINEERS:
 studio **NOVA**
 SCHRENK & PETERSON CONSULTING ENGINEERS / CIVIL
 KORDA/NEMETH ENGINEERING / STRUCTURAL
 BR+A CONSULTING ENGINEERS / MECH. ELECT. PLUMBING, LOW VOLTAGE
 ARCHITECTURAL ENGINEERING / PLUMBING
 SCALES ASSOCIATES / FIRE PROTECTION

DRAWING TITLE
BLDG 8 WEST ELEVATION

APPROVED: PROJECT DIRECTOR

PROJECT TITLE
SLVHCS REPLACEMENT MEDICAL CENTER PROJECT

LOCATION
NEW ORLEANS, LOUISIANA

DATE
July 16, 2012

CHECKED
NF

DRAWN
KS

PROJECT NUMBER
100342.00

BUILDING NUMBER
08

DOCUMENT SET PACKAGE
WP_09B

DRAWING NUMBER
8AS204

CONSTRUCTION DOCUMENTS 1
FULLY SPRINKLERED

OFFICE OF CONSTRUCTION AND FACILITIES MANAGEMENT

Department of Veterans Affairs