

GENERAL NOTES


- ALL WORK SHOWN ON THIS SHEET SHALL BE PERFORMED IN ACCORDANCE WITH NFPA 70-2002, NATIONAL ELECTRICAL CODE.
- LAYOUTS SHOWN ON THIS SHEET ARE DIAGRAMMATIC AND DO NOT NECESSARILY DEPICT EXACT CONFIGURATIONS. EQUIPMENT AND DEVICE LOCATIONS SHALL BE AS NEAR AS PRACTICABLE TO LOCATIONS SHOWN EXCEPT WHERE SPECIFIED, NOTED, OR INDICATED OTHERWISE.
- PROVIDE ALL POWER AND CONNECTIONS TO EQUIPMENT PER MANUFACTURER'S RECOMMENDATIONS. ELECTRICAL REQUIREMENTS INCLUDING CIRCUIT BREAKER SIZES, FUSE SIZES, AND CONDUCTOR SIZES ARE BASED ON CHARACTERISTICS INDICATED AND MAY VARY DEPENDING ON EQUIPMENT PROVIDED. COORDINATE ALL ELECTRICAL REQUIREMENTS WITH EQUIPMENT SUPPLIER AND REVISE IF NECESSARY.
- RECEPTACLES AND OUTLETS ARE SHOWN IN APPROXIMATE LOCATIONS. COORDINATE FINAL LOCATIONS WITH OWNER. LOCATE RECEPTACLES AND OUTLETS WITHIN TEN FEET OF LOCATIONS SHOWN AT NO ADDITIONAL COST TO OWNER.

SYMBOL LEGEND


- PANELBOARD
- DRY TYPE TRANSFORMER

KEYED NOTES THIS SHEET

- (200)** EXISTING PANELBOARDS AND TRANSFORMERS TO REMAIN. CONNECT BRANCH CIRCUITS TO EXISTING CIRCUIT BREAKERS. REF. SCHEDULES ON SHEET E-600. REVISE DIRECTORIES ACCORDINGLY.
- (207)** FIRE DAMPER ABOVE CEILING. PROVIDE POWER AND FIRE ALARM INTERLOCK. COORDINATE EXACT REQUIREMENTS WITH ALL TRADES AND SYSTEMS.
- (217)** NEMA 1 LABORATORY WIREWAY ABOVE CEILING, 6"x6"x48" LONG. ROUTE ALL 120/208V BRANCH CIRCUITS IN ASSOCIATED LABORATORY THROUGH THIS WIREWAY.
- (212)** NEMA 1 EQUIPMENT ROOM WIREWAY ABOVE CEILING, 6"x6"x24" LONG. ROUTE ALL 120/208V BRANCH CIRCUITS IN ASSOCIATED EQUIPMENT ROOM THROUGH THIS WIREWAY.
- (227)** CONNECTION BOX FOR BIOSAFETY CABINET. PROVIDE ALL CONNECTIONS AS RECOMMENDED BY THE MANUFACTURER.
- (222)** FUME HOOD CONNECTIONS AND BRANCH CIRCUIT BY OTHERS.
- (223)** AUTOCLAVE CONTROL POWER CONNECTION. COORDINATE EXACT REQUIREMENTS WITH AUTOCLAVE SUPPLIER.

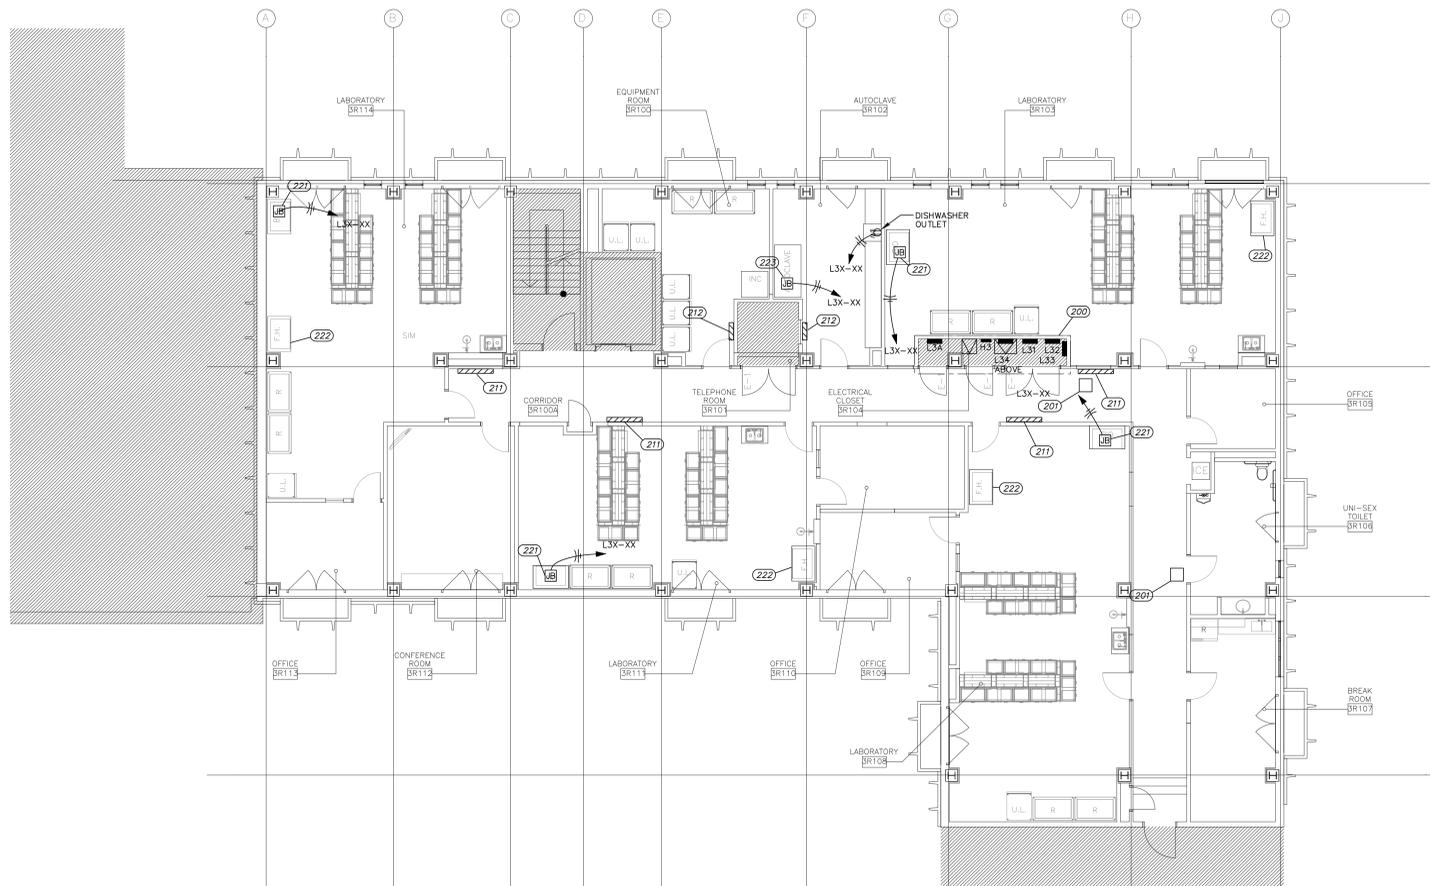


1 POWER PLAN - THIRD FLOOR
E-203
SCALE: 1/8"=1'-0"
SCALE IN FEET

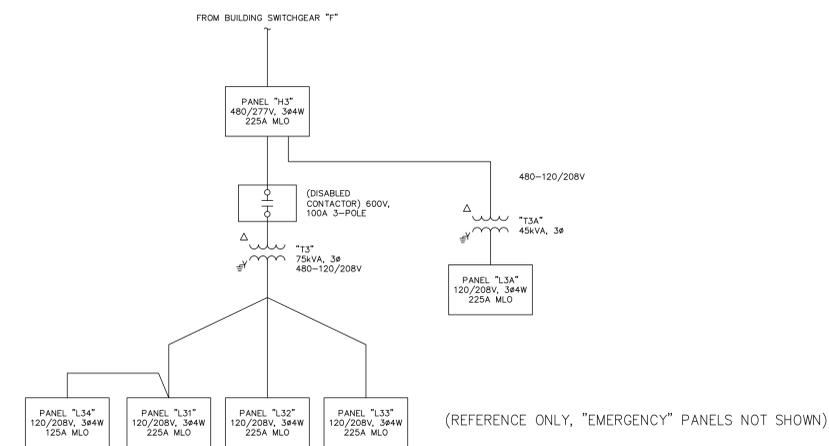

1 PARTIAL SINGLE-LINE DIAGRAM
E-204
SCALE: NONE

(REFERENCE ONLY, "EMERGENCY" PANELS NOT SHOWN)

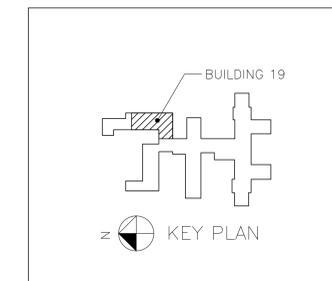

ZRHD, P.C. ENGINEERS OF AUTHORIZATION: CA1373
 EXPIRATION DATE: 30 JUNE 2013
 C:\Documents and Settings\vaashhoopok\My Documents\Bldg_19
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Revisions:	Date

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Drawing Title	POWER PLAN THIRD FLOOR
Approved:	Project Director

Project Title	RENOVATION BUILDING 19 VA MEDICAL CENTER
Location	VAMC, OKLAHOMA CITY, OK
Date	5/11/2012
Checked	WHW
Drawn	SWW

Project Number	635-11-303
Building Number	19
Drawing Number	E-203
Dwg.	59 of 71

Office of
Construction
and Facilities
Management