


(2.) EXISTING BREAKAWAY SLEEVE. DECOMMISSION EXISTING FIRE DAMPER. BLOCK FIRE (3)DAMPER SHUTTER PERMANENTLY OPEN WITH SHEET METAL SCREWS OR METAL ANGLES ATTACHED TO FRAME. (4.) EXISTING CORRIDOR WALL. BEAR STEELE GLOBAL, 2015 Boundary Street,

3

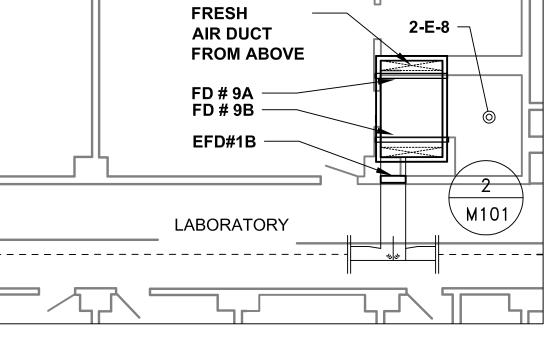

SECOND FLOOR ROOM 2-E-8

2-E-8 SCOPE OF WORK

PROVIDE ACCESS TO EXISTING FIRE DAMPER:

PROVIDE NEW DUCT ACCESS DOOR TO PROVIDE CODE COMPLIANT ACCESS TO EXISTING FIRE DAMPER EFD#1B

REPAIR INSULATION (IF DUCT IS INSULATED)

REMOVE EXISTING FUSIBLE LINK AND INSTALL NEW FUSIBLE LINK OF

4. FUNCTIONALLY TEST EXISTING FIRE DAMPER.

5. SEE PROVIDE ACCESS TO EXISTING FIRE DAMPER DETAIL NOTES ON


PROTECT EXISTING EXPOSED SHAFT DUCT

FULLY ENCLOSE EXISTING EXPOSED SECTIONS OF HORIZONTAL AND VERTICAL SHAFT DUCTWORK BETWEEN THE 3RD FLOOR ASSEMBLY AND THE 2ND FLOOR ASSEMBLY WITHIN A 2-HOUR FIRE RESISTANT SHAFT WALL ENCLOSURE. SEE 2-E-8 NEW SHAFT WALL CONSTRUCTION

2. 2-E-8 OPTION 1: IN LIEU OF INSTALLING A NEW SHAFT WALL ENCLOSURE INSTALL A NEW FIRE DAMPER WITH ACCESS PANEL AT THE SHAFT DUCT PENETRATION AT THE 3RD FLOOR ASSEMBLY AND A NEW FIRE DAMPER AND ACCESS PANEL AT THE LOCATION THE EXPOSED SHAFT DUCT, CONNECT TO THE RATED SHAFT CONTINUING TO THE 2ND FLOOR. SEE 2-E-8 OPTION 1 DETAIL NOTES.

INSTALL NEW FIRE DAMPERS FD#9A AND FD#9B AT OUTSIDE AIR SHAFT CONNECTION


1. INSTALL NEW FIRE DAMPER AT EXISTING DUCT CONNECTION TO RATED OUTSIDE AIR SHAFT. SEE NEW FIRE DAMPER AT RATED SHAFT

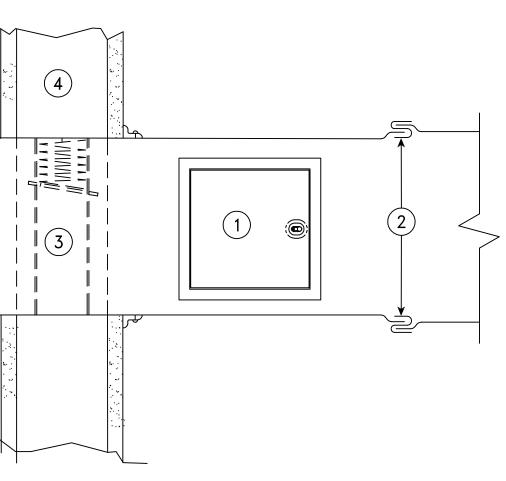


DECOMMISSION EXISTING FIRE DAMPER

DETAIL NOTES:

(1.) PROVIDE NEW ACCESS DOOR.

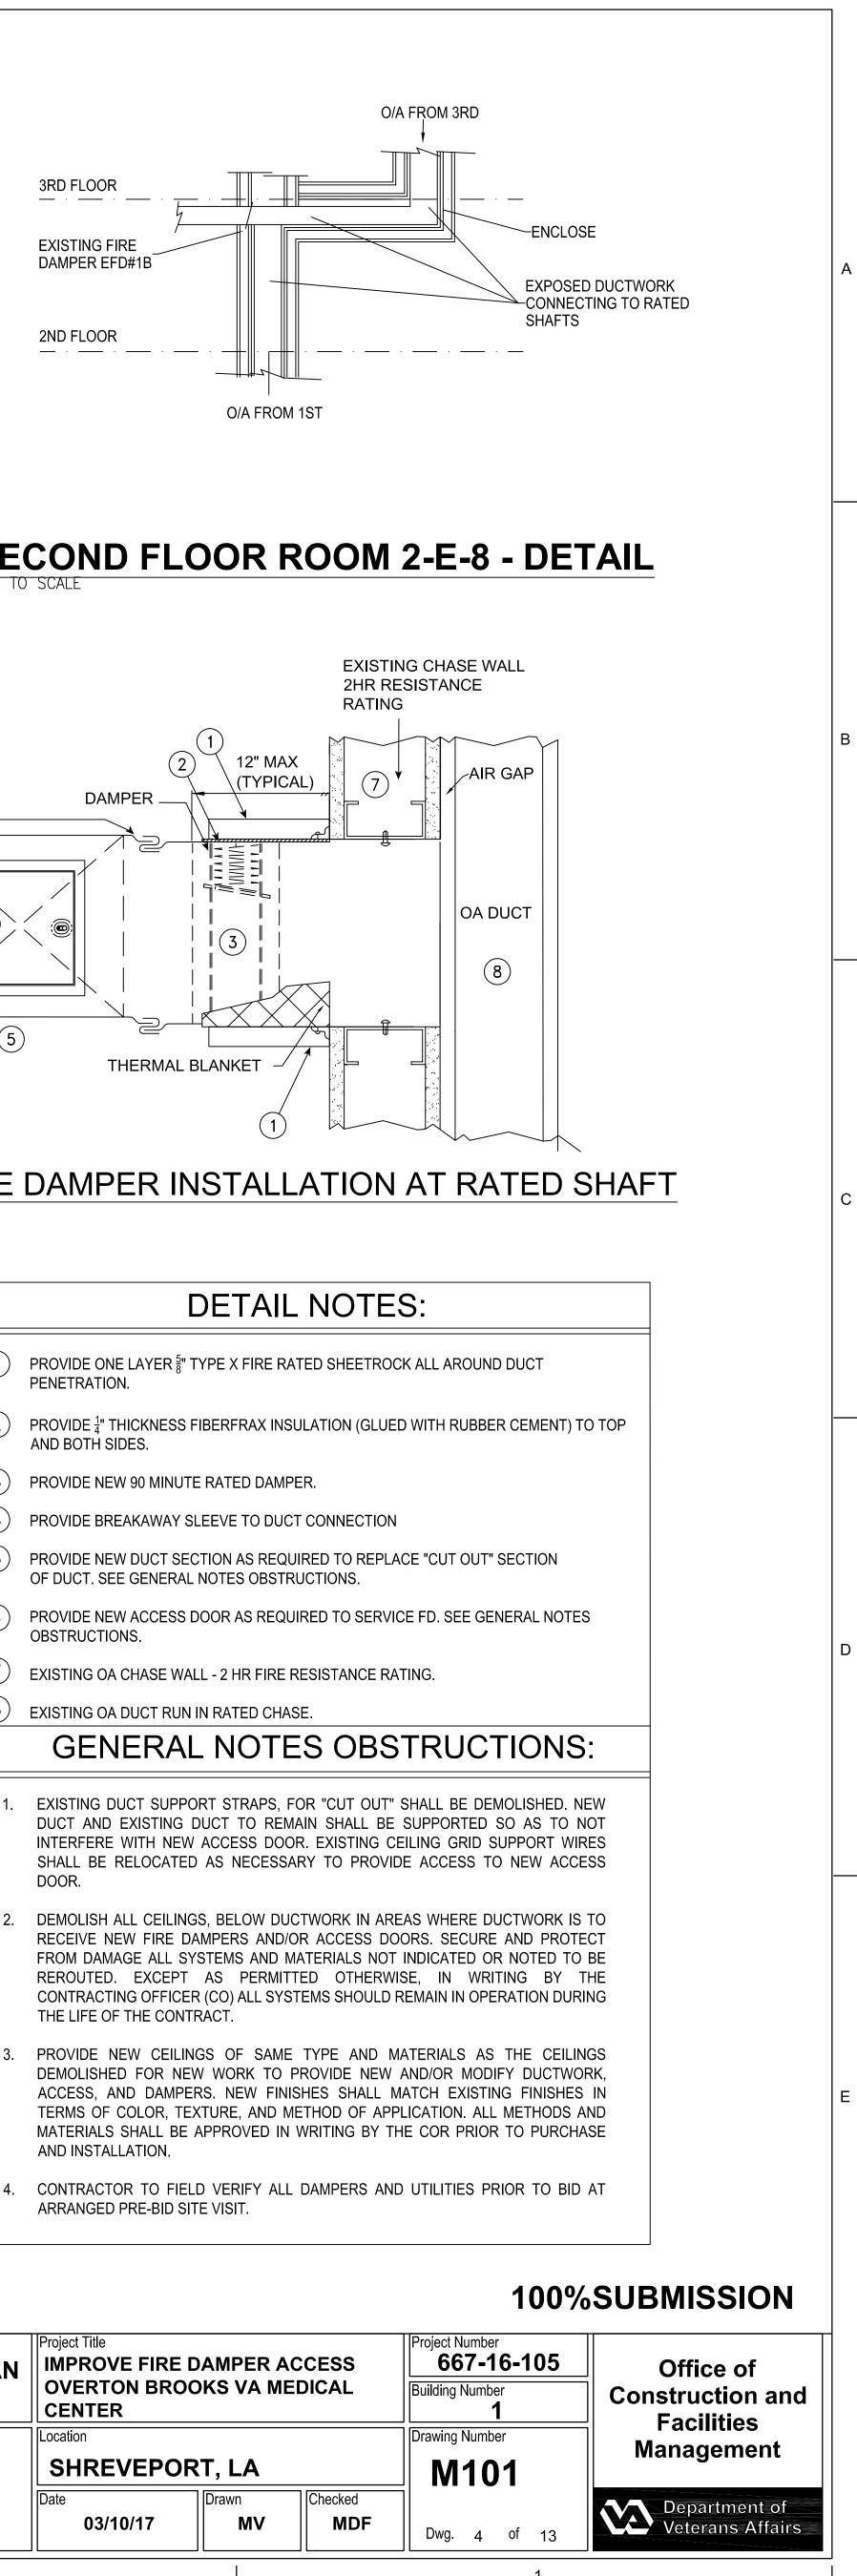



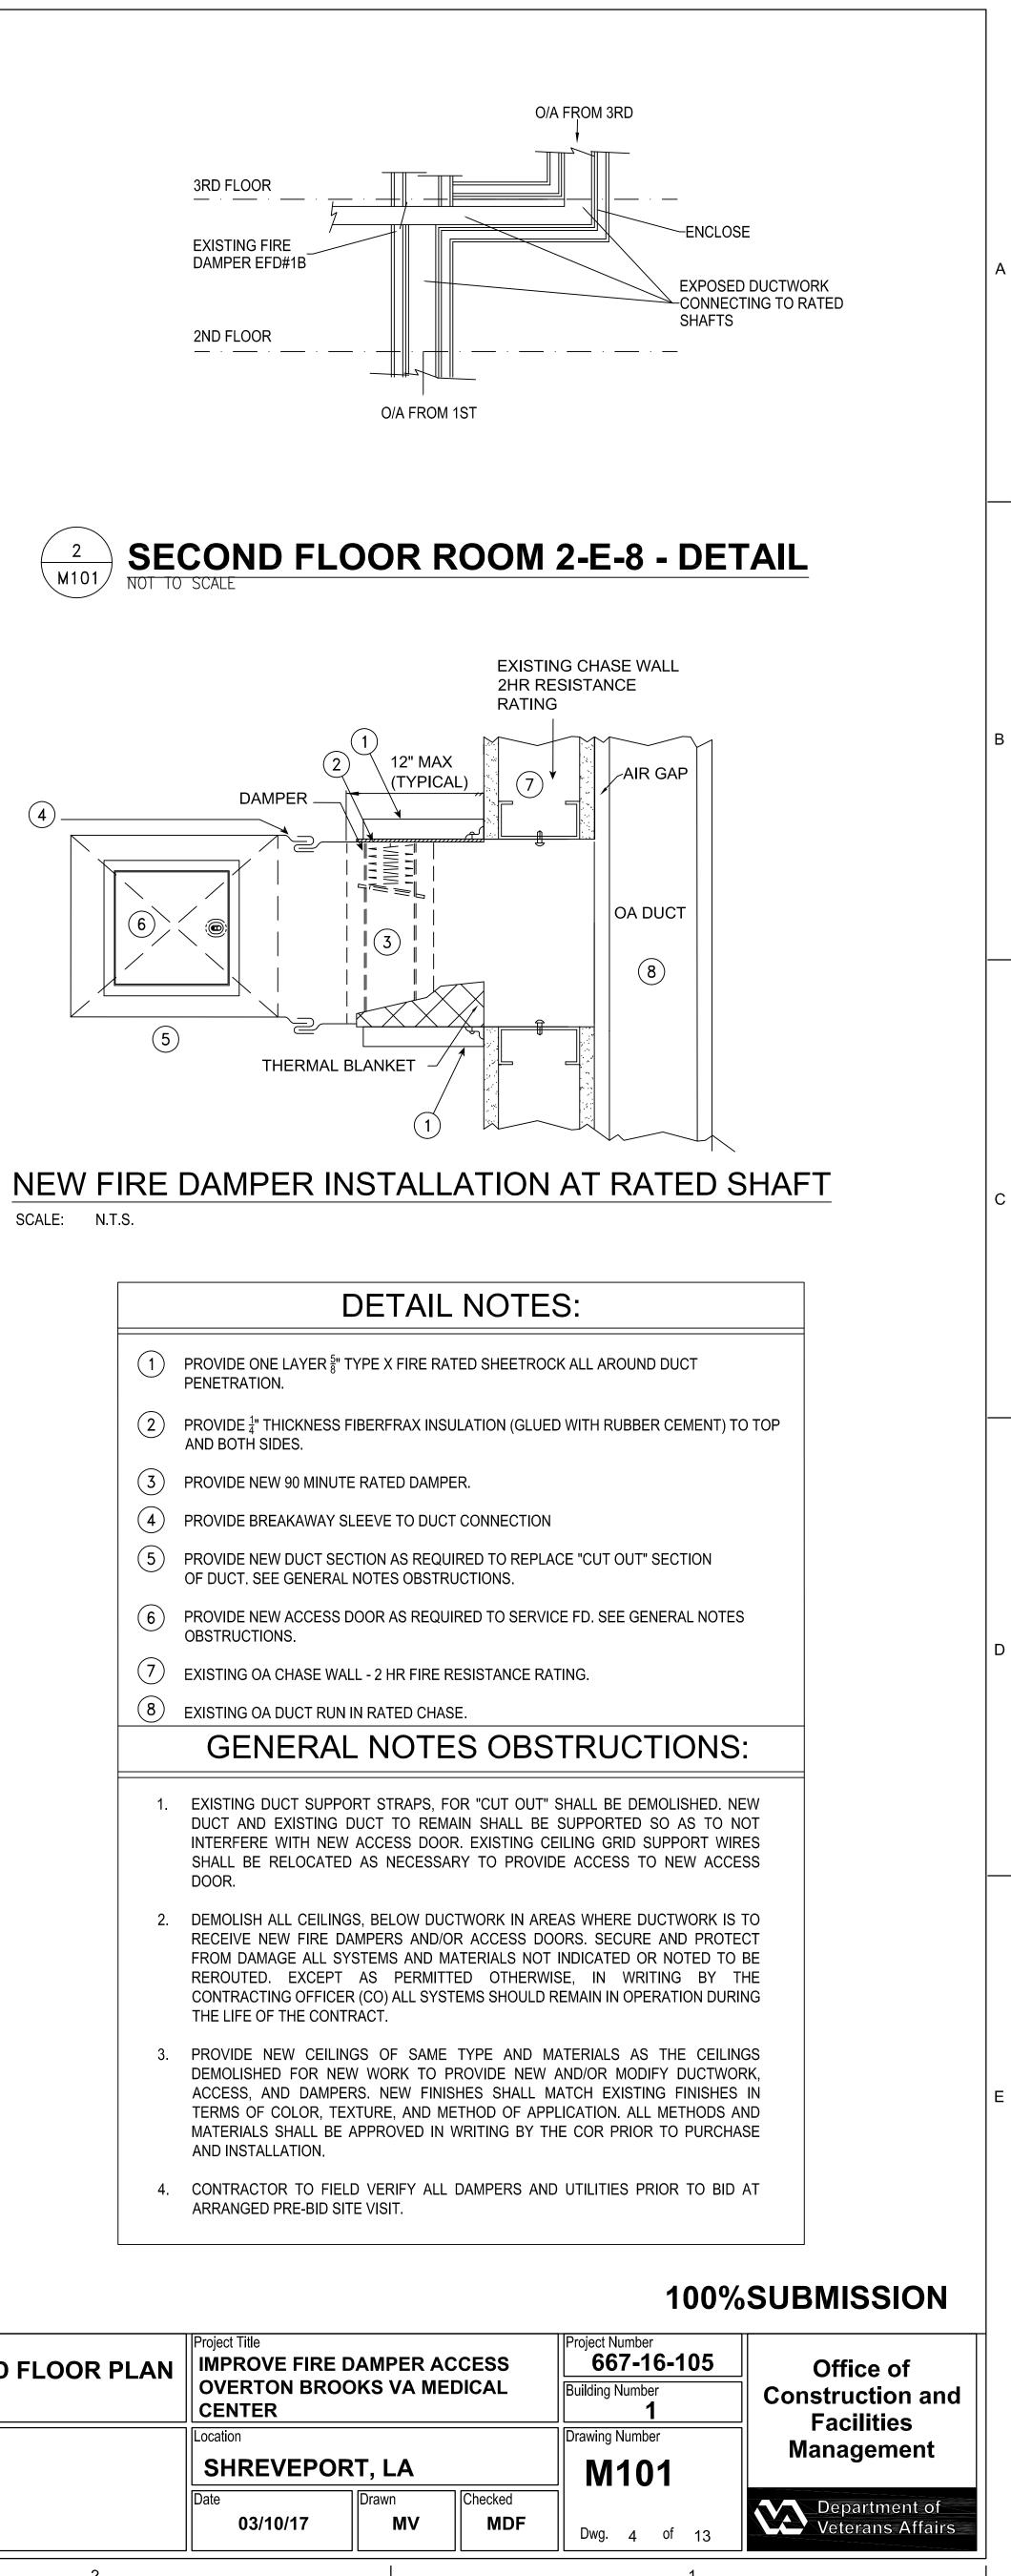

SCALE: N.T.S.

DETAIL NOTES:					
1	PROVIDE ONE LAYER 5" TYPE X FIRE RATED SHEETROCK ALL AROUND E PENETRATION.				
2	PROVIDE $\frac{1}{4}$ " THICKNESS FIBERFRAX INSULATION (GLUED WITH RUBBER AND BOTH SIDES.				
3	PROVIDE NEW 90 MINUTE RATED DAMPER.				
4	PROVIDE BREAKAWAY SLEEVE TO DUCT CONNECTION				
5	PROVIDE NEW DUCT SECTION AS REQUIRED TO REPLACE "CUT OUT" SE OF DUCT. SEE GENERAL NOTES OBSTRUCTIONS.				
6	PROVIDE NEW ACCESS DOOR AS REQUIRED TO SERVICE FD. SEE GENE OBSTRUCTIONS.				
7	EXISTING OA CHASE WALL - 2 HR FIRE RESISTANCE RATING.				
8	EXISTING OA DUCT RUN IN RATED CHASE.				
	GENERAL NOTES OBSTRUCT				
1.	EXISTING DUCT SUPPORT STRAPS, FOR "CUT OUT" SHALL BE DEMO DUCT AND EXISTING DUCT TO REMAIN SHALL BE SUPPORTED SO INTERFERE WITH NEW ACCESS DOOR. EXISTING CEILING GRID SUP SHALL BE RELOCATED AS NECESSARY TO PROVIDE ACCESS TO DOOR.				
2.	DEMOLISH ALL CEILINGS, BELOW DUCTWORK IN AREAS WHERE DUC RECEIVE NEW FIRE DAMPERS AND/OR ACCESS DOORS. SECURE A FROM DAMAGE ALL SYSTEMS AND MATERIALS NOT INDICATED OR I REROUTED. EXCEPT AS PERMITTED OTHERWISE, IN WRITIN CONTRACTING OFFICER (CO) ALL SYSTEMS SHOULD REMAIN IN OPERA THE LIFE OF THE CONTRACT.				
3.	PROVIDE NEW CEILINGS OF SAME TYPE AND MATERIALS AS T DEMOLISHED FOR NEW WORK TO PROVIDE NEW AND/OR MODIFY ACCESS, AND DAMPERS. NEW FINISHES SHALL MATCH EXISTING TERMS OF COLOR, TEXTURE, AND METHOD OF APPLICATION. ALL M MATERIALS SHALL BE APPROVED IN WRITING BY THE COR PRIOR T AND INSTALLATION.				

, LTD. CO. Ste 234 500 , LTD. CO. AL 36532 251.990.37	MECHANICAL SECOND FLOOR PLAN	N Project Title IMPROVE FIRE DAMPER ACCESS OVERTON BROOKS VA MEDICAL CENTER Location SHREVEPORT, LA			667-1
					Drawing Numb
		Date 03/10/17	Drawn MV	Checked MDF	Dwg. 4