


three inches = one foot  
one and one half inches = one foot  
one inch = one foot  
three quarters inch = one foot  
one half inch = one foot  
three eighths inch = one foot  
one quarter inch = one foot  
one eighth inch = one foot

LA Projects \2269 HMC-LB\071 Loma Linda Upgrade\Drawings\18-CAD\ACA\Sheets\AD1-3-3rd-Enlarged Demolition Plan.dwg 6-22-17 01:55:03 PM avila

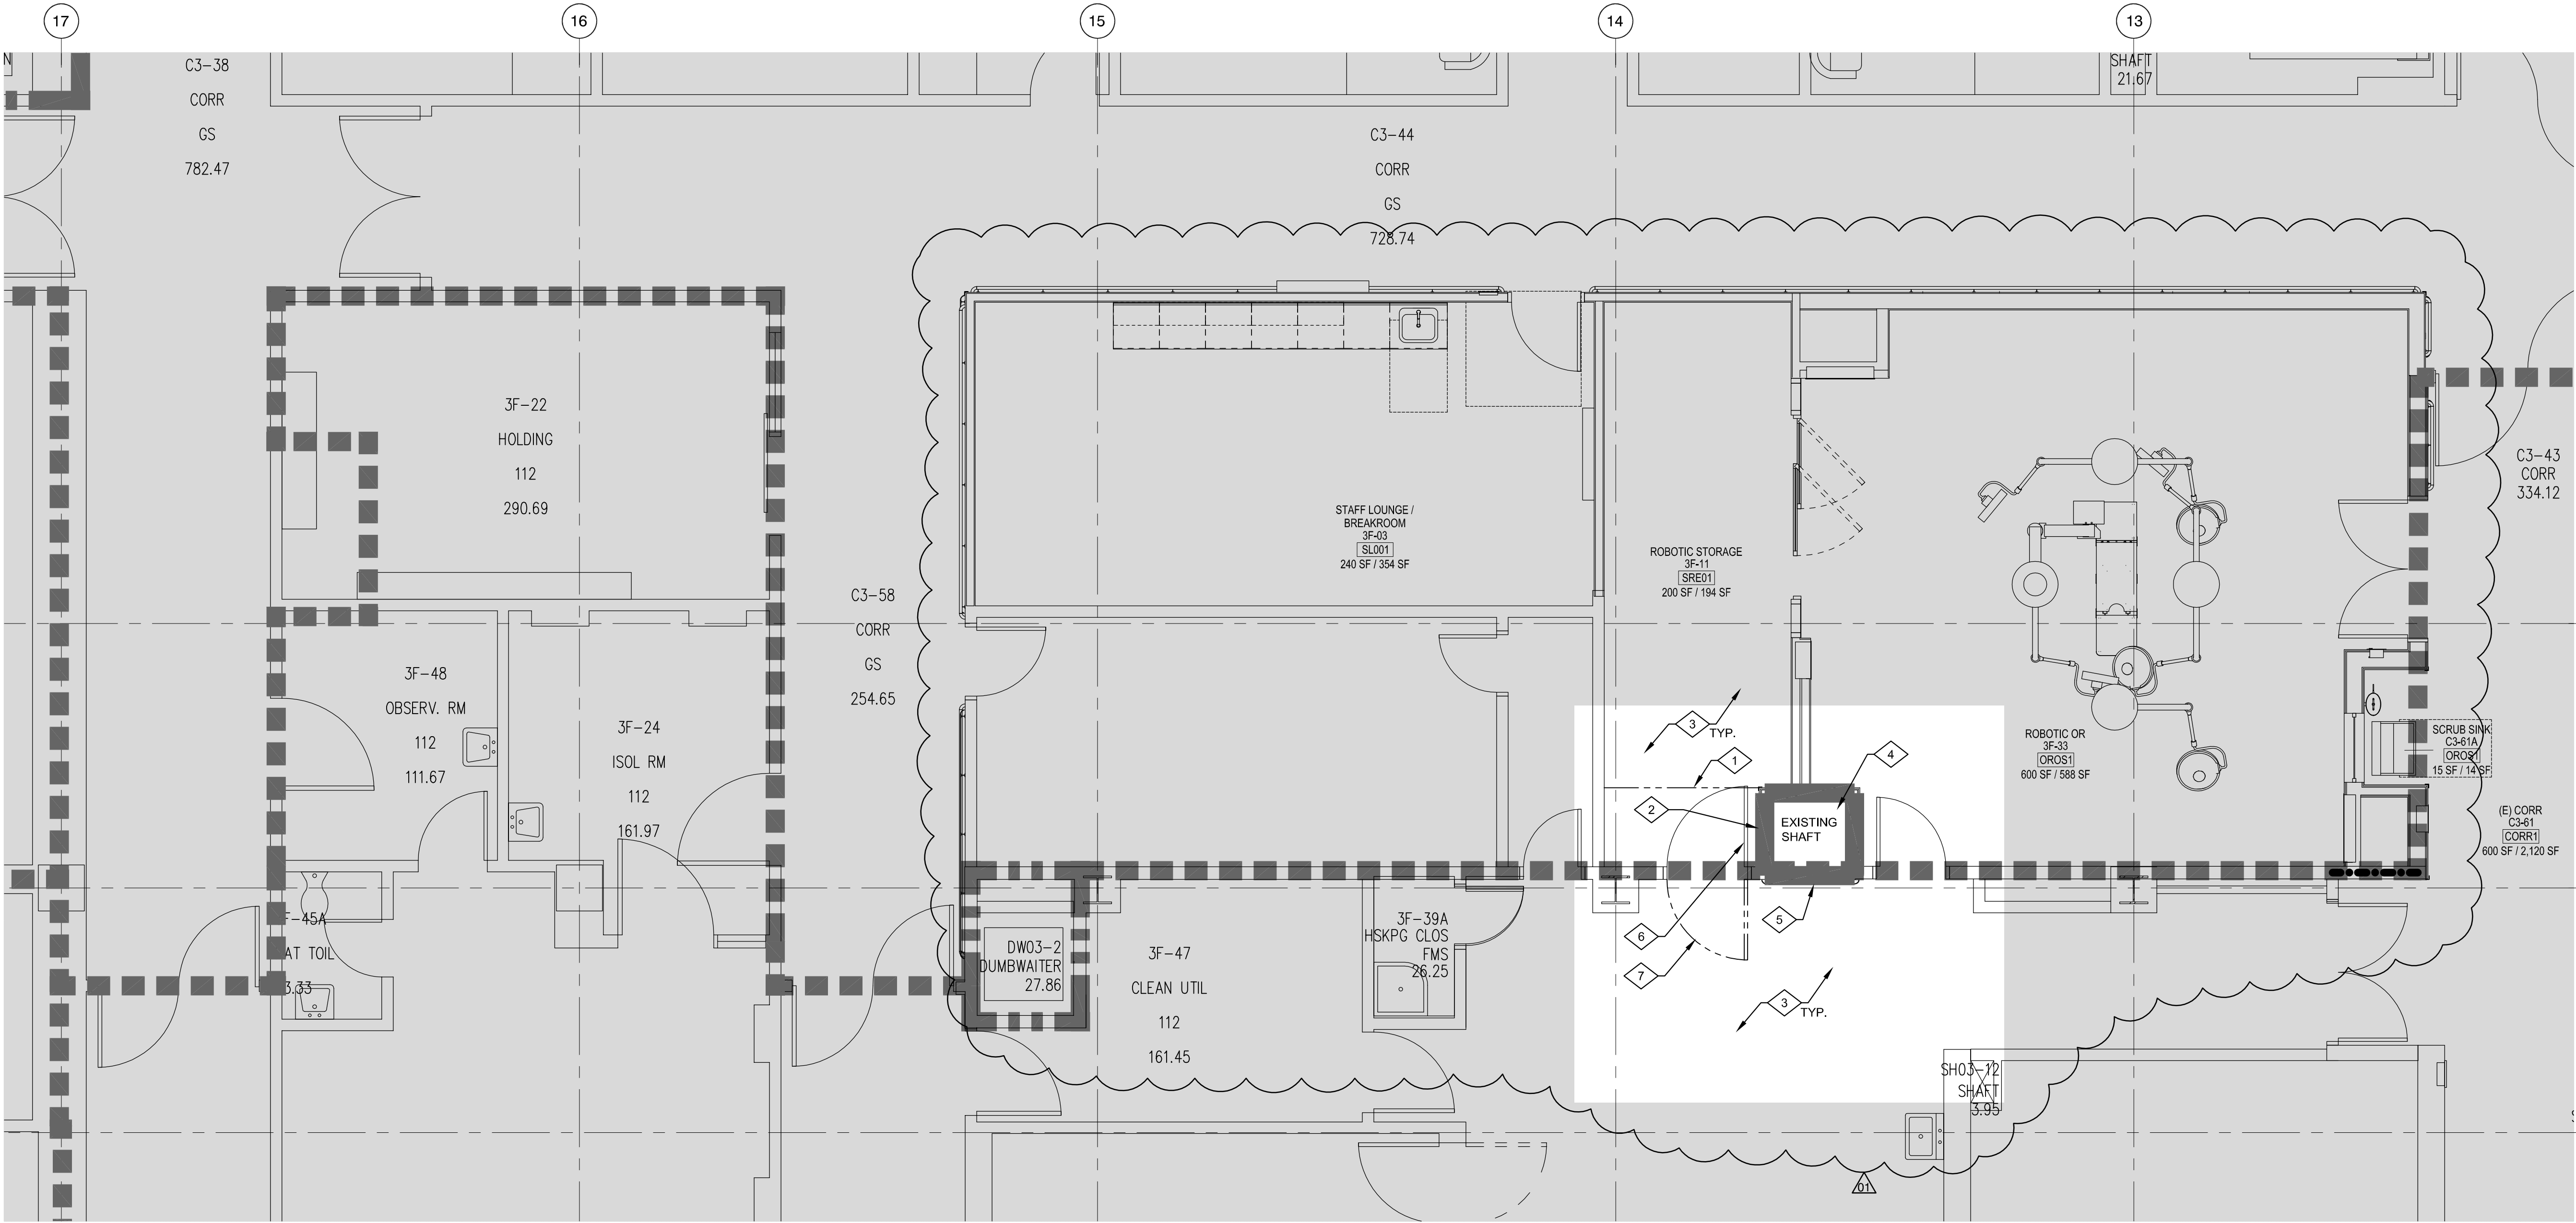

ENLARGED 3RD FLOOR DEMOLITION PLAN

1/4" = 1'-0"

1

| No. | Revision        | Date     |
|-----|-----------------|----------|
| 1   | ADDENDUM No. 01 | 06/22/17 |
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CONSULTANTS:

ARCHITECT/ENGINEERS:



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Architecture • Interiors • Planning

**ARCHITECTS**  
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ONTARIO, CALIFORNIA 91764  
Telephone: 909.989.9979  
Fax: 909.980.8558  
www.hmcarchitects.com

HMC Project #2269071-000

Drawing Title

ENLARGED 3RD FLOOR  
DEMOLITION PLAN

Approved Project Director

Project Title

Canteen Services (2nd Floor)  
Ventilation Upgrade

Location

VA LOMA LINDA HEALTHCARE SYSTEM  
11201 BENTON STREET  
LOMA LINDA, CALIFORNIA 92357

Date

03/30/16

Checked

A. Villa

Drawn

A. Villa

Project Number

605-15-425

Building Number

Drawing Number

**AD1-3**  
Dwg. of

Office of  
Construction  
and Facilities  
Management



GENERAL NOTES

- A. DIMENSIONS ARE TO FACE OF STUD OR CONCRETE. INTERIOR PARTITION DIMENSIONS ARE TO FACE OF STUDS, FACE OF CONCRETE, OR FACE OF MASONRY, UNLESS NOTED OTHERWISE.  
B. ELEVATIONS ARE TO TOP OF CONCRETE OR OTHER HARD SURFACE MATERIAL, NOT TO TOP OF FLOOR COVERING OR ROOFING.  
C. DO NOT SCALE DRAWINGS. USE DIMENSIONS INDICATED.
- DETAILS ARE INTENDED TO SHOW METHOD AND MANNER OF ACCOMPLISHING THE WORK. MINOR MODIFICATIONS MAY BE REQUIRED TO SUIT JOB DIMENSIONS OR CONDITIONS AND SHALL BE INCLUDED AS PART OF THE WORK.
- THE CONTRACTOR SHALL VERIFY ALL DIMENSIONS, ELEVATIONS, AND ALL EXISTING CONDITIONS AT THE SITE BEFORE COMMENCING WORK AND REPORT ANY DISCREPANCIES TO THE ARCHITECT PRIOR TO START OF WORK. IN CASE OF CONFLICT BETWEEN ARCHITECTURAL AND CONSULTANT DRAWINGS, THE ARCHITECT WILL DETERMINE THE CORRECT INTENT OF THE WORK.
- EXHAUST HOOD EQUIPMENT AND RELATED ITEMS ARE CONTRACTOR FURNISHED / CONTRACTOR INSTALLED.


LEGEND

- EXISTING FIRE WALL-1HR.
- EXISTING FIRE WALL-2HR.
- EXISTING SMOKE WALL.
- EXISTING OCCUPANCY SEPERATION-2HR.
- EXISTING CONSTRUCTION TO REMAIN.
- EXISTING CONSTRUCTION TO BE DEMOLISHED.
- TEMPORARY CONSTRUCTION BARRIER. SEE DET. 1 AS-3
- EXISTING LIGHT FIXTURE
- EXISTING LIGHT FIXTURE TO BE RELOCATED.
- RELOCATED LIGHT FIXTURE
- EXISTING RECESSED LIGHTING
- EXISTING PENDANT LIGHT FIXTURE
- EXISTING MECHANICAL DIFFUSER
- EXISTING MECHANICAL DIFFUSER TO BE REPLACED.
- MECHANICAL DIFFUSER
- EXISTING SUSPENDED CEILING
- SUSPENDED CEILING
- SHADED AREA INDICATES NOT WITHIN SCOPE OF WORK

DEMOLITION KEYNOTES

- PROVIDE TEMPORARY CONSTRUCTION BARRIER (HEAVY DUTY PLASTIC SHEET) w/ ZIPPER ACCESS DOOR AS REQUIRED DURING CONSTRUCTION. PROVIDE NEGATIVE AIR PRESSURE w/ MONITOR DEVICE/DISPLAY. MAINTAIN BARRIER DURING CONSTRUCTION.
- PORTION OF EXISTING SHAFT WALL TO BE DEMOLISHED AS REQUIRED FOR (N) ACCESS PANEL. RESTORE LEAD SHIELDING AT SHAFT WALL. REFER TO MECHANICAL DWGS.
- EXISTING FLOOR FINISH TO REMAIN. PROTECT IN PLACE. PATCH & REPAIR ANY INCIDENTAL DAMAGES CAUSED BY WORK.
- EXISTING DUCT SHAFT. PROVIDE EXHAUST DUCT FROM LOWER FLOOR TO ROOF. SEE DET. 5 AS-1 REFER TO MECHANICAL DWGS.
- EXISTING ELECTRICAL PANEL. PROTECT IN PLACE.
- EXISTING DOOR TO BE TEMPORARILY REMOVED AND PLACED IN PROTECTIVE STORAGE. DOOR TO BE REINSTALLED AFTER WORK IS COMPLETED.
- PROVIDE DOOR TO BE USED AS TEMPORARY CONSTRUCTION BARRIER.

KEY PLAN

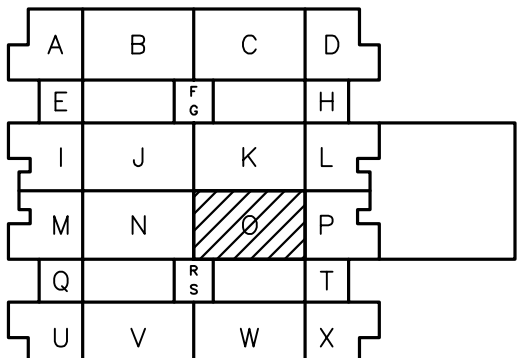


N.T.S.





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VA Projects \2269 HMC-LB\071 Loma Linda Upgrade Canteen Ventilation\18-CAO\CA\Sheets\A2-2.1\_2nd-EnlargedFloorPlan.dwg 6-22-17 01:29:25 PM avila

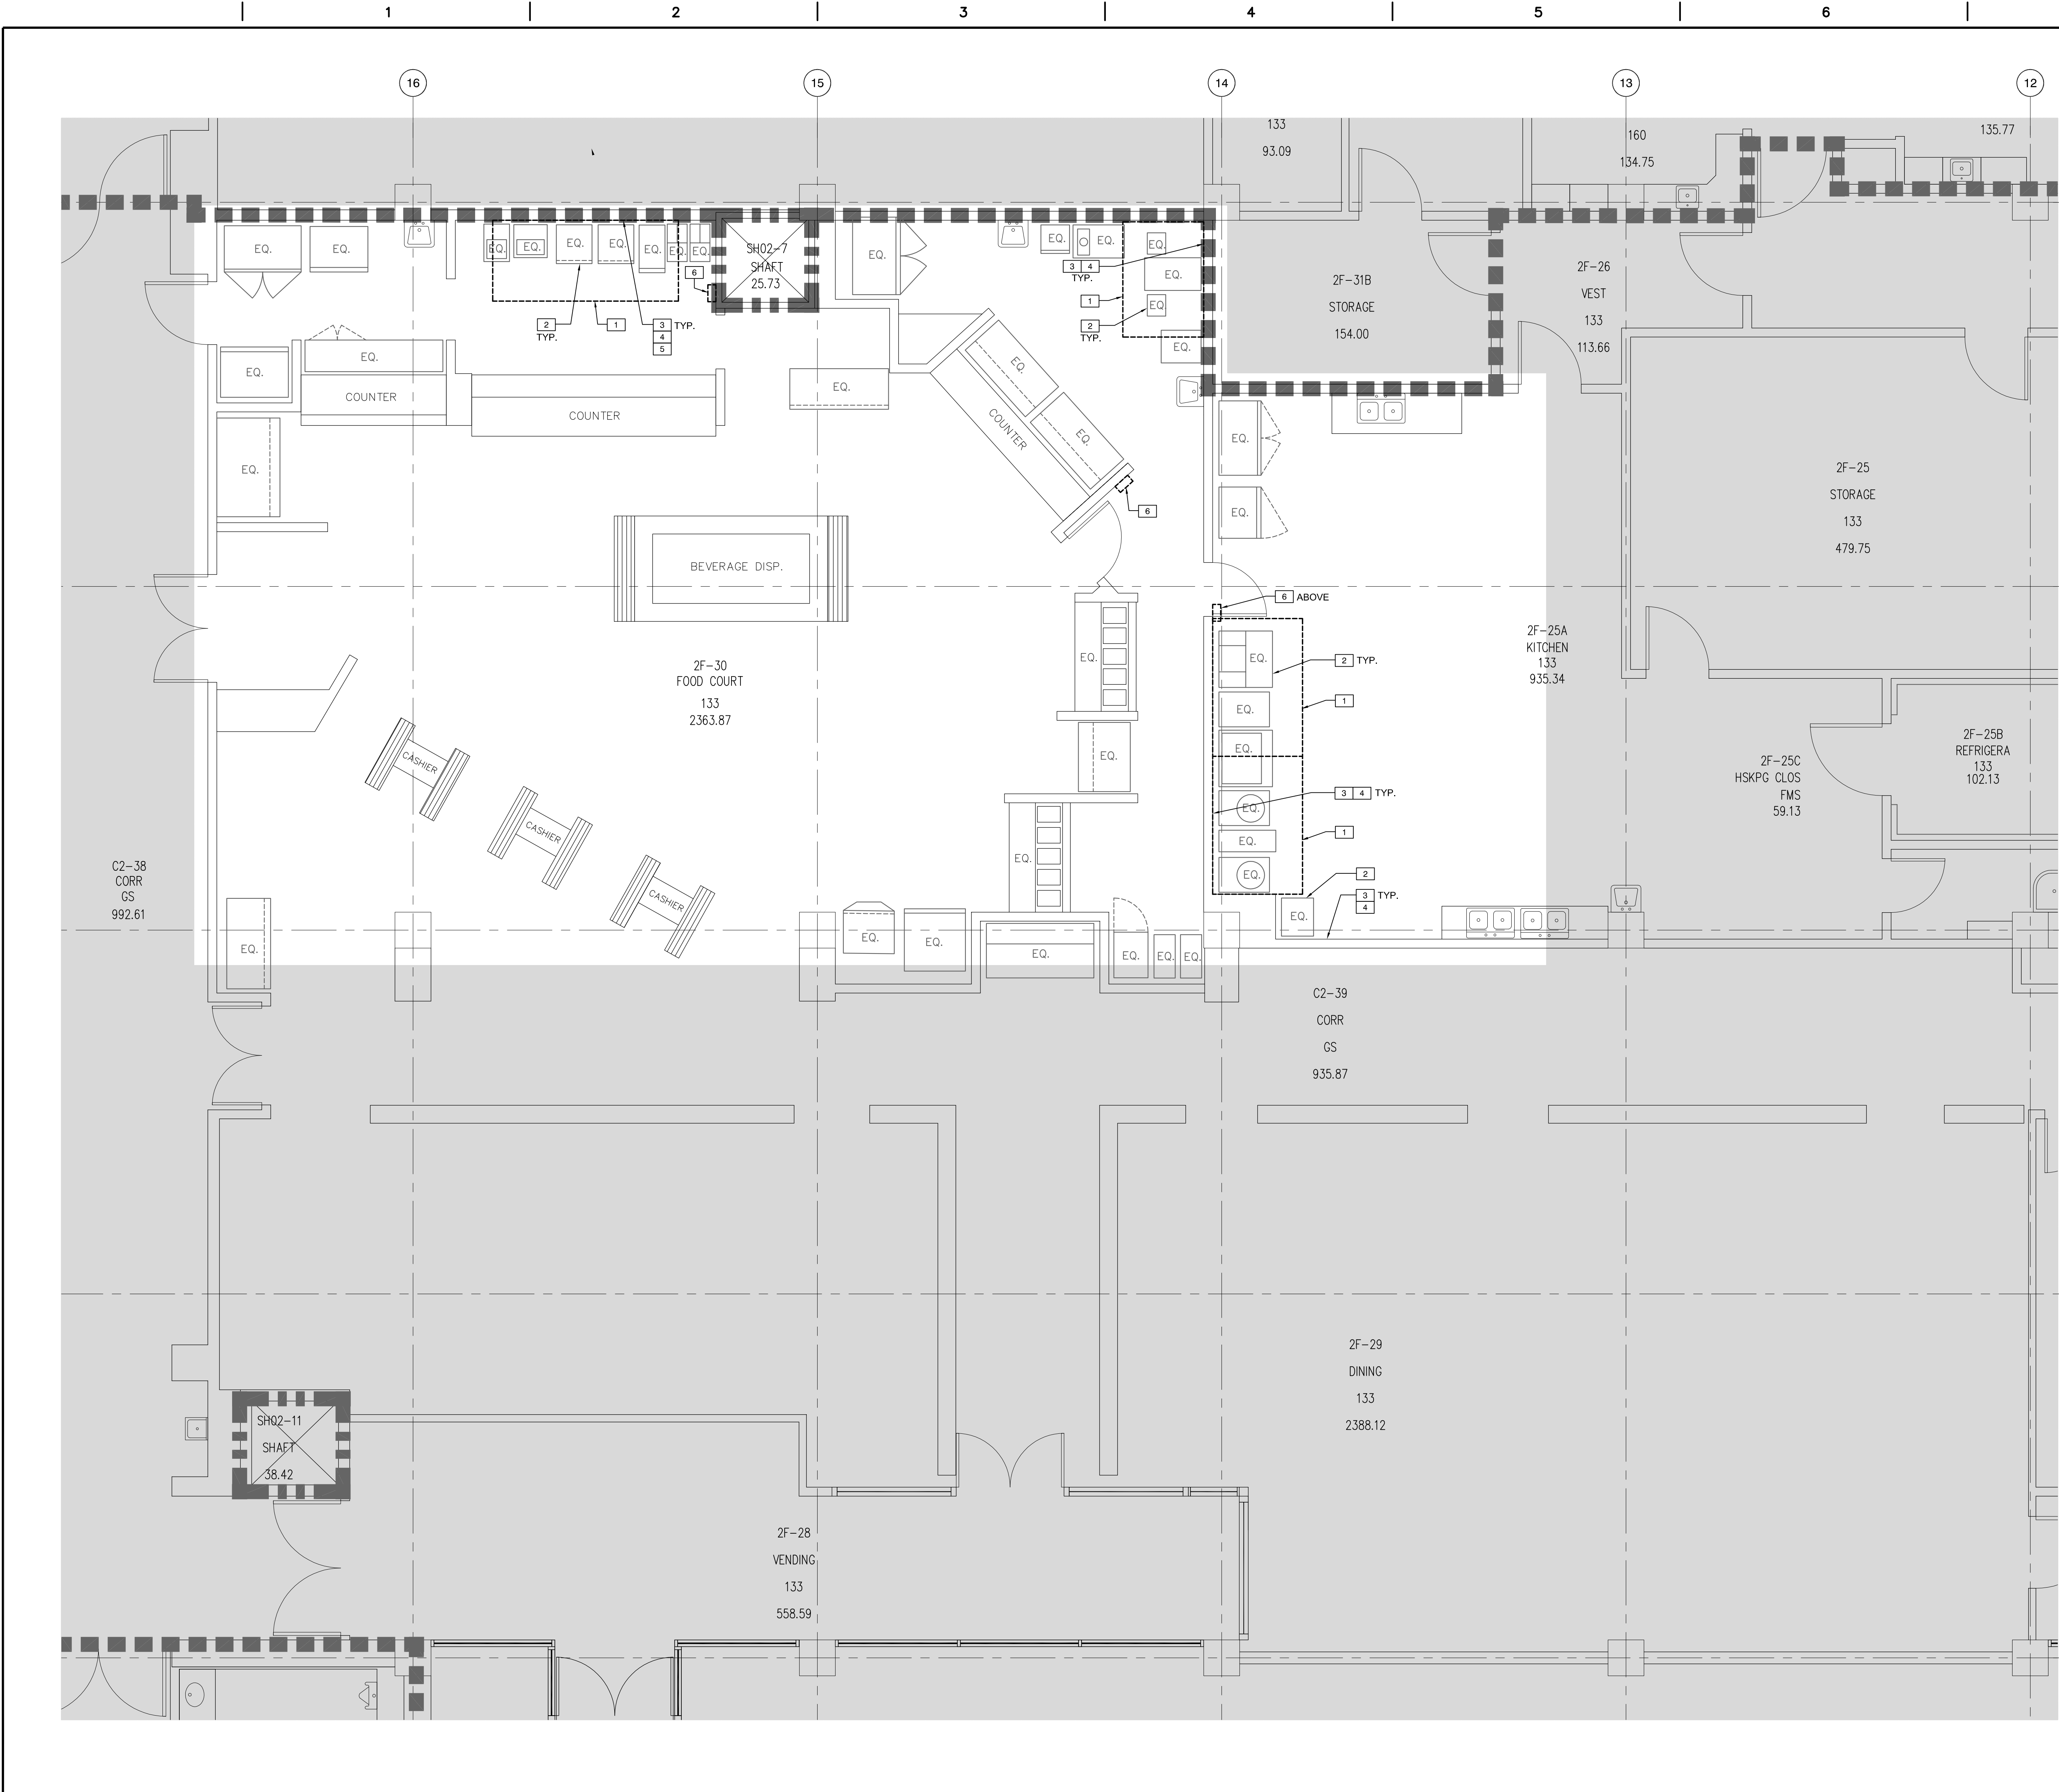

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- FIRE STOPPING AT CONCRETE FLOOR/DECK.
  - PROVIDE FIRE STOP ASSEMBLY PER UL LISTING HNLJ.V-34 AT DUCT FLOOR/DECK PENETRATION.
- ALL DEMOLITION AND WORK THAT WILL CREATE EXCESSIVE NOISE SHALL BE PERFORMED AFTER HOURS. NOISE SHALL BE MINIMIZED TO THE LEAST POSSIBLE.


## LEGEND

- EXISTING FIRE WALL-1HR
- EXISTING FIRE WALL-2HR
- EXISTING SMOKE WALL
- EXISTING OCCUPANCY SEPERATION-2HR
- EXISTING CONSTRUCTION TO REMAIN.
- EXISTING CONSTRUCTION TO BE DEMOLISHED.
- EXISTING 2X4 LIGHT FIXTURE
- EXISTING RECESSED LIGHTING
- EXISTING PENDANT LIGHT FIXTURE
- EXISTING MECHANICAL DIFFUSER
- SHADED AREA INDICATES NOT WITHIN SCOPE OF WORK

## REMODEL KEYNOTES

- EXHAUST HOOD ABOVE (CONTRACTOR FURNISHED / CONTRACTOR INSTALLED). REFER TO MECHANICAL AND EQUIPMENT DWGS. SEE MOUNTING DET.
- EXISTING FOOD SERVICE EQUIPMENT.
- PATCH & REPAIR EXISTING TILE WALL FINISH TO MATCH EXISTING. COORDINATE WITH HOSPITAL FACILITIES FOR TILE COLOR MATCH.
- REPAIR, PATCH, AND PAINT WALL TO MATCH EXISTING.
- STAINLESS STEEL BACKSPASH (CONTRACTOR FURNISHED / CONTRACTOR INSTALLED). FULL HEIGHT TO BOTTOM OF EXHAUST HOOD. INSTALL OVER EXISTING TILED WALL FINISH. REFER TO EQUIPMENT DWGS.
- FIRE SUPPRESSION SYSTEM CONTROL PANEL, REFER TO PLUMBING & ELECTRICAL DWGS.

## KEY PLAN

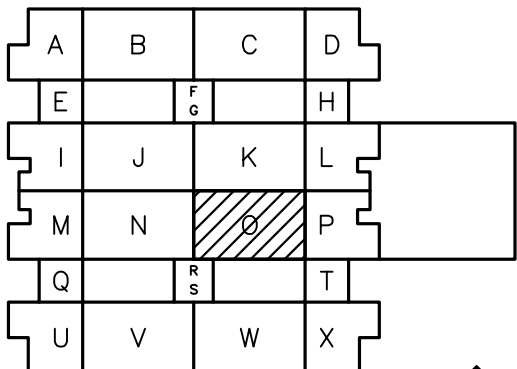

N.T.S.

ENLARGED 2nd FLOOR PLAN

Scale: 1/4" = 1'-0"

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| No. | Revision        | Date     |
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| 1   | ADDENDUM No. 01 | 06/22/17 |
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### CONSULTANTS:

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Telephone: 909 . 989 . 9979  
Fax: 909 . 980 . 8558  
www.hmcarchitects.com

HMC Project #2269071-000

### Drawing Title

ENLARGED 2ND FLOOR PLAN

### Approved Project Director

### Project Title

Canteen Services (2nd Floor)  
Ventilation Upgrade

### Location

VA LOMA LINDA HEALTHCARE SYSTEM  
11201 BENTON STREET  
LOMA LINDA, CALIFORNIA 92357

### Date

03/30/16

### Checked

A. Villa

### Drawn

A. Villa


### Drawing Number

**A2-2.1**  
Dwg. of

Office of  
Construction  
and Facilities  
Management





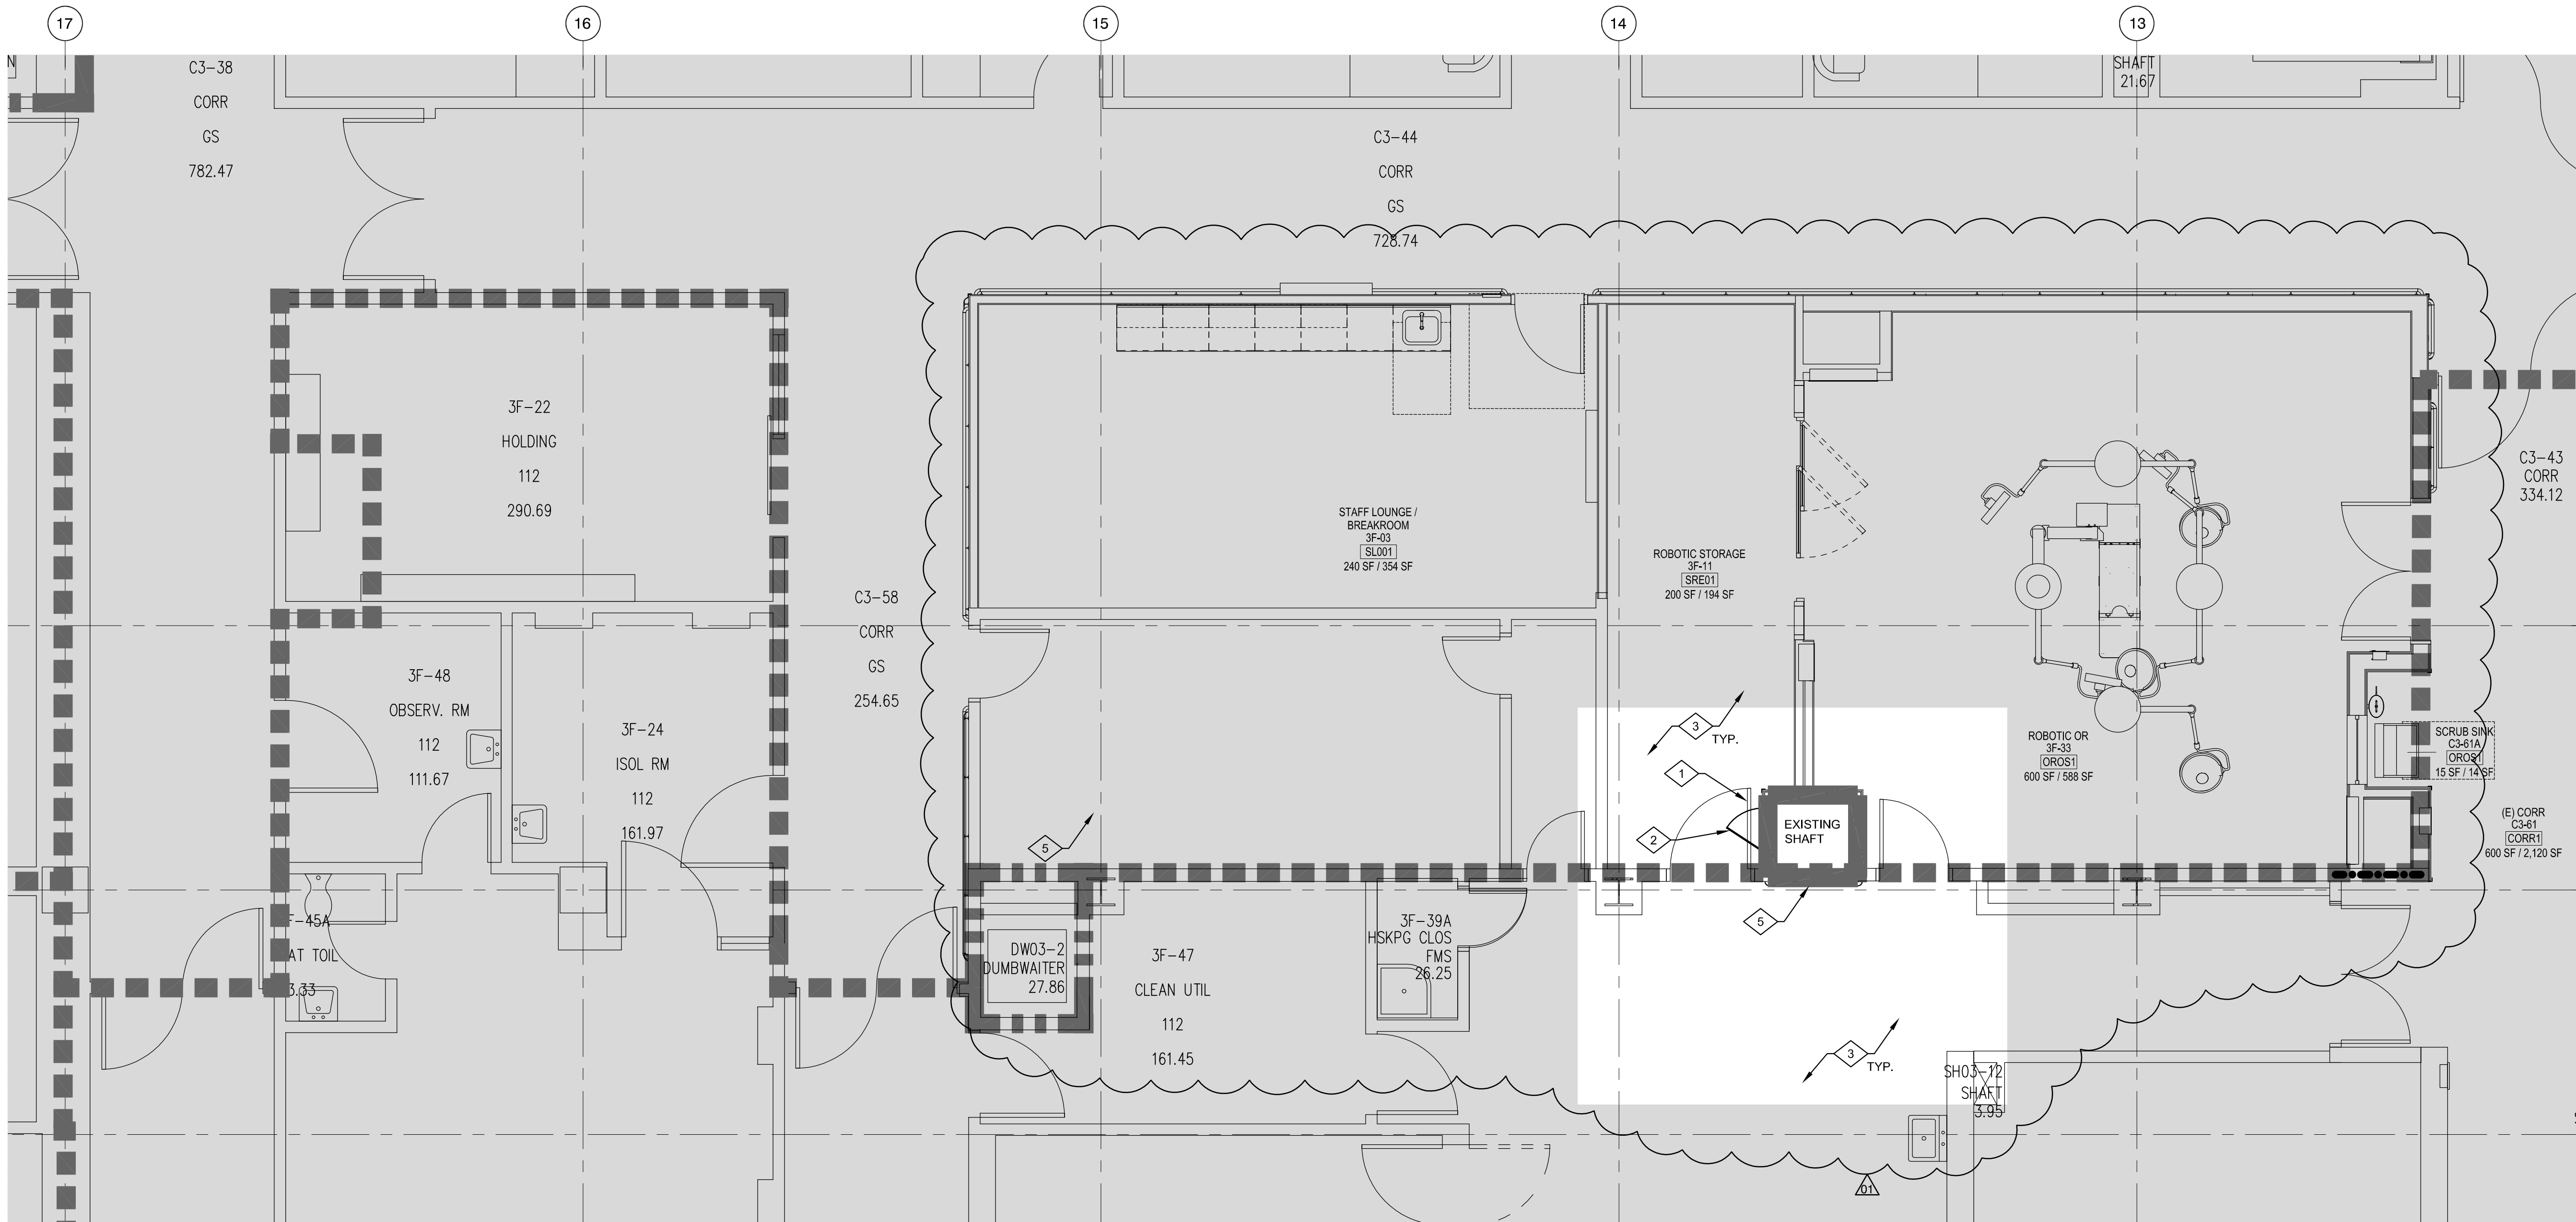

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$$1/4^n = 1'-0''$$

1

CONSULTANTS:

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Architecture • Interiors • Planning

HMC Project #2269071-000

Drawing Title

Approved: Project Director

Project Title

Canteen Services (2nd Floor)  
Ventilation Upgrade

11201 BENTON STREET  
LOMA LINDA, CALIFORNIA 92357

|          |          |   |
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| 03/30/16 | A. Villa | A |
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605-15-425

**Summary:**

Drilling Number  
A C

712

 Department of  
Veterans Affairs

1. A. DIMENSIONS ARE TO FACE OF STUD OR CONCRETE. INTERIOR PARTITION DIMENSIONS ARE TO FACE OF STUDS, FACE OF CONCRETE, OR FACE OF MASONRY, UNLESS NOTED OTHERWISE.
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 EXISTING OCCUPANCY SEPERATION-2HR.  
 EXISTING CONSTRUCTION TO REMAIN.  
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 TEMPORARY CONSTRUCTION BARRIER. SEE DET.

EXISTING LIGHT FIXTURE  
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 EXISTING RECESSED LIGHTING  
 EXISTING PENDANT LIGHT FIXTURE

EXISTING MECHANICAL DIFFUSER  
 MECHANICAL DIFFUSER  
 SHADED AREA INDICATES NOT WITHIN SCOPE OF WORK  
 EXISTING SUSPENDED CEILING  
 SUSPENDED CEILING

1  
 AS-3

- 1 REINSTALL EXISTING DOOR & HARDWARE (TEMPORARILY REMOVED DURING DEMOLITION). CLEAN AND REPAIR ANY INCIDENTAL DAMAGES DURING CONSTRUCTION.
- 2 PROVIDE AND INSTALL 22" X 22" MTL. ACCESS PANEL (WALL MOUNTED) AT EXISTING SHAFT ENCLOSURE.  
SEE DET. 8  
AS-1 REFER TO MECHANICAL DWGS.
- 3 EXISTING FLOOR FINISH TO REMAIN. PROTECT IN PLACE. PATCH & REPAIR ANY INCIDENTAL DAMAGES CAUSED BY WORK.
- 4 EXISTING DUCT SHAFT. PROVIDE EXHAUST DUCT FROM LOWER FLOOR TO ROOF. SEE DET. 5  
AS-1 REFER TO MECHANICAL DWGS.
- 5 EXISTING ELECTRICAL PANEL. PROTECT IN PLACE.

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N.T.S.