


three inches = one foot
one and one half inches = one foot
one inch = one foot
three quarters inch = one foot
one half inch = one foot
one quarter inch = one foot
three eighths inch = one foot
one eighth inch = one foot

EXISTING OUTPATIENT CLINIC FACILITY

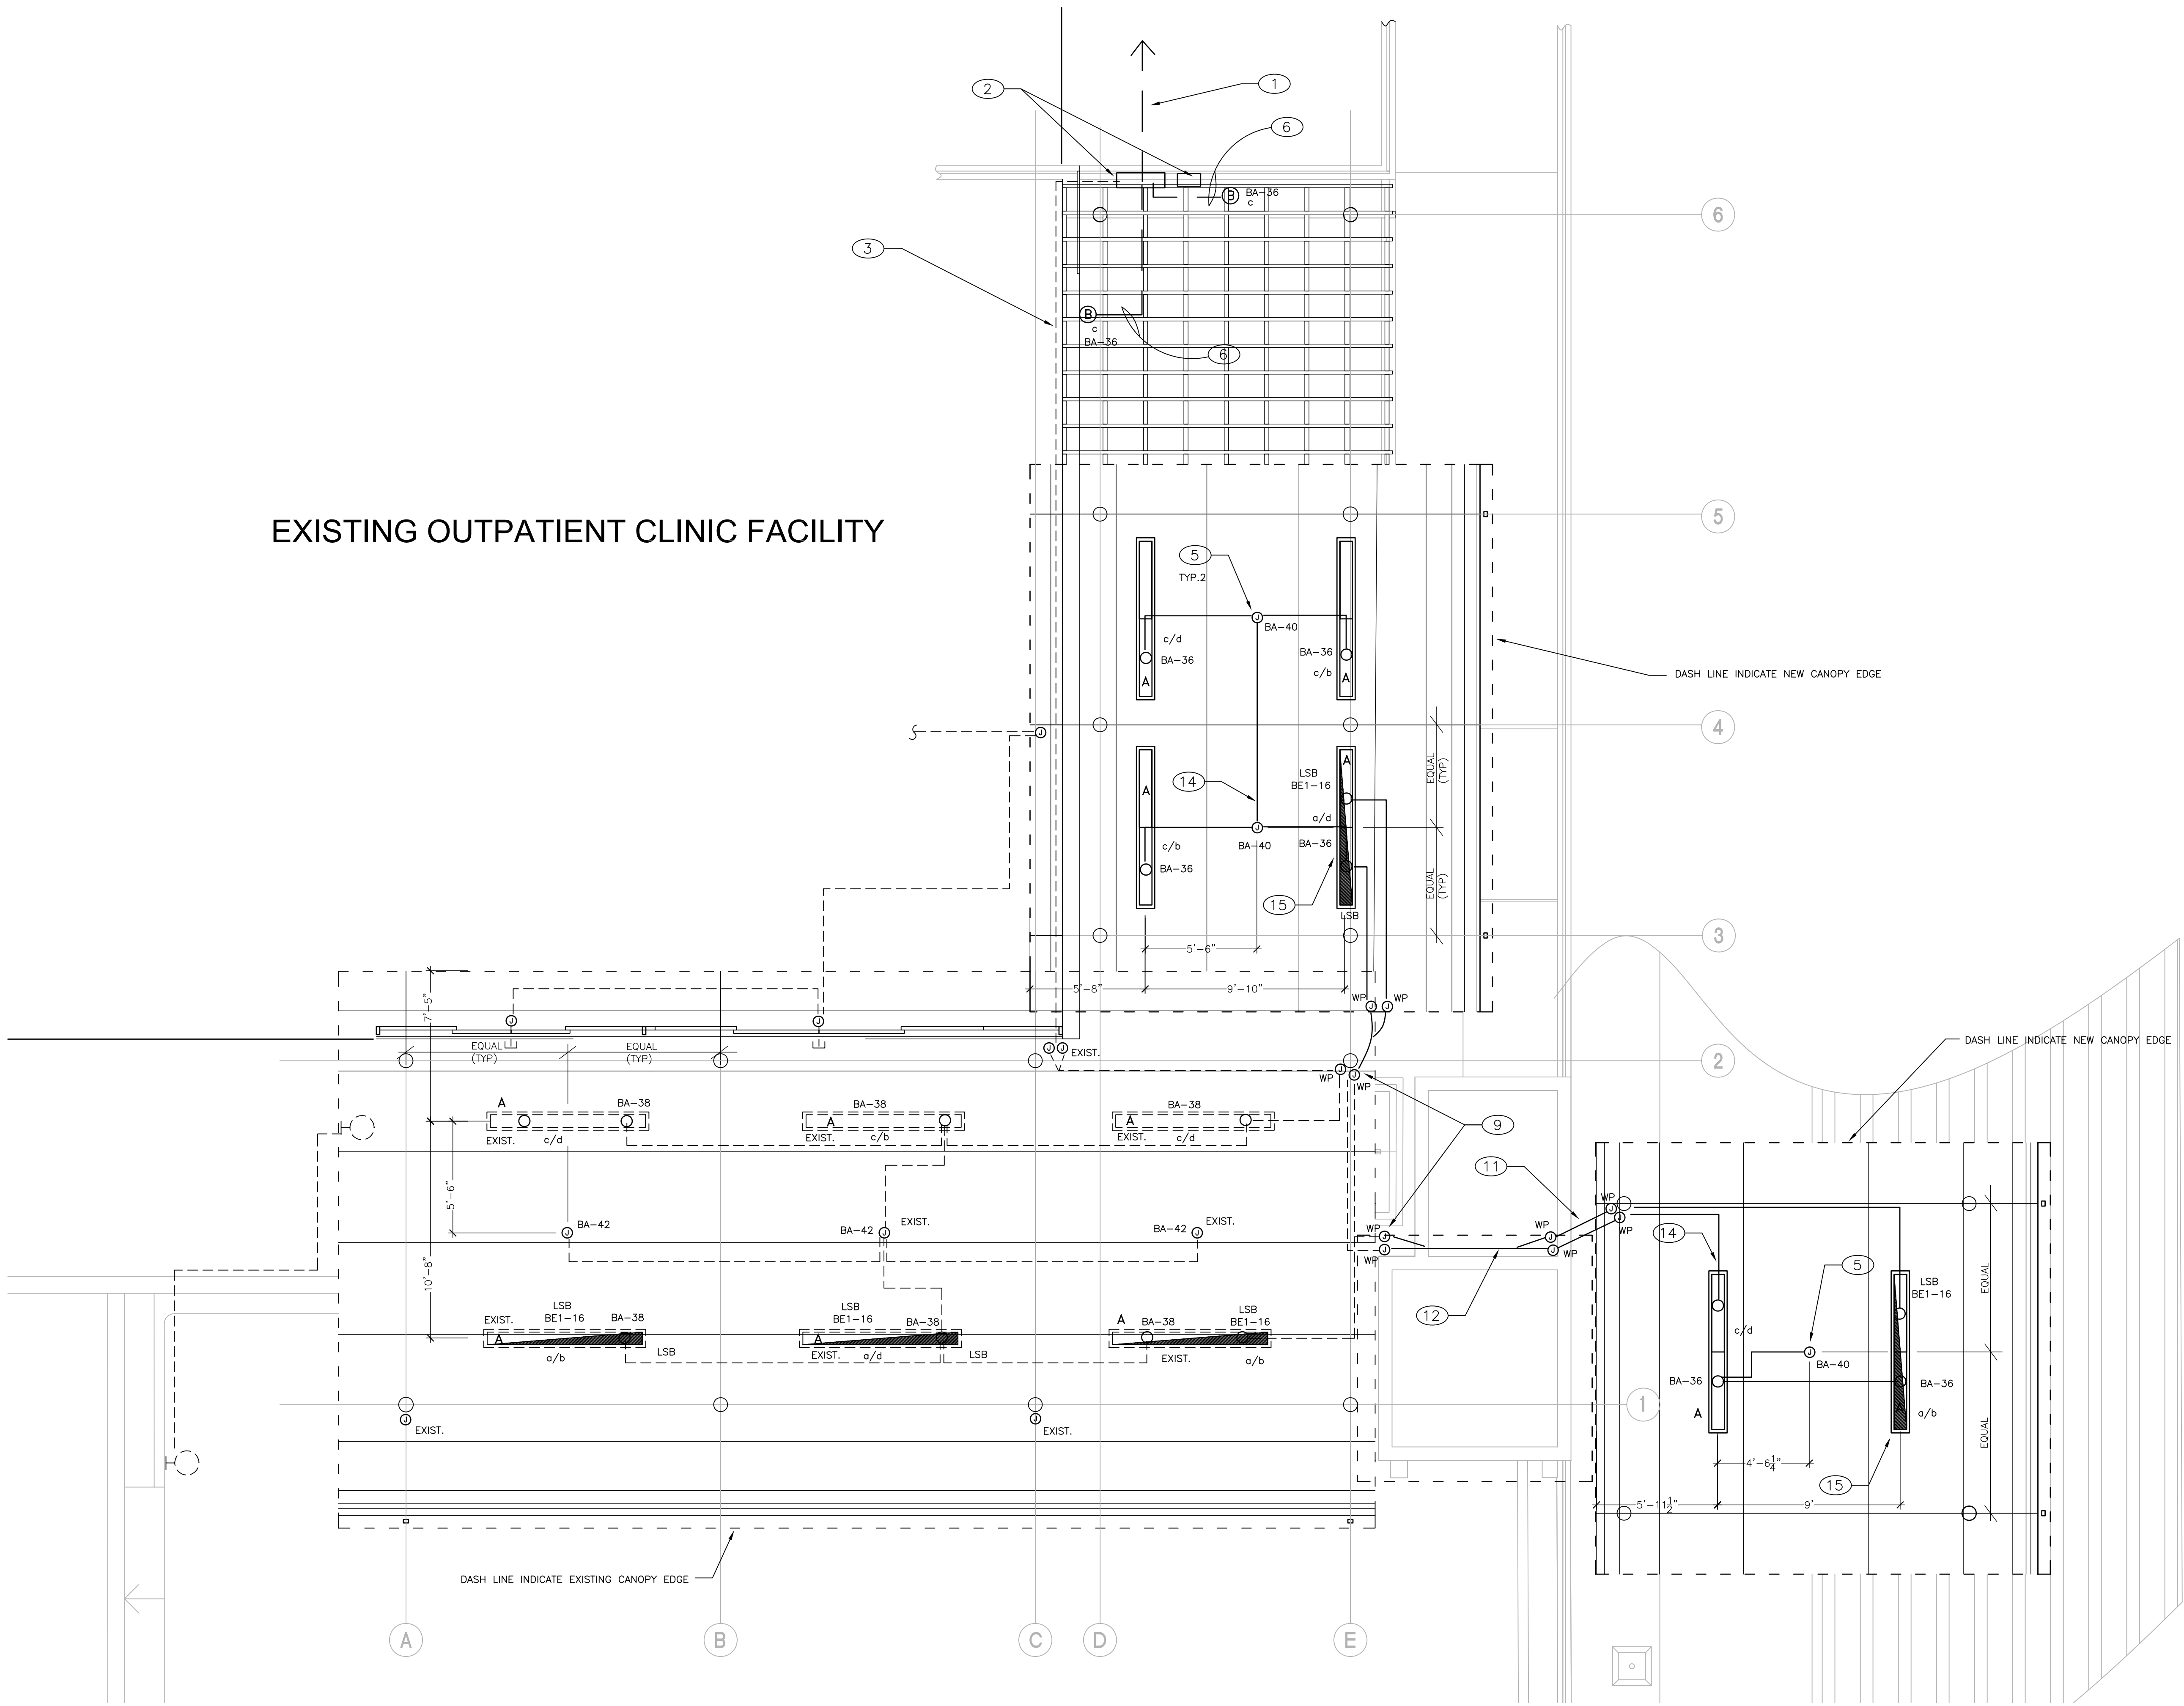

LIGHTING PLAN
SCALE: 1/4"=1'-0"
NORTH

SHEET NOTES

- (E) UNDERGROUND CONDUITS AND HOME RUN TO EXISTING PANELS INSIDE (E) ELECTRICAL CLOSET.
- (E) LIGHTING CONTROL PANEL TERMINAL CABINET SURFACE MOUNT ON RETAINING WALL.
- (E) CONDUITS AND LIGHTING BRANCH CIRCUITS SURFACE MOUNTED BEHIND PARAPET WALL.
- NOT USED.
- TYPICAL 4"SQ STEEL JUNCTION BOX WITH BLANK COVER FOR FUTURE CEILING FAN. CONDUIT RACEWAY SHALL BE INSTALLED INSIDE CANOPY STRUCTURE. NO EXPOSE CONDUIT ALLOW.
- NEW UNDERGROUND CONDUITS AND WIRING FOR LIGHTING BRANCH CIRCUITS.
- NOT USED.
- NOT USED.
- EXISTING CONDUITS STUB OUT BELOW CANOPY. EXTEND EXISTING CONDUITS TO NEW CANOPY AND PULL BACK NEW WIRING PER PLANS. PROVIDE FLEX CONDUITS AND JUNCTION BOXES AS REQUIRED.
- NOT USED.
- PROVIDE WP J-BOX AND FLEX CONDUIT BETWEEN NEW CANOPY AND EXISTING BUILDING STRUCTURE.
- EXPOSE CONDUITS AND WIRING SURFACE MOUNT ON EXTERIOR WALL TO NEW CANOPY IN PARKING LOT LEVEL. PROVIDE UNISTRUT SUPPORT AT 8FT ON CENTER. PAINT CONDUIT AND UNISTRUT TO MATCH COLOR AS REQUIRED. PROVIDE FLEX CONDUITS BETWEEN CANOPY AND WALL. SEE DETAIL 3/E602.
- NOT USED.
- TYPICAL CONDUIT RUN INSIDE CANOPY CAVITY. NO EXPOSED CONDUIT ALLOW ON NEW CANOPY SURFACE.
- PROVIDE POWER CONNECTION FOR (1) 2 LAMP UP LIGHT BALLAST ON EMERGENCY POWER BRANCH CIRCUIT AND (1) 4 LAMP DOWN LIGHT BALLAST ON NORMAL POWER CIRCUIT.

INDICATED PARTIAL SECTION OF LINEAR FIXTURE IS CONNECTED TO EMERGENCY POWER PANEL CIRCUIT.

LSB - EMERGENCY POWER LIFE SAFETY BRANCH CIRCUIT

- NOTES:
- ELECTRICAL CONTRACTOR SHALL PROVIDE TEMPORARY LIGHTING UNDER NEW CANOPY DURING CONSTRUCTION. PROVIDE AVERAGE 30 FOOT-CANDLE ON FLOOR LEVEL, AND PROVIDE EGRESS LIGHTING IN FRONT OF MAIN ENTRANCE AND PATH WAY TO PARKING LOT.
 - ELECTRICAL CONTRACTOR SHALL ATTEND JOB WALK MEETING TO VERIFY EXISTING LOCATION AND CONDITION FOR ALL EXISTING PANELS AND SIGNAL CLOSET PRIOR TO SUBMITTING THE BID PROPOSAL.

100% SUBMITTAL - FOR CONSTRUCTION

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Drawing Title

LIGHTING PLAN

Approved: Project Director

Project Title

CANOPIES AT ER ENTRANCE AREA
AND FLATWORK IMPROVEMENTS

Location

2615 E. Clinton Ave, Fresno, CA

Date
06-07-2012

Checked

Drawn

Project Number

570-11-123

Building Number

Building 1

Drawing Number

E201
Dwg. of --

Office of
Construction
and Facilities
Management

Department of
Veterans Affairs