

three inches = one foot  
 one and one half inches = one foot  
 one inch = one foot  
 three quarters inch = one foot  
 one half inch = one foot  
 three eighths inch = one foot  
 one quarter inch = one foot  
 one eighth inch = one foot


NOTES

EQUIPMENT SCHEDULE - BUILDING 1

ROOM NO.	ROOM NAME	QUANTITY	DESCRIPTION	MANUFACTURER	RESPONSIBILITY				UTILITY REQUIRED			REMARKS
					CFCI	OFCI	OFOI	OFVI	MECH	PLUMB	ELEC	
B1000	ITS Service Center Workshop	1	PHYSICAL ACCESS CONTROL SYSTEM (PACS) CCTV CAMERA		●							1 5 6 7 3 5 6 7
B121	Dietary Kitchen Entrance	1	PHYSICAL ACCESS CONTROL SYSTEM (PACS)		●							1 5 6 7
B122	Dietary Kitchen Entrance	1	PHYSICAL ACCESS CONTROL SYSTEM (PACS)		●							1 5 6 7
B125B	Dietary Kitchen Entrance	1	PHYSICAL ACCESS CONTROL SYSTEM (PACS)		●							1 5 6 7
B128	Dietary Kitchen Entrance	1	PHYSICAL ACCESS CONTROL SYSTEM (PACS)		●							1 5 6 7
B239	Morgue	1	PHYSICAL ACCESS CONTROL SYSTEM (PACS)		●							1 5 6 7
B251	Mechanical Room	1	PHYSICAL ACCESS CONTROL SYSTEM (PACS)		●							1 5 6 7
B165	Telephone Switch Room	1	PHYSICAL ACCESS CONTROL SYSTEM (PACS) CCTV CAMERA		●							1 5 6 7 3 5 6 7
B217B	Escort	1	PHYSICAL ACCESS CONTROL SYSTEM (PACS)		●							1 5 6 7
B135	Basement West	1	PHYSICAL ACCESS CONTROL SYSTEM (PACS)		●							1 5 6 7
B108A	Canteen Storage Area	1	PHYSICAL ACCESS CONTROL SYSTEM (PACS)		●							1 5 6 7
B172	Warehouse Storage	1	PHYSICAL ACCESS CONTROL SYSTEM (PACS)		●							1 5 6 7
B223	New Linen Storage	1	PHYSICAL ACCESS CONTROL SYSTEM (PACS)		●							1 5 6 7
B233A	New Linen Storage	1	PHYSICAL ACCESS CONTROL SYSTEM (PACS)		●							1 5 6 7
B194	Radiation	1	PHYSICAL ACCESS CONTROL SYSTEM (PACS)		●							1 5 6 7
B177	IT Room	1	PHYSICAL ACCESS CONTROL SYSTEM (PACS)		●							1 5 6 7

LEGEND:  
 CFC CONTRACTOR FURNISHED CONTRACTOR INSTALLED  
 OFCI OWNER FURNISHED CONTRACTOR INSTALLED  
 OFOI OWNER FURNISHED OWNER INSTALLED  
 OFVI OWNER FURNISHED VENDOR INSTALLED  
 PACS PHYSICAL ACCESS CONTROL SYSTEM  
 CCTV CLOSED CIRCUIT TELEVISION CAMERA  
 DSPI DURESS, SECURITY PHONES, & INTERCOM SYSTEM  
 IDS INTRUSION DETECTION SYSTEM


EQUIPMENT NOTES:  
 1. PACS - CONTRACTOR SHALL VERIFY WITH OWNER THAT PACS EQUIPMENT IS COMPATIBLE WITH EXISTING SECURITY SUBSYSTEMS USING DIRECT HARDWARE OR COMPUTER INTERFACE. PACS SHALL HAVE THE CAPABILITY TO BE INTEGRATED WITH CARD READERS, KEYPADS, BIOMETRICS, ELECTROMAGNETIC LOCKS AND STRIKES, AND THE VA SECURITY MANAGEMENT SYSTEM.  
 2. ALARM SYSTEM - CONTRACTOR SHALL VERIFY WITH OWNER THAT INTRUSION & PANIC ALARM EQUIPMENT IS COMPATIBLE WITH OTHER SECURITY SUBSYSTEMS USING DIRECT HARDWARE OR COMPUTER INTERFACE. INTRUSION DETECTION & INTERCOM SYSTEMS SHALL HAVE THE CAPABILITY TO BE INTEGRATED WITH DSPI, PACS, AND CCTV SYSTEMS.  
 3. CCTV - CONTRACTOR SHALL VERIFY WITH OWNER THAT CCTV CAMERA EQUIPMENT IS COMPATIBLE WITH THE EXISTING VA IP MEGAPIXEL CAMERAS, SERVERS, AND ENCODERS AND TIE INTO EXISTING CAMERA SUBSYSTEMS. THE CCTV SYSTEM INCLUDES CAMERAS, MONITORS, CONTROLLING & RECORDING EQUIPMENT, AND CENTRALIZED MANAGEMENT & OPERATION OF THE SYSTEM.  
 4. DRUG CABINET - CONTRACTOR SHALL PROVIDE ANCHORAGE TO FLOOR AS NECESSARY AND RECOMMENDED BY EQUIPMENT MANUFACTURER.  
 5. ALL EQUIPMENT SHALL BE FROM BASIS OF DESIGN "OR EQUAL".  
 6. TYPE: CONTRACTOR SHALL COORDINATE EQUIPMENT PROGRAMMING & TESTING W/VA 'PROJECT' PHYSICAL SECURITY SPECIALIST.  
 7. TYPE: CONTRACTOR SHALL VERIFY EXISTING POWER SUPPLY IS SUFFICIENT FOR PACS, CCTV, DSPI & IDS SYSTEMS; AND INSTALL ADDITIONAL POWER SYSTEMS AS NEEDED.

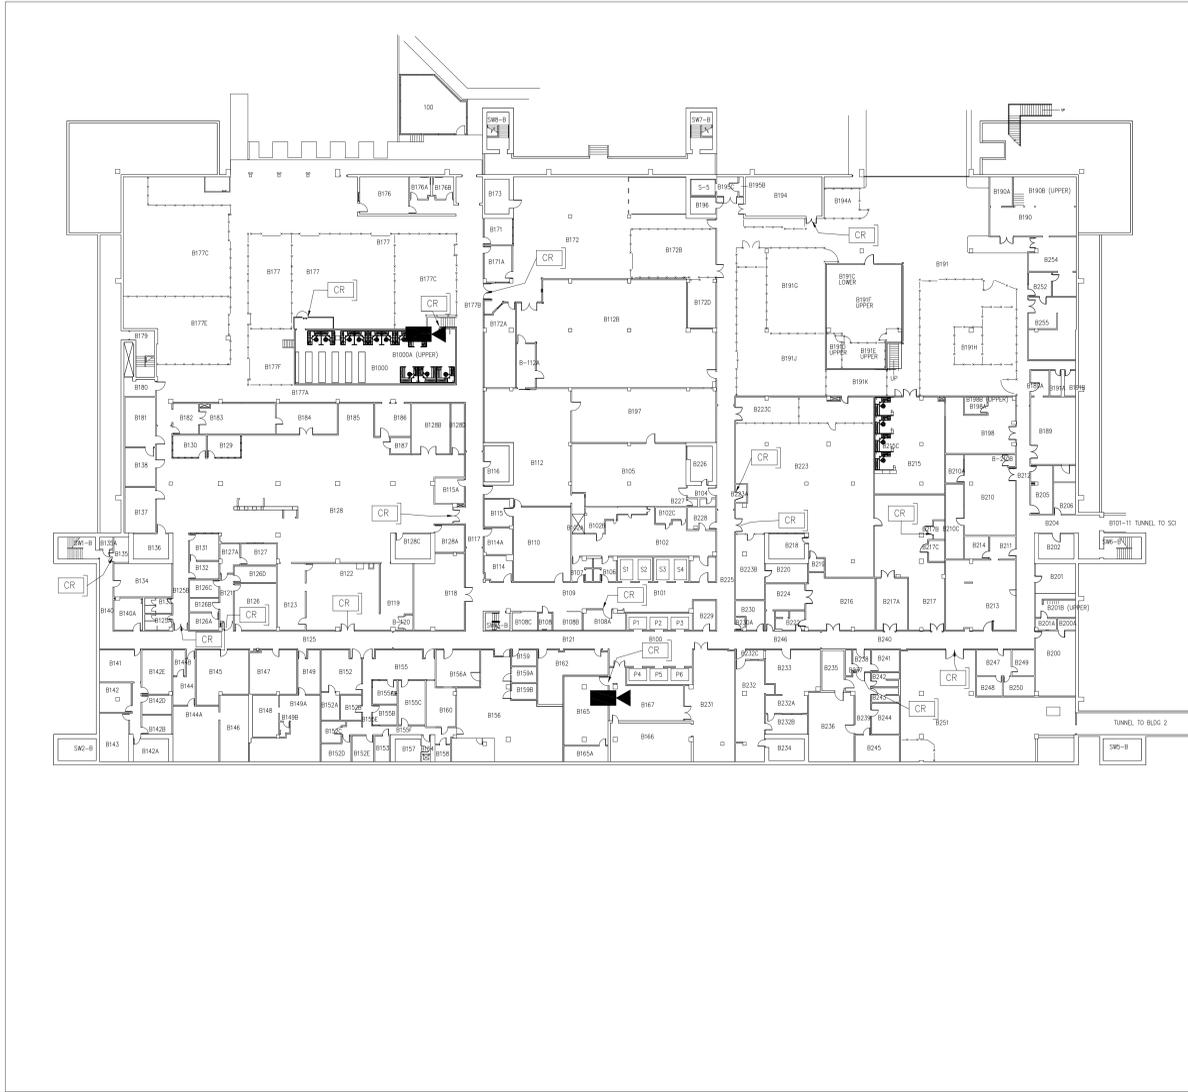

LEGEND

NEW FIXED CCTV CAMERA IN HOUSING (CCTV)  
 CARD READER / PIV / (PACS) (SEE 1/GN-002)

NOTE: CONTRACTOR SHALL FIELD VERIFY ALL EXISTING CONDITIONS AND DIMENSIONS PRIOR TO CONSTRUCTION. COORD. W/VA ENGINEERING SERVICES IN THE EVENT OF A DISCREPANCY. EXECUTION OF THE WORK SHALL INDICATE ACCEPTANCE OF THE EXISTING CONDITIONS.

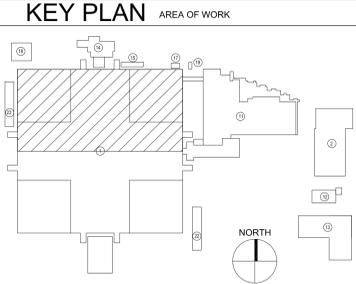

1 EQUIPMENT SCHEDULE

2 BASEMENT FLOOR PLAN  
 SCALE: 1/8" = 1'-0"

Number	Revisions	Date

CONTRACTOR:

ARCHITECT/ENGINEERS:  
**San Diego**  
 ENGINEERING SERVICES

Drawing Title  
**BUILDING 1 BASEMENT FLOOR PLAN**

Approved: Project Director

Project Title  
**CONTROLLED ACCESS  
 VA SAN DIEGO**

Location  
**SAN DIEGO, CA**

Date  
**05/04/2017**

Checked  
 YNP

664-17-405  
 Building Number  
**1**

Drawing Number  
**AE-100**  
 Dwg 3 of 12

Office of  
 Construction  
 and Facilities  
 Management