

UPON COMPLETION OF THE PROJECT, THE CONTRACTOR SHALL SCHEDULE AND PERFORM A COMPLETE FUNCTIONAL TEST TO DEMONSTRATE TO VA CONTRACTING OFFICER REPRESENTATIVE (COR) THAT THE SYSTEMS ARE OPERATING AS INTENDED. ANY DEFECTS OR DISCREPANCIES IN THE MATERIAL OR WORK SHALL BE CORRECTED IMMEDIATELY TO THE SATISFACTION OF THE CONTRACTING OFFICER REPRESENTATIVE (COR) AT NO ADDITIONAL COST, NOISY OPERATION AND/OR VIBRATION TRANSMISSION TO THE BLDG. STRUCTURE WILL NOT BE ACCEPTED.

## D. GENERAL REQUIREMENTS:

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- 1. DRAWINGS ARE DIAGRAMMATIC, AND INDICATE GENERAL ARRANGEMENT OF THE PIPING/PLUMBING SYSTEMS ONLY. THE CONTRACTOR SHALL FIELD COORDINATE ALL PIPING INSTALLATION WITH ALL TRADES.
- 2. BRACE AND SUPPORT ALL PIPING AND MECHANICAL EQUIPMENT IN ACCORDANCE WITH THE MANUFACTURER'S GUIDELINES, VA STANDARDS AND THE LATEST SMACNA GUIDELINES.
- 3. PROVIDE ALL VALVES AND OTHER PIPING SPECIALTIES AS FULL-LINE SIZE, UNLESS OTHERWISE SHOWN.
- 4. SHUT-OFF VALVES SHOWN ARE ONLY SYMBOLS AND DO NOT REFLECT THE VALVE TYPE OR MATERIALS. CONTRACTOR SHALL PROVIDE AND INSTALL VALVES WITH CONSTRUCTION AND MATERIAL COMPLYING WITH SPECIFICATIONS.
- 5. SEAL AROUND ALL PIPES PENETRATING FIRE RATED WALLS AND CONCRETE FLOOR WITH UL LISTED MATERIAL. SEAL SMOKE TIGHT ALL PIPE PENETRATIONS.
- 6. ALL PIPING/PLUMBING SHALL BE PROVIDED WITH LABEL. LABEL SHALL INDICATE THE NAME OF SERVICED LIQUID OR GAS. IT SHALL ALSO INDICATE THE DIRECTION OF FLOW. LABEL'S COLOR SIZE AND SPACING SHALL BE PER SPECIFICATIONS.
- 7. COORDINATE ALL PIPING AND VALVE INSTALLATIONS WITH ALL OTHER TRADES.
- 8. PROTECT THE PUBLIC FROM INJURY DURING THE ENTIRE PROGRESS OF WORK BY POSTING SIGNS, GUARD LIGHTS AND BARRICADES.
- 9. DEBRIS SHALL BE REMOVED FROM THE PREMISES ON A DAILY BASIS. DO NOT ALLOW DEBRIS TO ACCUMULATE. PROTECT ADJACENT AREAS FROM DUST AND DEBRIS.
- 10. CONTRACTOR SHALL FAMILIARIZE THEMSELVES WITH SPECIFICATIONS. PROVIDE ALL MATERIALS, CONSTRUCTION, INSTALLATION AND SUPPORTS TO CONSTITUTE OPERABLE. DOMESTIC WATER, STORM DRAIN, WASTE AND VENT AND FIRE PROTECTION SYSTEM.
- 11. CONTRACTOR SHALL SCAN CONCRETE FLOOR OR WALL BEFORE CORE DRILLING TO AVOID CUTTING THE EXISTING STEEL REINFORCED BAR.
- 12. NOTIFY CONTRACTING OFFICER REPRESENTATIVE (COR) 3 WEEKS IN ADVANCE PRIOR TO DRAINAGE AND WATER SHUT DOWN TO PERFORM TIE IN FOR NEW SERVICE.

PUMP SCHEDULE													
EQUIPMENT TAG	MANUFACTURER AND MODEL NUMBER			SERVICE TYPE	GPM HEAD FT H20	MOTOR	EL	ELECTICAL			OPERATING		
			SERVICE				HP	VOLT	РН	ΗZ	- RPM	WEIGHT (Ibs.)	REMARKS
(103A-SP-01)	ZOELLER MODEL 50	ELECTRICAL ROOM	TROUGH	SUBMERSIBLE	45	15	¥2	110	1	60	1,550	27.5	1,2,3

3. WITH NEMA PREMIUM EFFICIENCY INVERTER DUTY MOTOR.

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## CONSTRUCTION DOCUMENTS

		<b>CONSULTANTS:</b>	KEY PLAN	STAMP	<b>ARCHITECT/ENGINE</b>	ERS:
FINAL BID DOCUMENTS (15-411)	6/22/17					ATTENTION:
100% CONSTRUCTION DOCUMENTS (15-410)	6/15/17					
100% DESIGN DEVELOPMENT (15-407)	5/12/17					PROFESSIONAL WORK AND BECA
50% DESIGN DEVELOPMENT (15-401)	4/13/17					SIGNED DOCUMENTS MUST B INFORMATION. IF THERE ANY DIF
100% SCHEMATIC DESIGN (15-391)	3/10/17				CONSULTANTS, INC.	ANY OTHER DOCUMENTS, 1
65% DESIGN DEVELOPMENT (15-354)	11/30/16				998 PARK AVENUE SAN JOSE CALIFORNIA 95126	TO OUR DOCUMENTS BY ANYO
15% DESIGN REPORT (15-269)	5/5/16				P: (408) 297-1881 F: (408)294-3186 www.adcengineers.com	<u>PRJ# 15-308-55</u>
Revisions:	Date					

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HWCP DOM. HOT WATER CIRC. PUMP

HERTZ

DHW

DFU

DWH

(E)

EL

FC

FCO

FLR

FT

FU

GALV

GCO

GPH

ΗZ

GPM

FD

ELEC

ABBRE	VIATIONS	<u>S:</u>
DESCRIPTION	ABBR.	DESCRIPTION
AMBIENT	IN	INCHES
BRAKE HORSEPOWER	IE	INVERT ELEVATION
CAST IRON	INV	INVERT
CEILING	JS	JANITOR SINK
CONTRACTING OFFICER REPRESENATIVE	LAV	LAVATORY
CLINICAL SERVICE SINK	LB	POUND
COPPER	LOD	LIMIT OF DEMOLITION
CUBIC FEET	MAX	MAXIMUM
DOM. COLD WATER CIRC. PUMP	MA	MEDICAL AIR
DOMESTIC COLD WATER	MIN	MINIMUM
DOMESTIC HOT WATER	MV	MEDICAL VACUUM
DRAINAGE FIXTURE UNITS	(N)	NEW
DOMESTIC WATER HEATER	02	OXYGEN
EXISTING	OFD	OVERFLOW DRAIN
ELECTRICAL	PD	PRESSURE DROP
ELEVATION	PSI	POUNDS PER SQUARE INCH
DEGREE FAHRENHEIT	RD	ROOF DRAIN
FLOOR SINK	SQ.FT.	SQUARE FEET
FLOOR CLEAN-OUT	SS	SANITARY SEWER
FLOOR DRAIN	TEMP	TEMPERATURE
FLOOR	TMV	THERMOSTATIC MIXING VALVE
FEET	TP	TRAP PRIMER
FIXTURE UNITS	TYP	TYPICAL
GALVANIZED	V	VENT
GRADE-CLEAN OUT	VTR	VENT THRU ROOF
GALLON PER HOUR	WC	WATER CLOSET
GALLON PER MINUTE	WCO	WALL CLEAN-OUT

WALL HYDRANT

WATER HAMMER ARRESTOR

WH

WHA

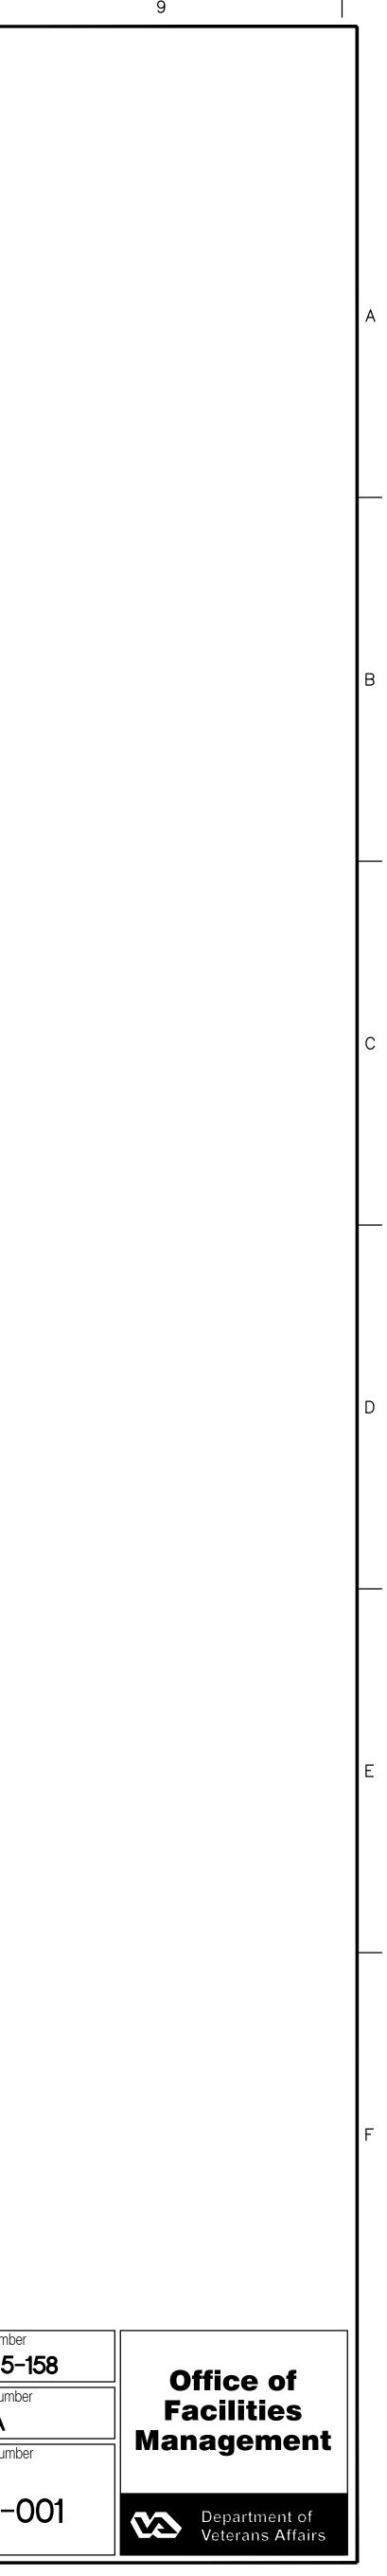
	PIPING S	SYMBOLS:
G	ENERAL	
SYMB.	DESCRIPTION	SYMB.
	- EQUIPMENT TYPE - EQUIPMENT NO. - BUILDING NO.	
Ĵ.	- DETAIL NUMBER/SECTION LETTER - DRAWING NUMBER WHERE DETAIL/SECTION TAKEN - DRAWING NUMBER WHERE	
$\langle 1 \rangle \langle 1 \rangle$	DETAIL/SECTION SHOWN SHEET NOTE	
	POINT OF CONNECTION	
;	NEW	со — FC0 <b>—</b>
\$	EXISTING	GCOO WCOI
<del>                                     </del>	EXISTING PIPING OR EQUIPMENT TO BE DEMOLISHED	
;;	UNDERGROUND OR BELOW CONCRETE SLAB SANITARY SEWER OR WASTE	⊠ ]-⊂ ™
; <b>;</b>	ABOVE GRADE SANITARY SEWER OR WASTE	
	CIRCULATING PUMP	

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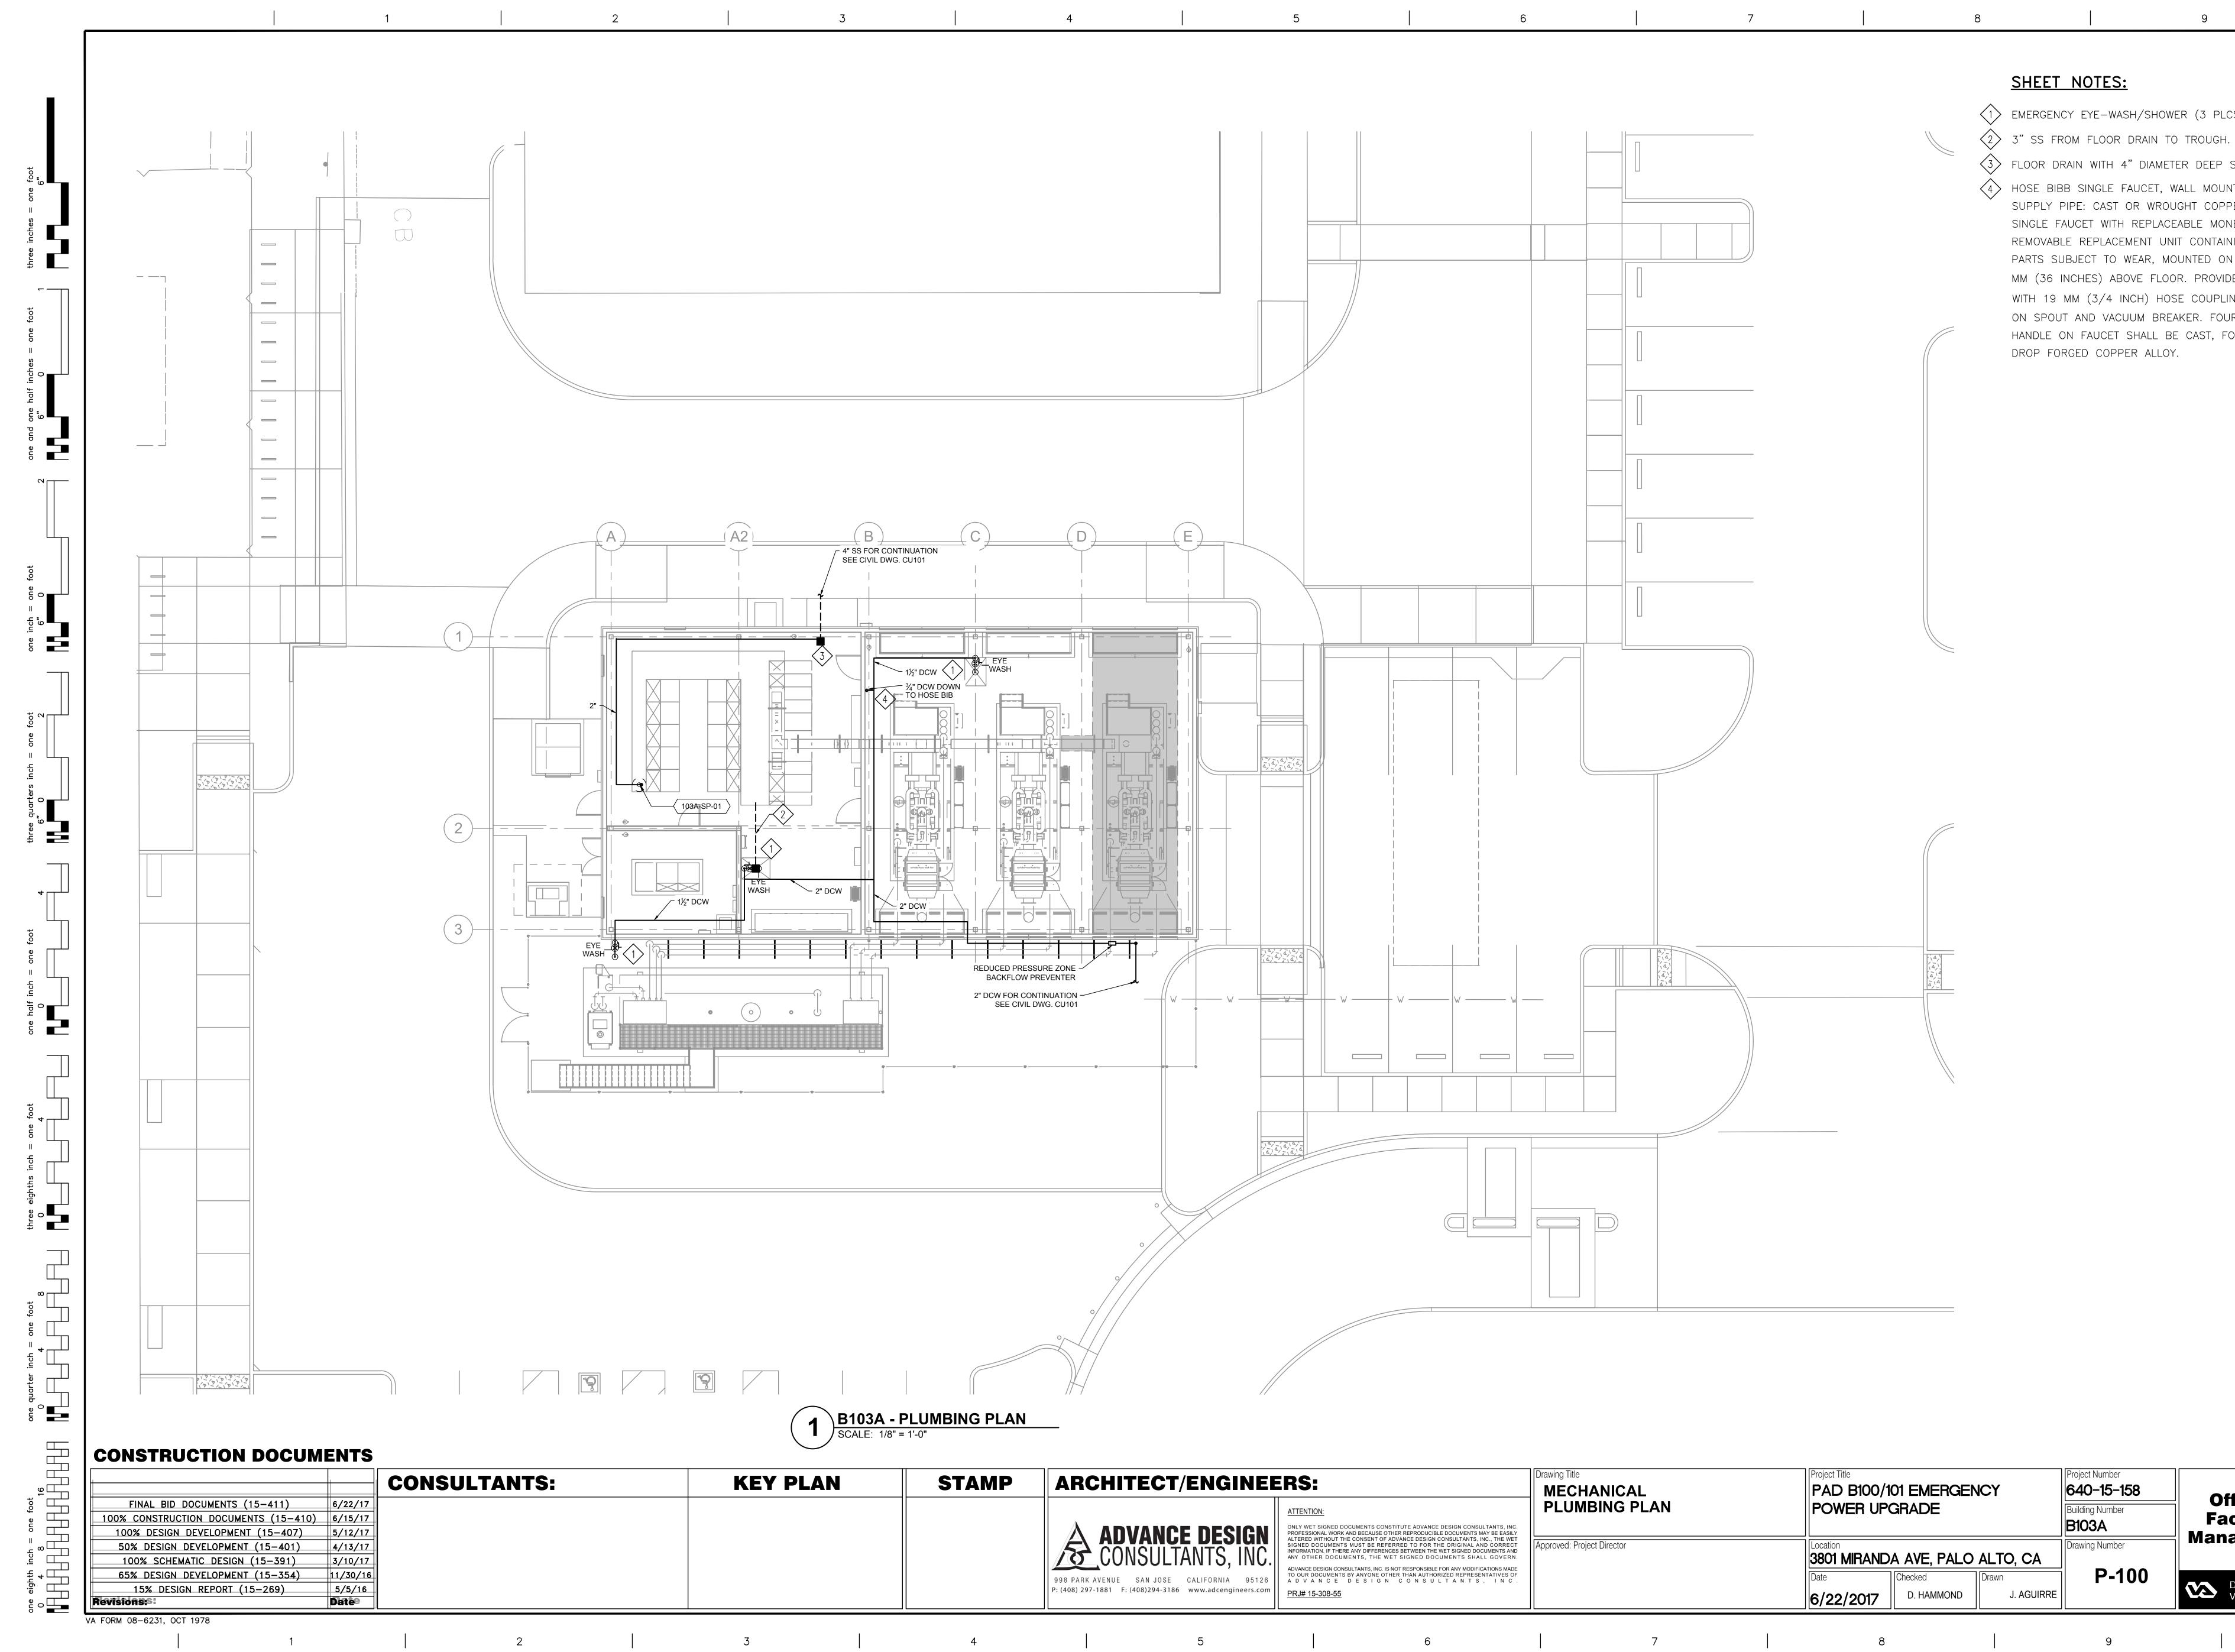
PIPING
DESCRIPTION
AIR GAP
BACKFLOW PREVENTER
BALL VALVE
CHECK VALVE
PRESSURE AND TEMPERATURE RELIEF VALVE
SHUT-OFF VALVE
THERMOSTATIC MIXING VALVE
CIRCUIT SETTER
CLEAN OUT
FLOOR CLEAN OUT
GRADE CLEAN OUT
WALL CLEAN OUT
CONCENTRIC REDUCER
FLEXIBLE CONNECTOR
FLOOR DRAIN
HOSE BIB/WALL HYDRANT
TRAP PRIMER
UNION Y—STRAINER
PRESSURE GAUGE
TEMPERATURE GAUGE
THERMOMETER
FLOW METER
OXIDENT LEVEL (WATER DISENFECTANT) LEVEL METER
ph Meter
PRESSURE SWITCH
PRESSURE TRANSMITTER
TEMPERATURE TRANSMITTER
PIPE-UP
PIPE-DN
PIPE DROP
COLD WATER
HOT WATER
VENT

NSTITUTE ADVANCE DESIGN CONSULTANTS, INC. DTHER REPRODUCIBLE DOCUMENTS MAY BE EASILY	Drawing Title PLUMBING PLUMBING NOTES, SYMBOLS + ABBREVIAT	Project Title PAD B100/101 EMERGENCY POWER UPGRADE				
F ADVANCE DESIGN CONSULTANTS, INC., THE WET FERRED TO FOR THE ORIGINAL AND CORRECT NCES BETWEEN THE WET SIGNED DOCUMENTS AND WET SIGNED DOCUMENTS SHALL GOVERN. IS NOT RESPONSIBLE FOR ANY MODIFICATIONS MADE THER THAN AUTHORIZED REPRESENTATIVES OF N C O N S U L T A N T S , I N C .	Approved: Project Director		Location 3801 MIRAND Date 6/22/2017	A AVE, PAL Checked L. RIOS	Drawn	Drawing Nur
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	Approved: Project Director	3801 MIRANDA AVE, PALO ALTO, CA				
		Date	Checked	Drawn	j <b>P-</b>	
		6/22/2017	D. HAMMOND	J. AGUIRRE		
CONSULIANIS, INC.						

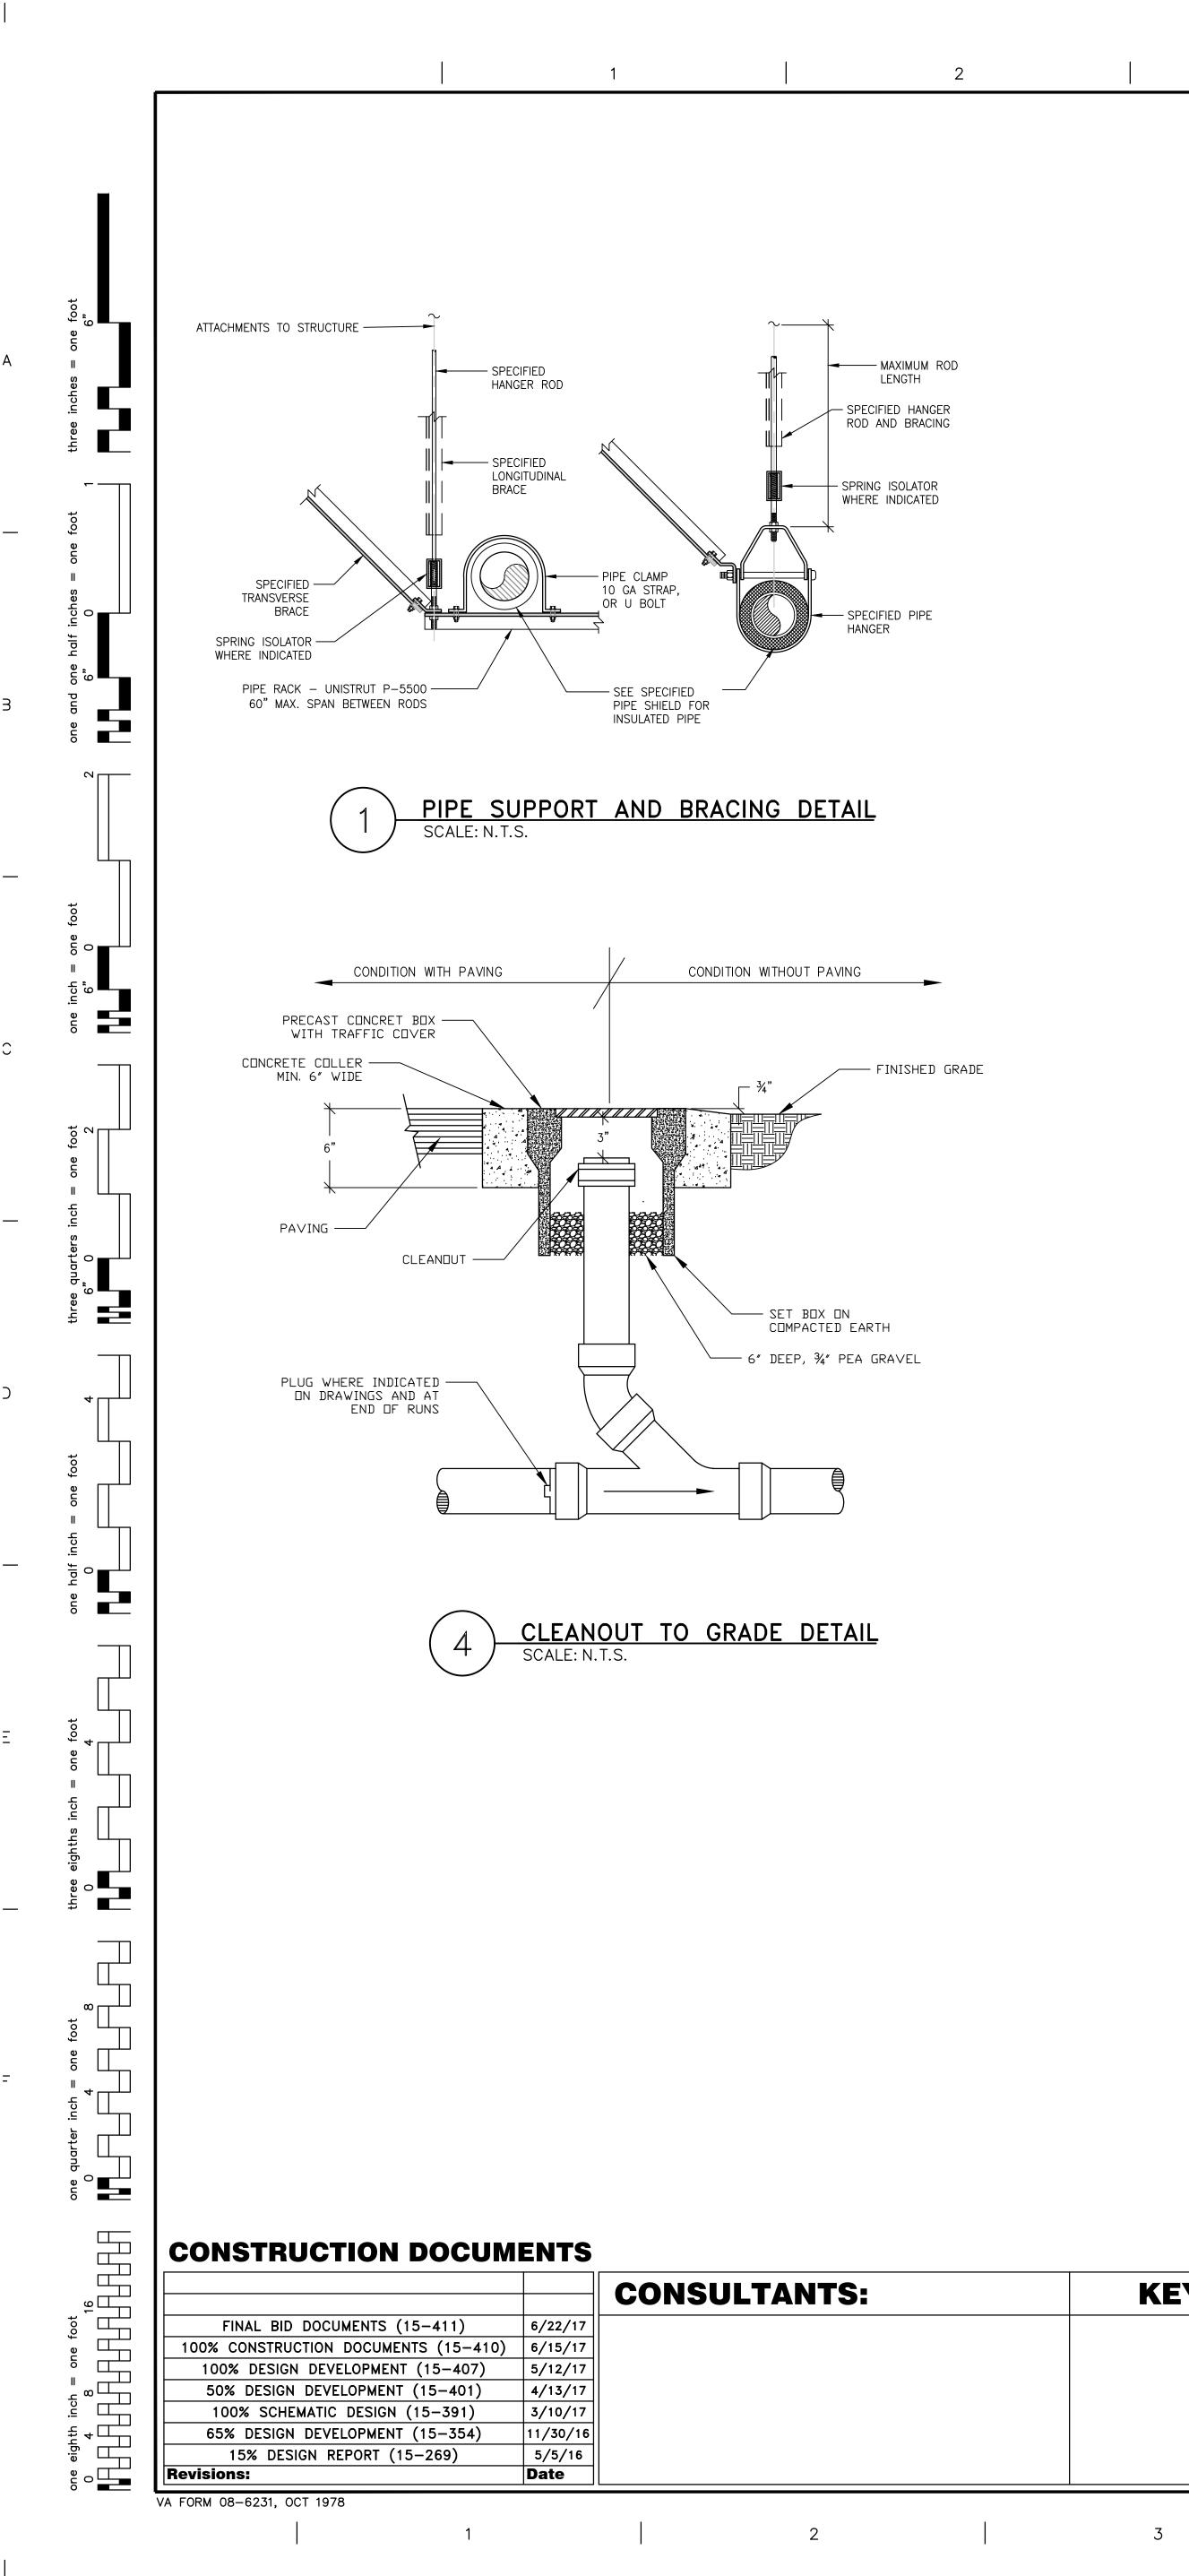
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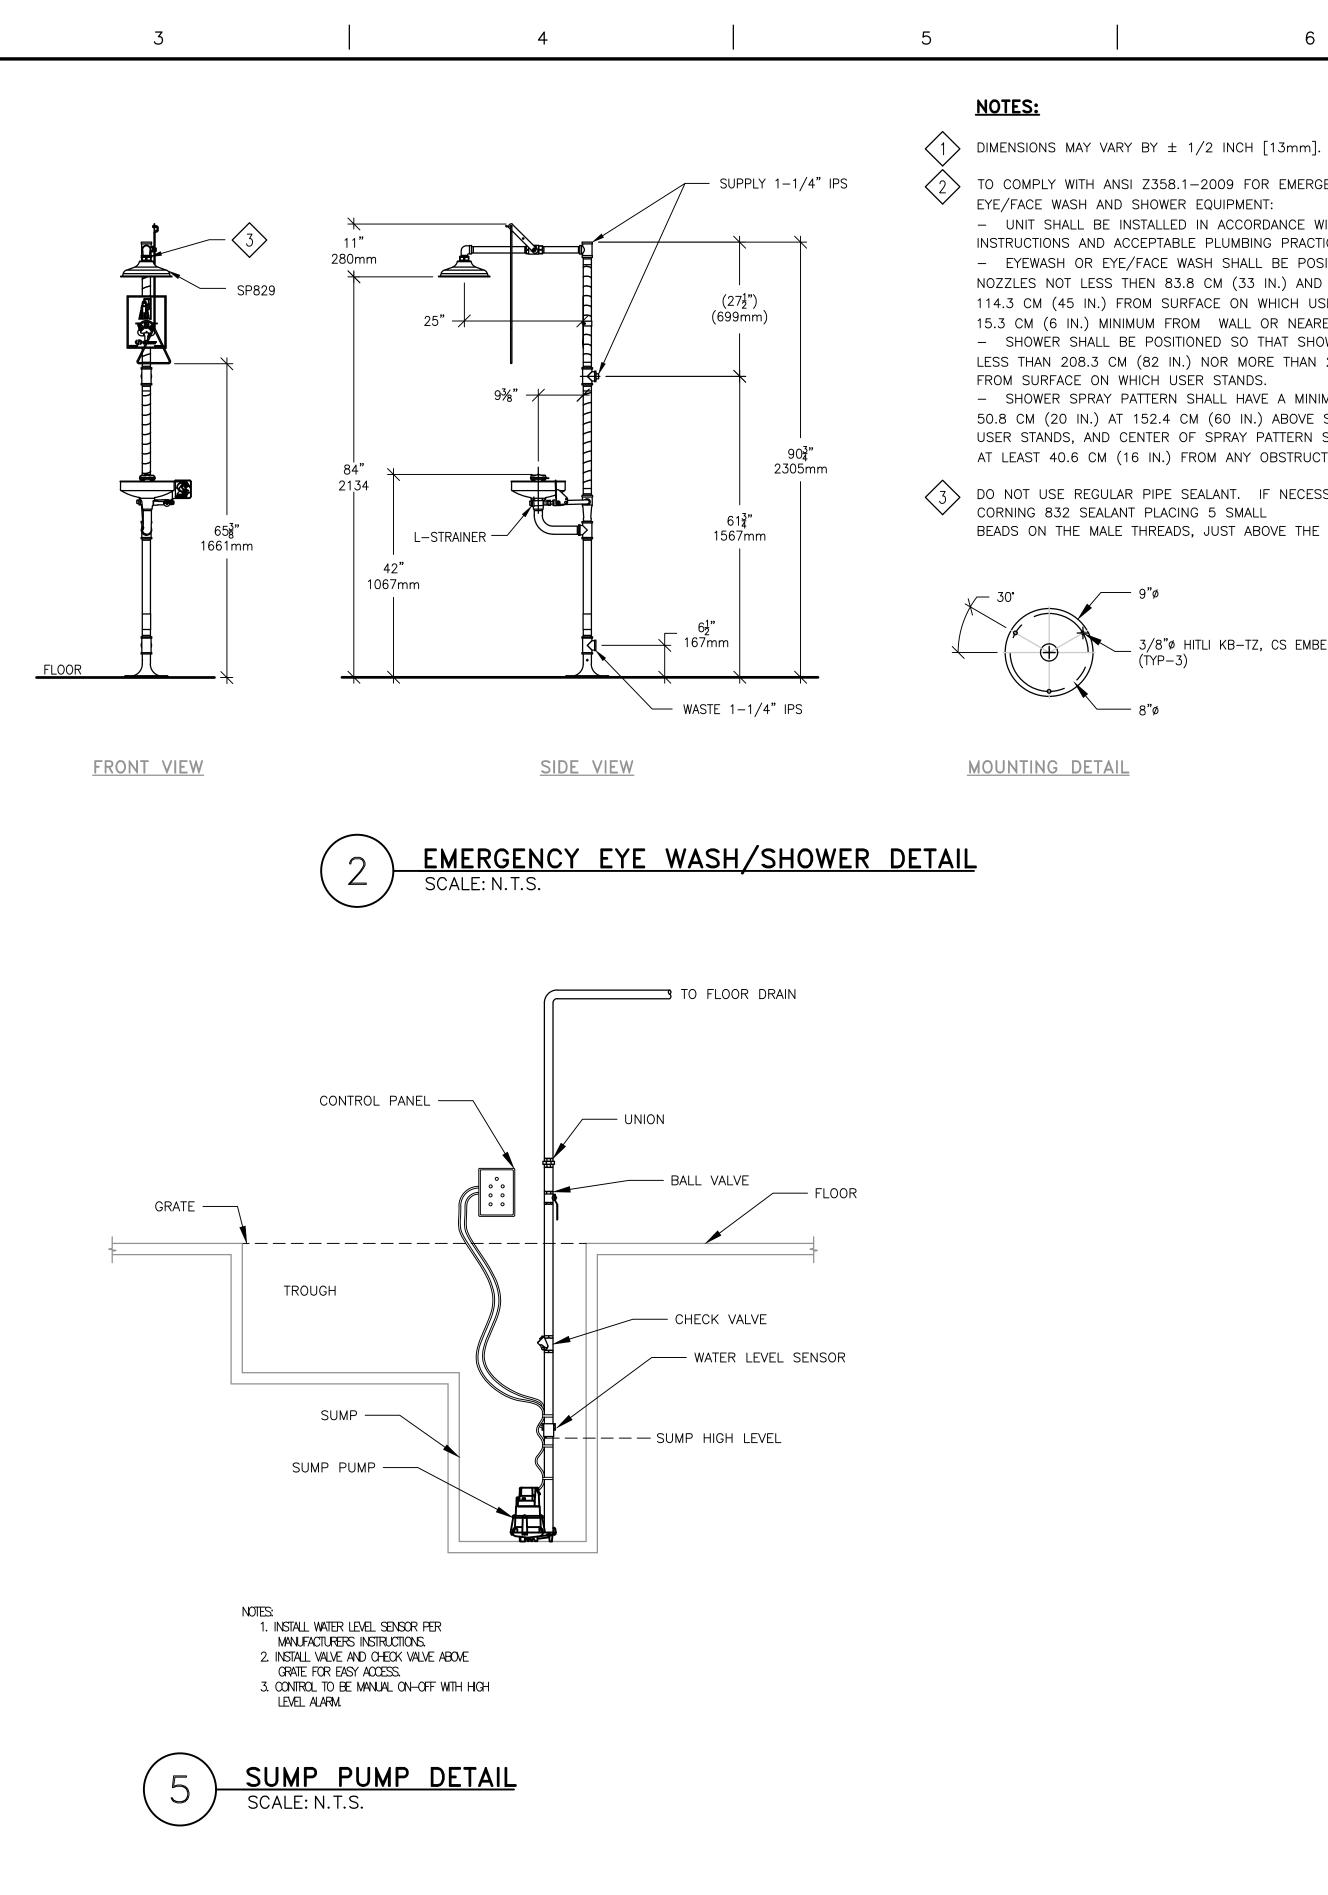
 $\langle 1 \rangle$  emergency eye-wash/shower (3 plcs)

 $\langle 3 \rangle$  Floor drain with 4" diameter deep seal trap.  $\langle 4 \rangle$  hose bibb single faucet, wall mounted to SUPPLY PIPE: CAST OR WROUGHT COPPER ALLOY, SINGLE FAUCET WITH REPLACEABLE MONEL SEAT, REMOVABLE REPLACEMENT UNIT CONTAINING ALL PARTS SUBJECT TO WEAR, MOUNTED ON WALL 914 MM (36 INCHES) ABOVE FLOOR. PROVIDE FAUCET WITH 19 MM (3/4 INCH) HOSE COUPLING THREAD ON SPOUT AND VACUUM BREAKER. FOUR-ARM HANDLE ON FAUCET SHALL BE CAST, FORMED OR

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KEY PLAN	STAMP	MP ARCHITECT/ENGINEERS:					
		ADVANCE DESIGN CONSULTANTS, INC. 998 PARK AVENUE SAN JOSE CALIFORNIA 95126 P: (408) 297-1881 F: (408)294-3186 www.adcengineers.com	ATTENTION: ONLY WET SIGNED DOCUMENTS CONSTITUTE PROFESSIONAL WORK AND BECAUSE OTHER RE ALTERED WITHOUT THE CONSENT OF ADVANC SIGNED DOCUMENTS MUST BE REFERRED INFORMATION. IF THERE ANY DIFFERENCES BET ANY OTHER DOCUMENTS, THE WET SIG ADVANCE DESIGN CONSULTANTS, INC. IS NOT RE TO OUR DOCUMENTS BY ANYONE OTHER TH. A D V A N C E D E S I G N C C PRJ# 15-308-55				

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2 TO COMPLY WITH ANSI Z358.1-2009 FOR EMERGENCY EYEWASH OR EYE/FACE WASH AND SHOWER EQUIPMENT:

 UNIT SHALL BE INSTALLED IN ACCORDANCE WITH MANUFACTURER'S INSTRUCTIONS AND ACCEPTABLE PLUMBING PRACTICES. - EYEWASH OR EYE/FACE WASH SHALL BE POSITIONED WITH

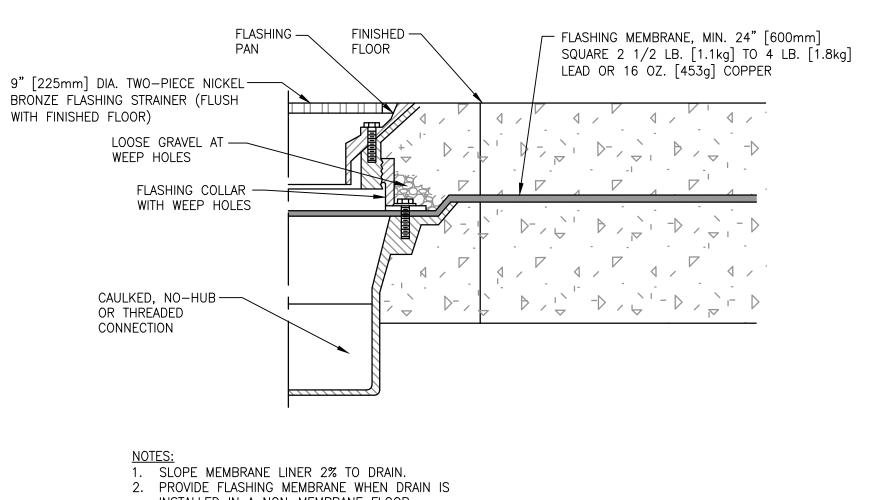
NOZZLES NOT LESS THEN 83.8 CM (33 IN.) AND NO GREATER THAN 114.3 CM (45 IN.) FROM SURFACE ON WHICH USER STANDS AND 15.3 CM (6 IN.) MINIMUM FROM WALL OR NEAREST OBSTRUCTION. - SHOWER SHALL BE POSITIONED SO THAT SHOWER HEAD IS NOT LESS THAN 208.3 CM (82 IN.) NOR MORE THAN 243.8 CM (96 IN.)

– SHOWER SPRAY PATTERN SHALL HAVE A MINIMUM DIAMETER OF 50.8 CM (20 IN.) AT 152.4 CM (60 IN.) ABOVE SURFACE ON WHICH USER STANDS, AND CENTER OF SPRAY PATTERN SHALL BE LOCATED AT LEAST 40.6 CM (16 IN.) FROM ANY OBSTRUCTION.

3 DO NOT USE REGULAR PIPE SEALANT. IF NECESSARY USE DOW CORNING 832 SEALANT PLACING 5 SMALL BEADS ON THE MALE THREADS, JUST ABOVE THE FIRST THREAD.

\_ 3/8"Ø HITLI KB-TZ, CS EMBED 2½" (TYP-3)

— 8"ø



INSTALLED IN A NON-MEMBRANE FLOOR. 3. HEAVY BODY WITH NON TILTING NICKEL

BRONZE GRATE, REMOVABLE SEDIMENT BUCKET, 12 IN. SQAURE. EXTRA HEAVE DUTY GRATE FOR TRAFFIC USE.

4. INSTALL WITH DEEP SEAL TRAP



FLOOR DRAIN DETAIL SCALE: N.T.S.

HITECT/ENGINEERS:		Drawing Title EMERGENCY/STAND-BY POWER	Project Title PAD B100/1	Project Number 640-15-156			
ADVANCE DESIGN	ATTENTION: ONLY WET SIGNED DOCUMENTS CONSTITUTE ADVANCE DESIGN CONSULTANTS, INC. PROFESSIONAL WORK AND BECAUSE OTHER REPRODUCIBLE DOCUMENTS MAY BE EASILY	PLUMBING DETAILS	POWER UPGRADE Location 3801 MIRANDA AVE, PALO ALTO, CA			Building Number B103A	
CONSULTANTS, INC.	ALTERED WITHOUT THE CONSENT OF ADVANCE DESIGN CONSULTANTS, INC., THE WET SIGNED DOCUMENTS MUST BE REFERRED TO FOR THE ORIGINAL AND CORRECT INFORMATION. IF THERE ANY DIFFERENCES BETWEEN THE WET SIGNED DOCUMENTS AND ANY OTHER DOCUMENTS, THE WET SIGNED DOCUMENTS SHALL GOVERN. ADVANCE DESIGN CONSULTANTS, INC. IS NOT RESPONSIBLE FOR ANY MODIFICATIONS MADE	Approved: Project Director				Drawing Number	
ENUE SAN JOSE CALIFORNIA 95126 881 F: (408)294-3186 www.adcengineers.com	TO OUR DOCUMENTS BY ANYONE OTHER THAN AUTHORIZED REPRESENTATIVES OF A D V A N C E D E S I G N C O N S U L T A N T S , I N C		Date 6/22/2017	Checked _	Drawn -	P-50	
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