


# DEPARTMENT OF VETERANS AFFAIRS

## VA Loma Linda Healthcare System

11201 Benton St, Loma Linda, CA 92357  
VA Project No. 605-17-414 | Perimeter Fence II

### VICINITY MAP

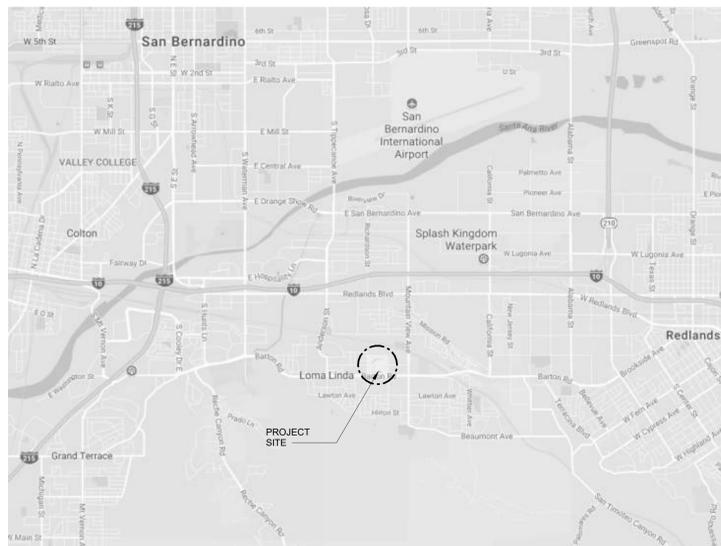

### SHEET INDEX

**GENERAL**  
G-100 COVER SHEET  
G-101 ABBREVIATIONS, GENERAL NOTES & APPLICABLE STANDARDS

**ARCHITECTURAL**  
AS-100 OVERALL SITE PLAN  
AS-101 ENLARGED PLANS  
AS-102 ENLARGED PLANS  
AS-103 ENLARGED PLAN

### PROJECT DESCRIPTION

INSTALL NEW PERIMETER SECURITY FENCING ALONG EASTERN PROPERTY LINE (APPROX. 1,050 LINEAR FEET); INSTALL NEW CONCRETE STAGING PAD FOR ROLL-OFF DUMPSTERS AT SOUTH-EAST CORNER OF PROSPECT AVENUE ENTRANCE. INSTALL NEW CONCRETE STAGING PAD FOR ROLL-OFF DUMPSTERS AT NORTH-EAST CORNER OF PROSPECT AVENUE ENTRANCE; CONSTRUCT NEW RETAINING WALL TO ENLARGE (E) SERVICE YARD. MODIFY NORTH-WEST ACCESS POINT TO BE RIGHT TURN EXIT ONLY; INSTALL NEW PERIMETER SECURITY FENCING ALONG WESTERN PROPERTY LINE (APPROX. 250 LINEAR FEET)

### PROJECT TEAM

**CLIENT:**  
Department of Veterans Affairs  
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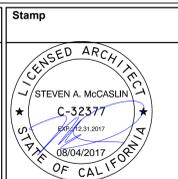
### DEDUCTIVE ALTERNATES

1. NORTHWEST EXIT
2. DUMPSTER PAD #2
3. DUMPSTER PAD #1

| Revisions: |            |               |
|------------|------------|---------------|
| Rev.       | Date       | Description   |
| 08.04.2017 | 08.04.2017 | 95% Submittal |

| CONSULTANT |
|------------|
|            |

| ARCHITECT / ENGINEER OF RECORD  |
|---|
| <p><b>MAArchitects, Inc.</b><br/>21515 Hawthorne Blvd - Suite 200, Torrance, CA 90503<br/>www.ma-architects.net</p> |



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|---|
| <p>Office of Construction and Facilities Management<br/><b>VA</b> U.S. Department of Veterans Affairs</p> |
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|   |
|---|
| <p>Drawing Title<br/><b>COVER SHEET</b></p> |
| <p>Approved:</p>                            |

|                                       |
|---------------------------------------|
| <p>Phase<br/><b>95% Submittal</b></p> |
| <p>N/A</p>                            |

|   |                        |                          |
|---|------------------------|--------------------------|
| <p>Project Title<br/><b>PERIMETER FENCE II</b></p>        |                        |                          |
| <p>Location<br/>11201 Benton St, Loma Linda, CA 92357</p> |                        |                          |
| <p>Issue Date<br/>08.04.2017</p>                          | <p>Checked<br/>SMc</p> | <p>Drawn<br/>MA Arch</p> |

|   |
|---|
| <p>Project Number<br/><b>605-17-414</b></p> |
| <p>Building Number<br/>-</p>                |
| <p>Drawing Number<br/><b>G-100</b></p>      |

ABBREVIATIONS

Table with 2 columns: Abbreviation and Description. Includes sections for A, B, C, D, E, F, G, H, I, J, K, L, M, N, O, P, Q, R, S, T, U, V, W, X, Y, Z.

Table with 2 columns: Abbreviation and Description. Includes sections for G, H, I, J, K, L, M, N, O, P, Q, R, S, T, U, V, W, X, Y, Z.

Table with 2 columns: Abbreviation and Description. Includes sections for P, Q, R, S, T, U, V, W, X, Y, Z.

Table with 2 columns: Abbreviation and Description. Includes sections for W, X, Y, Z and a section for SYMBOLS AS ABBREVIATIONS.

APPLICABLE STANDARDS

APPLICABLE STANDARDS:
VA Directives, Design Manuals, Master Specifications, VA National CAD Standard Application Guide, and other Guidance on the Technical Information Library (TIL)
International Building Code (IBC)
NFPA 101 Life Safety Code
NFPA National Fire Codes
Occupational Safety and Health Administration (OSHA) Standards
VA Seismic Design Requirements, H-18-8
National Electrical Code (NEC)
International Plumbing Code (IPC)
Safety Code for Elevators and Escalators, American Society of Mechanical Engineers (ASME) A 17.1
ASME Boiler and Pressure Vessel Code
ASME Code for Pressure Piping
Architectural Barriers Act Accessibility Standards (ABAAS) including VA supplement, Barrier Free Design Guide (PG-18-13)
Building Code Requirements for Reinforced Concrete, American Concrete Institute and Commentary (ACI 318)
Manual of Steel Construction, Load and Resistance Factor Design Specifications for Structural Steel Buildings, American Institute of Steel Construction (AISC)
Energy policy Act of 2005 (EPAct)
DOE Interim Final Rule: Energy Conservation Standards for New Federal, Commercial and Multi-Family High-Rise Residential Buildings and New Low-Rise Residential Buildings, 10 CFR Parts 433, 434 and 435.
Federal Leadership in High Performance and Sustainable Buildings: Memorandum of Understanding (MOU)
Executive Order 13423: Strengthening Federal Environmental, Energy, and Transportation Management.
The Provisions for Construction and Safety Signs, Stated in the General Requirements Section 01010 of the VA Master Construction Specification.
Ventilation for Acceptable Indoor Air Quality – ASHRAE Standard 62.1- 2004.
Safety Standard for Refrigeration Systems – ASHRAE Standard 15 – 2007.
UNLESS OTHERWISE SPECIFIED, SPECIFIC REFERENCES TO CODES, REGULATIONS, STANDARDS, MANUFACTURERS' INSTRUCTIONS, OR REQUIREMENTS OF REGULATORY AGENCIES, SHALL MEAN THE LATEST EDITION OF EACH IN EFFECT AT THE DATE OF PROJECT SUBMISSION UNON

PROJECT GENERAL NOTES

GENERAL NOTES:
1. THE FOLLOWING GENERAL NOTES APPLY TO THE ENTIRE SET OF DRAWINGS LISTED BY THE "INDEX OF DRAWINGS".
2. FOR GENERAL NOTES, ABBREVIATIONS, AND SYMBOLS APPLICABLE ONLY TO THE DRAWINGS OF ONE DISCIPLINE, REFER TO THE DRAWINGS OF THAT DISCIPLINE - SEE "INDEX OF DRAWINGS".
3. THE SET OF DRAWINGS, WHEN COMPLETE, CONSISTS OF ALL DRAWINGS LISTED BY THE "INDEX OF DRAWINGS". PARTIAL SETS OF DRAWINGS ARE INCOMPLETE. DO NOT DISTRIBUTE OR UTILIZE PARTIAL SETS OF DRAWINGS. THE WORK DESCRIBED BY THE DRAWINGS OF ANY ONE DISCIPLINE MAY BE AFFECTED BY THE WORK DESCRIBED ON DRAWINGS OF ANOTHER DISCIPLINE OR MANUFACTURE INSTALLATION REQUIREMENTS. SHOULD THEY DISAGREE IN THEMSELVES, OR WITH EACH OTHER, BIDS SHALL BE BASED ON THE MOST EXPENSIVE COMBINATION OF QUALITY AND QUANTITY OF WORK INDICATED. ANY DISCREPANCY BETWEEN THESE DOCUMENTS SHALL BE IMMEDIATELY BROUGHT TO THE ATTENTION OF THE ARCHITECT FOR CLARIFICATION.
4. IT IS THE CONTRACTOR'S RESPONSIBILITY TO REVIEW AND COORDINATE THE WORK OF ALL SUBCONTRACTORS, TRADES, AND SUPPLIERS WITH ALL REQUIREMENTS OF THE CONTRACT DOCUMENTS BEFORE COMMENCING CONSTRUCTION, AND TO ASSURE THAT ALL PARTIES ARE AWARE OF ALL REQUIREMENTS, REGARDLESS OF WHERE THE REQUIREMENTS OCCUR IN THE CONTRACT DOCUMENTS, WHICH MIGHT AFFECT THE WORK OF THAT PARTY.
CONTRACTOR SHALL SUPPLY ALL LABOR, MATERIALS, EQUIPMENT, TOOLS AND SERVICES NECESSARY FOR THE PROPER EXECUTION AND COMPLETION OF ALL WORK SHOWN, DESCRIBED, OR REASONABLY IMPLIED, BUT NOT LIMITED TO THAT EXPLICITLY INDICATED IN THE CONTRACT DOCUMENTS.
THE CONTRACTOR SHALL BE RESPONSIBLE FOR ALL CUTTING, FITTING OR PATCHING THAT MAY BE REQUIRED TO COMPLETE WORK OR TO MAKE ITS SEVERAL PARTS FIT TOGETHER.
5. THE ARCHITECT SHALL NOT HAVE CONTROL OR CHARGE OF AND SHALL NOT BE RESPONSIBLE FOR CONSTRUCTION MEANS, METHODS, TECHNIQUES, SEQUENCE OR PROCEDURE, OR FOR SAFETY PRECAUTIONS AND PROGRAMS IN CONNECTION WITH THE WORK, ALL OF WHICH SHALL BE THE SOLE RESPONSIBILITY OF THE GENERAL CONTRACTOR.
6. APPLICABLE PORTIONS OF THE CODES, REGULATIONS, AND STANDARDS LISTED HERE ARE INCORPORATED BY REFERENCE INTO THE REQUIREMENTS OF THIS CONTRACT AND ESTABLISH MINIMUM REQUIREMENTS WITH WHICH THE WORK MUST COMPLY.
THIS PROJECT AND ALL PARTS OF THE WORK ASSOCIATED WITH THE PROJECT - INCLUDING MATERIALS, METHODS, ASSEMBLIES, ETC. - SHALL COMPLY WITH ALL APPLICABLE GOVERNING RULES, CODES, REGULATIONS, ORDINANCES, AND LAWS OF ALL FEDERAL, STATE, DISTRICT, TERRITORIAL, AND LOCAL GOVERNMENT AUTHORITIES HAVING JURISDICTION OVER THE DESIGN, CONSTRUCTION, AND OCCUPANCY OF THE PROJECT, WHETHER LISTED BY THE CONTRACT DOCUMENTS OR NOT. NO PART OF THE CONTRACT DOCUMENTS SHALL BE CONSTRUED TO REQUIRE OR PERMIT WORK CONTRARY TO AN APPLICABLE GOVERNING RULE, CODE, REGULATION, ORDINANCE, OR LAW.
7. IF A CONFLICT EXISTS BETWEEN THE CONTRACT DOCUMENTS AND A REGULATORY REQUIREMENT, THE CONTRACTOR SHALL COMPLY WITH THE ONE ESTABLISHING THE MORE STRINGENT OR RESTRICTIVE REQUIREMENT.
- THE DRAWINGS AND SPECIFICATIONS MAY SET FORTH MORE DETAILED, MORE SPECIFIC, AND/OR MORE RESTRICTIVE REQUIREMENTS THAN THOSE SET FORTH BY THE APPLICABLE REGULATORY REQUIREMENTS, WHERE THE DRAWINGS AND SPECIFICATIONS PROVIDE MORE DETAILED, MORE SPECIFIC, AND/OR MORE RESTRICTIVE REQUIREMENTS, THE CONTRACTOR SHALL COMPLY WITH THOSE REQUIREMENTS.
- WHERE THE APPLICABLE REQUIREMENTS OF THE REFERENCED RULES, CODES, REGULATIONS, ORDINANCES, OR LAWS ARE MORE RESTRICTIVE THAN THAT SET FORTH BY THE DRAWINGS AND SPECIFICATION, THE CONTRACTOR SHALL COMPLY WITH ALL SUCH MORE RESTRICTIVE REQUIREMENTS - ALTHOUGH SUCH REQUIREMENTS MAY NOT BE ILLUSTRATED BY THE DRAWINGS AND SPECIFICATIONS.
8. PROPRIETARY PRODUCTS OR ASSEMBLIES UTILIZED AS "BASIS OF DESIGN":
- ON OCCASION, THE DRAWINGS MAY REFER TO A SINGLE PROPRIETARY PRODUCT OR ASSEMBLY WHILE THE SPECIFICATIONS LIST TWO OR MORE ACCEPTABLE MANUFACTURES AND/OR PRODUCTS, WHEN THIS OCCURS, THE PRODUCT OR ASSEMBLY ILLUSTRATED BY THE DRAWINGS IS THE "BASIS OF DESIGN" PRODUCT OR ASSEMBLY.
- THE DIMENSIONS, MOUNTING HEIGHTS, CLEARANCES, AND ACCESS REQUIREMENTS OF SPECIFIED PRODUCTS AND ASSEMBLIES OTHER THAN THE "BASIS OF DESIGN" MAY VARY FROM THAT SHOWN BY THE DRAWINGS.
- THE CONTRACTOR MAY UTILIZE ANY OTHER SPECIFIED PRODUCT OR ASSEMBLY IN LIEU OF THE "BASIS OF DESIGN" PRODUCT OR ASSEMBLY, AS APPROVED BY RESIDENT ENGINEER. HOWEVER, THE CONTRACTOR IS RESPONSIBLE (AT NO ADDITIONAL EXPENSE TO THE OWNER) FOR ALL COORDINATION AND REVISIONS TO DIMENSIONS AND/OR DETAILS NECESSARY TO ACHIEVE THE SAME FUNCTIONAL AND AESTHETIC DESIGN INTENT AS ILLUSTRATED BY THE "BASIS OF DESIGN" SHOWN BY THE CONTRACT DOCUMENTS.
9. SCHEDULE CONSTRUCTION WORK HOURS TO ACCOMMODATE THE OPERATION OF THE HOSPITAL / CLINIC
10. CONTRACTOR SHALL MAINTAIN RECORD DOCUMENTS OF CONSTRUCTION CHANGES ("AS-BUILT DRAWINGS") AND SHALL PROVIDE SAID DOCUMENTATION TO THE ARCHITECT UPON COMPLETION OF CONSTRUCTION IN BOTH DIGITAL AND HARD COPY FORMATS. RECORD DOCUMENTS SHALL ARTICULATE WHERE ACTUAL INSTALLATION OF WORK, PRODUCTS, AND/OR SYSTEMS VARY FROM THE DESIGN INTENT EXPRESSED/SPECIFIED IN THE CONTRACT DOCUMENTS. \*\*NO EXCEPTION ALLOWED\*\*
11. ANY WORK INSTALLED IN CONFLICT WITH THE CONTRACT DRAWINGS, CODE REQUIREMENTS OR MANUFACTURE REQUIREMENTS WITHOUT THE PRIOR APPROVAL OF THE OWNER AND THE ARCHITECT SHALL BE CORRECTED AT THE CONTRACTOR'S EXPENSE.
THE CONTRACTOR SHALL PROMPTLY CORRECT ALL WORK REJECTED BY THE ARCHITECT AS DEFECTIVE OR AS FAILING TO CONFORM TO THE CONTRACT DOCUMENTS WHETHER OBSERVED BEFORE OR AFTER SUBSTANTIAL COMPLETION AND WHETHER OR NOT FABRICATED, INSTALLED OR COMPLETED. THE CONTRACTOR SHALL BEAR ALL COSTS OF CORRECTING SUCH REJECTED WORK, NOT TO BE REIMBURSED, INCLUDING COMPENSATION FOR THE ARCHITECT'S ADDITIONAL SERVICES MADE NECESSARY THEREBY.
12. THE GENERAL CONTRACTOR SHALL NOTIFY THE ARCHITECT IMMEDIATELY OF ANY SPECIFIED MATERIALS OR EQUIPMENT WHICH ARE EITHER UNAVAILABLE OR THAT WILL CAUSE A DELAY IN THE CONSTRUCTION COMPLETION SCHEDULE. THE CONTRACTOR SHALL SUBMIT CONFIRMATIONS OF DELIVERY DATES FOR ORDERS OF MATERIALS AND EQUIPMENT HAVING LONG LEAD TIMES.
13. PROJECT SPECIFICATIONS ARE AN INTEGRAL PART OF THESE PLANS; SUBSTITUTIONS FOR SPECIFIED MATERIALS REQUIRE THE WRITTEN APPROVAL FROM THE ARCHITECT AND OWNER. ALL REQUESTS FOR SUBSTITUTIONS OF ITEMS SPECIFIED SHALL BE SUBMITTED IN WRITING AND WILL BE CONSIDERED ONLY IF BETTER SERVICE FACILITIES, A MORE ADVANTAGEOUS DELIVERY DATE, OR A LOWER PRICE WITH CREDIT TO THE OWNER / TENANT WILL BE PROVIDED WITHOUT SACRIFICING QUALITY, APPEARANCE, AND FUNCTION. UNDER NO CIRCUMSTANCES WILL THE ARCHITECT BE REQUIRED TO PROVE THAT A PRODUCT PROPOSED FOR SUBSTITUTION IS OR IS NOT OF EQUAL QUALITY TO THE PRODUCT SPECIFIED.
14. PROVIDE CONTINUOUS INSPECTIONS AS SET FORTH IN STATE AND LOCAL CODES AND PER CONTRACT DOCUMENTS AS NEEDED.

Revisions table with columns: Rev., Date, Description. Row 1: 08.04.2017, 95% Submittal.

CONSULTANT


ARCHITECT / ENGINEER OF RECORD
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21515 Hawthorne Blvd - Suite 200, Torrance, CA 90503
www.ma-architects.net



Office of Construction and Facilities Management
U.S. Department of Veterans Affairs

Drawing Title: ABBREVIATIONS, GENERAL NOTES & APPLICABLE STANDARDS
Approved:

Phase: 95% Submittal
Project Title: PERIMETER FENCE II
Project Number: 605-17-414
Building Number:
Location: 11201 Benton St, Loma Linda, CA 92357
Issue Date: 08.04.2017
Checked: SMc
Drawn: MA ARCH
Drawing Number: G-101

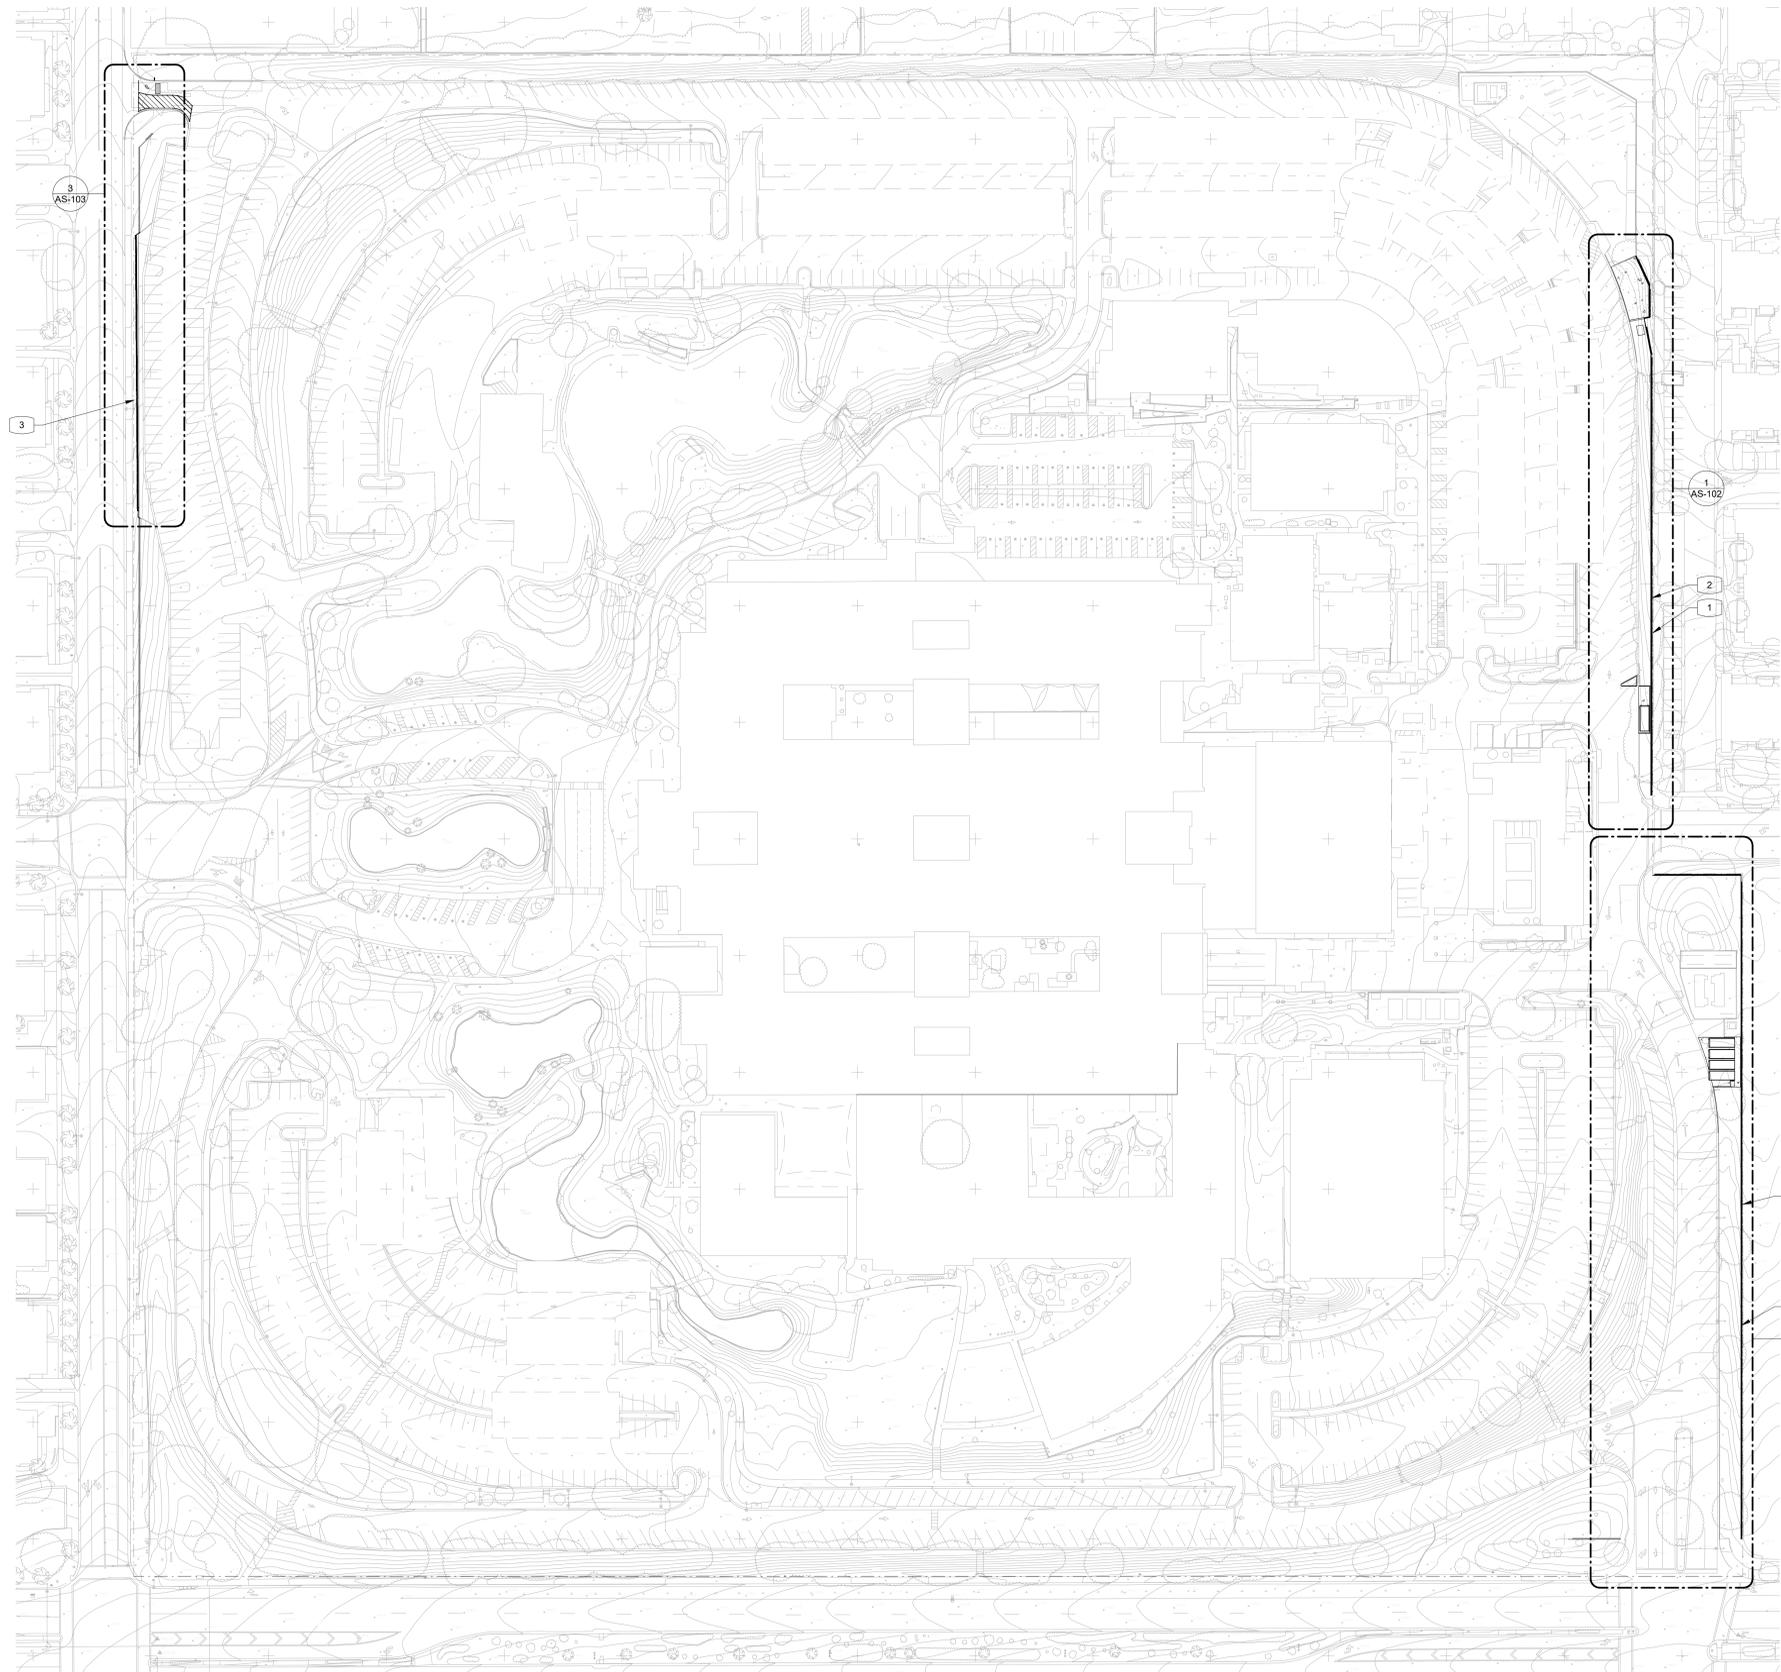


**Key Notes**

- 1 (E) PROPERTY LINE TO BE VERIFIED BY CONTRACTOR.
- 2 NEW 8'-0" HIGH PERIMETER SECURITY FENCE TO MATCH EXISTING (AMERISTRAR; IMPASSE II - GAUNTLET; 3 RAIL); OFFSET FROM PROPERTY LINE 18".
- 3 NEW 8'-0" HIGH PERIMETER SECURITY FENCE TO MATCH EXISTING (AMERISTRAR; IMPASSE II - GAUNTLET; 3 RAIL) TO BE PLACED STREET SIDE OF EXISTING BLOCK RETAINING WALL. TRIM BACK EXISTING VEGETATION AS NEEDED FOR INSTALLATION OF NEW FENCE; COORDINATE INSTALLATION OF FOOTINGS AS TO NOT DISTURB VEGETATION ROOT SYSTEM.


1 Reference Site Plan  
1" = 60'-0"

|  |                   |  |  |   |   |                               |   |                          |                                     |
|--|-------------------|--|--|---|---|-------------------------------|---|--------------------------|-------------------------------------|
| <b>Revisions:</b><br>Rev. Date Description<br>08.04.2017 95% Submittal | <b>CONSULTANT</b> | <b>ARCHITECT / ENGINEER OF RECORD</b><br><br><b>MA Architects, Inc.</b><br>21515 Hawthorne Blvd - Suite 200, Torrance, CA 90503<br>www.ma-architects.net | Stamp<br> | Office of<br>Construction<br>and Facilities<br>Management<br><br><b>VA</b> U.S. Department<br>of Veterans Affairs | Drawing Title<br><b>OVERALL SITE PLAN</b> | Phase<br><b>95% Submittal</b> | Project Title<br><b>PERIMETER FENCE II</b>        |                          | Project Number<br><b>605-17-414</b> |
|  |                   |  |  |   | Approved:                                 | <b>N/A</b>                    | Location<br>11201 Benton St, Loma Linda, CA 92357 | Issue Date<br>08.04.2017 | Checked<br>SMc                      |

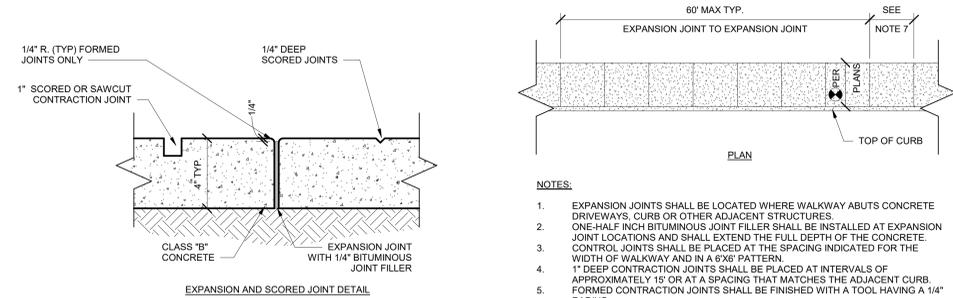


- NOTES:**
1. EXPANSION JOINTS SHALL BE LOCATED WHERE WALKWAY ABUTS CONCRETE DRIVEWAYS, CURB OR OTHER ADJACENT STRUCTURES.
  2. ONE-HALF INCH BITUMINOUS JOINT FILLER SHALL BE INSTALLED AT EXPANSION JOINT LOCATIONS AND SHALL EXTEND THE FULL DEPTH OF THE CONCRETE. CONTROL JOINTS SHALL BE PLACED AT THE SPACING INDICATED FOR THE WIDTH OF WALKWAY AND IN A 6X6' PATTERN.
  3. 1" DEEP CONTRACTION JOINTS SHALL BE PLACED AT INTERVALS OF APPROXIMATELY 15' OR AT A SPACING THAT MATCHES THE ADJACENT CURB. FORMED CONTRACTION JOINTS SHALL BE FINISHED WITH A TOOL HAVING A 1/4" RADIUS.
  4. SCORED JOINTS SHALL BE 1/4" DEEP AND PLACED AT THE SPACING INDICATED FOR THE WIDTH OF SIDEWALK OR MATCH SCORED JOINTS OF ADJACENT CURB. CONCRETE SHALL NOT BE TINTED AND SHALL BE FINISHED BY MEANS OF A FLOAT, STEEL, TROWELLED AND BROOMED WITH A FINE BRUSH IN A TRANSVERSE DIRECTION.
  5. 1/4" DEEP SCORED JOINTS (TYP) SPACED AT 6' OR EQUAL TO SIDEWALK WIDTH.


7 TYP. CONC. SIDEWALK  
3" = 1'-0"

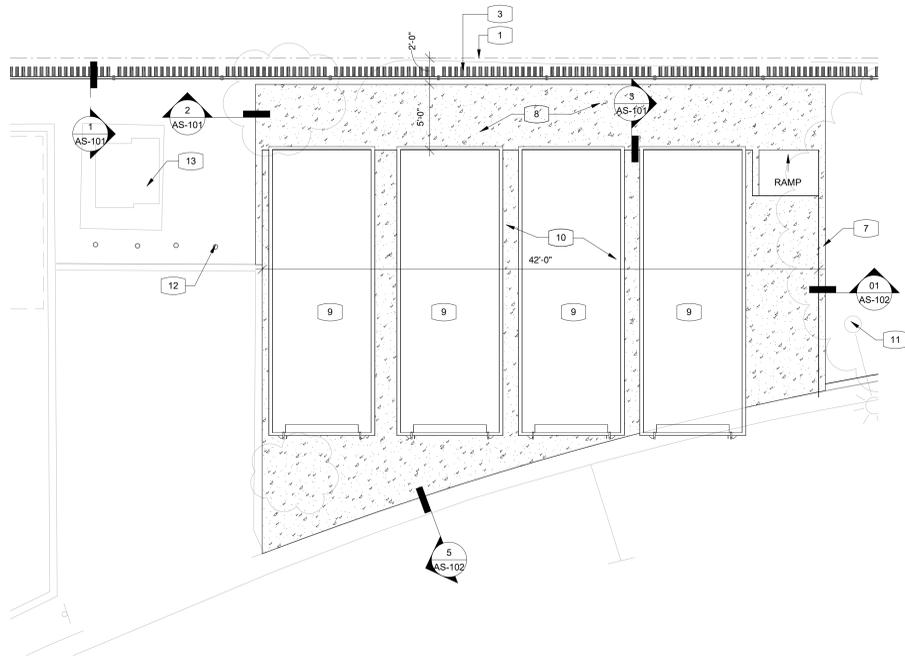

6 Dumpster Pad #1  
3/16" = 1'-0"

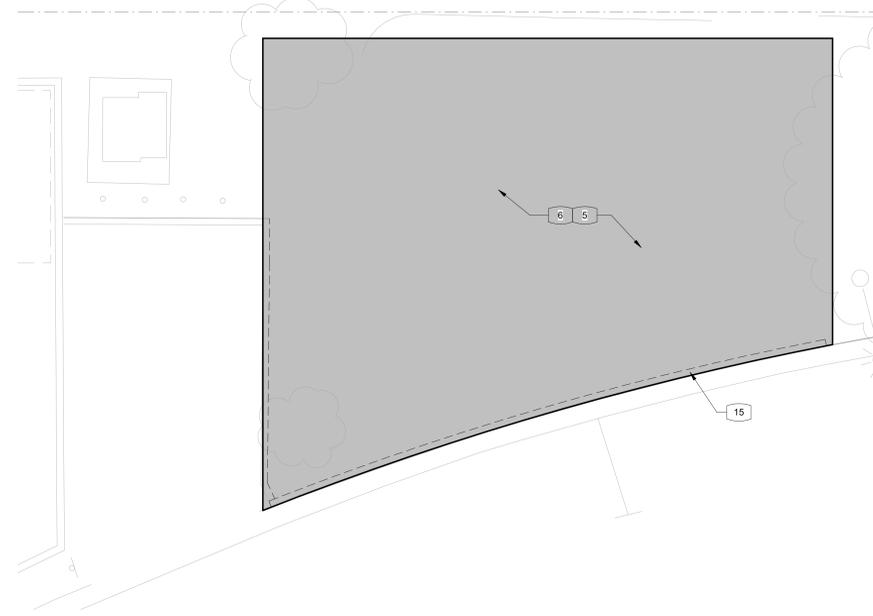


5 Dumpster Pad #1 (Demo)  
3/16" = 1'-0"

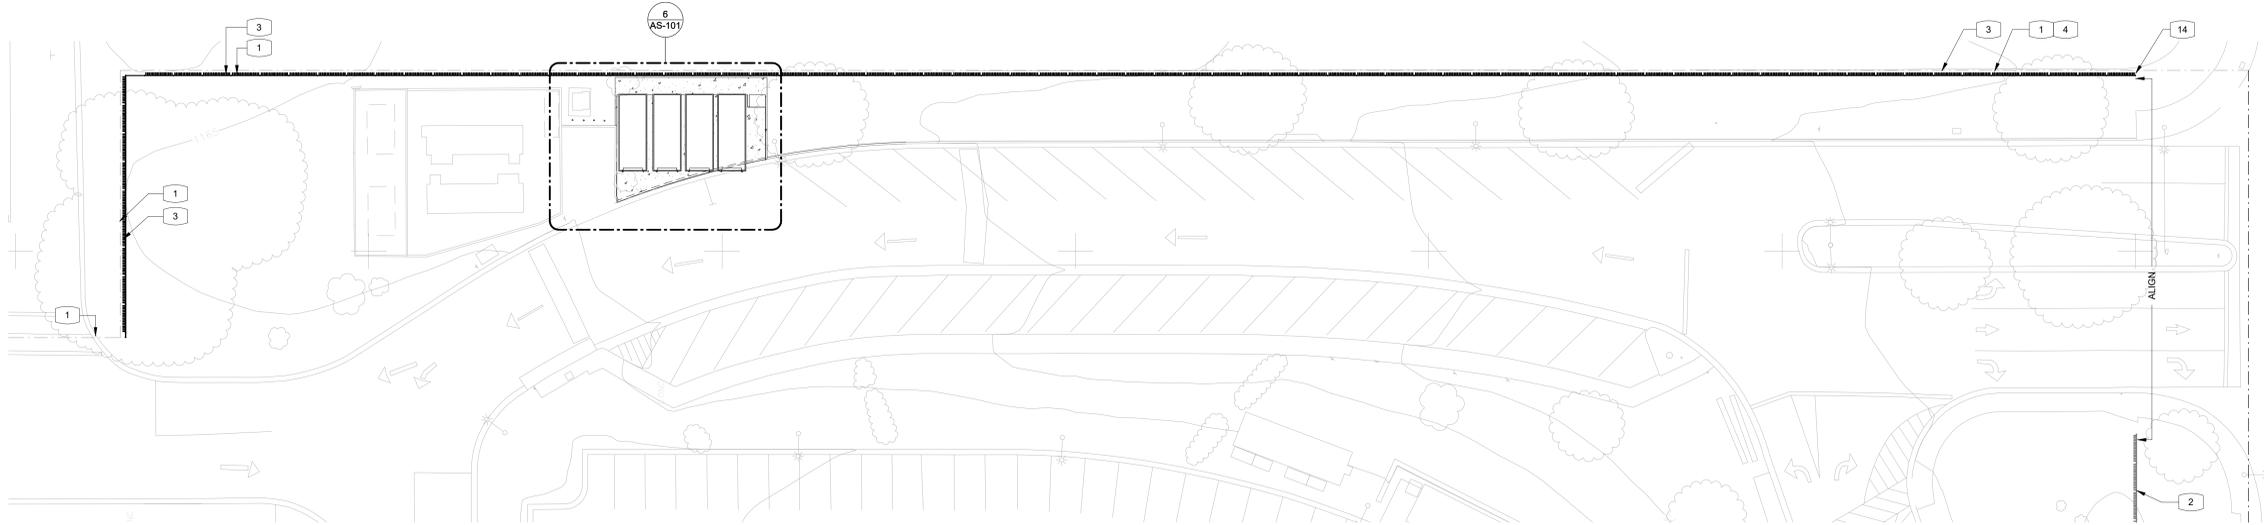


4 Southeast Perimeter Area  
1" = 20'-0"

**Key Notes**


- 1 (E) PROPERTY LINE TO BE VERIFIED BY CONTRACTOR.
- 2 (E) PERIMETER SECURITY FENCE TO REMAIN.
- 3 NEW 8'-0" HIGH PERIMETER SECURITY FENCE TO MATCH EXISTING (AMERISTRAR; IMPASSE II - GAUNTLET; 3 RAIL); OFFSET FROM PROPERTY LINE 18".
- 4 VERIFY ANY EXISTING UTILITY CONFLICTS BY GROUND PENETRATING RADAR PRIOR TO EXCAVATION FOR FOUNDATION WORK (TYPICAL).
- 5 PROTECT (E) IRRIGATION SYSTEM IN PLACE WHERE OCCURS (TYPICAL FOR ENTIRE AREA IMPACTED).
- 6 CLEAR & GRUB AREA FOR PLACEMENT OF NEW PROPOSED WORK; COMPACT EXISTING GRADE TO 90%.
- 7 NEW 6" CONCRETE CURB (REFER TO DETAILS).
- 8 NEW 4" CONCRETE WALKWAY SLAB w/ #4 REBAR @ 18" O.C. EACH WAY OF 2" SAND BED OF COMPACTED GRADE.
- 9 ROLL OFF DUMPSTERS TO BE PROVIDED BY FACILITY.
- 10 NEW 6" CONCRETE SLAB w/ #4 REBAR @ 18" O.C. EACH WAY OF 2" SAND BED OF COMPACTED GRADE. SLOPE 2% TOWARDS EXISTING ROADWAY GUTTER.
- 11 (E) LIGHT STANDARD TO REMAIN (PROTECT IN PLACE DURING CONSTRUCTION ACTIVITIES).
- 12 (E) PIPE BOLLARDS TO REMAIN.
- 13 (E) UTILITY TRANSFORMER TO REMAIN.
- 14 TERMINATE SECURITY FENCE RUN PERPENDICULAR TO EXISTING PERIMETER SECURITY FENCE LINE.
- 15 COORDINATE REMOVAL OF CURB SECTION AS NEEDED WITH NEW PROPOSED WORK.

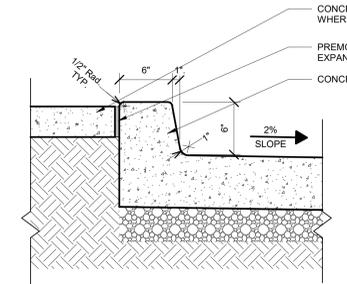

3 TYP. REJECT CURB  
1 1/2" = 1'-0"

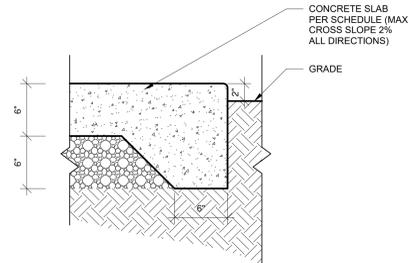

2 TYP. WALKWAY @ GRADE  
1 1/2" = 1'-0"

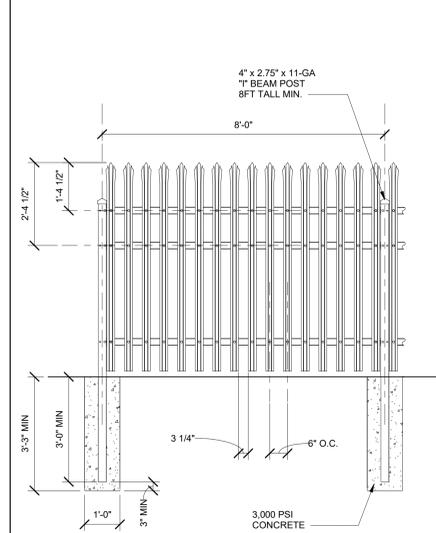

1 SECURITY FENCE DETAIL  
1/2" = 1'-0"


| Revisions: |      |             |
|------------|------|-------------|
| Rev.       | Date | Description |
|            |      |             |

**CONSULTANT**

**ARCHITECT / ENGINEER OF RECORD**

**MA Architects, Inc.**

21515 Hawthorne Blvd - Suite 200, Torrance, CA 90503  
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Office of Construction and Facilities Management

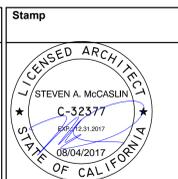VA U.S. Department of Veterans Affairs


Drawing Title  
**ENLARGED PLANS**

Approved:

Phase  
**95% Submittal**


N/A

|   |                |                 |                                     |
|---|----------------|-----------------|-------------------------------------|
| Project Title<br><b>PERIMETER FENCE II</b>        |                |                 | Project Number<br><b>605-17-414</b> |
| Location<br>11201 Benton St, Loma Linda, CA 92357 |                |                 | Building Number<br>-                |
| Issue Date<br>08.04.2017                          | Checked<br>SMc | Drawn<br>Author | Drawing Number<br><b>AS-101</b>     |

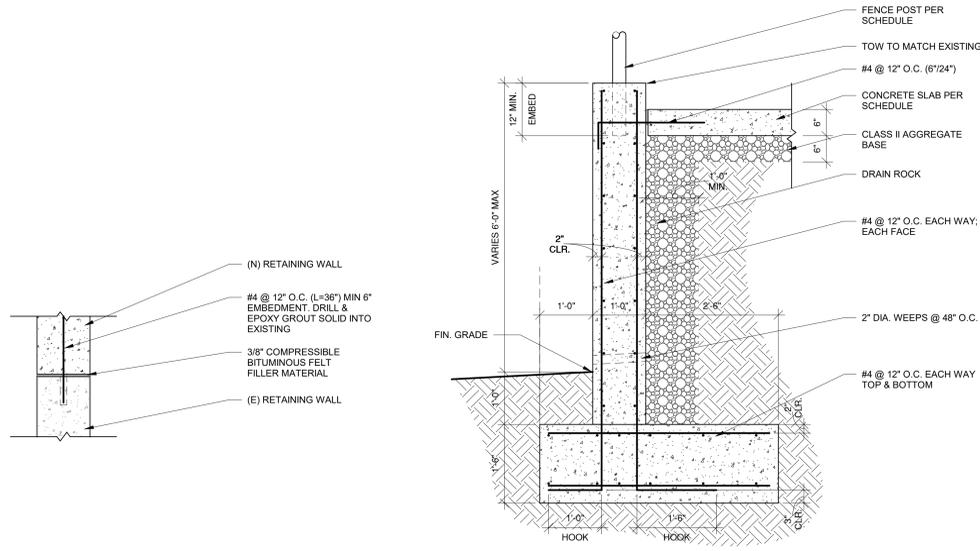


8 RETAINING WALL TIE-IN  
3/4" = 1'-0"


7 CONCRETE RETAINING WALL  
3/4" = 1'-0"

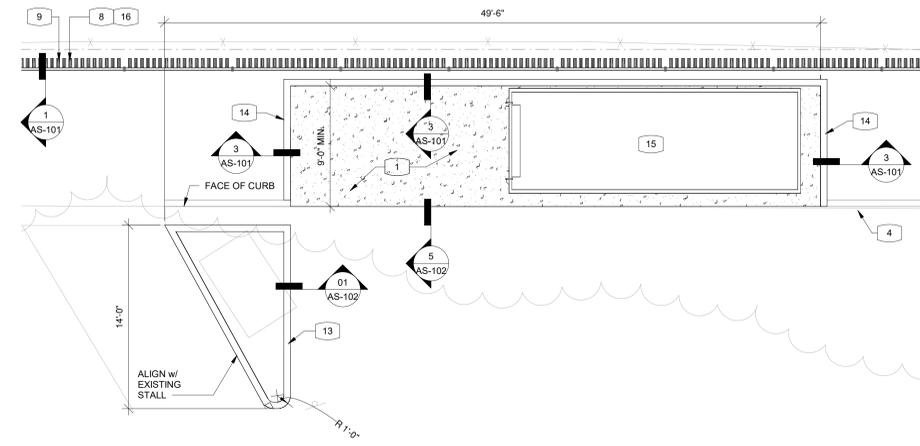


3 Dumpster Pad #2  
3/16" = 1'-0"

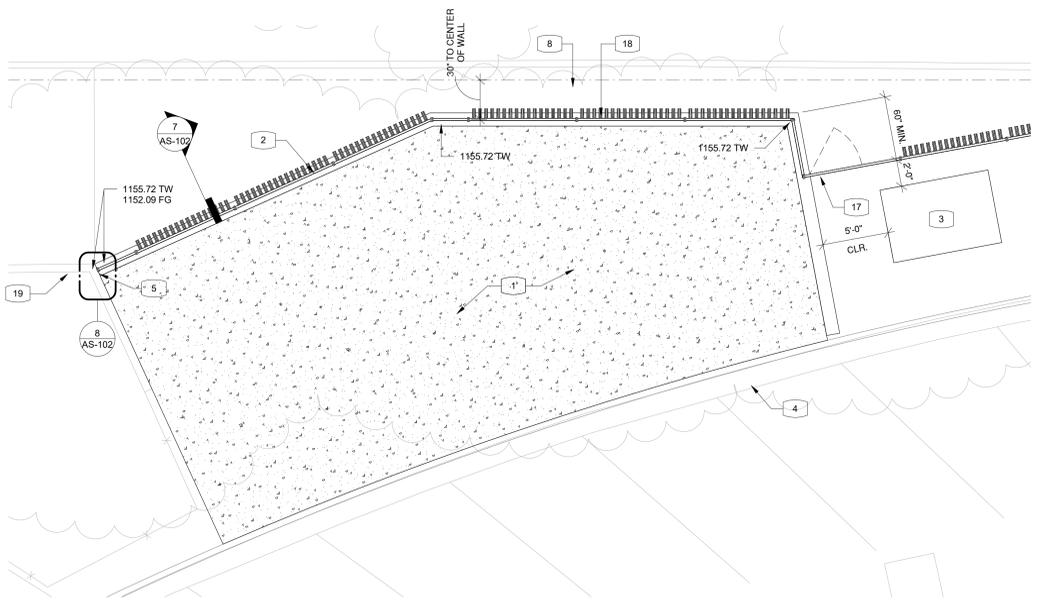

4 Retaining Wall & Pad Extension  
3/16" = 1'-0"

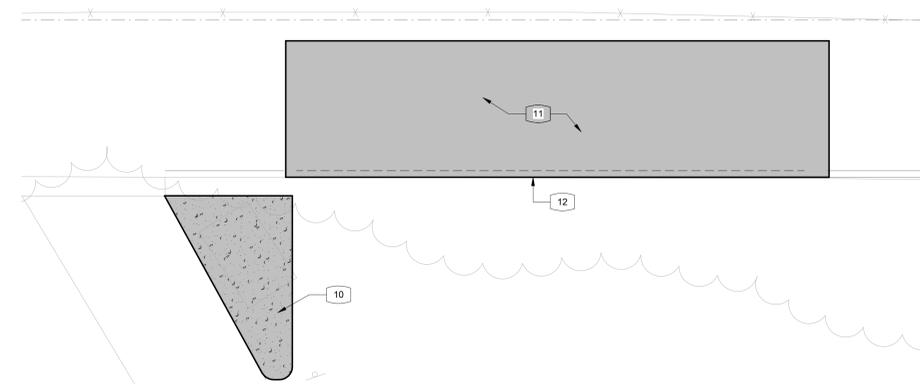


2 Dumpster Pad #2 (Demo)  
3/16" = 1'-0"

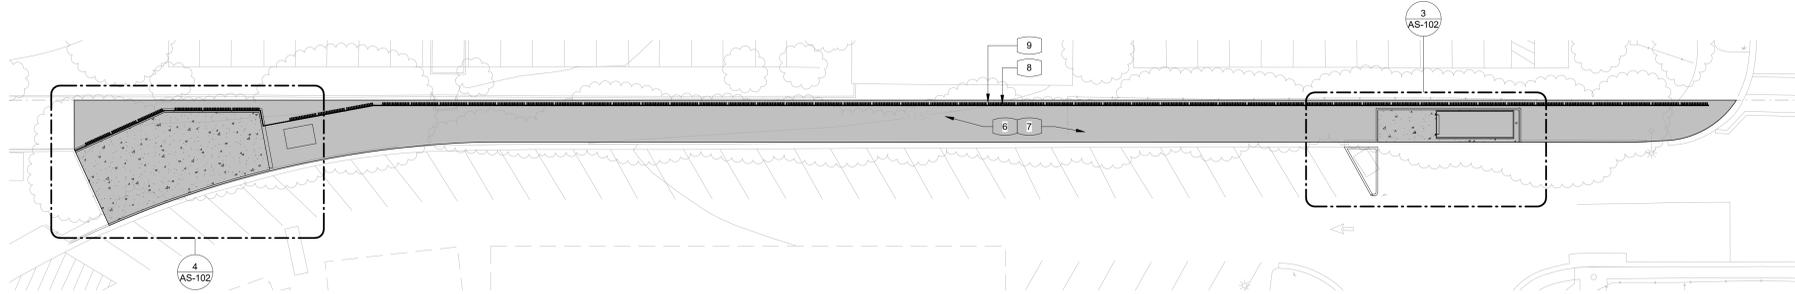


1 Northeast Permitter Area  
1" = 20'-0"

**Key Notes**


- 1 NEW 6" CONCRETE SLAB w/ #4 REBAR @ 18" O.C. EACH WAY w/ 2" SAND BED w/ COMPACTED GRADE. SLOPE 2% TOWARDS EXISTING ROADWAY GUTTER.
- 2 NEW 12" THICK CONCRETE RETAINING WALL w/ SECURITY FENCE TO MATCH EXISTING ADJACENT CONSTRUCTION; MATCH EXISTING TOP OF WALL ELEVATIONS FROM ADJACENT CONSTRUCTION.
- 3 EXISTING PV TRANSFORMER ENCLOSURE TO REMAIN.
- 4 EXISTING CURB & GUTTER TO REMAIN.
- 5 CONNECT NEW RETAINING WALL TO EXISTING.
- 6 CLEAR & GRUB ENTIRE SHADED AREA; REMOVE ALL TREES w/ A TRUNK DIAMETER MEASURING 10" or LESS AT AN ELEVATION OF 48" ABOVE GRADE.
- 7 PROTECT (E) IRRIGATION SYSTEM IN PLACE WHERE OCCURS (TYPICAL FOR ENTIRE AREA IMPACTED).
- 8 (E) PROPERTY LINE TO BE VERIFIED BY CONTRACTOR.
- 9 NEW 8'-0" HIGH PERIMETER SECURITY FENCE TO MATCH EXISTING (AMERISTRAR; IMPASSE II - GAUNTLET; 3 RAIL); OFFSET FROM PROPERTY LINE 18".
- 10 COORDINATE ASPHALT REMOVAL FOR NEW ISLAND CURB. CLEAR & GRUB AREA FOR PLACEMENT OF NEW PROPOSED WORK; COMPACT EXISTING GRADE TO 90%.
- 11 COORDINATE REMOVAL OF CURB SECTION AS NEEDED WITH NEW PROPOSED WORK.
- 12 NEW 6" ISLAND CURB (REFER TO DETAILS). INFILL WITH SOIL FOR NEW PLANTING PER VA.
- 13 NEW 6" CONCRETE CURB (REFER TO DETAILS).
- 14 ROLL OFF DUMPSTERS TO BE PROVIDED BY FACILITY.
- 15 VERIFY ANY EXISTING UTILITY CONFLICTS BY GROUND PENETRATING RADAR PRIOR TO EXCAVATION FOR FOUNDATION WORK (TYPICAL).
- 16 PROVIDE MANUFACTURE'S STANDARD 48" WIDE PERSONNEL GATE AND ACCESSORIES.
- 17 NEW 8'-0" HIGH PERIMETER SECURITY FENCE TO MATCH EXISTING (AMERISTRAR; IMPASSE II - GAUNTLET; 3 RAIL); OFFSET FROM PROPERTY LINE 30".
- 18 EXISTING SERVICE YARD RETAINING WALL.

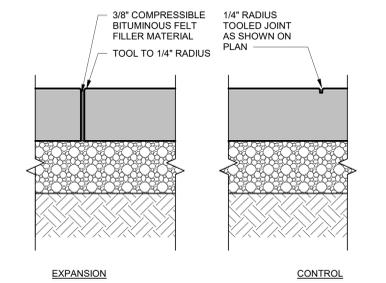

6 TYP. CONCRETE JOINTS  
1 1/2" = 1'-0"

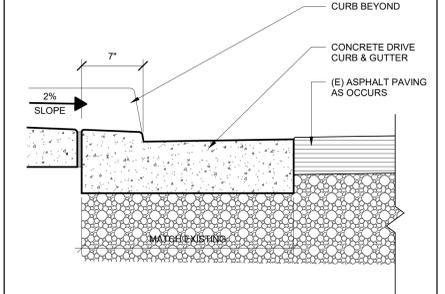

5 TYP. DRIVE APPROACH  
1 1/2" = 1'-0"

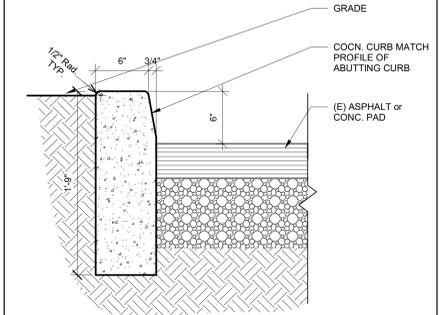


01 TYP. VERTICAL CURB  
1 1/2" = 1'-0"

| Revisions: | Rev. | Date | Description |
|------------|------|------|-------------|
|            |      |      |             |

**CONSULTANT**

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Office of Construction and Facilities Management  
**VA** U.S. Department of Veterans Affairs

Drawing Title  
**ENLARGED PLANS**

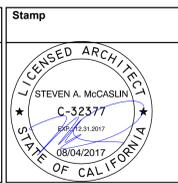Approved:


Phase  
**95% Submittal**

N/A


|   |                |                 |                                     |
|---|----------------|-----------------|-------------------------------------|
| Project Title<br><b>PERIMETER FENCE II</b>        |                |                 | Project Number<br><b>605-17-414</b> |
| Location<br>11201 Benton St, Loma Linda, CA 92357 |                |                 | Building Number<br>-                |
| Issue Date<br>08.04.2017                          | Checked<br>SMc | Drawn<br>Author | Drawing Number<br><b>AS-102</b>     |

**Key Notes**


- 1 NEW 8'-0" HIGH PERIMETER SECURITY FENCE TO MATCH EXISTING (AMERISTRAR; IMPASSE II - GAUNTLET; 3 RAIL) TO BE PLACED STREET SIDE OF EXISTING BLOCK RETAINING WALL. TRIM BACK EXISTING VEGETATION AS NEEDED FOR INSTALLATION OF NEW FENCE; COORDINATE INSTALLATION OF FOOTINGS AS TO NOT DISTURB VEGETATION ROOT SYSTEM.
- 2 POLE MOUNTED SIGNAGE: "STOP" (R1-1) & "RIGHT TURN ONLY" (R3-5R) / ASSOCIATED TRAFFIC PAVEMENT MARKINGS.
- 3 ASSOCIATED TRAFFIC PAVEMENT MARKINGS FOR "STOP" PER CALTRANS STANDARDS FIG 6-36.
- 4 CONNECT NEW & EXISTING PERIMETER SECURITY FENCE PER MANUFACTURER'S STANDARD INSTALLATION REQUIREMENTS.
- 5 (E) PROPERTY LINE TO BE VERIFIED BY CONTRACTOR.
- 6 PROTECT (E) IRRIGATION SYSTEM IN PLACE WHERE OCCURS (TYPICAL FOR ENTIRE AREA IMPACTED).
- 7 (E) PERIMETER SECURITY FENCE TO REMAIN.
- 8 YELLOW PAVEMENT MARKINGS: 4" WIDE BORDER W/ HATCHED LINES @ 36" O.C.; COORDINATE SPECIFIC LAYOUT WITH VA ENGINEERING.
- 9 SURFACE MOUNTED FLEXIBLE POST TRAFFIC DELINEATOR SPACE 36" OC @ PERIMETER OF PAVEMENT MARKING. MATCH EXISTING VA CAMPUS STANDARDS (BASIS OF DESIGN - SAFE-HIT: SH342SMA--WS).

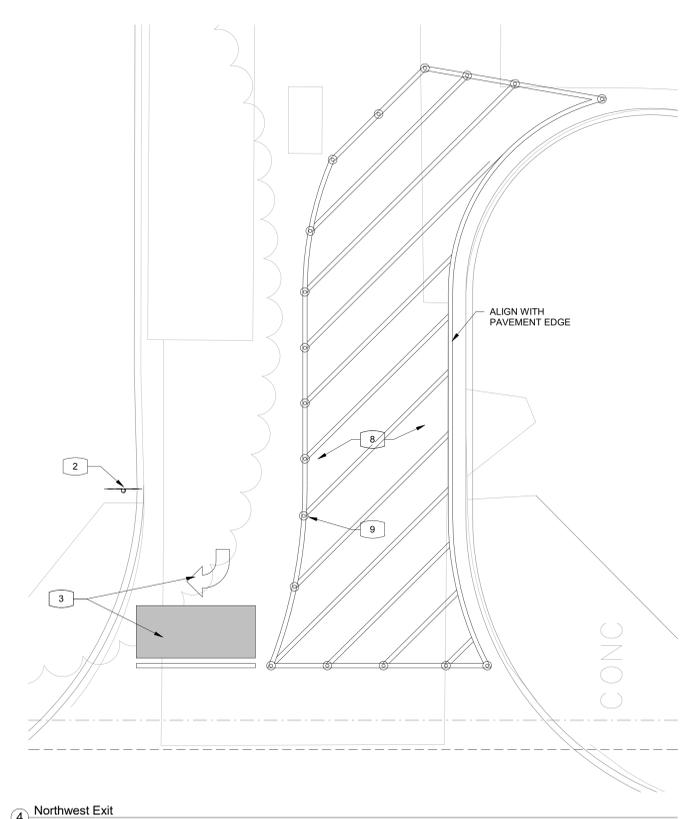


4 Northwest Exit  
3/16" = 1'-0"

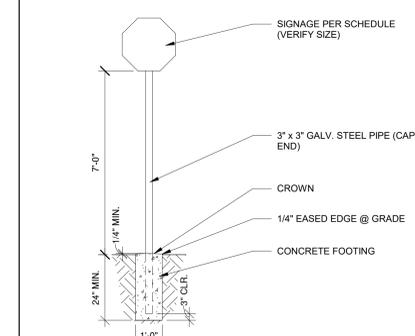

2 POLE SIGNAGE  
3/8" = 1'-0"

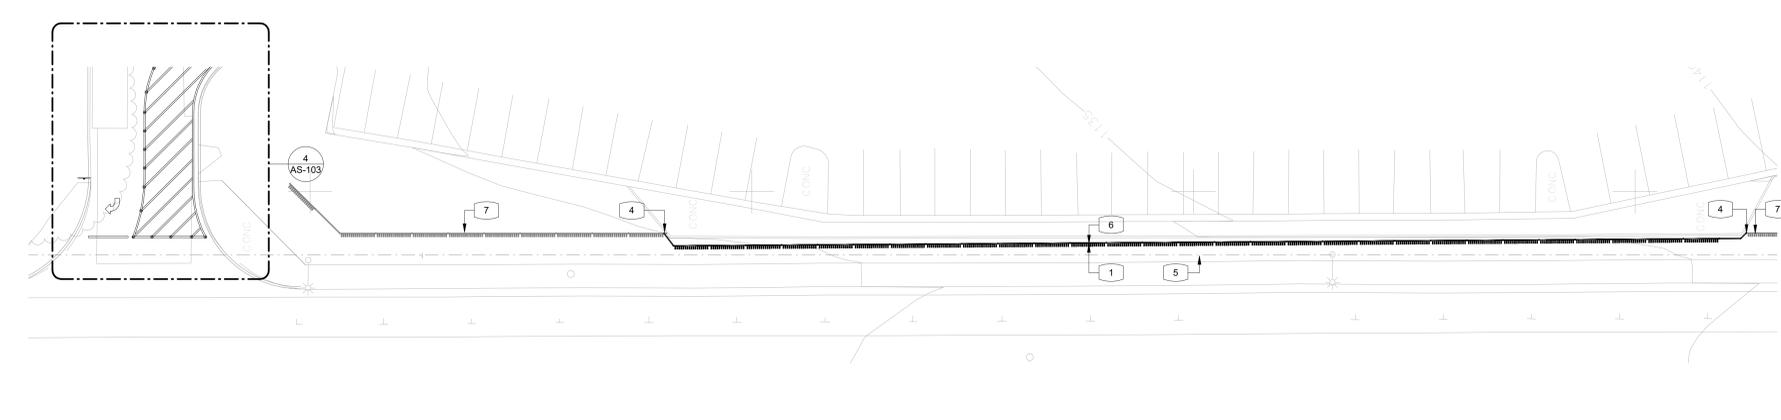

3 West Perimeter Area  
1/16" = 1'-0"

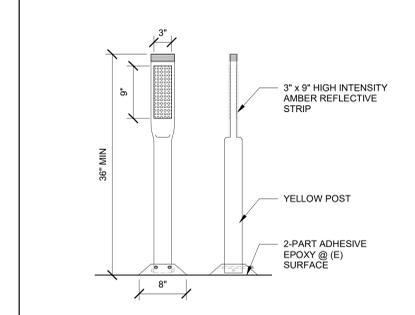

1 FLEXIBLE POST DELINEATOR  
1" = 1'-0"

|  |  |                   |  |  |  |           |  |   |  |                                       |  |   |  |  |  |                                     |  |
|--|--|-------------------|--|--|--|-----------|--|---|--|---------------------------------------|--|---|--|--|--|-------------------------------------|--|
| <b>Revisions:</b><br>Rev. Date Description |  | <b>CONSULTANT</b> |  | <b>ARCHITECT / ENGINEER OF RECORD</b><br><br><b>MA Architects, Inc.</b><br>21515 Hawthorne Blvd - Suite 200, Torrance, CA 90503<br>www.ma-architects.net |  | Stamp<br> |  | Office of Construction and Facilities Management<br><br><b>VA</b> U.S. Department of Veterans Affairs |  | Drawing Title<br><b>ENLARGED PLAN</b> |  | Phase<br><b>95% Submittal</b>                     |  | Project Title<br><b>PERIMETER FENCE II</b> |  | Project Number<br><b>605-17-414</b> |  |
|  |  |                   |  |  |  |           |  | Approved:   |  | <b>N/A</b>                            |  | Location<br>11201 Benton St, Loma Linda, CA 92357 |  | Building Number<br>-                       |  |                                     |  |
|  |  |                   |  |  |  |           |  |   |  | Issue Date<br>08.04.2017              |  | Checked<br>SMc                                    |  | Drawn<br>Author                            |  | Drawing Number<br><b>AS-103</b>     |  |