


three inches = one foot
 one and one half inches = one foot
 one inch = one foot
 three quarters inch = one foot
 one half inch = one foot
 three eighths inch = one foot
 one quarter inch = one foot
 one eighth inch = one foot
 one eighth inch = one foot

SITE UTILITY LEGEND


- PERFORATED UNDERDRAIN ——— UD ———
- PROPOSED STORM SEWER ——— ST ———
- DIRECTIONAL BORE LIMITS [Hatched Box]
- DIRECTIONAL BORE ENTRY/EXIT PITS [Dashed Box]
- PROPOSED UNDERGROUND POWER ——— UE ———
- PROPOSED UNDERGROUND SIGNAL ——— UT ———
- STORM SEWER INLETS, MANHOLE [Grid Symbol]
- ELECTRICAL MANHOLE [E in Circle]

UTILITY KEYNOTES

1. NEW POWER CONDUIT (SEE ES102 FOR DETAIL)
2. NEW SIGNAL CONDUIT (SEE ES102 FOR DETAIL)
3. NEW POWER MANHOLE (SEE ES102 FOR DETAIL)
4. NEW SIGNAL MANHOLE (SEE ES102 FOR DETAIL)
5. UTILIZE EXISTING UNDERGROUND CONDUIT FOR PROPOSED WIRING (SEE ES101 AND PP101 FOR MORE INFORMATION)
6. DIRECTIONAL BORE NEW SIGNAL CONDUIT
7. CONNECT CONDUIT TO EXISTING MANHOLE (SEE ES102)
8. EXISTING CONDUIT TO BE CAPPED AFTER COMPLETION OF NEW ELECTRICAL WORK. (SEE CD101)
9. TRANSFORMER (COORDINATE WITH APOGEE)
10. ADJUST CASTING TO GRADE (NOT USED)

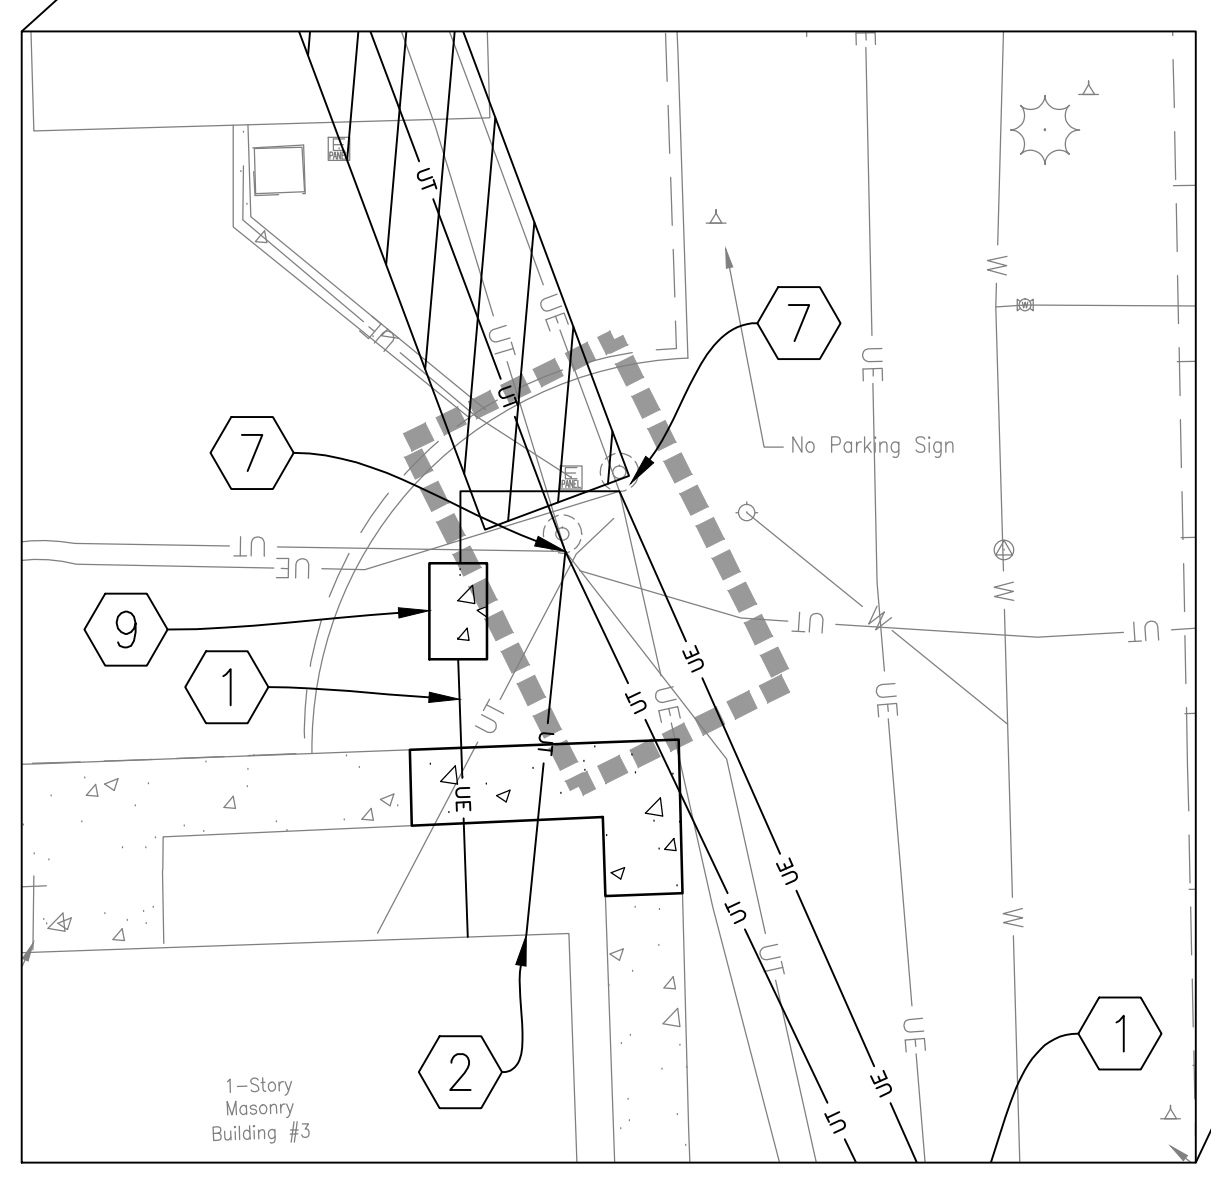

SCALE: 1" = 20'

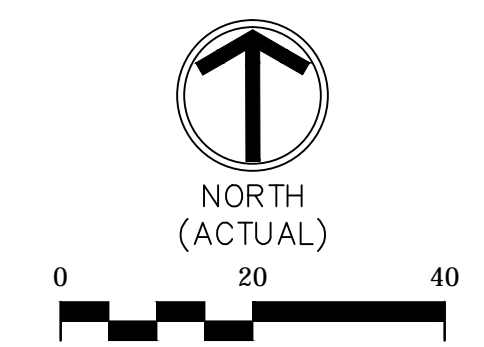

100% CONSTRUCTION DOCUMENTS

<p>Revisions:</p> <table border="1" style="width: 100%; border-collapse: collapse;"> <tr> <th style="width: 5%;">No.</th> <th style="width: 15%;">Description</th> <th style="width: 10%;">Date</th> </tr> <tr> <td> </td> <td> </td> <td> </td> </tr> <tr> <td> </td> <td> </td> <td> </td> </tr> </table>	No.	Description	Date							<p>CONSULTANTS:</p>	<p>ARCHITECT/ENGINEERS:</p> <div style="text-align: center;"> <p>WYLE JOSEPH CYR REGISTERED PROFESSIONAL ENGINEER STATE OF VIRGINIA License No. 11100558</p> </div> <div style="text-align: center;"> <p>APOGEE Consulting Group, PA www.apogee-pa.com Apogee Project # 2014 121</p> </div> <div style="text-align: center;"> <p>Civil / Structural Engineer GUIDON DESIGN 905 N. Capital Avenue, STE 10030 Indianapolis, IN 46225 Tel: (317) 830-4388</p> </div>	<p>Drawing Title UTILITY PLAN - SOUTH</p> <p>Approved: Project Director</p>	<p>Project Title REPLACE MAIN ELECTRICAL TO OUT BUILDINGS</p> <p>Location FORT WAYNE, IN</p> <p>Date 9/18/2015</p> <p>Checked KJC</p> <p>Drawn CMB</p>	<p>Project Number 610A4-12-188</p> <p>Building Numbers 1,3,5,6,7,10,T4,T5,T6</p> <p>Drawing Number CU101 Dwg. 12 of 48</p>	<p style="text-align: center;">Office of Construction and Facilities Management</p> <p style="text-align: center;"> Department of Veterans Affairs</p>
No.	Description	Date													