

GENERAL NOTES

1. PROJECT TO BE COMPLETED IN PHASES. MAIN LOBBY SHALL BE OPEN DURING NORMAL BUSINESS HOURS.
2. ALL WORK TO BE DONE AFTER NORMAL BUSINESS HOURS; WEEKENDS AND HOLIDAYS. MAIN LIBBY TO REMAIN OPEN DURING RENOVATION.
3. TEMPORARY CONSTRUCTION BARRIERS WILL BE REQUIRED AROUND ALL WORK AREAS FOR DUST CONTAINMENT. BARRIERS TO BE REMOVED AT THE END OF THE WORK SHIFT.
4. CONTRACTOR TO COORDINATE ALL WITH WITH C.O.R.
5. CONTRACTOR IS RESPONSIBLE TO REPAIR ANY AREAS DAMAGED DURING THE RENOVATION.


KEY NOTES

- ① REMOVE EXISTING CARPET COMPLETE AS SHOWN. PATCH AND REPAIR CONCRETE SLAB BELOW AS REQUIRED.
- ② REMOVE EXISTING PLANTER AS SHOWN. PATCH AND REPAIR CONCRETE SLAB BELOW.
- ③ REMOVE OLD RECEPTION DESK AS SHOWN. RELOCATE LIGHTING CONTROLS SWITCHES AND SPEAKER CONTROLS. REMOVE EXISTING POWER OUTLETS COMPLETE. PATCH AND REPAIR CONCRETE SLAB AS REQUIRED. SEE ELECTRICAL FOR ADDITIONAL INFORMATION.
- ④ REMOVE EXISTING SLIDING DOOR COMPLETE. PREP OPENING FOR NEW SLIDING DOOR.
- ⑤ REMOVE EXISTING CERAMIC FLOOR TILE COMPLETE. PATCH AND REPAIR FLOOR AS REQUIRED FOR NEW WORK.
- ⑥ EXISTING RECEPTION DESK TO REMAIN.

1 1ST FLOOR PLAN - DEMOLITION
SCALE: 1/8"=1'-0"

three inches = one foot
 one and one half inches = one foot
 one inch = one foot
 three quarters inch = one foot
 one half inch = one foot
 three eighths inch = one foot
 one quarter inch = one foot
 one eighth inch = one foot
 S:\Engineering\COMMON\Projects\Construction\Projects\FY 17\580-17-125 Main Lobby Improvements\1stfloor-base-DEMO.dwg 7-27-17 08:50:35 AM VHAHOUlandm

	Dept. of Veterans Affairs Michael E. DeBakey VAMC 2002 Holcombe Blvd. Houston, TX		ARCHITECT/ENGINEERS:	Drawing Title ST FLOOR PLAN - DEMOLITION	Project Title MAIN LOBBY IMPROVEMENTS	Project Number 580-17-125 Building Number 100	Office of Construction and Facilities Management
Approved: Chief Engineer/Division Manager	Location VA Medical Center Houston, TX	Drawing Number AD-101	Date 7/21/2017	Checked ML	Drawn mal	Dwg 2 of 12	

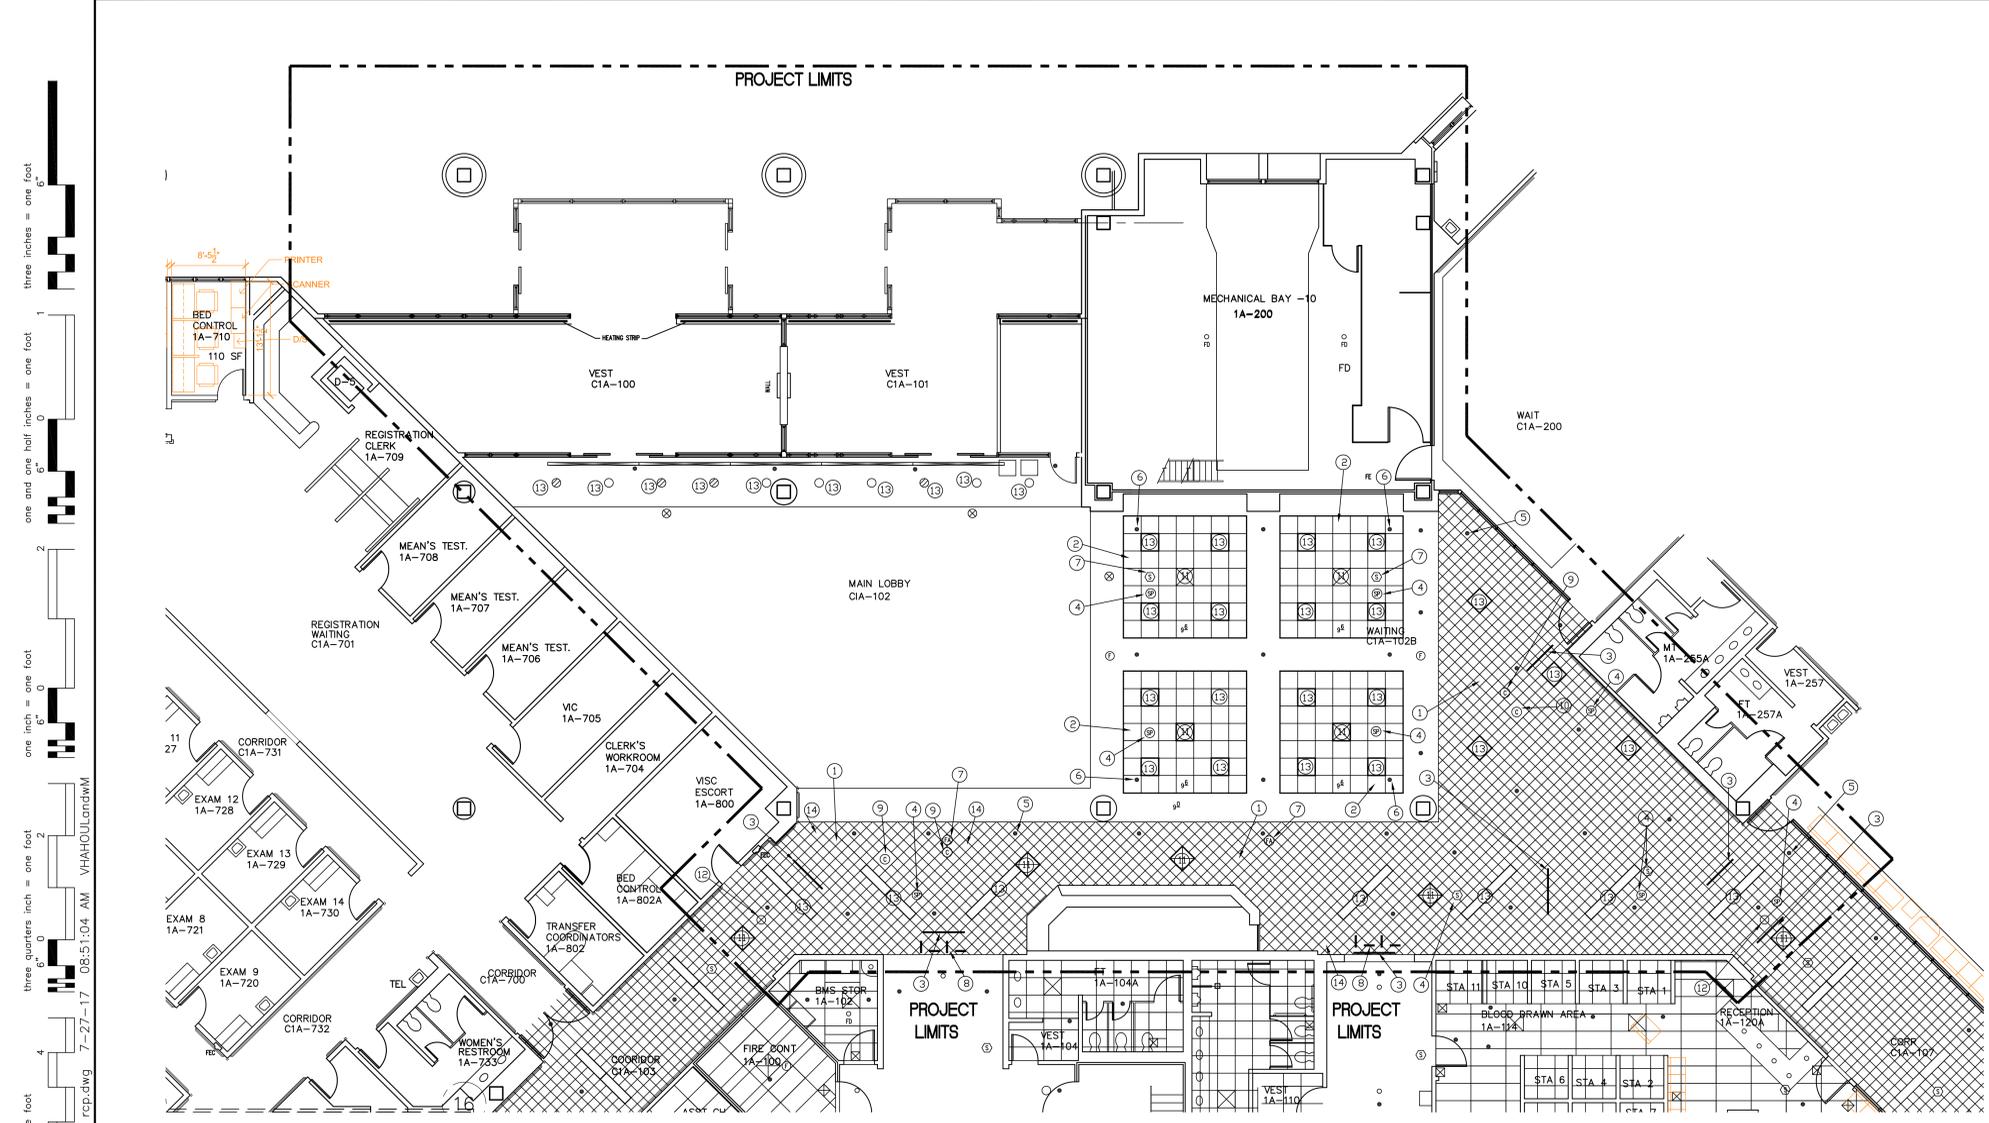

- LEGEND**
- 2 X 2 LED FIXTURE - SEE ELECTRICAL
 - 2 X 2 LED FIXTURE W/BATT B/U - SEE ELECTRICAL
 - ▨ 2 X 4 LED FIXTURE - SEE ELECTRICAL
 - ▩ 2 X 4 LED FIXTURE W/BATT B/U - SEE ELECTRICAL
 - RECESSED LED FIXTURE - SEE ELECTRICAL
 - ⊙ ELECTRICAL RECESSED LED FIXTURE W/BATT B/U - SEE ELECTRICAL
 - ⊚ ELECTRICAL PENDENT LED FIXTURE - SEE ELECTRICAL
 - ⊛ ELECTRICAL PENDENT LED FIXTURE - LIFE SAFETY BRANCH - SEE ELECTRICAL
 - ▭ 1 X 4 EXISTING FIXTURE
 - ⊠ 2 X 2 HVAC SUPPLY
 - ⊡ 2 X 2 HVAC RETURN
 - LINEAR HVAC SUPPLY
 - LINEAR HVAC RETURN
 - ⊞ 2 X 2 SUSPENDED CEILING
 - ▨ GYP. BD. CEILING
 - EXISTING SPRINKLER
 - ⊙ EXISTING FIRE ALARM DEVICE
 - ⊚ EXISTING SPEAKER
 - ⊛ EXISTING SECURITY CAMERA
 - ⊜ EXISTING EXIT LIGHT
 - EXISTING SIGNAGE - CEILING MOUNTED

- GENERAL NOTES**
1. PROJECT TO BE COMPLETED IN PHASES. MAIN LOBBY SHALL BE OPEN DURING NORMAL BUSINESS HOURS.
 2. ALL WORK TO BE DONE AFTER NORMAL BUSINESS HOURS, WEEKENDS AND HOLIDAYS. MAIN LOBBY TO REMAIN OPEN DURING RENOVATION.
 3. TEMPORARY CONSTRUCTION BARRIERS WILL BE REQUIRED AROUND ALL WORK AREAS FOR DUST CONTAINMENT. BARRIERS TO BE REMOVED AT THE END OF THE WORK SHIFT.
 4. CONTRACTOR TO COORDINATE ALL WITH WITH CDR.
 5. CONTRACTOR IS RESPONSIBLE TO REPAIR ANY AREAS DAMAGED DURING THE RENOVATION.


- KEY NOTES**
1. REMOVE EXISTING 12 X 12 CEILING SYSTEM COMPLETE. SEE NEW RCP FOR LIMITS OF DEMOLITION.
 2. REMOVE EXISTING 2' X 2' CEILING TILE GRID TO REMAIN
 3. REMOVE EXISTING CEILING MOUNTED SIGN. REINSTALL IN NEW CEILING.
 4. REMOVE EXISTING SPEAKER. REINSTALL IN NEW CEILING. SEE LEGEND-TYP
 5. EXISTING SPRINKLER TO REMAIN. ADJUST LOCATION TO CENTER IN NEW CEILING TILE. THIS CEILING ONLY.
 6. EXISTING SPRINKLER TO REMAIN.
 7. REMOVE EXISTING FIRE ALARM DEVICE. REINSTALL IN NEW CEILING. SEE LEGEND
 8. REMOVE EXISTING PATIENT WONDERING DEVICE. REINSTALL IN NEW CEILING
 9. REMOVE EXISTING SECURITY CAMERA. REINSTALL IN NEW CEILING. SEE LEGEND
 10. REMOVE EXISTING SECURITY CAMERA COMPLETE.
 11. EXISTING HVAC DEVICE TO BE REPLACED. SEE NEW RCP.
 12. REMOVE EXISTING EXIT LIGHT. REINSTALL IN NEW CEILING.
 13. REMOVE EXISTING LIGHT FIXTURE. CIRCUIT TO BE REUSED. SEE ELECTRICAL.
 14. REMOVE EXISTING WI-FI DEVICE. REINSTALL IN NEW CEILING.

1 1ST FLOOR REFLECTED CEILING PLAN - DEMOLITION
SCALE: 1/8"=1'-0"

three inches = one foot
 one and one half inches = one foot
 one inch = one foot
 one quarter inch = one foot
 three quarters inch = one foot
 one half inch = one foot
 three eighths inch = one foot
 one quarter inch = one foot
 one eighth inch = one foot
 S:\Engineering\COMMON\Projects\Construction\Projects\17\580-17-125 Main Lobby Improvements\100-17-X-existing rcp.dwg 7-27-17 08:51:04 AM VHAHQULandwM

	Dept. of Veterans Affairs Michael E. DeBakey VAMC 2002 Holcombe Blvd. Houston, TX	ARCHITECT/ENGINEERS:	Drawing Title 1 ST FLOOR REFLECTED CEILING PLAN - DEMOLITION	Project Title MAIN LOBBY IMPROVEMENTS	Project Number 580-17-125 Building Number 100	Office of Construction and Facilities Management Department of Veterans Affairs
Revisions Date			Approved Chief Engineer/Division Manager	Location VA Medical Center Houston, TX	Drawing Number AD-201 Dwg 3 of 12	
				Date 7/21/2017	Checked ML	Drawn mal

three inches = one foot
 one and one half inches = one foot
 one inch = one foot
 three quarters inch = one foot
 three quarters inch = one foot
 one half inch = one foot
 one half inch = one foot
 three eighths inch = one foot
 three eighths inch = one foot
 one quarter inch = one foot
 one eighth inch = one foot

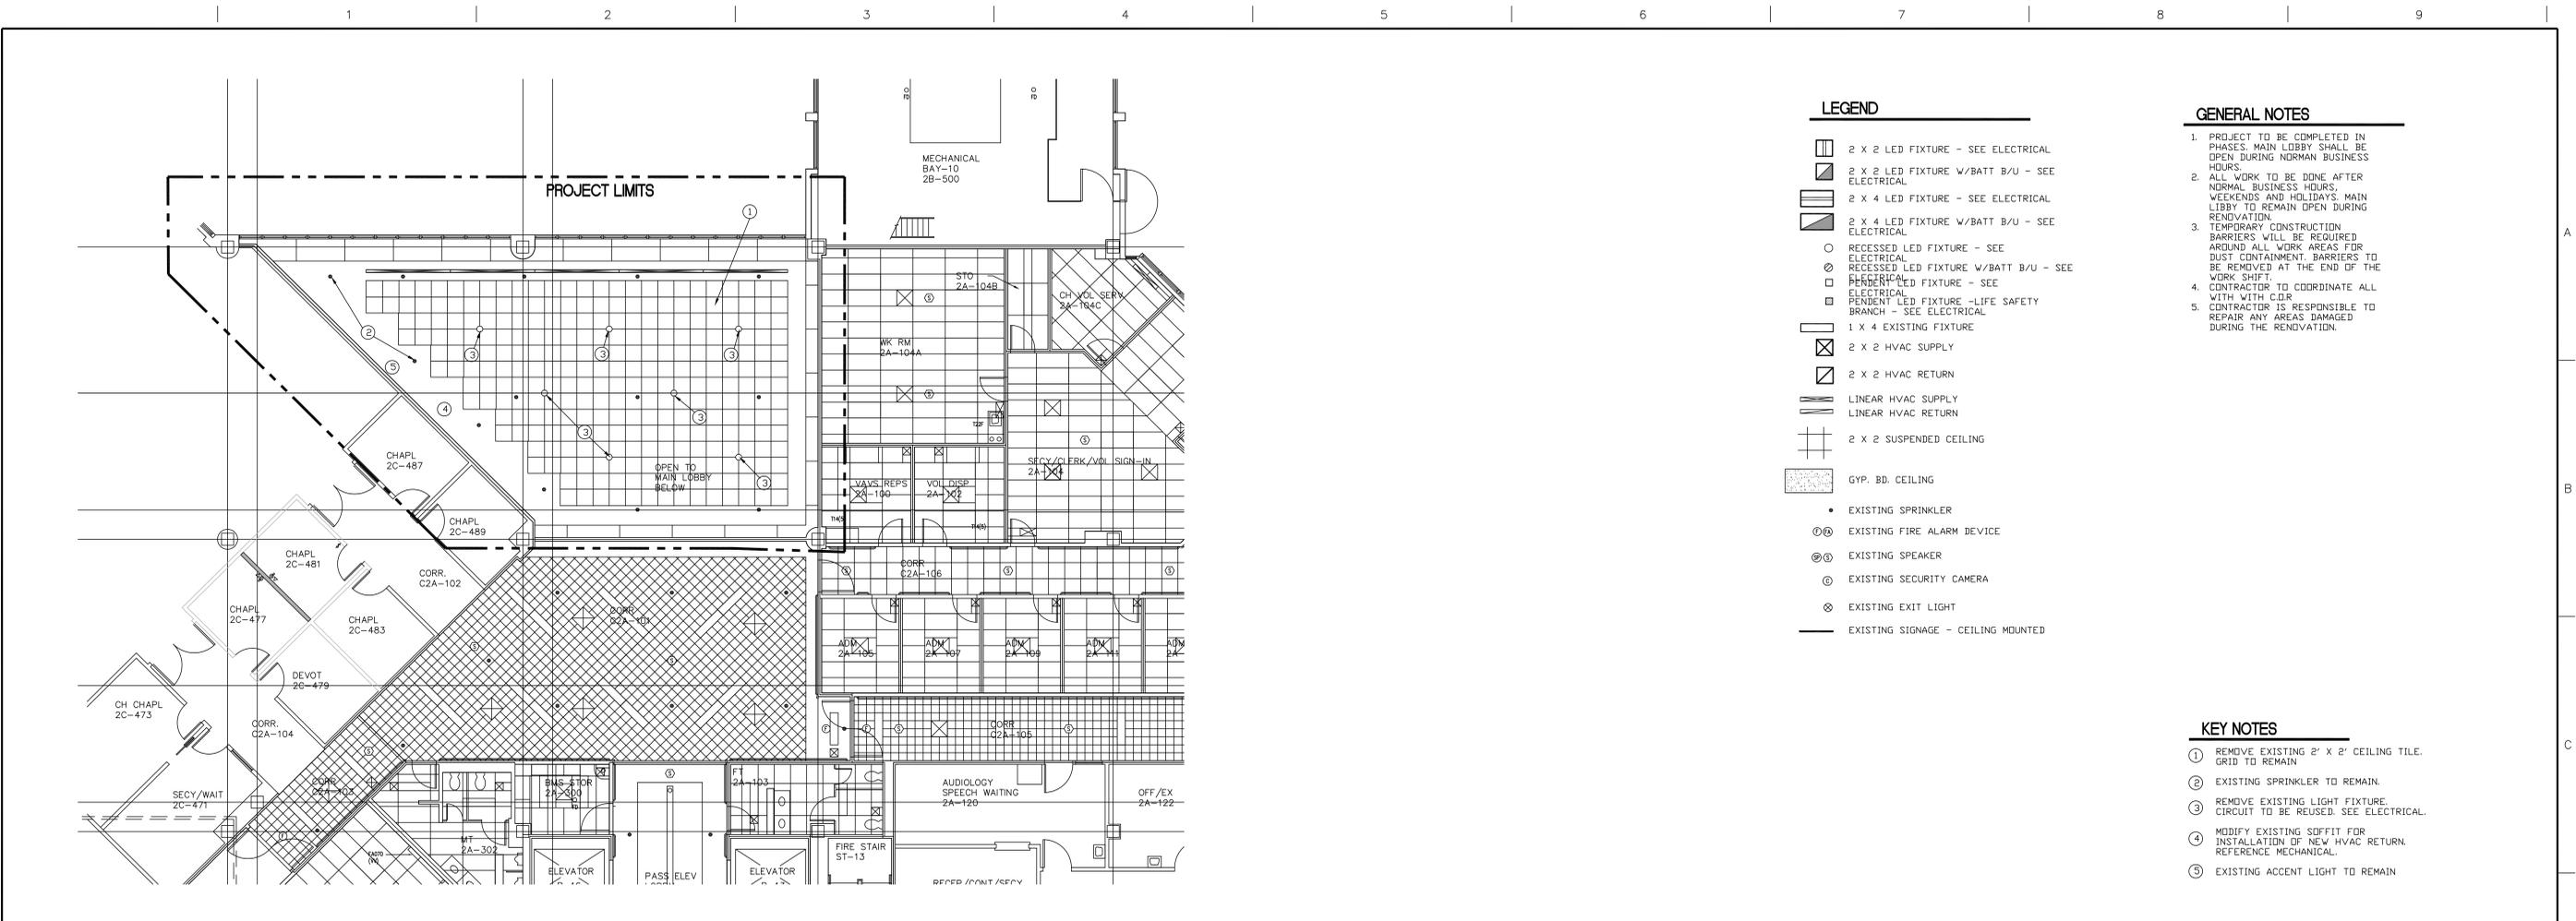

- LEGEND**
- 2 X 2 LED FIXTURE - SEE ELECTRICAL
 - ▣ 2 X 2 LED FIXTURE W/BATT B/U - SEE ELECTRICAL
 - ▤ 2 X 4 LED FIXTURE - SEE ELECTRICAL
 - ▥ 2 X 4 LED FIXTURE W/BATT B/U - SEE ELECTRICAL
 - RECESSED LED FIXTURE - SEE ELECTRICAL
 - ⊙ RECESSED LED FIXTURE W/BATT B/U - SEE ELECTRICAL
 - ⊠ RECESSED LED FIXTURE - SEE ELECTRICAL
 - ⊞ PENDENT LED FIXTURE -LIFE SAFETY BRANCH - SEE ELECTRICAL
 - ▭ 1 X 4 EXISTING FIXTURE
 - ⊗ 2 X 2 HVAC SUPPLY
 - ⊘ 2 X 2 HVAC RETURN
 - LINEAR HVAC SUPPLY
 - LINEAR HVAC RETURN
 - ⊞ 2 X 2 SUSPENDED CEILING
 - ▨ GYP. BD. CEILING
 - EXISTING SPRINKLER
 - ⊙ EXISTING FIRE ALARM DEVICE
 - ⊞ EXISTING SPEAKER
 - ⊙ EXISTING SECURITY CAMERA
 - ⊗ EXISTING EXIT LIGHT
 - EXISTING SIGNAGE - CEILING MOUNTED

- GENERAL NOTES**
1. PROJECT TO BE COMPLETED IN PHASES. MAIN LOBBY SHALL BE OPEN DURING NORMAL BUSINESS HOURS.
 2. ALL WORK TO BE DONE AFTER NORMAL BUSINESS HOURS. WEEKENDS AND HOLIDAYS. MAIN LOBBY TO REMAIN OPEN DURING RENOVATION.
 3. TEMPORARY CONSTRUCTION BARRIERS WILL BE REQUIRED AROUND ALL WORK AREAS FOR DUST CONTAINMENT. BARRIERS TO BE REMOVED AT THE END OF THE WORK SHIFT.
 4. CONTRACTOR TO COORDINATE ALL WITH WITH C.D.R.
 5. CONTRACTOR IS RESPONSIBLE TO REPAIR ANY AREAS DAMAGED DURING THE RENOVATION.

- KEY NOTES**
- ① REMOVE EXISTING 2' X 2' CEILING TILE. GRID TO REMAIN
 - ② EXISTING SPRINKLER TO REMAIN.
 - ③ REMOVE EXISTING LIGHT FIXTURE. CIRCUIT TO BE REUSED. SEE ELECTRICAL.
 - ④ MODIFY EXISTING SOFFIT FOR INSTALLATION OF NEW HVAC RETURN. REFERENCE MECHANICAL.
 - ⑤ EXISTING ACCENT LIGHT TO REMAIN

1 2ND FLOOR REFLECTED CEILING PLAN - DEMOLITION
 SCALE: 1/8"=1'-0"

Revisions	Date



Dept. of Veterans Affairs
 Michael E. DeBakey VAMC
 2002 Holcombe Blvd.
 Houston, TX



ARCHITECT/ENGINEERS:

Drawing Title
2ND FLOOR REFLECTED CEILING PLAN - DEMOLITION

Approved: Chief Engineer/Division Manager

Project Title
MAIN LOBBY IMPROVEMENTS

Location
 VA Medical Center Houston, TX

Date
 7/21/2017

Checked
 ML

Drawn
 mal

Project Number
580-17-125

Building Number
100

Drawing Number
AD-202

Dwg 4 of 12


Office of Construction and Facilities Management



Department of Veterans Affairs

one eighth inch = one foot
 one quarter inch = one foot
 three eighths inch = one foot
 one half inch = one foot
 three quarters inch = one foot
 one inch = one foot
 one and one half inches = one foot
 three inches = one foot

S:\Engineering\COMMON\Projects\Construction Projects\FY 17\580-17-125_Main Lobby Improvements\100-2R-K-rcp-new.dwg 7-27-17 08:53:11 AM VHAHQJLlancwM

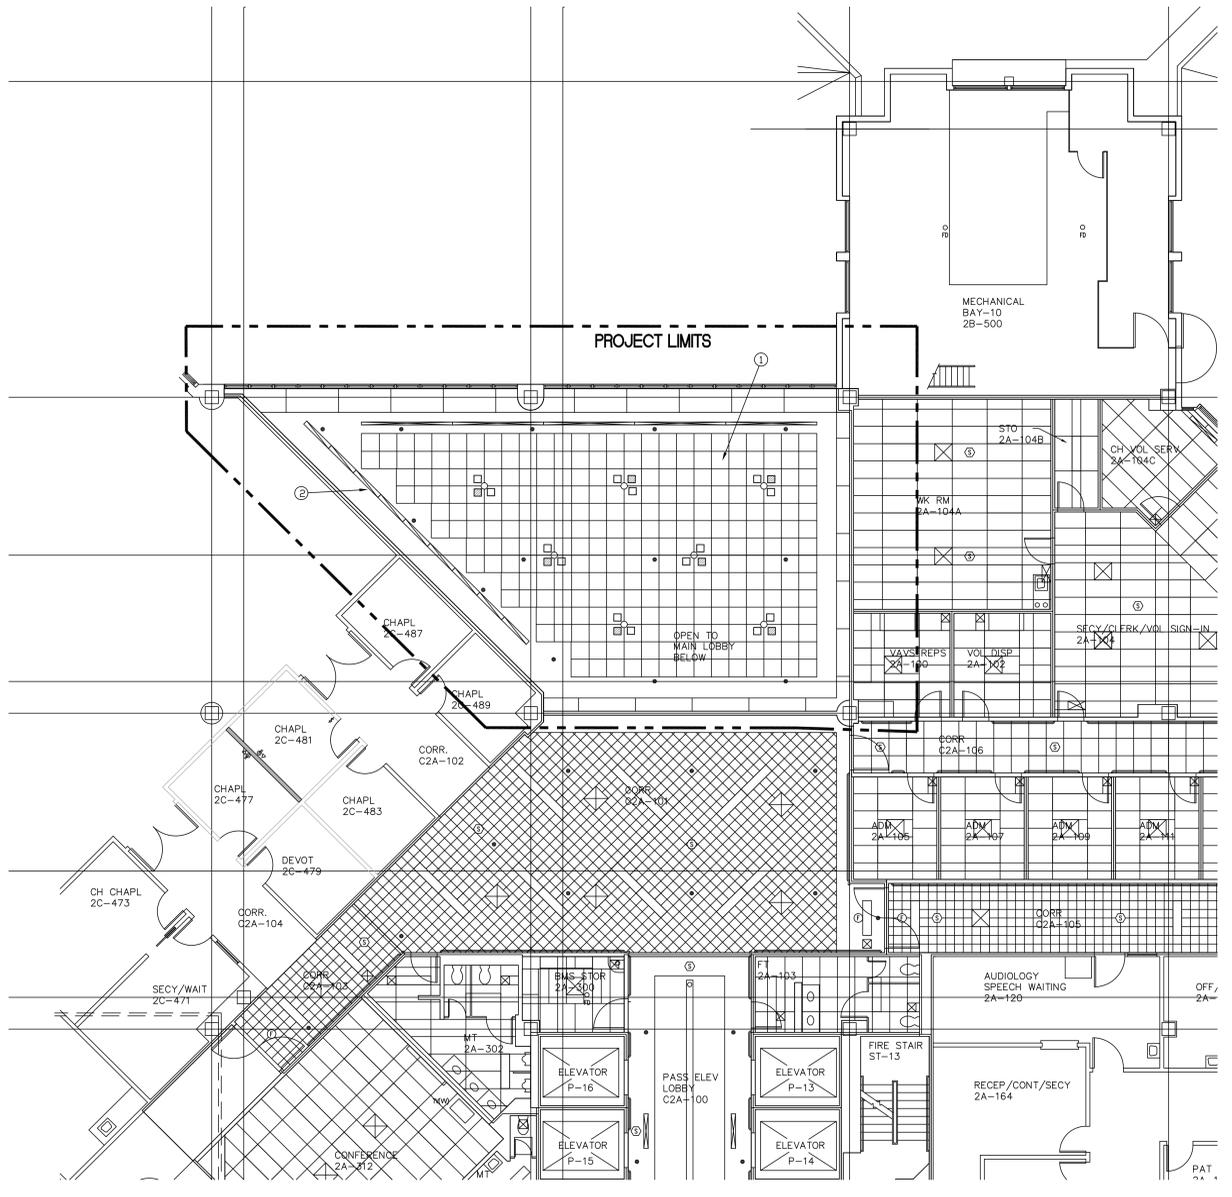

1 2ND FLOOR REFLECTED CEILING PLAN
 SCALE: 1/8"=1'-0"

LEGEND

- 2 X 2 LED FIXTURE - SEE ELECTRICAL
- 2 X 2 LED FIXTURE W/BATT B/U - SEE ELECTRICAL
- 2 X 4 LED FIXTURE - SEE ELECTRICAL
- 2 X 4 LED FIXTURE W/BATT B/U - SEE ELECTRICAL
- RECESSED LED FIXTURE - SEE ELECTRICAL
- RECESSED LED FIXTURE W/BATT B/U - SEE ELECTRICAL
- RECESSED LED FIXTURE - LIFE SAFETY BRANCH - SEE ELECTRICAL
- 1 X 4 EXISTING FIXTURE
- 2 X 2 HVAC SUPPLY
- 2 X 2 HVAC RETURN
- LINEAR HVAC SUPPLY
- LINEAR HVAC RETURN
- 2 X 2 SUSPENDED CEILING
- GYP. BD. CEILING
- EXISTING SPRINKLER
- EXISTING FIRE ALARM DEVICE
- EXISTING SPEAKER
- EXISTING SECURITY CAMERA
- EXISTING EXIT LIGHT
- EXISTING SIGNAGE - CEILING MOUNTED

GENERAL NOTES

1. PROJECT TO BE COMPLETED IN PHASES. MAIN LOBBY SHALL BE OPEN DURING NORMAL BUSINESS HOURS.
2. ALL WORK TO BE DONE AFTER NORMAL BUSINESS HOURS. WEEKENDS AND HOLIDAYS. MAIN LOBBY TO REMAIN OPEN DURING RENOVATION.
3. TEMPORARY CONSTRUCTION BARRIERS WILL BE REQUIRED AROUND ALL WORK AREAS FOR DUST CONTAINMENT. BARRIERS TO BE REMOVED AT THE END OF THE WORK SHIFT.
4. CONTRACTOR TO COORDINATE ALL WITH WITH COR.
5. CONTRACTOR IS RESPONSIBLE TO REPAIR ANY AREAS DAMAGED DURING THE RENOVATION.

KEY NOTES

- 1 NEW 2' X 2' CEILING TILE IN EXISTING GRID. REINSTALL ALL DEVICES AS SHOWN. SEE ELECTRICAL FOR LIGHTING.
- 2 NEW 2' X 2' HVAC DEVICE. MODIFY EXISTING SDDFIT AS REQUIRED FOR INSTALLATION. SEE MECHANICAL PLANS.



Dept. of Veterans Affairs
 Michael E. DeBakey VAMC
 2002 Holcombe Blvd.
 Houston, TX



ARCHITECT/ENGINEERS:

Drawing Title
2ND FLOOR REFLECTED CEILING PLAN

Approved: Chief Engineer/Division Manager

Project Title
MAIN LOBBY IMPROVEMENTS

Location
 VA Medical Center Houston, TX

Date
 7/21/2017

Checked
 ML

Drawn
 mal

Project Number
580-17-125

Building Number
 100

Drawing Number
AS-202
 Dwg 7 of 12

Office of Construction and Facilities Management



