



K:\2013\2013030_00>Loading Dock\Correct Safety Deficiencies at Loading Dock\DWG\2013.030.00_AE108.dwg, 12/11/2014 9:16:49 AM

ONE EIGHTH INCH = ONE FOOT
ONE QUARTER INCH = ONE FOOT
ONE HALF INCH = ONE FOOT
THREE EIGHTHS INCH = ONE FOOT
THREE QUARTERS INCH = ONE FOOT
ONE INCH = ONE FOOT
ONE AND ONE HALF INCHES = ONE FOOT
THREE INCHES = ONE FOOT

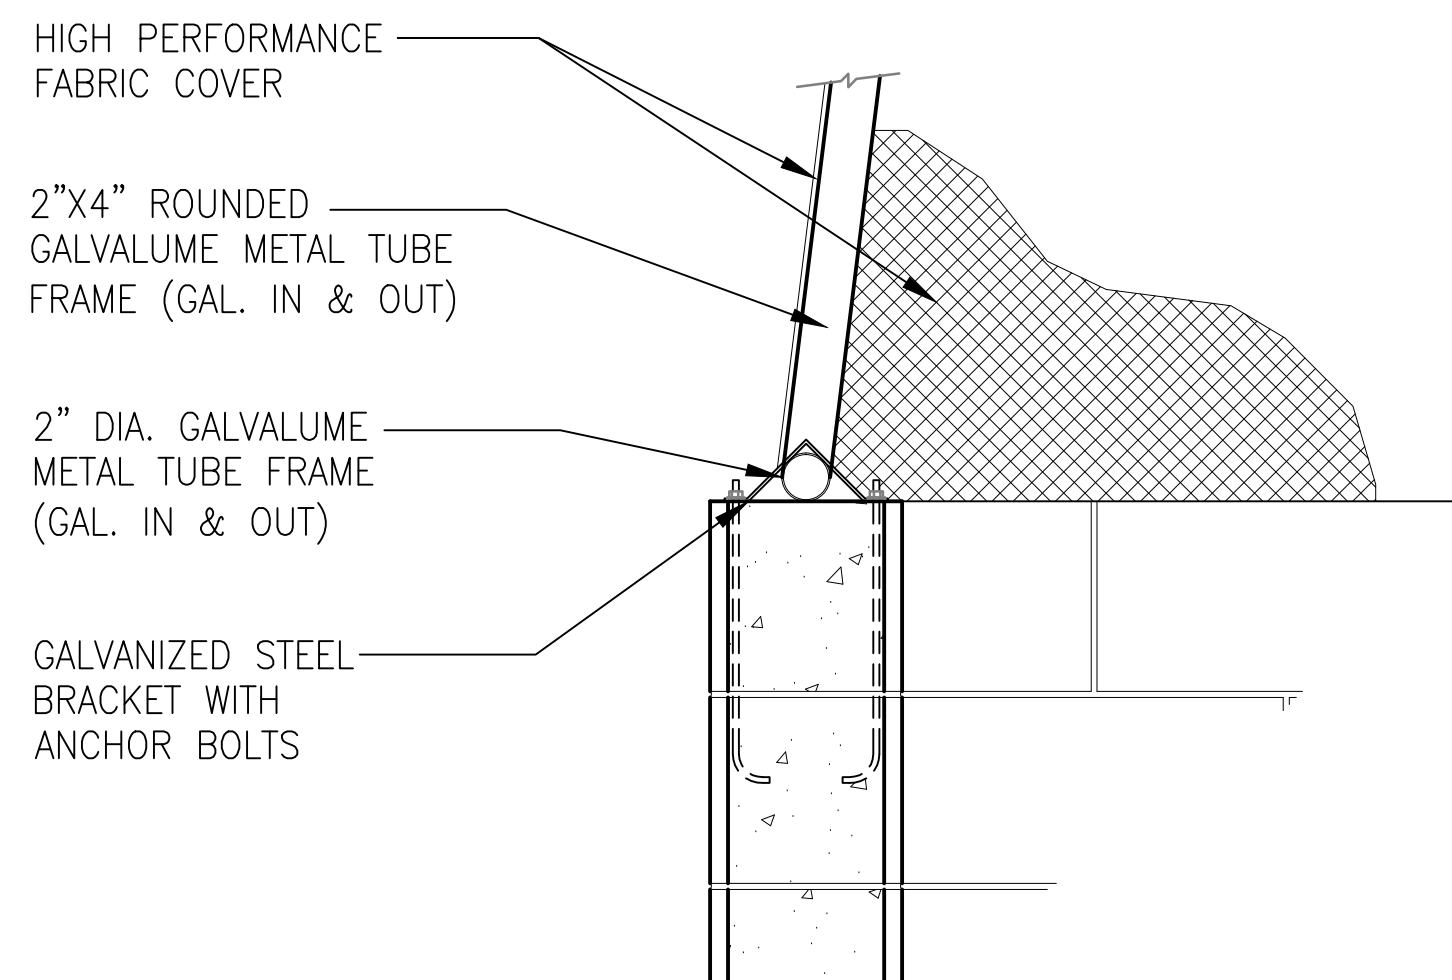

4 SECTION
AE108
NOT TO SCALE

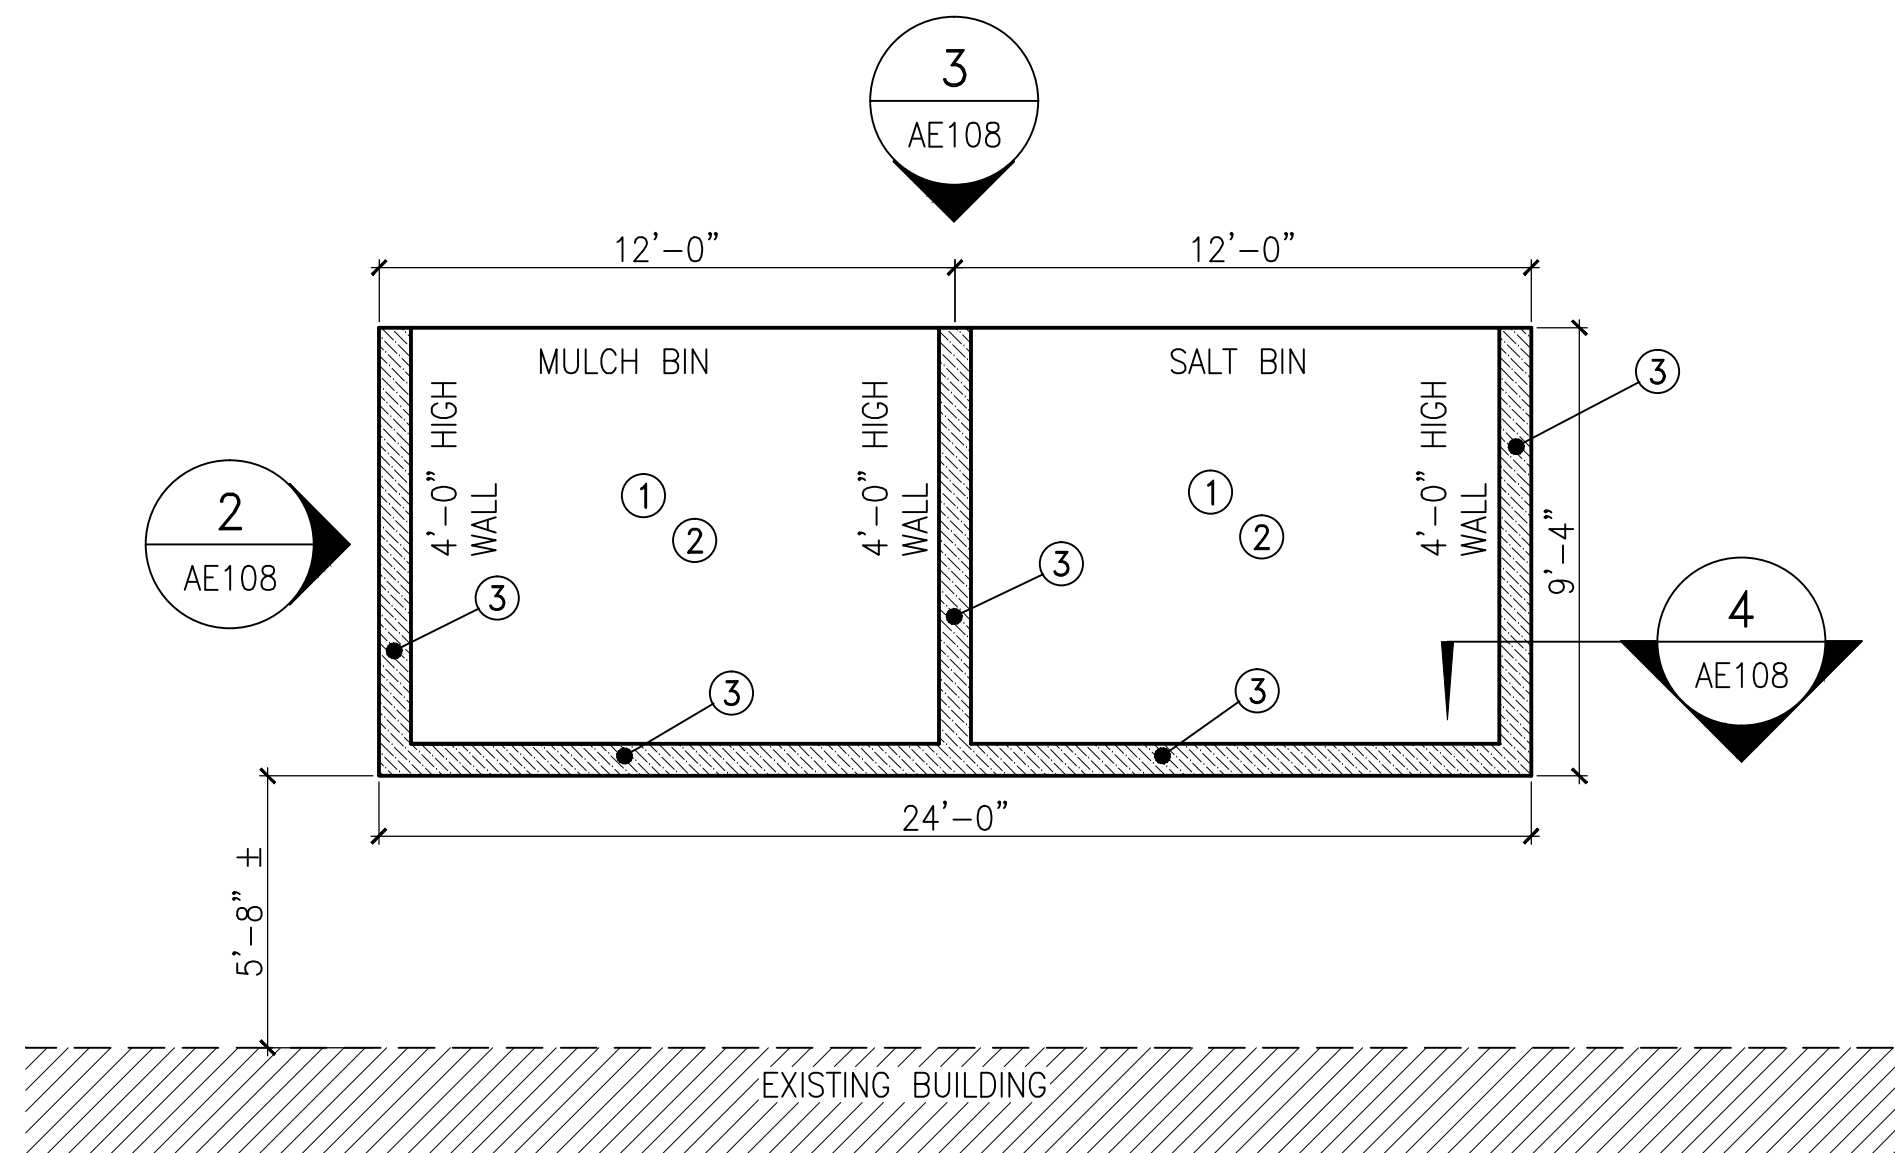


1 STORAGE BIN PLAN - NEW WORK
AE108
SCALE: 1/4" = 1'-0"

- ### NEW WORK NOTE SCHEDULE
- 1 PROVIDE NEW 6" REINFORCED CONCRETE SLAB. SEE STRUCTURAL DRAWINGS FOR ADDITIONAL INFORMATION.
 - 2 APPLY PROTECTIVE SEALER TO CONCRETE SLAB PER MANUFACTURER'S REQUIREMENTS, MINIMUM OF (2) COATS. ALLOW TO DRY THOROUGHLY. BASIS OF DESIGN IS CRETEDEFENDER INC. BUT IS NOT INTENDED TO LIMIT SELECTION. PROVIDE INDICATED EQUIPMENT OR EQUIPMENT OF EQUAL CAPACITY, QUALITY, AND PERFORMANCE.
 - 3 APPLY PROTECTIVE MASONRY SEALER/PRIMER TO CMU ALL SURFACES OF CMU WALLS PER MANUFACTURER'S REQUIREMENTS. BASIS OF DESIGN IS SUPER SPEC® MASONRY INTERIOR/EXTERIOR ACRYLIC HIGH BUILD MASONRY PRIMER N068, MANUFACTURED BY BENJAMIN MOORE, INC. BUT IS NOT INTENDED TO LIMIT SELECTION. PROVIDE INDICATED PRODUCT OR PRODUCT OF EQUAL CAPACITY, QUALITY, AND PERFORMANCE.
 - 4 INSTALL CANOPY PER DETAILS AND MANUFACTURER'S REQUIREMENTS.


GENERAL NOTE

REFER TO STRUCTURAL DRAWINGS S101 AND S102 FOR ADDITIONAL INFORMATION.

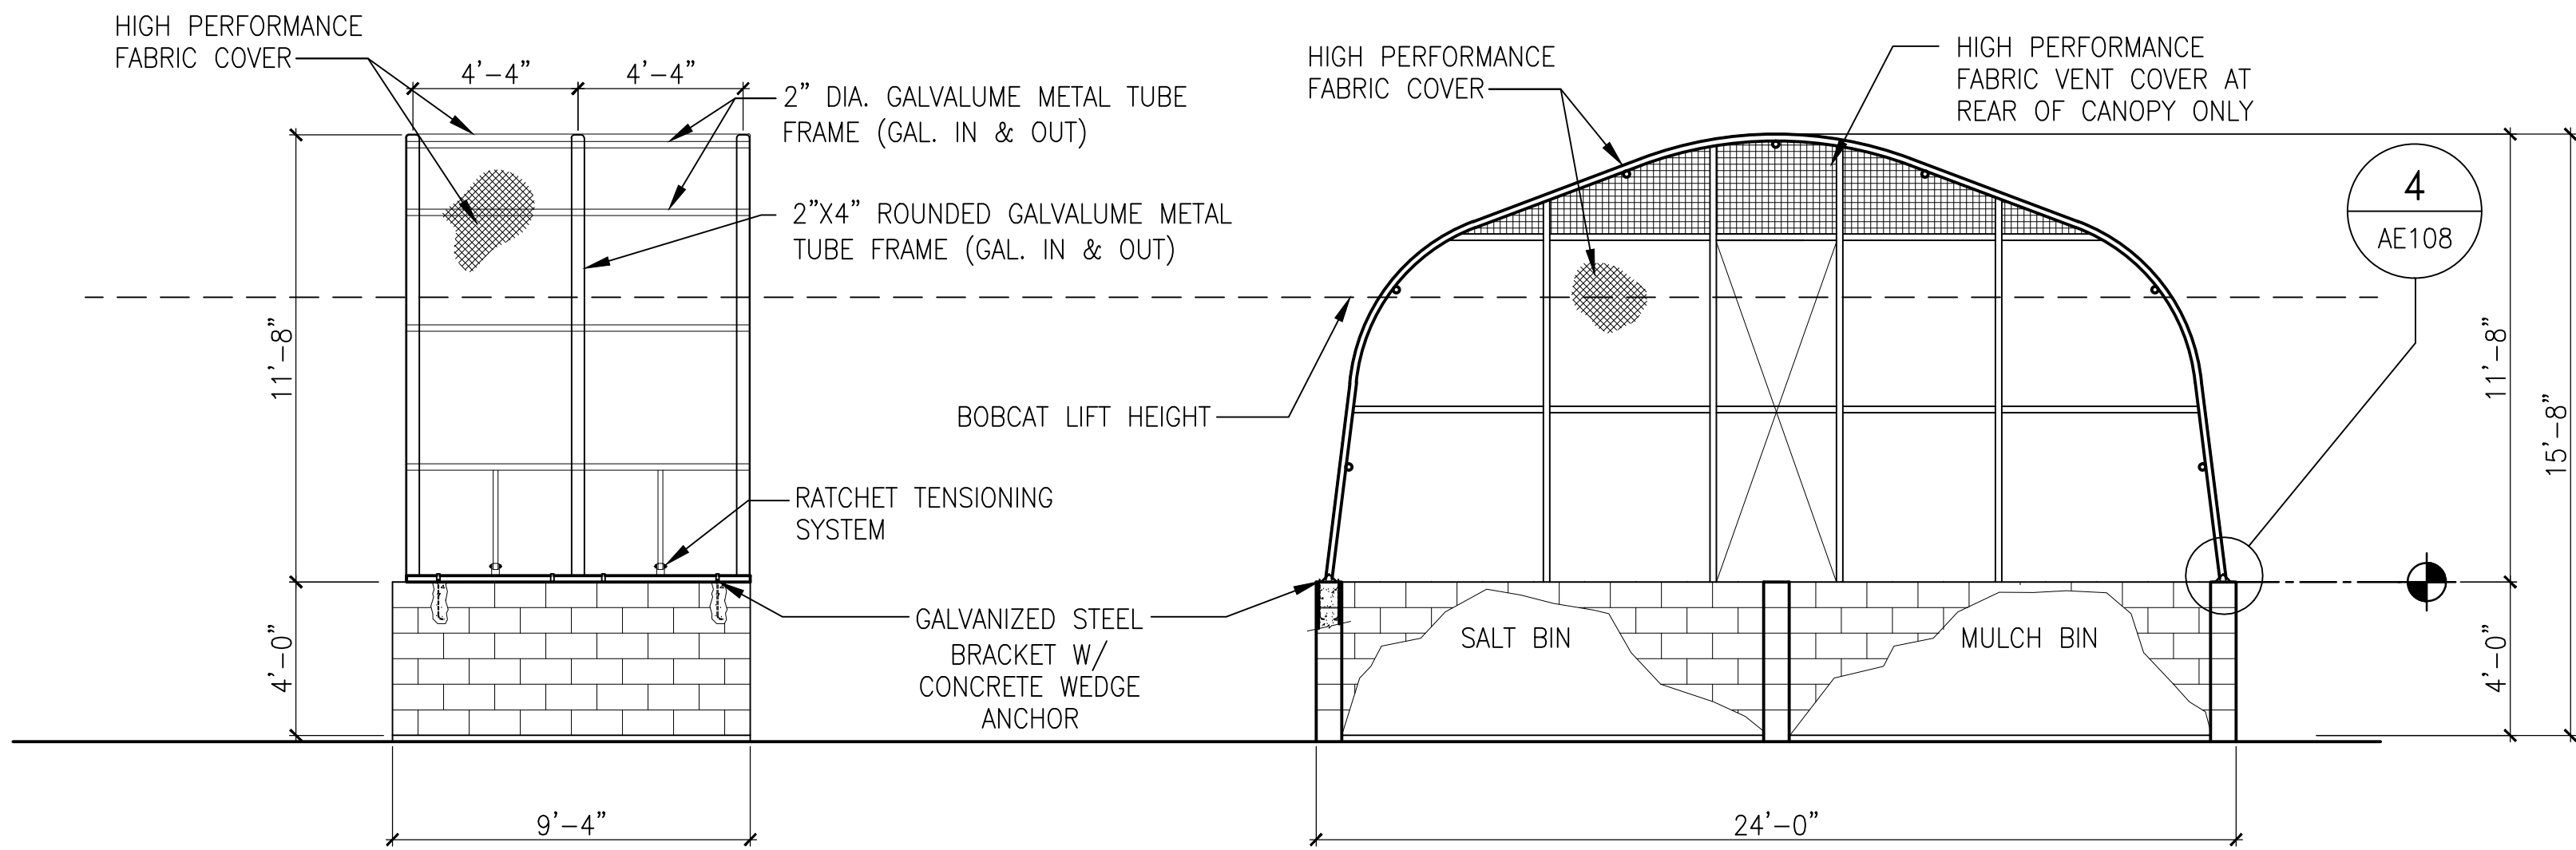

2 SIDE ELEVATION
STORAGE BINS - NEW WORK
AE108
SCALE: 1/4" = 1'-0"

3 FRONT ELEVATION
STORAGE BINS - NEW WORK
AE108
SCALE: 1/4" = 1'-0"

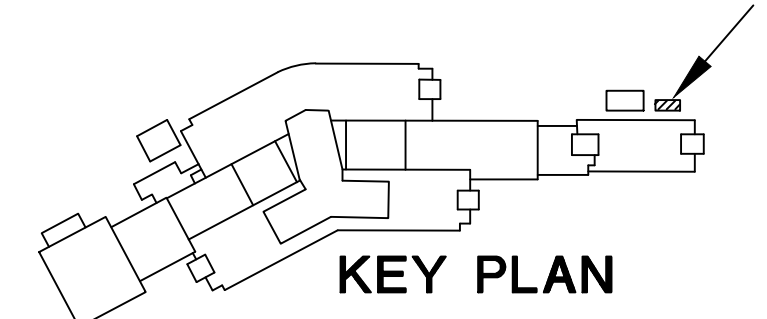

FINAL SUBMISSION

CONSULTANTS:			ARCHITECT/ENGINEERS:		Drawing Title STORAGE BIN PLAN, ELEVATIONS AND DETAILS - NEW WORK		Project Title CORRECT SAFETY DEFICIENCIES AT LOADING DOCK JAMES PETERS MEDICAL CENTER, BRONX, NY		Project Number 526-13-108		Office of Construction and Facilities Management Department of Veterans Affairs
			BES ARCHITECTS ENGINEERS CONSTRUCTORS P.O. BOX 2060, BEAUFORT, S.C. 29901-2060 843-522-2094		Approved Project Director		Location Date 11/07/2014 Checked RLD Drawn JMA		Building Number N/A Drawing Number AE108 Dwg. 28 of 38		
Revisions:		Date									