


three inches = one foot  
one and one-half inches = one foot  
one inch = one foot  
three-quarters inch = one foot  
one-half inch = one foot  
three-eighths inch = one foot  
one-quarter inch = one foot  
one-eighth inch = one foot

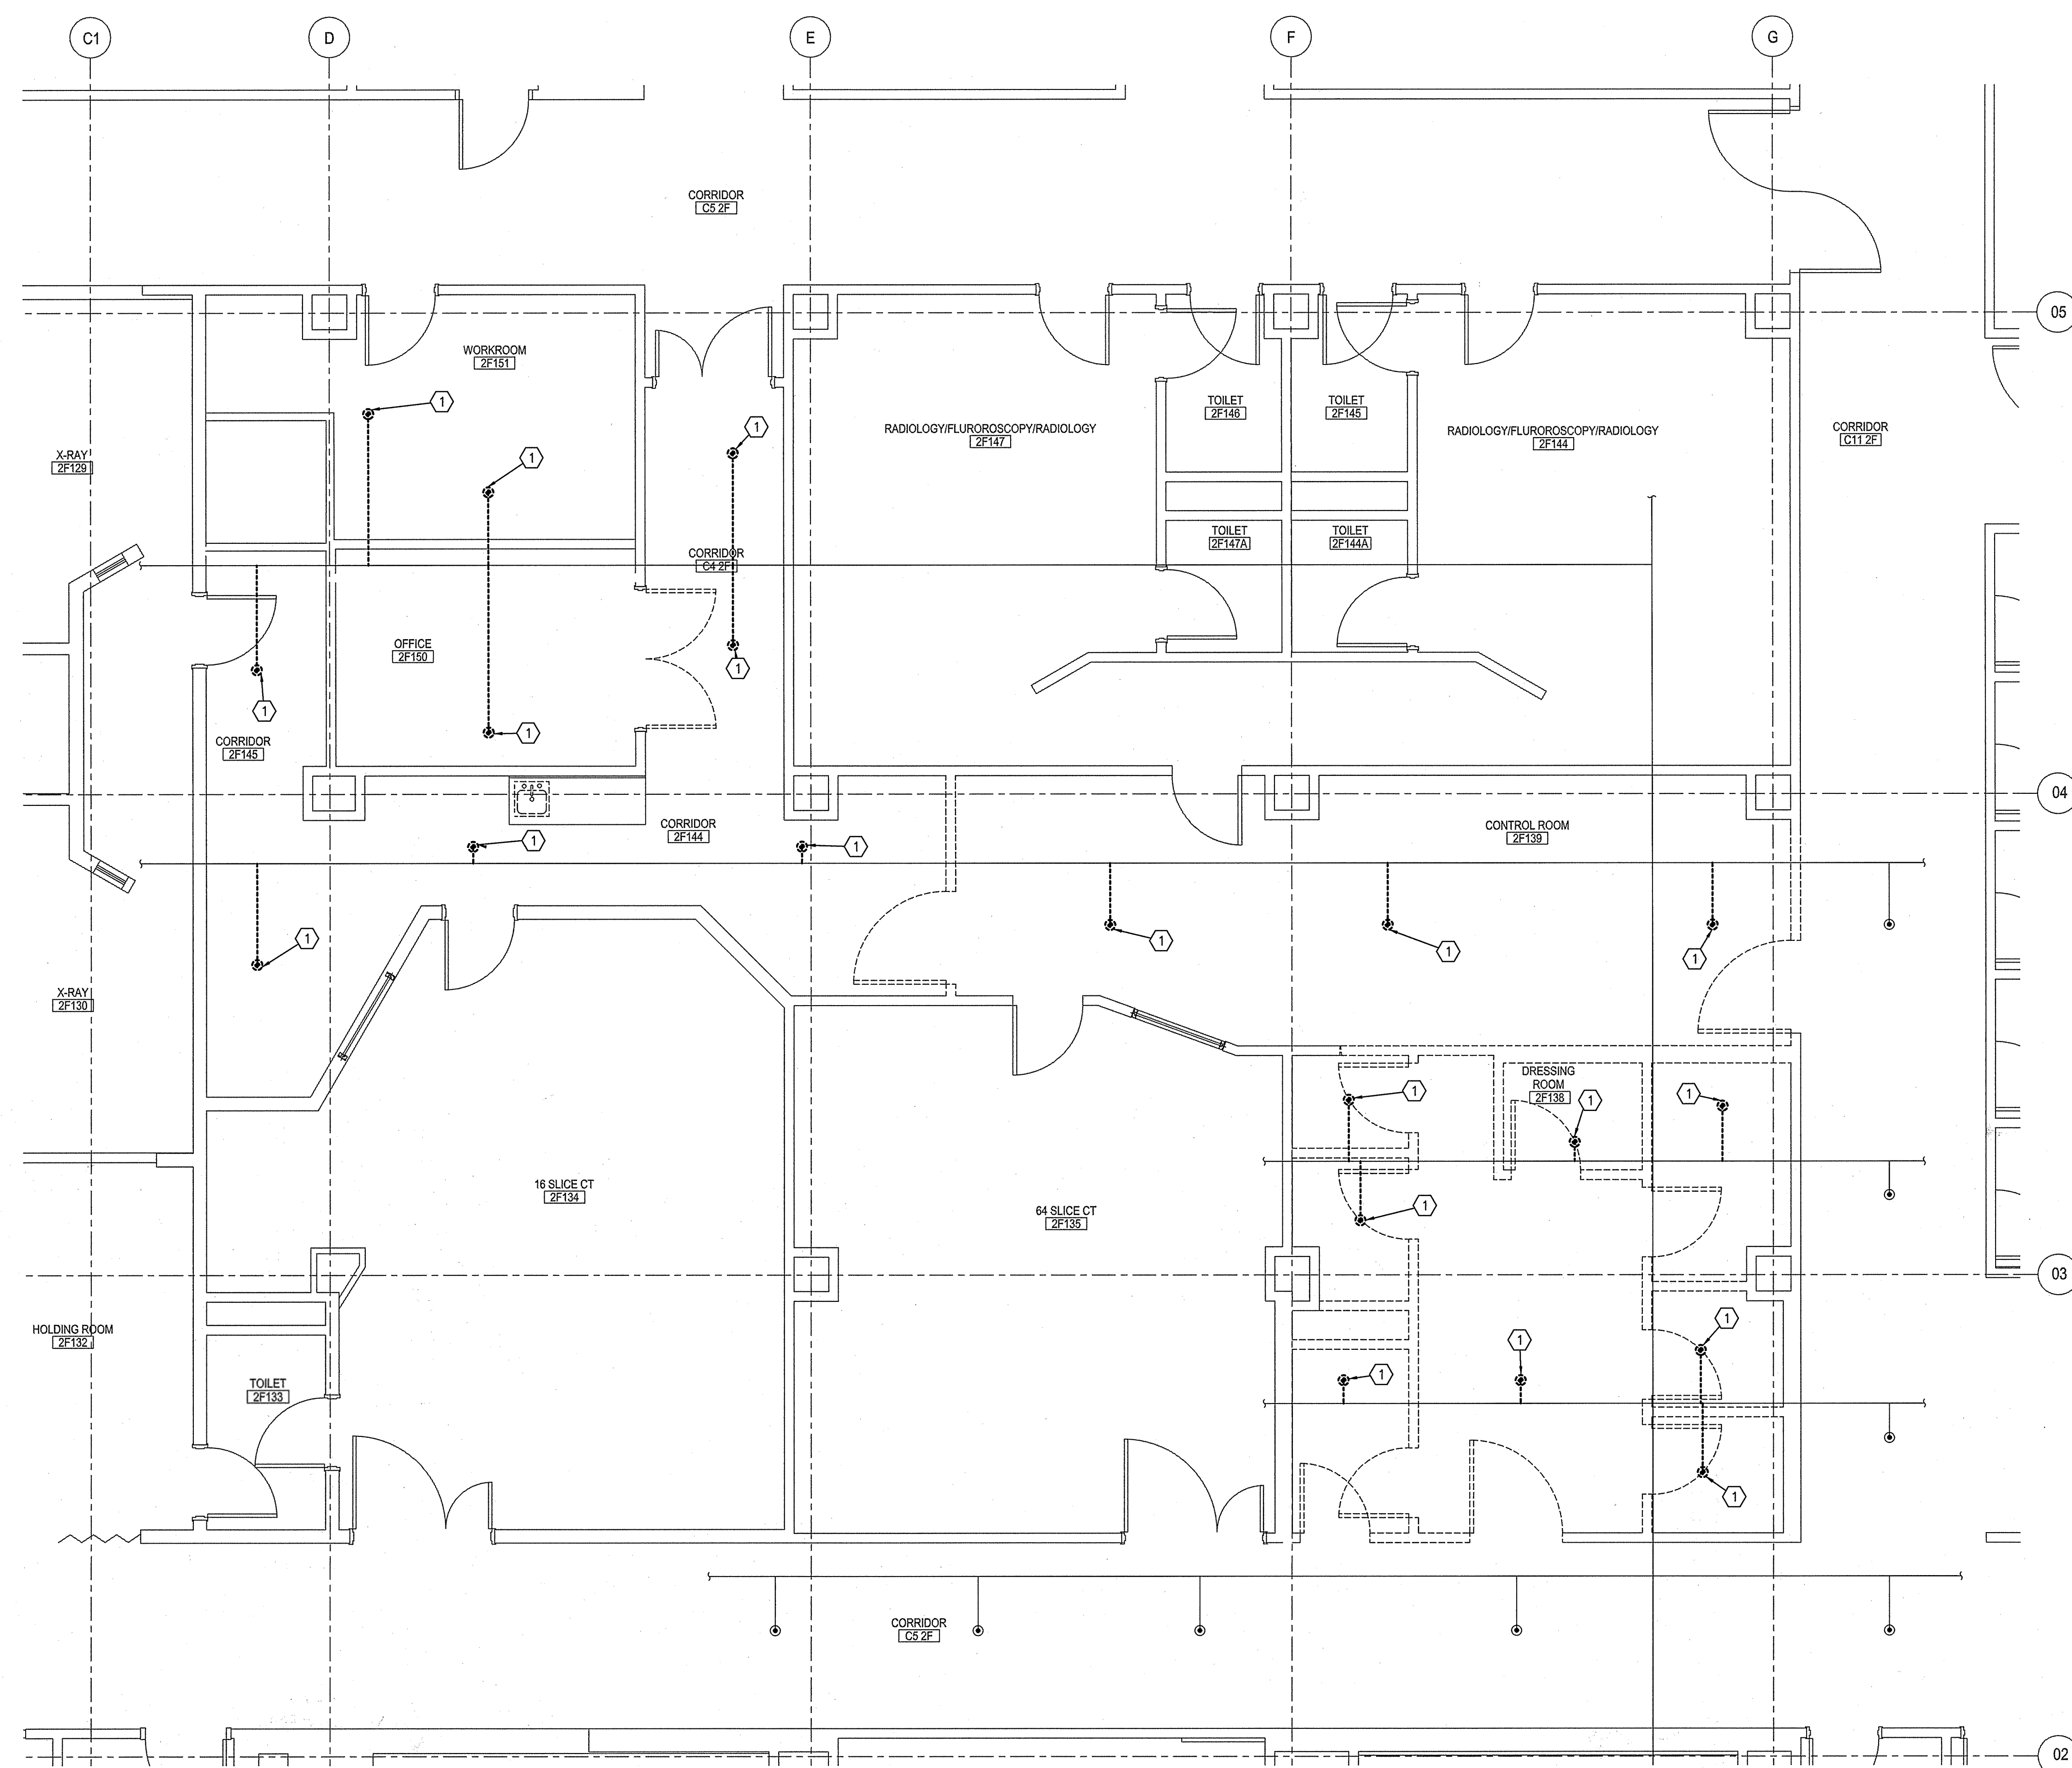

- FIRE SPRINKLER PLAN NOTES:**
1. REMOVE EXISTING SPRINKLERS AND BRANCH PIPING AS REQUIRED TO ALLOW INSTALLATION OF THE NEW FIRE PROTECTION SYSTEM, W/EP SYSTEMS, NEW CEILING, AND THE NEW FLOOR PLAN AS SHOWN ON FS101, PLUG AND CAP OFF EXISTING PIPE OUTLETS.
- FIRE SPRINKLER DEMOLITION NOTES:**
1. PRIOR TO SUBMITTING BID, VISIT THE JOB SITE AND BECOME FULLY ACQUAINTED WITH THE EXISTING CONDITIONS OF THE PROJECT. REVIEW THE GENERAL NOTES, SPECIFICATIONS AND OTHER DRAWINGS FOR ADDITIONAL REQUIREMENTS WHICH MAY NOT BE SPECIFICALLY CALLED OUT IN THIS PORTION OF THE CONSTRUCTION DOCUMENTS. NOTIFY ARCHITECT, ENGINEER AND/OR OWNER OF CONFLICTS OR DISCREPANCIES PRIOR TO SUBMISSION OF BID.
  2. EXISTING CONDITIONS WERE TAKEN FROM ORIGINAL DRAWINGS AND SITE VISITS AND MAY NOT REFLECT EXACT "AS-BUILT" CONDITIONS. FIELD VERIFY EXISTING CONDITIONS PRIOR TO SUBMITTING FINAL BIDS. COORDINATE NEW WORK AND DEMOLITION WITH OTHER DISCIPLINES AND EXISTING CONDITIONS PRIOR TO CONSTRUCTION.
  3. OWNER RETAINS RIGHTS OF SALVAGE FOR EQUIPMENT AND FIXTURES TO BE REMOVED. COORDINATE WITH THE OWNER THE EQUIPMENT AND FIXTURES TO BE SALVAGED AND THE LOCATION FOR STORAGE. AVOID DAMAGE TO EQUIPMENT, FIXTURES AND DEVICES DURING DEMOLITION WORK AND DURING TRANSPORT TO OWNER'S DESIGNATED STORAGE LOCATION.
  4. REMOVE ITEMS SHOWN HEAVY LINED AND/OR CROSSHATCHED AND/OR NOTED TO BE REMOVED.
  5. PERFORM ALL WORK ACCORDING TO THE PHASING SCHEDULE FOR THIS PROJECT. PROVIDE ALL TEMPORARY DESIGN AND/OR CONFIGURATIONS THAT MEET APPLICABLE CODE REQUIREMENTS AS NECESSARY TO CONFORM TO THE REQUIRED CONSTRUCTION PHASING OF THE PROJECT.
  6. ONLY THE PORTIONS OF THE BUILDING AFFECTED BY THE SCOPE OF THE PROJECT HAVE BEEN SHOWN. INFORMATION SHOWN AS EXISTING TO REMAIN IS NOT BEING MODIFIED AS A PART OF THIS PROJECT.
  7. ALL WORK SHALL BE PERFORMED SO AS TO NOT INTERRUPT SERVICE. THE CONTRACTOR SHALL PROPERLY NOTIFY THE BUILDING OWNER, LANDLORD, THE LEASER AND ADJACENT TENANTS AS APPLICABLE A MINIMUM OF 48 HOURS IN ADVANCE BEFORE PROCEEDING WITH THIS WORK.
  8. REMOVE ALL UNUSED AND DEMOLISHED EQUIPMENT AND ASSOCIATED MATERIALS FROM SITE. ABANDONING UNUSED PORTIONS WILL NOT BE ACCEPTABLE.
  9. AVOID DAMAGING EXISTING SURFACES AND EQUIPMENT TO REMAIN FOR NEW INSTALLATION. REPAIR ANY DAMAGE CAUSED DURING WORK AT NO EXTRA COST TO THE OWNER.
  10. SEAL ALL PENETRATIONS THROUGH FLOORS, WALLS, CEILINGS AND ROOFS WHERE FIRE SPRINKLER COMPONENTS ARE REMOVED AND WHERE THE EXISTING PENETRATION IS NOT USED FOR THE NEW INSTALLATION. REPAIR SURFACES TO MATCH ADJACENT AREAS.
  11. FIRE SPRINKLER SYSTEM(S) NOT ASSOCIATED WITH THE DEMOLITION SHALL BE LEFT IN SERVICE AS APPLICABLE.
  12. VERIFY THAT EXISTING EQUIPMENT TO REMAIN IS OPERATING PROPERLY. NOTIFY THE ARCHITECT, ENGINEER AND/OR OWNER OF ANY DAMAGED AND/OR MALFUNCTIONING COMPONENTS.
  13. ALL SYSTEMS TO BE LEFT IN SERVICE PRIOR TO THE END OF EACH WORKDAY.

1 FIRE PROTECTION DEMOLITION PLAN - SECOND FLOOR RADIOLOGY  
SCALE: 1/4"=1'-0"


<b>CONSULTANTS</b>		<b>ARCHITECT</b>		<b>SHEET TITLE</b>		<b>PROJECT TITLE</b>		<b>VA PROJECT NUMBER</b>		<b>Office of Construction and Facilities Management</b> Department of Veterans Affairs	
M.E.P. / F.P. / T. ENGINEER HENDERSON ENGINEERS, INC. 8345 LENEXA DRIVE, SUITE 300 LENEXA, KS 66214 (816) 742-5000		RADIOLOGY PLANNING RAD RADIOLOGY PLANNING 802 BROADWAY BOULEVARD, 5TH FLOOR KANSAS CITY, MO 64105 (816) 472-7722		FIRE PROTECTION DEMOLITION PLAN - SECOND FLOOR RADIOLOGY		SITE PREP FOR 80-SLICE CT		635-CSI-103			
1450000525 OK CONTRACT NUMBER: CA 1639 EXPIRES: 06/30/17		320 NW 15th St. SUITE 200 OKLAHOMA CITY, OK 73103 spur design.com		APPROVED: PROJECT DIRECTOR		PROJECT LOCATION OKLAHOMA CITY VA HEALTH CARE SYSTEM 921 NE 13TH STREET OKLAHOMA CITY, OK 73104		BUILDING NUMBER 1			
REVISION # DATE		DARRELL E. STEN REGISTERED PROFESSIONAL ENGINEER OKLAHOMA		DATE 04/18/2017		CHECKED CHK		DRAWN DRW			
1450000525 OK CONTRACT NUMBER: CA 1639 EXPIRES: 06/30/17		1311 Westport Blvd KANSAS CITY, MO 64111 spur design.com		DATE 04/18/2017		CHECKED CHK		DRAWN DRW		DRAWING NUMBER FD-101	
1450000525 OK CONTRACT NUMBER: CA 1639 EXPIRES: 06/30/17		1311 Westport Blvd KANSAS CITY, MO 64111 spur design.com		DATE 04/18/2017		CHECKED CHK		DRAWN DRW		DWG. 21 OF 52	

FULLY SPRINKLERED




Diagram illustrating the layout of a toilet stall. A central door is labeled "TOILET 2P169". Two side stalls are labeled "TOILET 2P168". A force  $F$  is applied to the central door handle.

The drawing consists of two parts. The left part is a side view of a door handle assembly. It shows a horizontal handle bar with a square grip. A vertical line labeled 'G' indicates the hinge side. The right part is a detail view of the handle profile, showing a curved shape with a circular feature labeled '05'.

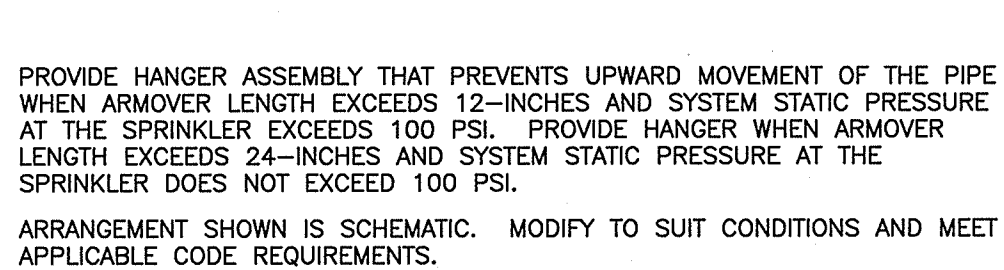

100

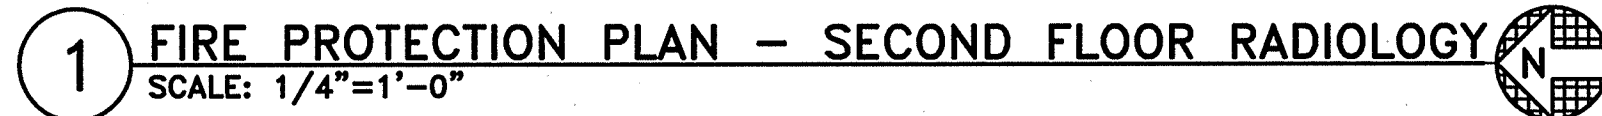

VA FORM 08-6231

**FULLY SPRINKLERED**