



three inches = one foot
one and one half inches = one foot
one inch = one foot
three quarters inch = one foot
one half inch = one foot
three eighths inch = one foot
one quarter inch = one foot
one eighth inch = one foot

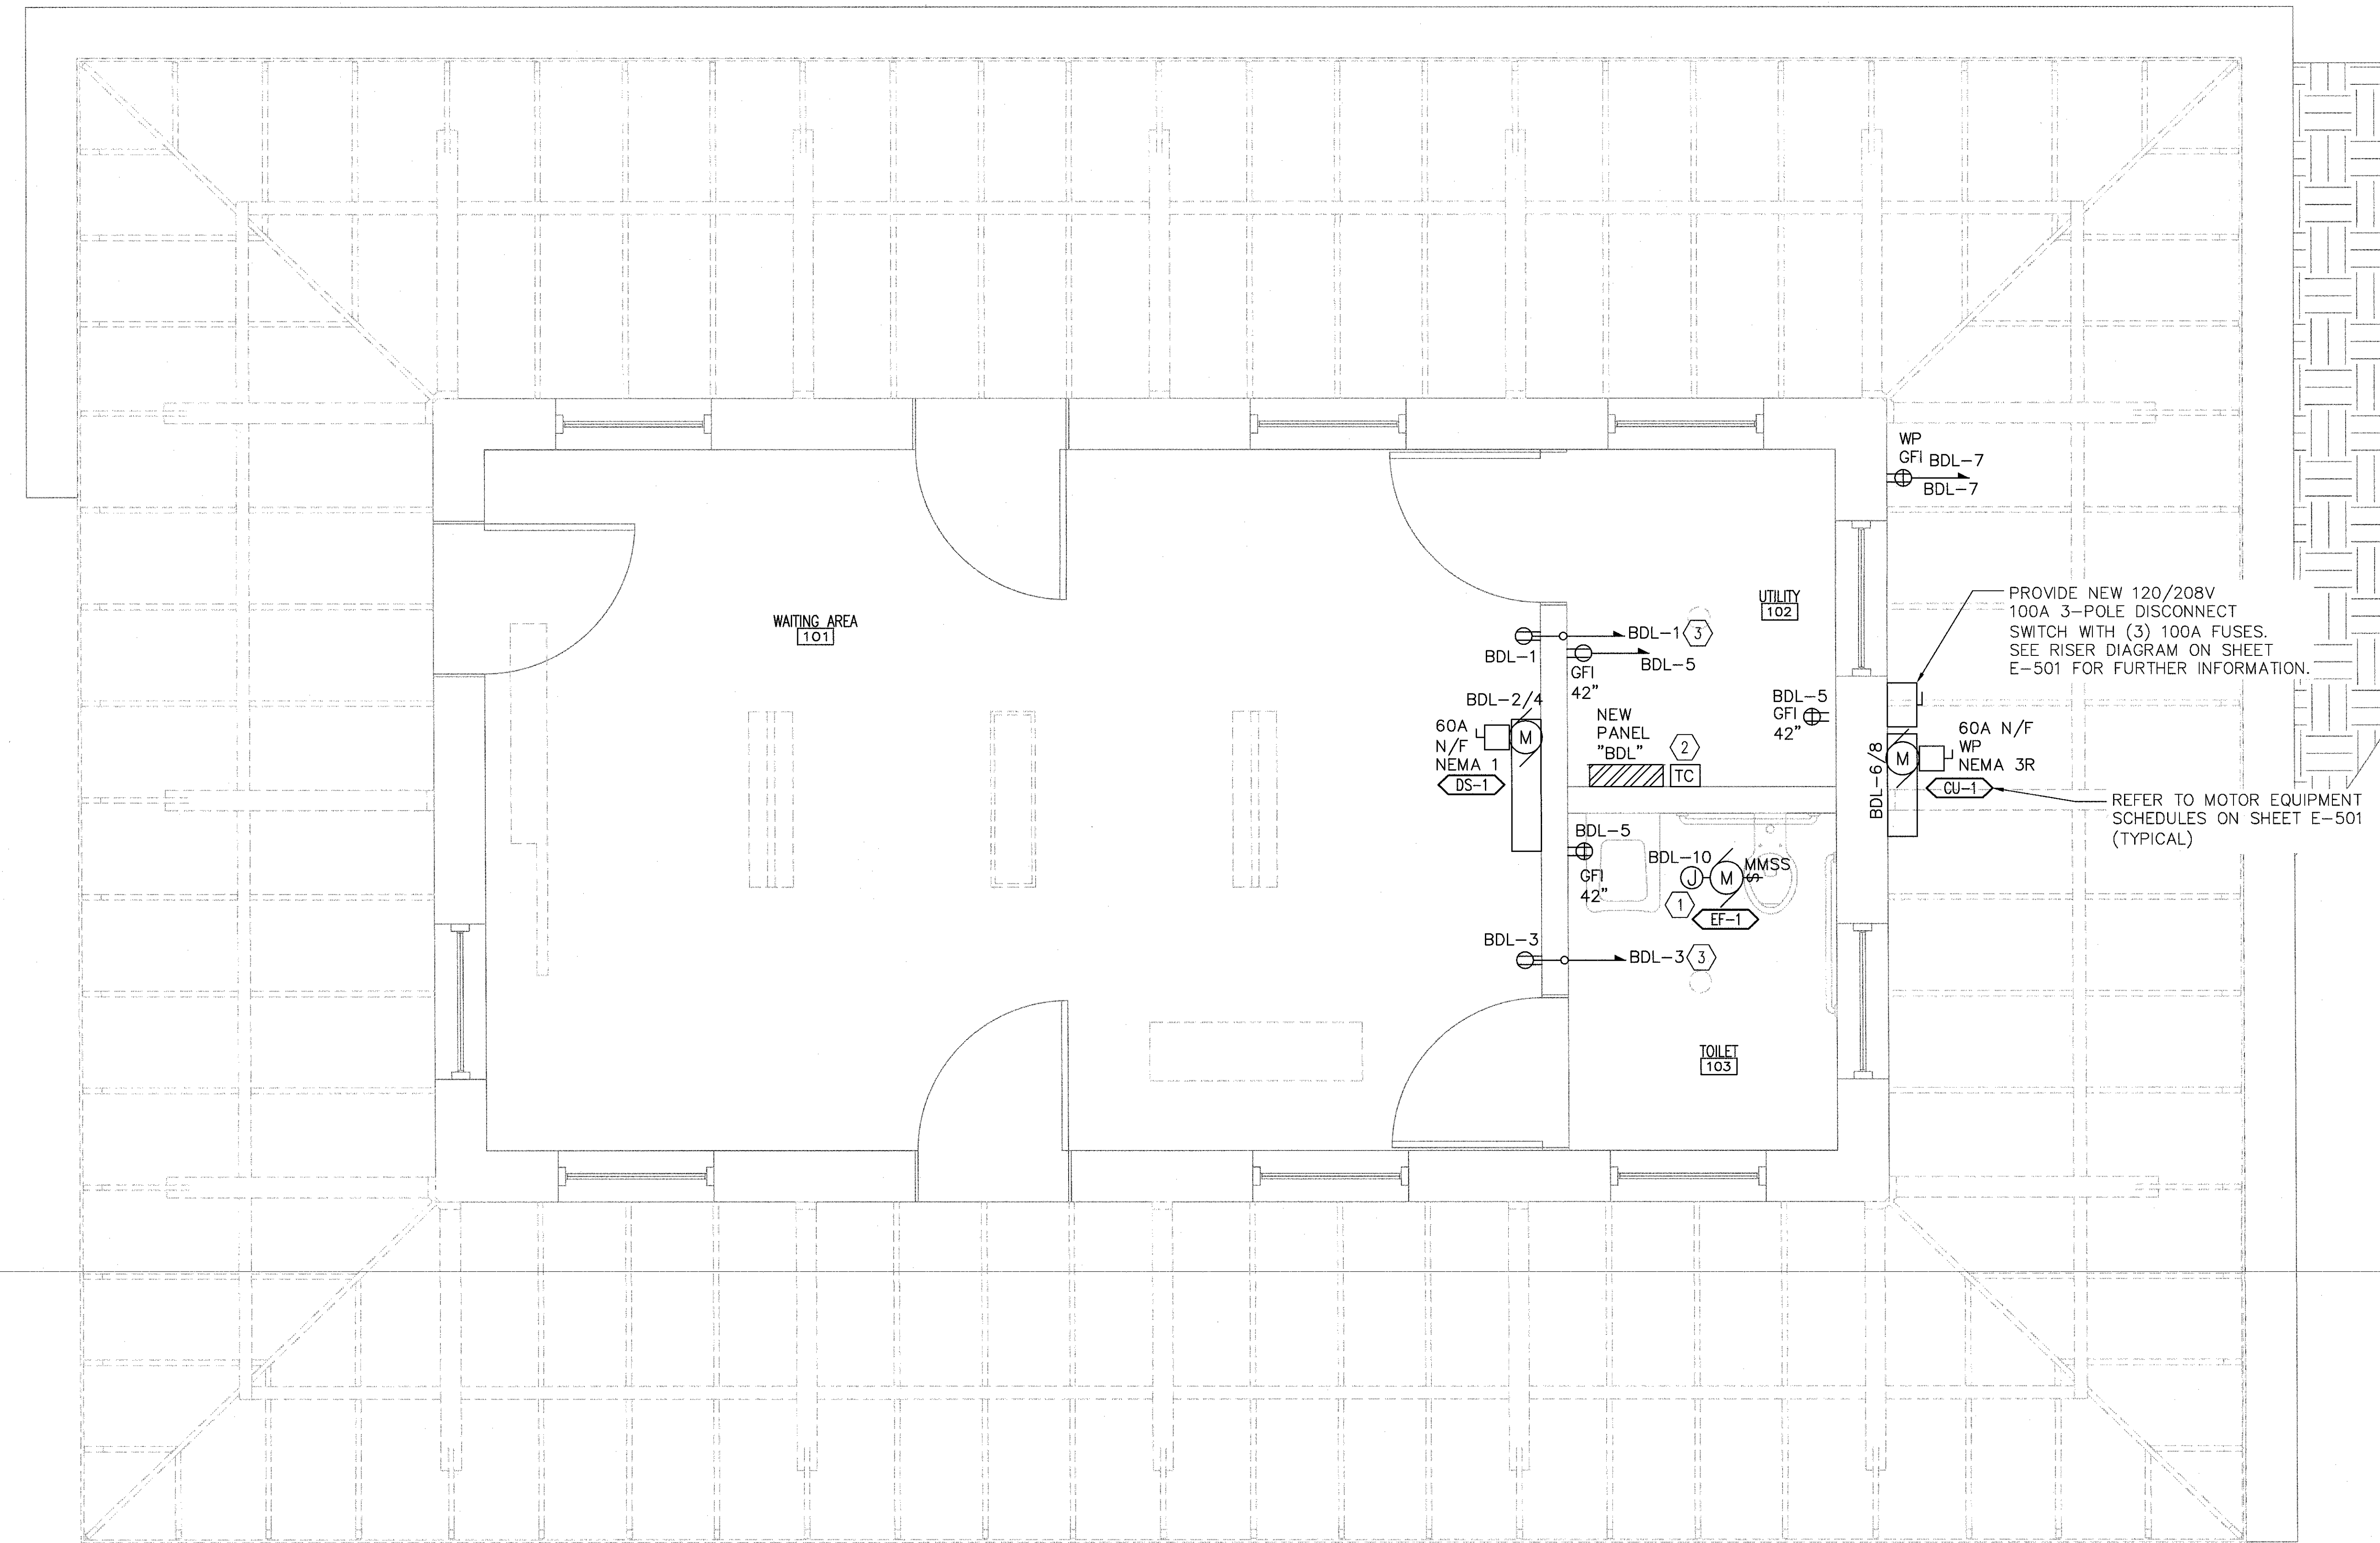

- GENERAL ELECTRICAL POWER PLAN NOTES**
- A. REFER TO E-001 FOR ELECTRICAL LEGEND, GENERAL NOTES, AND ABBREVIATIONS.
 - B. ALL RECEPTACLES SHALL BE INSTALLED AT 18" A.F.F. UNLESS NOTED OTHERWISE.
 - C. ALL CONDUITS TO BE CONCEALED WITHIN ALL WALLS UNLESS NOTED OTHERWISE.
 - D. ALL CONDUIT USED SHALL BE 3/4" MINIMUM.
 - E. BRANCH CIRCUITS SHALL BE CONNECTED TO NEW PANEL "BDL."
 - F. REFER TO SHEET E-501 FOR MOTOR EQUIPMENT SCHEDULE AND FURTHER INFORMATION.

- ELECTRICAL POWER PLAN NOTES**
- 1. PROVIDE JUNCTION BOX WITH 120 VOLT CONNECTION TO EXHAUST FAN AS INDICATED. FIELD COORDINATE EXACT LOCATION WITH MECHANICAL CONTRACTOR PRIOR TO INSTALLATION. PROVIDE MANUAL MOTOR STARTER SWITCH AS INDICATED.
 - 2. PROVIDE LIGHTING CONTACTOR AS INDICATED. CONTACTOR SHALL BE 120V COIL, 120V CONTACTS, 4-POLE, ELECTRICALLY HELD, IN NEMA 1 ENCLOSURE.
 - 3. ROUTE CIRCUIT DIRECTLY THROUGH WALL AND OVER TO ELECTRICAL PANEL "BDL" AS INDICATED, NO CONDUIT SHALL BE SHOWN IN WAITING ROOM NO. 101.

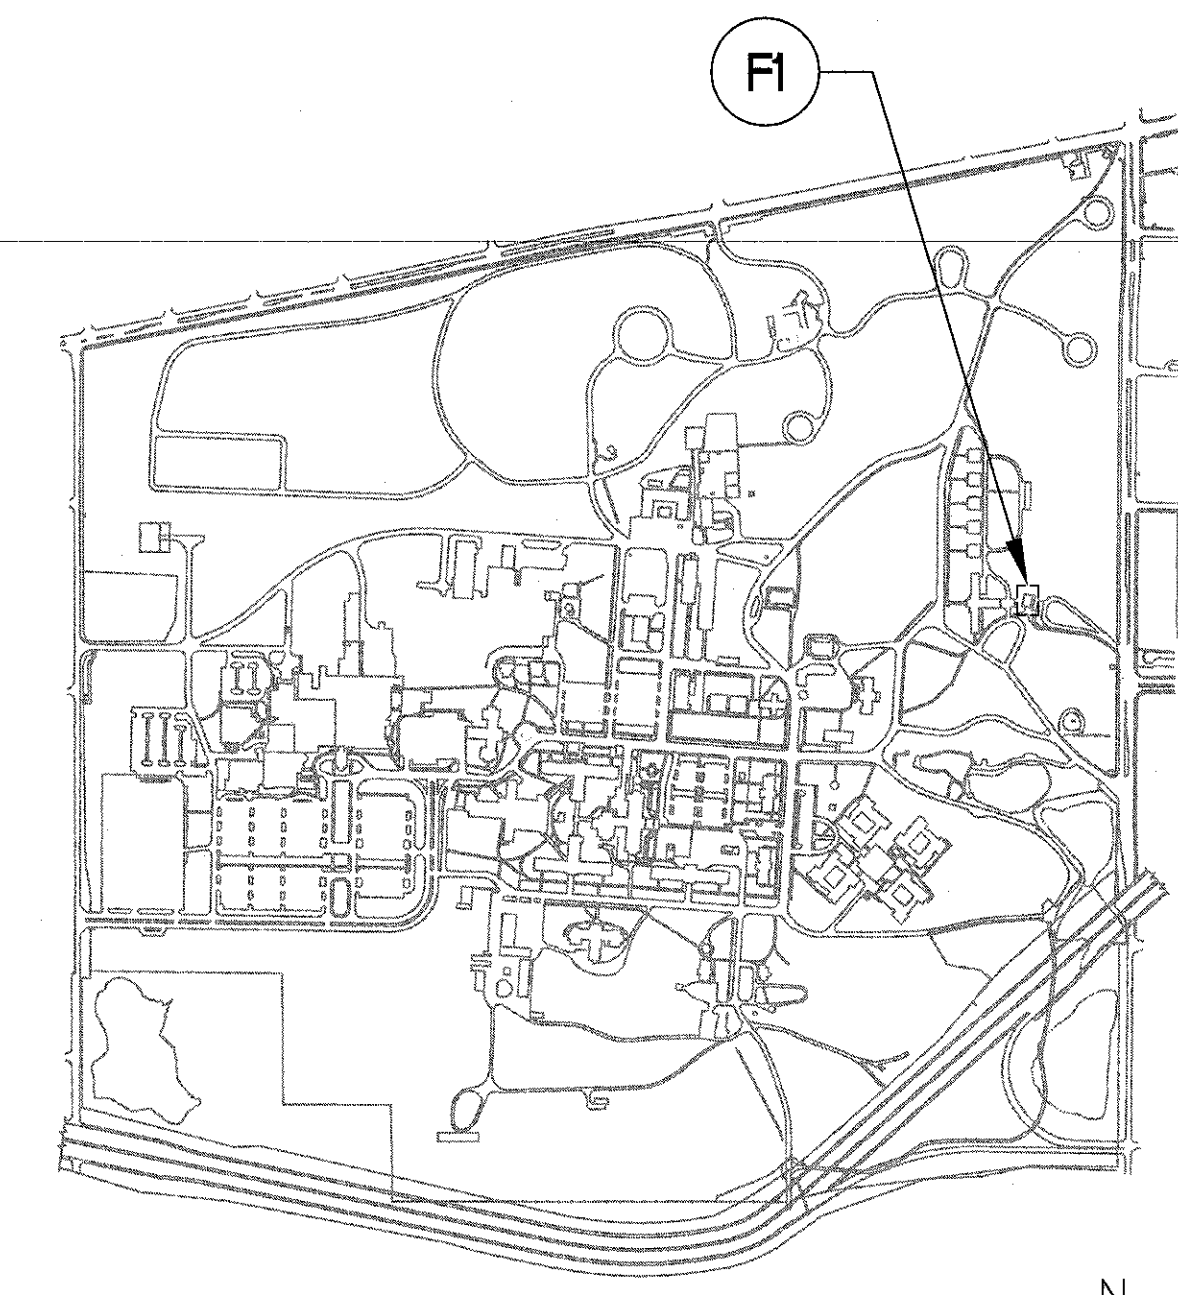

FI FLOOR PLAN
1/2" = 1'-0"

KEY PLAN - SITE
NTS

Revisions		CONSULTANTS:		ARCHITECT/ENGINEERS:		Drawing Title		Project Title		Project Number		Office of Construction and Facilities Management Department of Veterans Affairs	
				 Architecture Engineering Design-Build 200 Envy Circle #201, Louisville KY 40299 - PH: 502.339.8511 - www.paradigmusa.com		ELECTRICAL POWER PLAN BUILDING 105		IMPROVE CAMPUS ACCESS AND SECURITY		552-16-101			
										Building Number 105			
						Approved Project Director		Location DAYTON VA MEDICAL CENTER 400 W. THIRD STREET, DAYTON, OH 45429-9000		Drawing Number EP101			
								Date 04-07-2017		Checked WLM		Drawn MMF	