

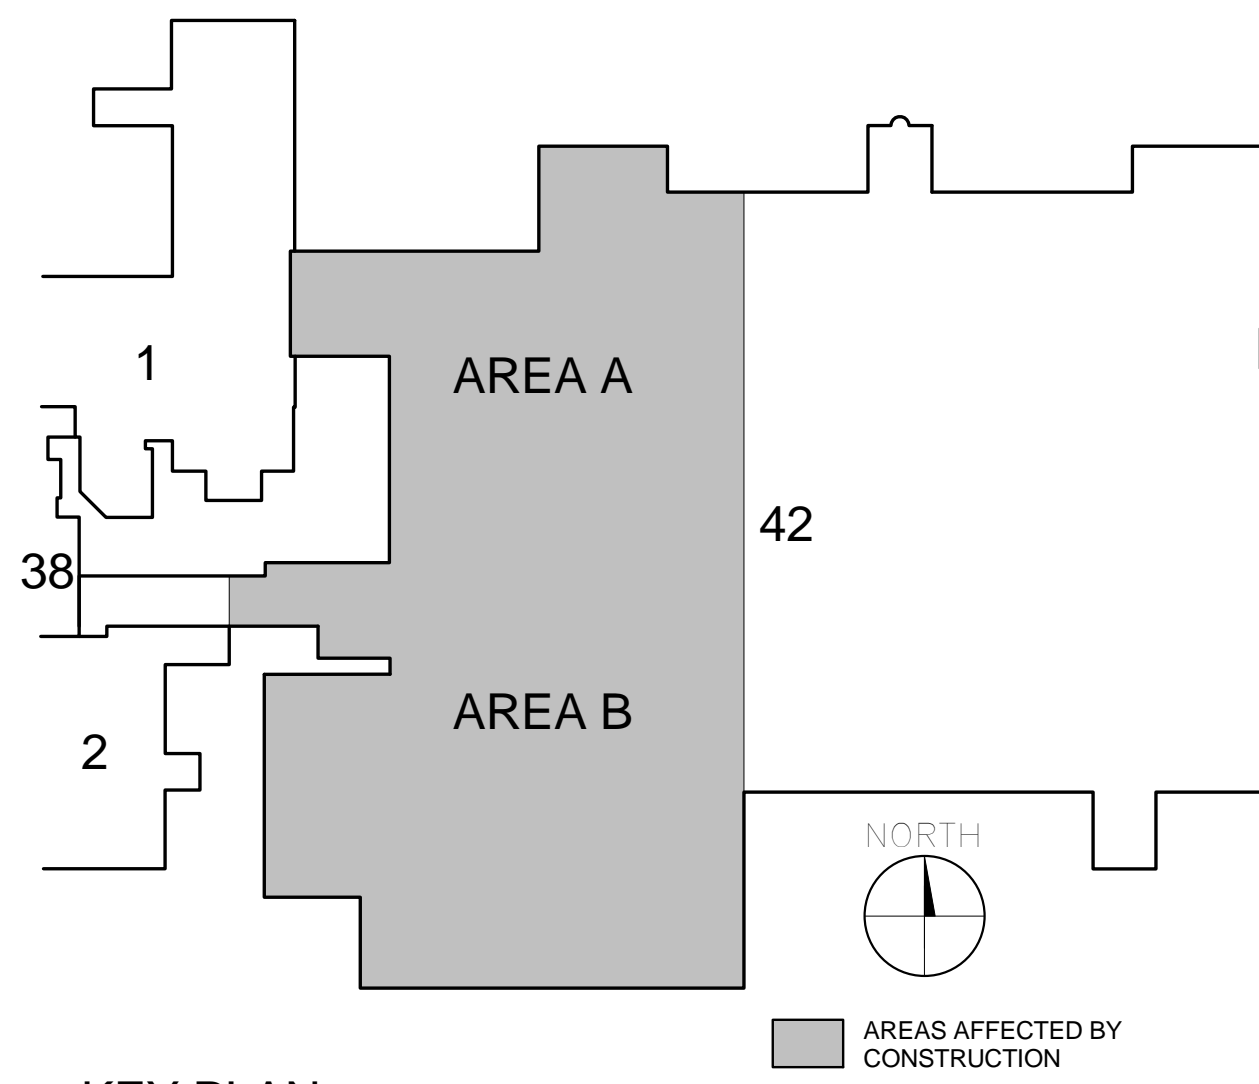


COORDINATION NOTE:
COORDINATE PHASING OF ALL STRUCTURAL CONSTRUCTION WITH OTHER
DISCIPLINES AS NECESSARY TO MAINTAIN AND PROTECT MEP EQUIPMENT AND LINES
IN SERVICE THROUGHOUT DURATION OF CONSTRUCTION. CONTRACTOR TO PROVIDE
COORDINATION/PHASING DOCUMENTS FOR APPROVAL BY THE COR.

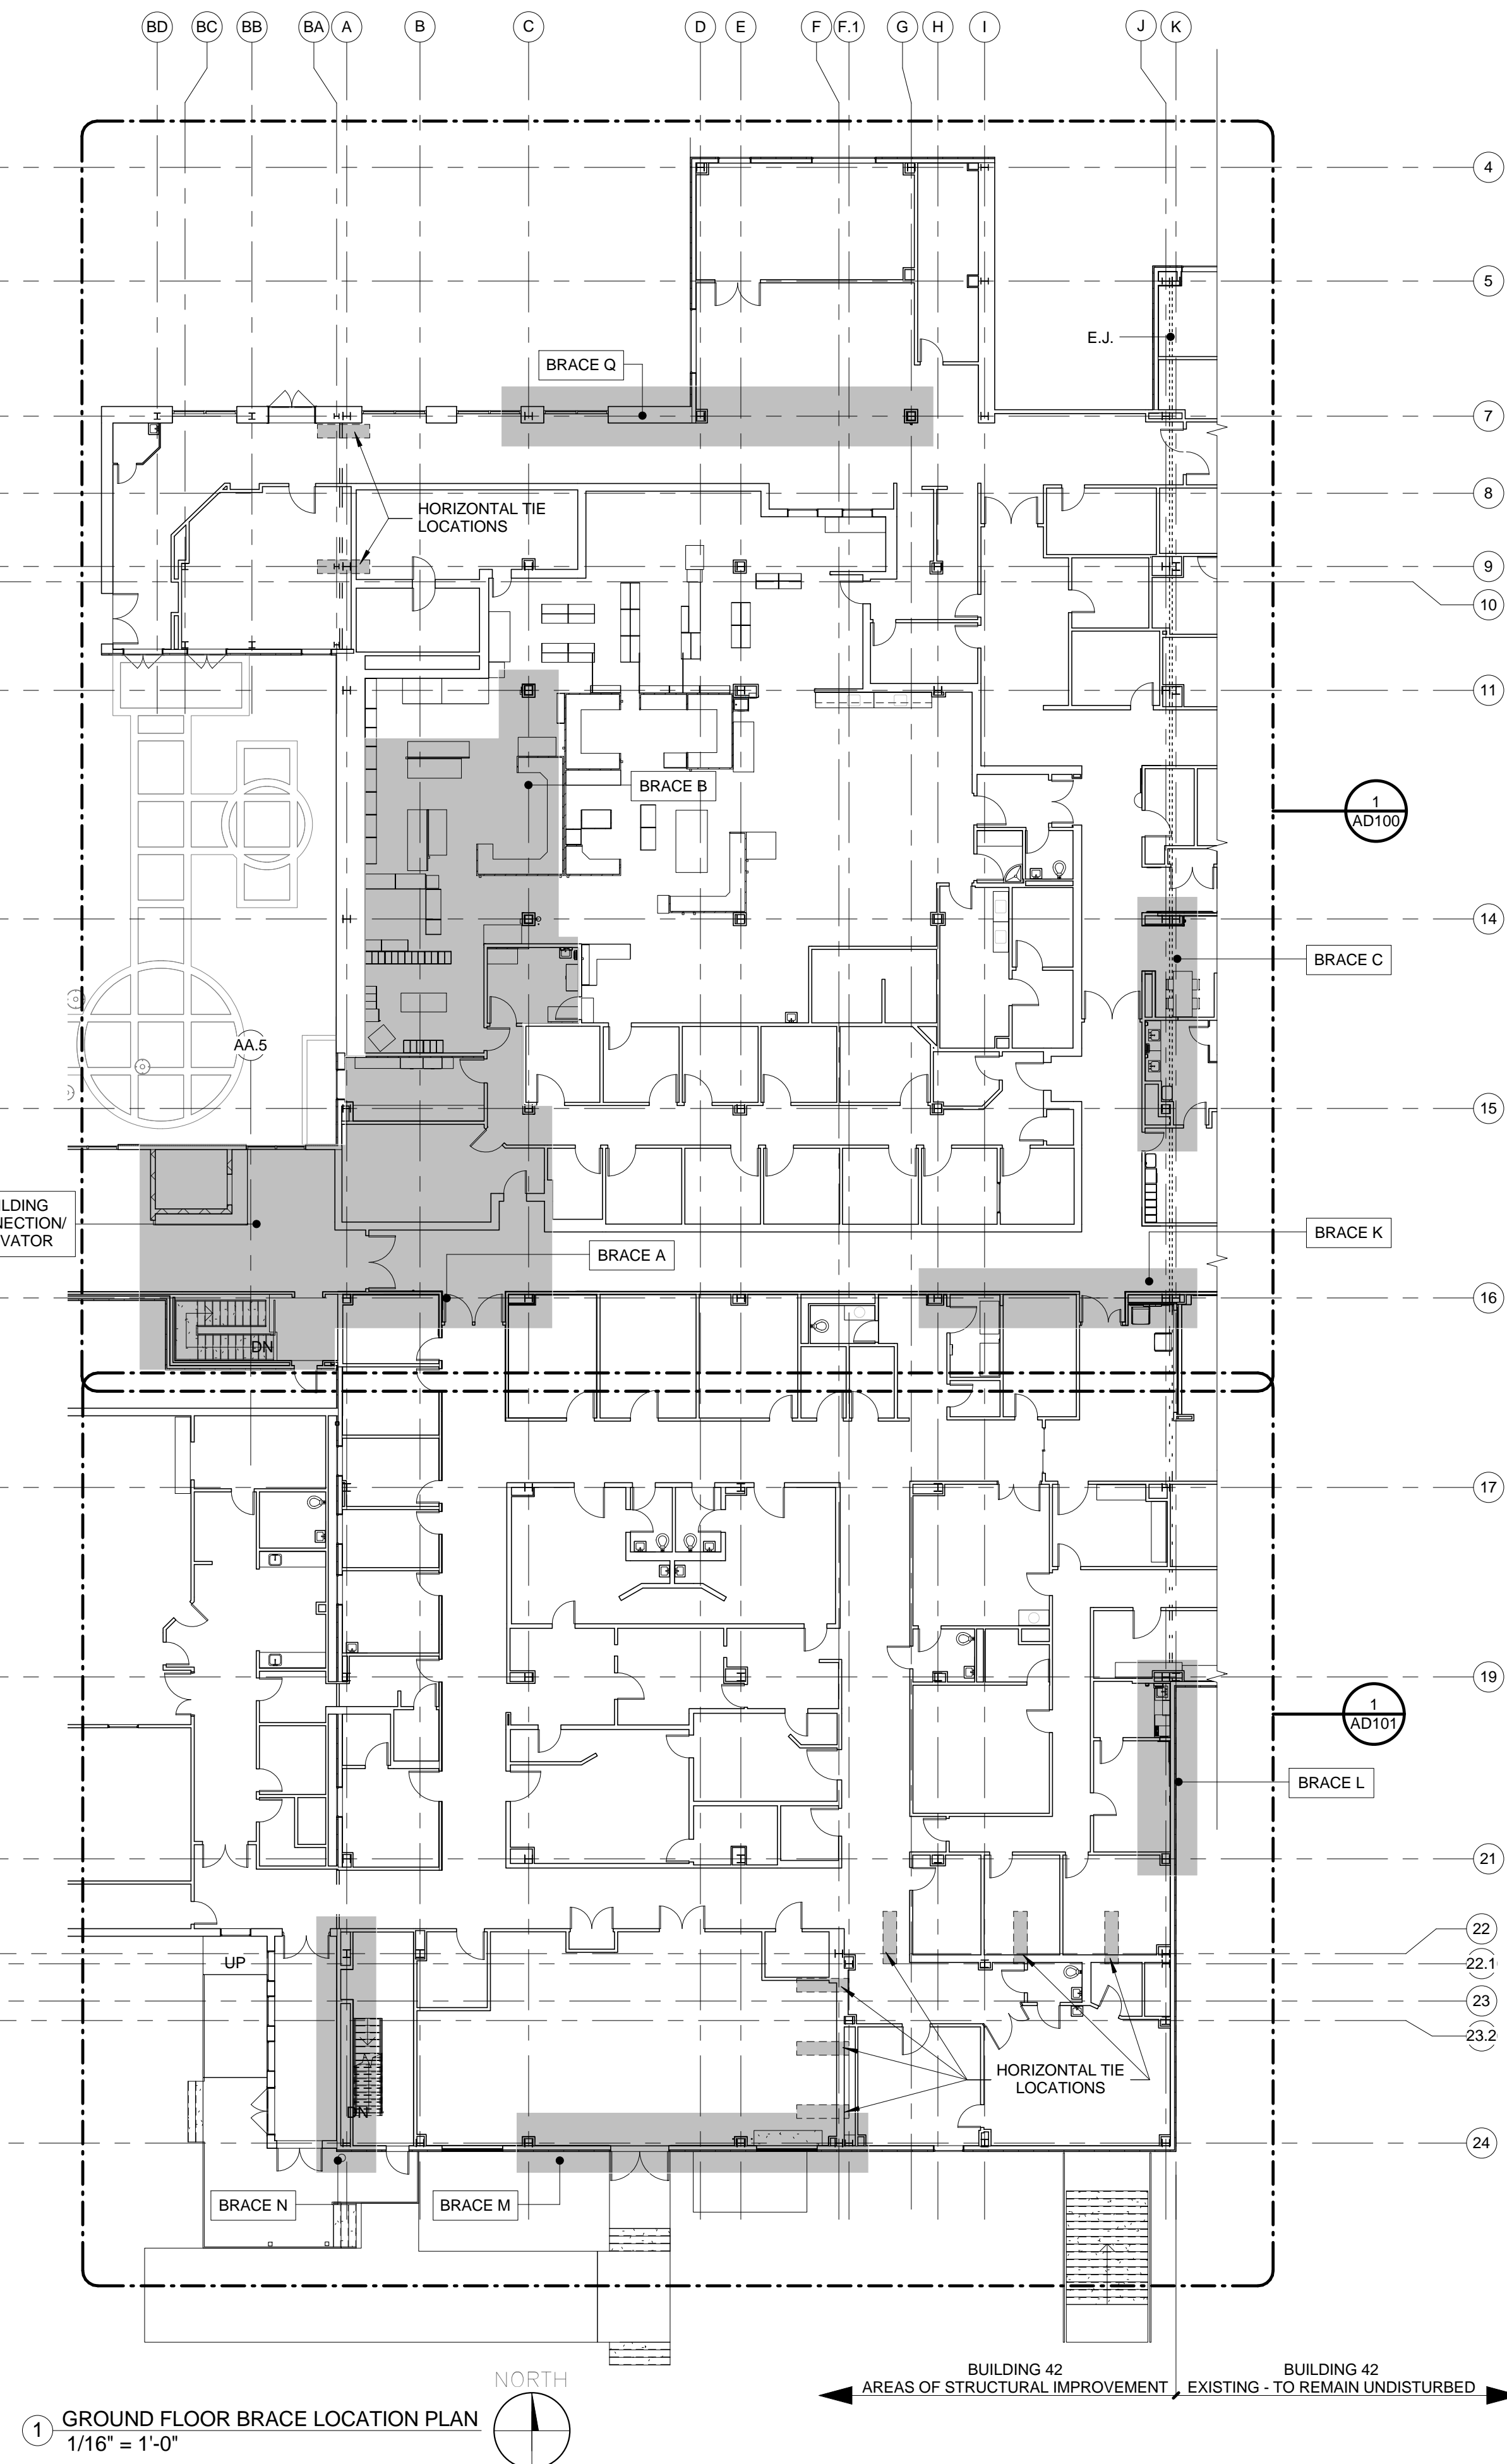

100% BID DOCUMENTS

Revisions:		Date	CONSULTANTS:		PROJECT MANAGER:		Office of Construction and Facilities Management		Drawing Title: EXISTING FLOOR PLAN		Project Title: ADD STRUCTURAL IMPROVEMENTS TO BUILDING 42		VA PROJECT NUMBER 657-343	
1			Baysinger Design Group, Inc.		Raleigh, NC Indianapolis, IN Pittsburgh, PA Virginia Beach, VA Fort Collins, CO		U.S. Department of Veterans Affairs		MARION VAMC MARION, IL, 62959		Approved: Project Director		Building Number 42	
2			AMERICAN STRUCTUREPOINT INC.		7260 Shadeland Station, Indianapolis, IN 46256 Tel: 317.543.5580 Fax: 317.543.8270 www.structurepoint.com		VA		Date 09/06/17		Checked HKG		Drawn MNH	
3			Expires 11-30-18		Project Number 16-198		Scale AS INDICATED		Location		Drawing Number AD001		Dwg. 36 of 81	

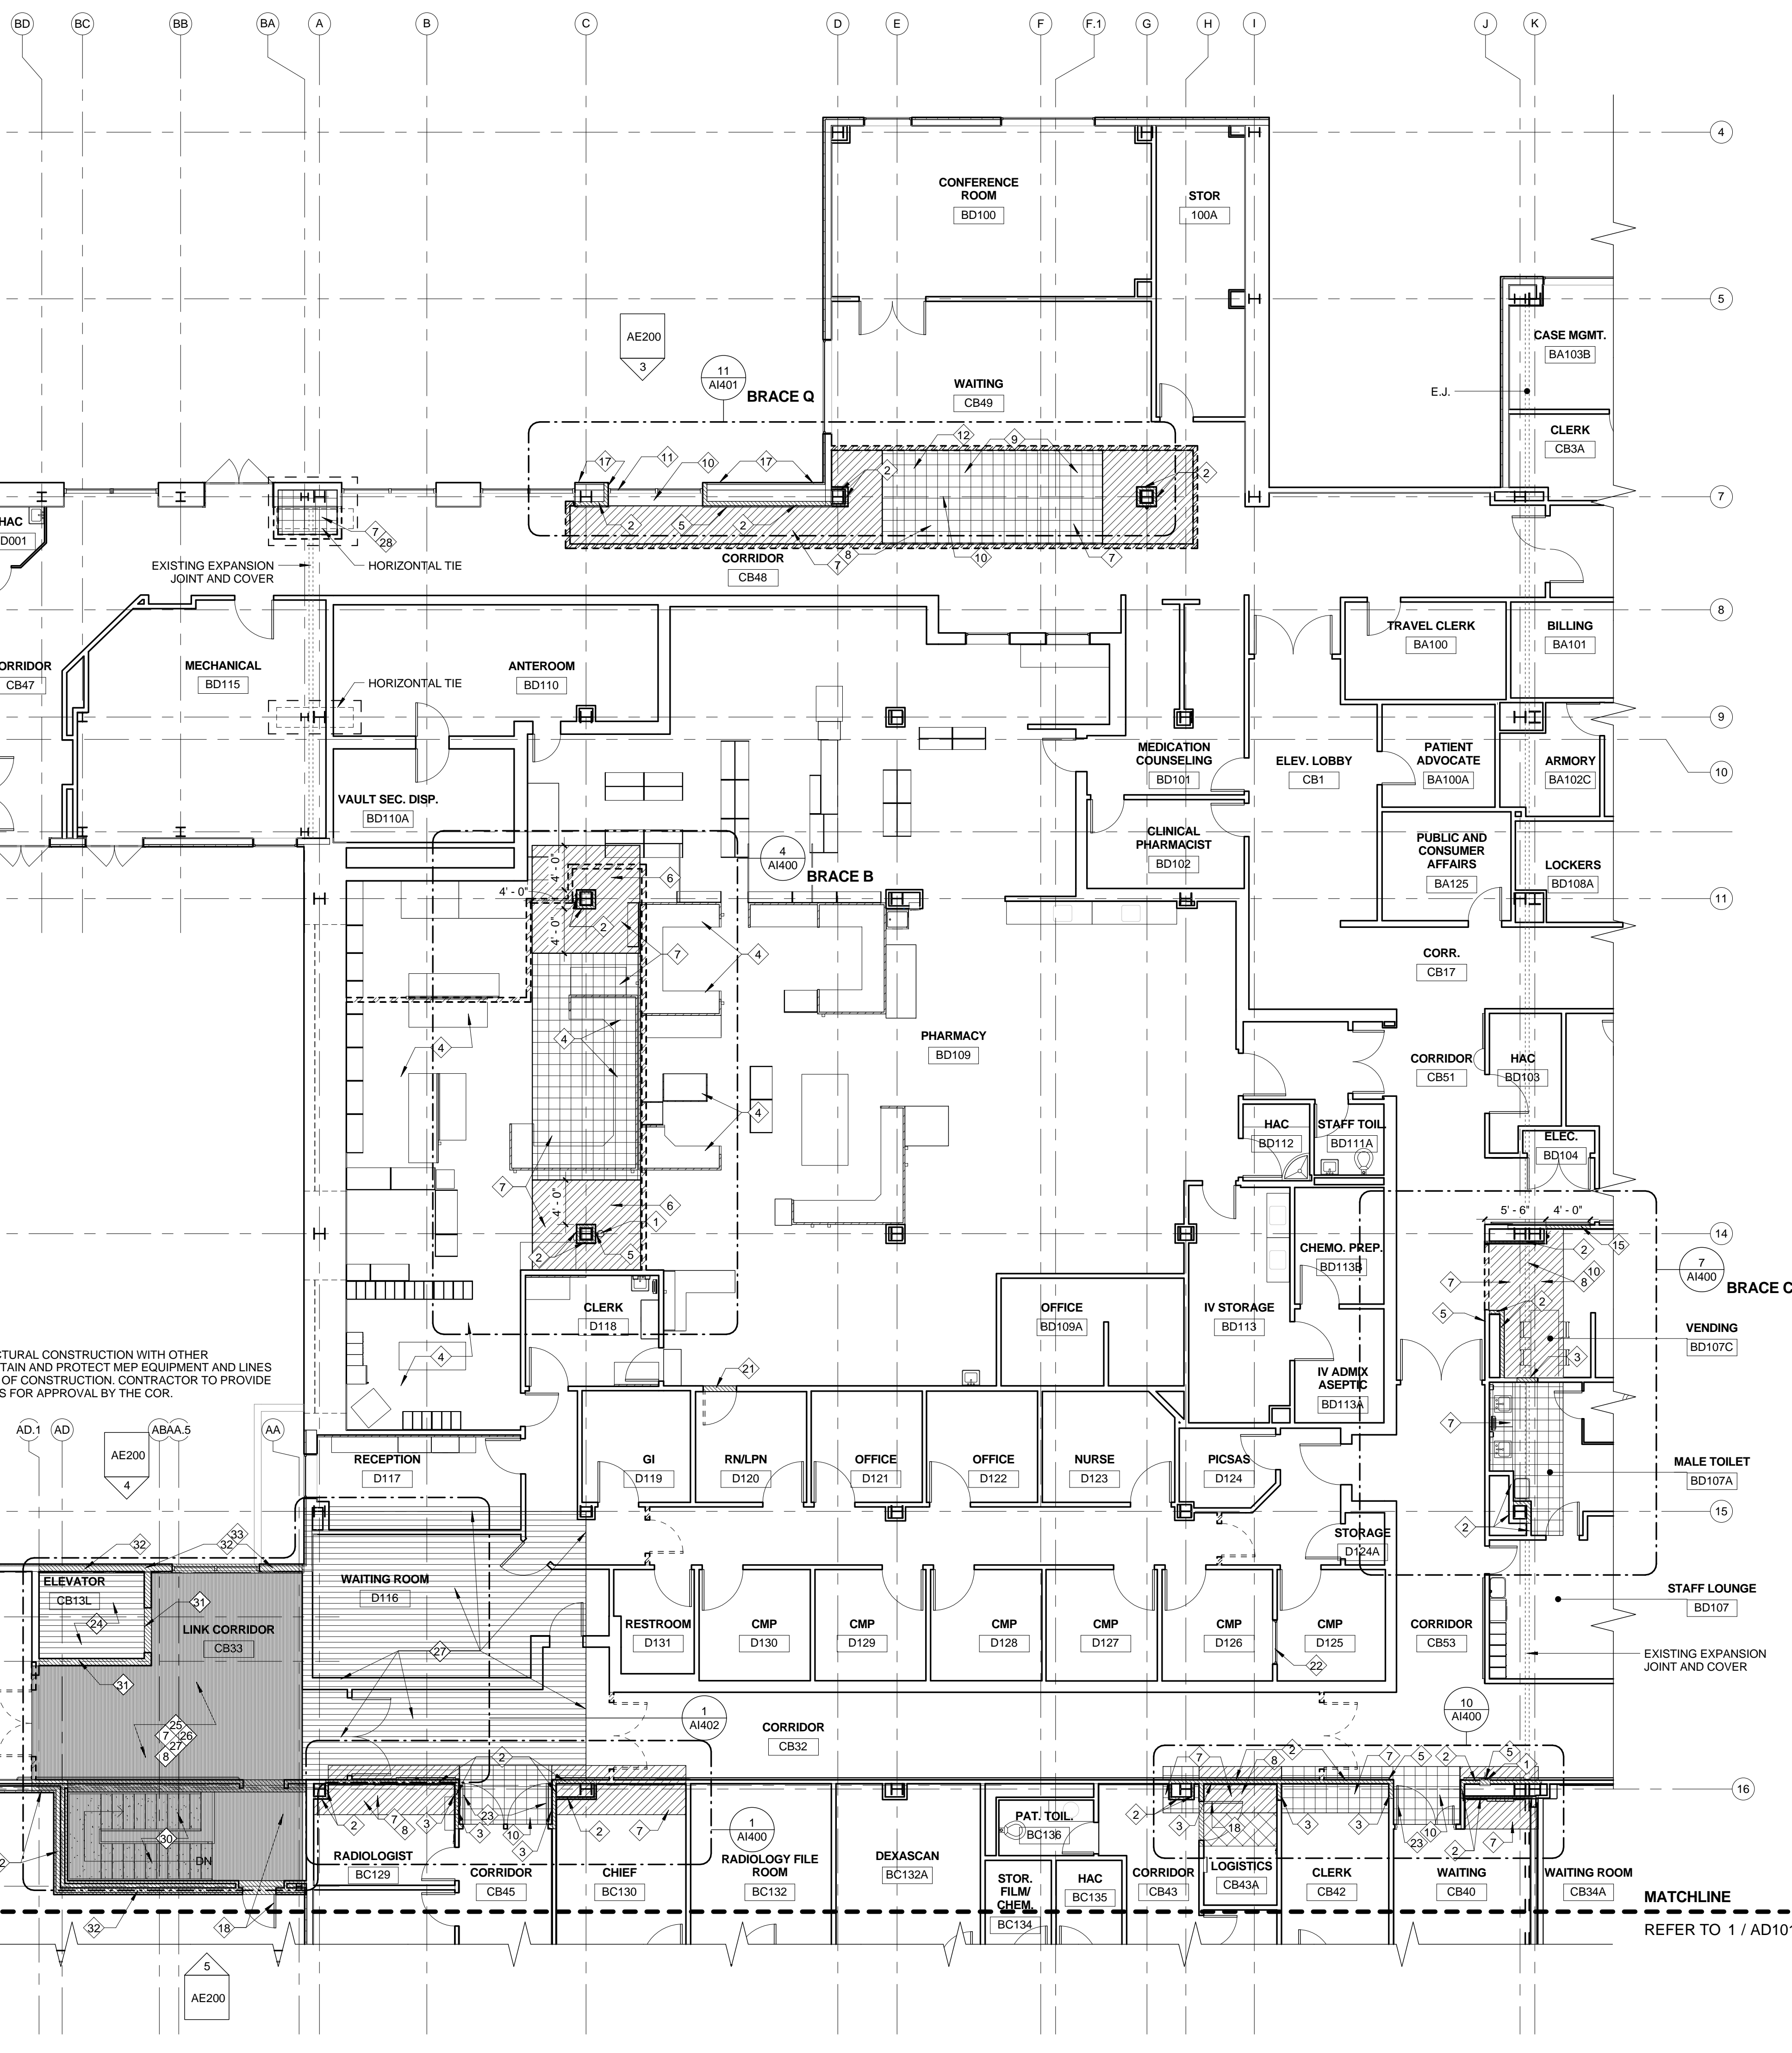

- FINISH NOTES**
- IN SOME LOCATIONS WHERE BRACING IS TO BE INSTALLED, IT IS ASSUMED THAT ALL FINISH WORK ASSOCIATED WITH BRACE INSTALLATION WILL OCCUR ABOVE THE CEILING. SPECIFICALLY, THIS IS ANTICIPATED AT THE FOLLOWING LOCATIONS:
- BC130
- DOOR ALCOVE BETWEEN CB32 AND CB45
- BD107A
- CB42
 - THE EXISTING FINISH OF THE EAST WALL OF CORRIDOR 100 IS GYPSUM BOARD ASSUMED TO BE INSTALLED OVER METAL FURRING STUDS AND AN EXISTING EXTERIOR WALL.
 - IT IS INTENDED FOR THE CONTRACTOR TO SALVAGE THE EXISTING WALL PROTECTION (HANDRAILS/BUMPER GUARDS) FOR REINSTALLATION. IN THE EVENT THAT WALL PROTECTION IS DAMAGED DURING CONSTRUCTION, CONTRACTOR SHALL REPLACE THE WALL PROTECTION TO THE EXTENT NECESSARY TO PROVIDE ONE CONTINUOUS, MATCHING GUARD FOR THE LENGTH OF THE ENTIRE RUN.

LEGEND: DEMOLITION FLOOR PLAN


- AREAS OF WALL DEMO
- AREAS OF FLOOR DEMO
- AREAS OF CEILING REMOVAL
- AREAS OF FLOOR DEMO & CEILING REMOVAL
- TEMPORARY PARTITION/BARRIER, RE: PHASING AND INFECTION CONTROL PLAN.
- TEMPORARY PARTITION/BARRIER AND DOOR, RE: PHASING AND INFECTION CONTROL PLAN.
- AREAS OF FLOOR SLAB, FLOOR DECK, ROOF SLAB, ROOF DECK, ROOF SYSTEM, AND JOIST AND BEAM REMOVAL, COORDINATE WITH STRUCTURAL.
- AREAS OF ROOF SLAB, ROOF DECK, JOIST AND BEAM, AND ROOFING SYSTEM REMOVAL. COORDINATE WITH STRUCTURAL.

KEYED NOTES - APPLY TO SHEETS AD100 & AD101 ONLY

- REMOVE EXISTING FIRE EXTINGUISHER AND ALL ASSOCIATED HARDWARE. SALVAGE FOR REINSTALLATION.
- REMOVE AND LEGALLY DISPOSE OF EXISTING GYPSUM BOARD AND METAL STUD PARTITION IN ITS ENTIRETY. REMOVAL INCLUDES WALL BOARD, WALL BASE, CORNER GUARDS AND WALL PROTECTION. SIGNAGE, AND METAL STUD FRAMING. COORDINATE WITH OTHER TRADES FOR REMOVAL OF ADDITIONAL WALL MOUNTED ELEMENTS. SALVAGE INTERIOR SIGNAGE FOR REINSTALLATION.
- REMOVE AND LEGALLY DISPOSE OF PORTIONS OF EXISTING GYPSUM BOARD AND METAL STUD PARTITION TO EXTENT NECESSARY TO PERFORM STRUCTURAL IMPROVEMENTS. REMOVE INCLUDES WALL BASE, CORNER GUARDS, WALL PROTECTION, SIGNAGE AND METAL STUD FRAMING. SALVAGE INTERIOR SIGNAGE FOR REINSTALLATION. COORDINATE WITH OTHER TRADES FOR REMOVAL OF ADDITIONAL WALL MOUNTED ELEMENTS.
- REMOVE SYSTEMS FURNITURE COMPONENTS INCLUDING ALL PANELS, WORK SURFACES, STORAGE COMPONENTS, AND HARDWARE. SALVAGE FOR REINSTALLATION.
- REMOVE EXISTING INTERIOR SIGNAGE AND SALVAGE FOR REINSTALLATION.
- CUT AND MODIFY EXISTING HEAT-WELDED SHEET VINYL FLOORING TO EXTENTS NECESSARY TO PERFORM STRUCTURAL IMPROVEMENTS. PROTECT SUBSTRATE DURING CONSTRUCTION ACTIVITIES AND PREPARE FOR INSTALLATION OF NEW HEAT-WELDED SHEET VINYL FLOORING.
- REMOVE AND LEGALLY DISPOSE OF EXISTING 2x4 CEILING AND GRID TO EXTENTS SHOWN. PROTECT REMAINING CONSTRUCTION AND PREPARE FOR INSTALLATION AND TIE-IN OF NEW 2x4 CEILING AND GRID.
- CUT AND REMOVE EXISTING VCT FLOORING TO EXTENTS NECESSARY TO PERFORM STRUCTURAL IMPROVEMENTS. PROTECT SUBSTRATE DURING CONSTRUCTION ACTIVITIES AND PREPARE FOR INSTALLATION OF NEW VCT FLOORING.
- CUT AND REMOVE EXISTING CARPET FLOORING TO EXTENTS NECESSARY TO PERFORM STRUCTURAL IMPROVEMENTS. PROTECT SUBSTRATE DURING CONSTRUCTION ACTIVITIES AND PREPARE FOR INSTALLATION OF CARPET FLOORING.
- REMOVE AND LEGALLY DISPOSE OF EXISTING BULKHEAD/SOFFIT CONSTRUCTION TO EXTENTS NECESSARY TO PERFORM STRUCTURAL IMPROVEMENTS.
- REMOVE EXISTING STOREFRONT WINDOW SYSTEM IN ITS ENTIRETY. PROVIDE TEMPORARY SHORING/WEATHERPROOFING UNTIL STRUCTURAL MODIFICATIONS ARE COMPLETE.
- REMOVE AND SALVAGE EXISTING 2x2 PATTERNED CEILING AND REMOVE AND LEGALLY DISPOSE OF GRID TO EXTENTS SHOWN. PROTECT REMAINING CONSTRUCTION AND PREPARE FOR INSTALLATION AND TIE-IN OF NEW 2x2 GRID AND SALVAGED CEILING TIE.
- REMOVE AND LEGALLY DISPOSE OF PORTIONS OF EXISTING GYPSUM BOARD FROM INDICATED SIDE OF EXISTING PARTITION TO EXTENTS NECESSARY TO PERFORM STRUCTURAL IMPROVEMENTS. EXISTING METAL STUDS TO REMAIN. REMOVAL INCLUDES WALL BOARD, WALL BASE, CORNER GUARDS AND WALL PROTECTION. SIGNAGE, COORDINATE WITH OTHER TRADES FOR REMOVAL OF ADDITIONAL WALL ELEMENTS. BRACE MAY BE INSTALLED OVER GYPSUM BOARD AT BRACE M LOCATION.
- REMOVE PORTIONS OF EXISTING CHAINLINK FENCE TO THE EXTENT NECESSARY TO PERFORM STRUCTURAL IMPROVEMENTS. REMOVAL INCLUDES CHAINLINK, POSTS, VINYL FENCE SLATS, ETC.
- REMOVE AND LEGALLY DISPOSE OF EXISTING GYPSUM BOARD AND METAL STUD PARTITION AS INDICATED TO CREATE NEW 4'-0" WIDE CASED OPENING.
- REMOVE EXISTING BASE CABINETS, WORK SURFACE, WALL CABINETS, ICE MAKER, ETC. COORDINATE WITH OTHER TRADES FOR REMOVAL OF ADDITIONAL WALL MOUNTED ELEMENTS. SALVAGE FOR REINSTALLATION.
- REMOVE AND LEGALLY DISPOSE OF PORTIONS OF EXISTING EXTERIOR CONSTRUCTION TO EXTENTS NECESSARY TO PERFORM STRUCTURAL IMPROVEMENTS. REMOVAL INCLUDES EXTERIOR INSULATION FINISH SYSTEM, METAL STUD FRAMING, GYPSUM WALL BOARD, AND ALL ASSOCIATED WALL MOUNTED ITEMS. COORDINATE WITH OTHER TRADES FOR REMOVAL OF ADDITIONAL WALL MOUNTED ELEMENTS.
- REMOVE EXISTING HOLLOW METAL DOOR, FRAME, AND HARDWARE. SALVAGE FOR REINSTALLATION.
- REMOVE EXISTING PROJECTION SCREEN AND SALVAGE FOR REINSTALLATION.
- REMOVE EXISTING INDUSTRIAL METAL PAN STAIRS INCLUDING ALL ASSOCIATED RAILING AND HARDWARE AND SALVAGE FOR REINSTALLATION.
- REMOVE PORTION OF EXISTING WALL CONSTRUCTION TO INSTALL NEW TEMPORARY DOOR AND FRAME AS INDICATED. WALL CONSTRUCTION CONSISTS OF WALL BOARD, METAL STUDS, EXPANDED METAL MESH, WALL BASE, ETC. RESTORE ADJACENT CONSTRUCTION TO EXISTING CONDITION AFTER WINDOW REMOVAL. RE: PHASING PLANS.
- REMOVE PORTION OF EXISTING WALL CONSTRUCTION TO INSTALL NEW TEMPORARY WINDOW AND FRAME AS INDICATED. WALL CONSTRUCTION CONSISTS OF WALL BOARD, METAL STUDS, EXPANDED METAL MESH, WALL BASE, ETC. RESTORE ADJACENT CONSTRUCTION TO EXISTING CONDITION AFTER WINDOW REMOVAL. RE: PHASING PLANS.
- REMOVE DOOR(S), FRAME, AND WALL AT BRACE A AND K LOCATIONS. SALVAGE DOOR, FRAME, AND HARDWARE FOR REINSTALLATION. WHERE EXISTING DOOR IS ACCESS CONTROLLED, DISCONNECT AND RECONNECT ALL POWER OPERATED HARDWARE AS REQUIRED TO RESTORE FUNCTION TO ACCESS CONTROLS.
- REMOVE EXISTING HYDRAULIC ELEVATOR IN ITS ENTIRETY, INCLUDING BUT NOT LIMITED TO ELEVATOR, ELEVATOR SHAFT, EQUIPMENT, AND SUPPORTS, ETC.
- SAW CUT AND REMOVE EXISTING CONCRETE FLOOR SLAB AND METAL FLOOR DECK IN THEIR ENTIRETY WHERE INDICATED. COORDINATE WITH STRUCTURAL DRAWINGS FOR REMOVAL OF EXISTING STRUCTURAL COMPONENTS AT THESE AREAS. SHORE REMAINING STRUCTURE UNTIL NEW STRUCTURAL COMPONENTS, FLOOR DECKING, AND CONCRETE SLAB HAVE BEEN INSTALLED AND CURED TO SUPPORT PERMANENT LOADS.
- EXISTING STRUCTURE AND ROOFING SYSTEM TO BE REMOVED ABOVE INDICATED AREA. RE: ROOF PLAN AND STRUCTURAL DRAWINGS FOR ADDITIONAL INFORMATION. SHORE ADJACENT REMAINING STRUCTURE UNTIL NEW STRUCTURAL COMPONENTS AND ROOF DECK HAVE BEEN INSTALLED.
- IN AREAS OF ROOF SYSTEM AND STRUCTURE REMOVAL: REMOVE EXISTING SUSPENDED ACOUSTICAL CEILING SYSTEM IN ITS ENTIRETY. AT CONTRACTOR'S OPTION, REMOVE EXISTING METAL STUD AND GYPSUM BOARD PARTITIONS, WALL MOUNTED EQUIPMENT, AND REMAINING INTERIOR FINISHES IN THEIR ENTIRETY OR REMOVE AFOREMENTIONED ITEMS ONLY TO THE EXTENT REQUIRED TO COMPLETE THE STRUCTURAL UPGRADES. UPON COMPLETION OF THE IMPROVEMENTS, CONTRACTOR SHALL REBUILD OR RESTORE SPACES TO EXISTING CONDITION. BUILDING SYSTEMS/SERVICES TRANSITING THE AREA SHALL REMAIN IN OPERATION AND BE PROTECTED DURING THE DURATION OF CONSTRUCTION. COORDINATE WITH PLUMBING, MECHANICAL, ELECTRICAL DRAWINGS FOR ADDITIONAL BUILDING SYSTEMS/SERVICES WORK.
- REMOVE AND LEGALLY DISPOSE OF PORTIONS OF EXISTING METAL STUD AND GYPSUM BOARD PARTITIONS AS REQUIRED TO INSTALL STRUCTURAL HORIZONTAL TIES.
- REMOVE ONE LEAF OF EXISTING DOUBLE DOORS AND SALVAGE FOR REINSTALLATION. REPLACE REMOVED LEAF WITH TEMPORARY LOUVER PER MECHANICAL DRAWINGS. UPON COMPLETION OF STRUCTURAL IMPROVEMENTS, REMOVE TEMPORARY LOUVER AND REINSTALL SALVAGED DOOR LEAF RE: MECHANICAL DRAWINGS.
- REMOVE EXISTING METAL PAN STAIRS WITH CONCRETE TREADS AND ALL ASSOCIATED RAILINGS AND SALVAGE FOR REINSTALLATION.
- REMOVE AND LEGALLY DISPOSE OF EXISTING ELEVATOR SHAFTWALL IN ITS ENTIRETY. REMOVAL INCLUDES CMU, METAL FURRING, GYPSUM BOARD, WALL BASE, ETC. EXISTING WEST CMU SHAFTWALL SHALL REMAIN.
- REMOVE AND LEGALLY DISPOSE OF EXISTING EXTERIOR WALL CONSTRUCTION IN ITS ENTIRETY. REMOVAL INCLUDES EXTERIOR INSULATION FINISH SYSTEM, METAL STUD FRAMING, CMU, GYPSUM WALL BOARD, INTERIOR FINISHES AND ALL ASSOCIATED WALL MOUNTED ITEMS, METAL COPING CAPS, AND PARAPET FRAMING, ETC. EXISTING FOUNDATION WALL AND STRUCTURAL STEEL FRAMING TO REMAIN U.N.O. COORDINATE WITH STRUCTURAL REQUIREMENTS.
- REMOVE EXISTING STOREFRONT WINDOW SYSTEM IN ITS ENTIRETY AND SALVAGE FOR REINSTALLATION.

COORDINATION NOTE:
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MATCHLINE
REFER TO 1 / AD101 FOR CONTINUATION.

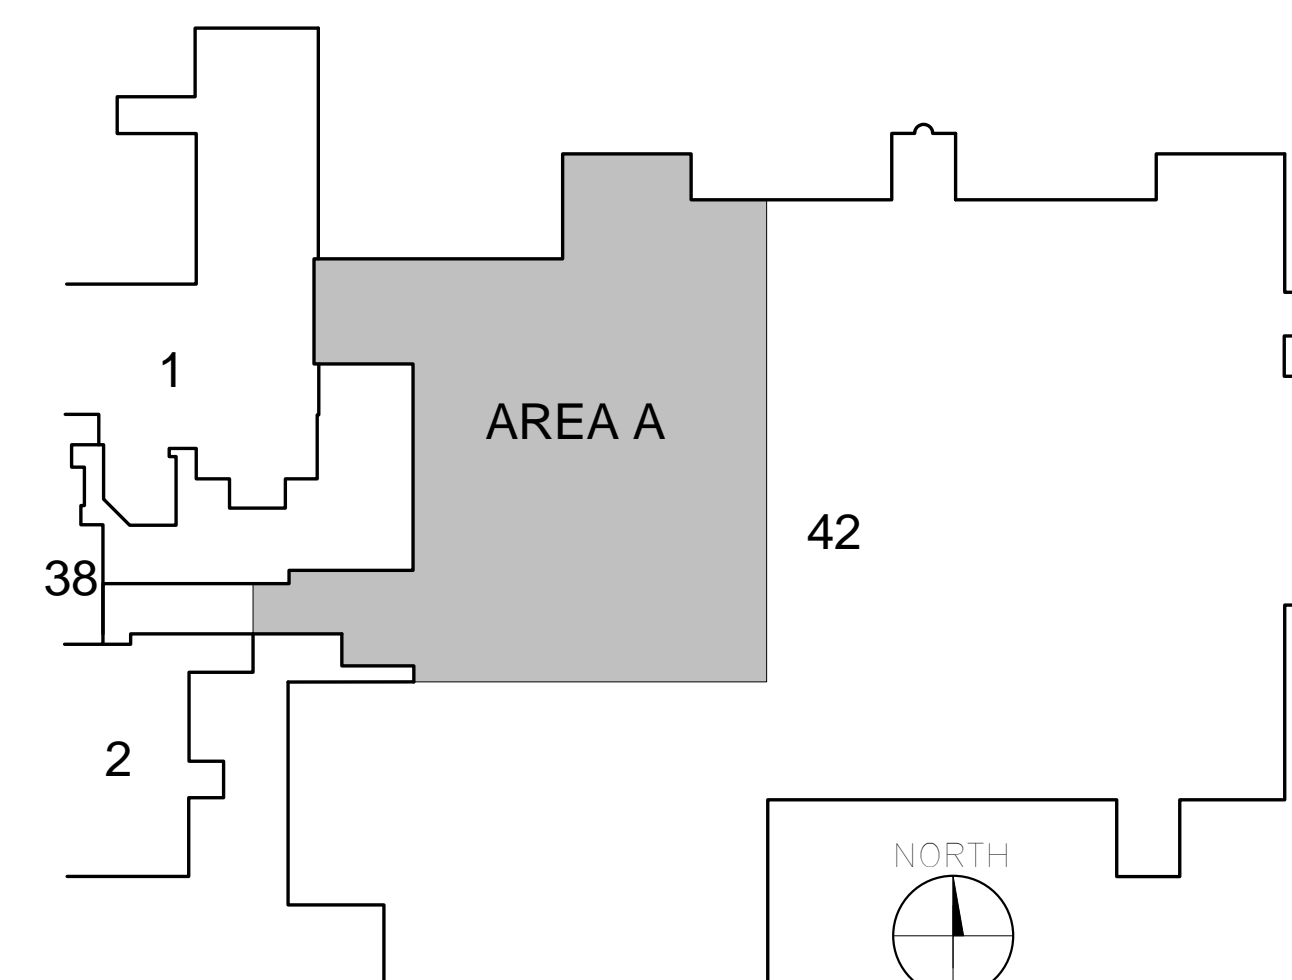

KEY PLAN

AREAS AFFECTED BY CONSTRUCTION

100% BID DOCUMENTS

CONSULTANTS:

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STRUCTUREPOINT INC.
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www.structurepoint.com



PROJECT MANAGER:

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Consulting Group
Engineers / Architects
www.apogee-gc.com
919-858-7420

Raleigh, NC
Indianapolis, IN
Pittsburgh, PA
Virginia Beach, VA
Fort Collins, CO

Project Number 16-198
Scale AS INDICATED

Office of
Construction
and Facilities
Management



Drawing Title:
GROUND FLOOR AREA A FLOOR PLAN - DEMOLITION

Location

**MARION VAMC
MARION, IL, 62959**

Project Title:
**ADD STRUCTURAL
IMPROVEMENTS TO BUILDING
42**

Approved: Project Director

Date 09/06/17

Checked HKG

Drawn MNH


VA PROJECT NUMBER 657-343

Building Number 42

Drawing Number

AD100

Dwg. 37 of 81

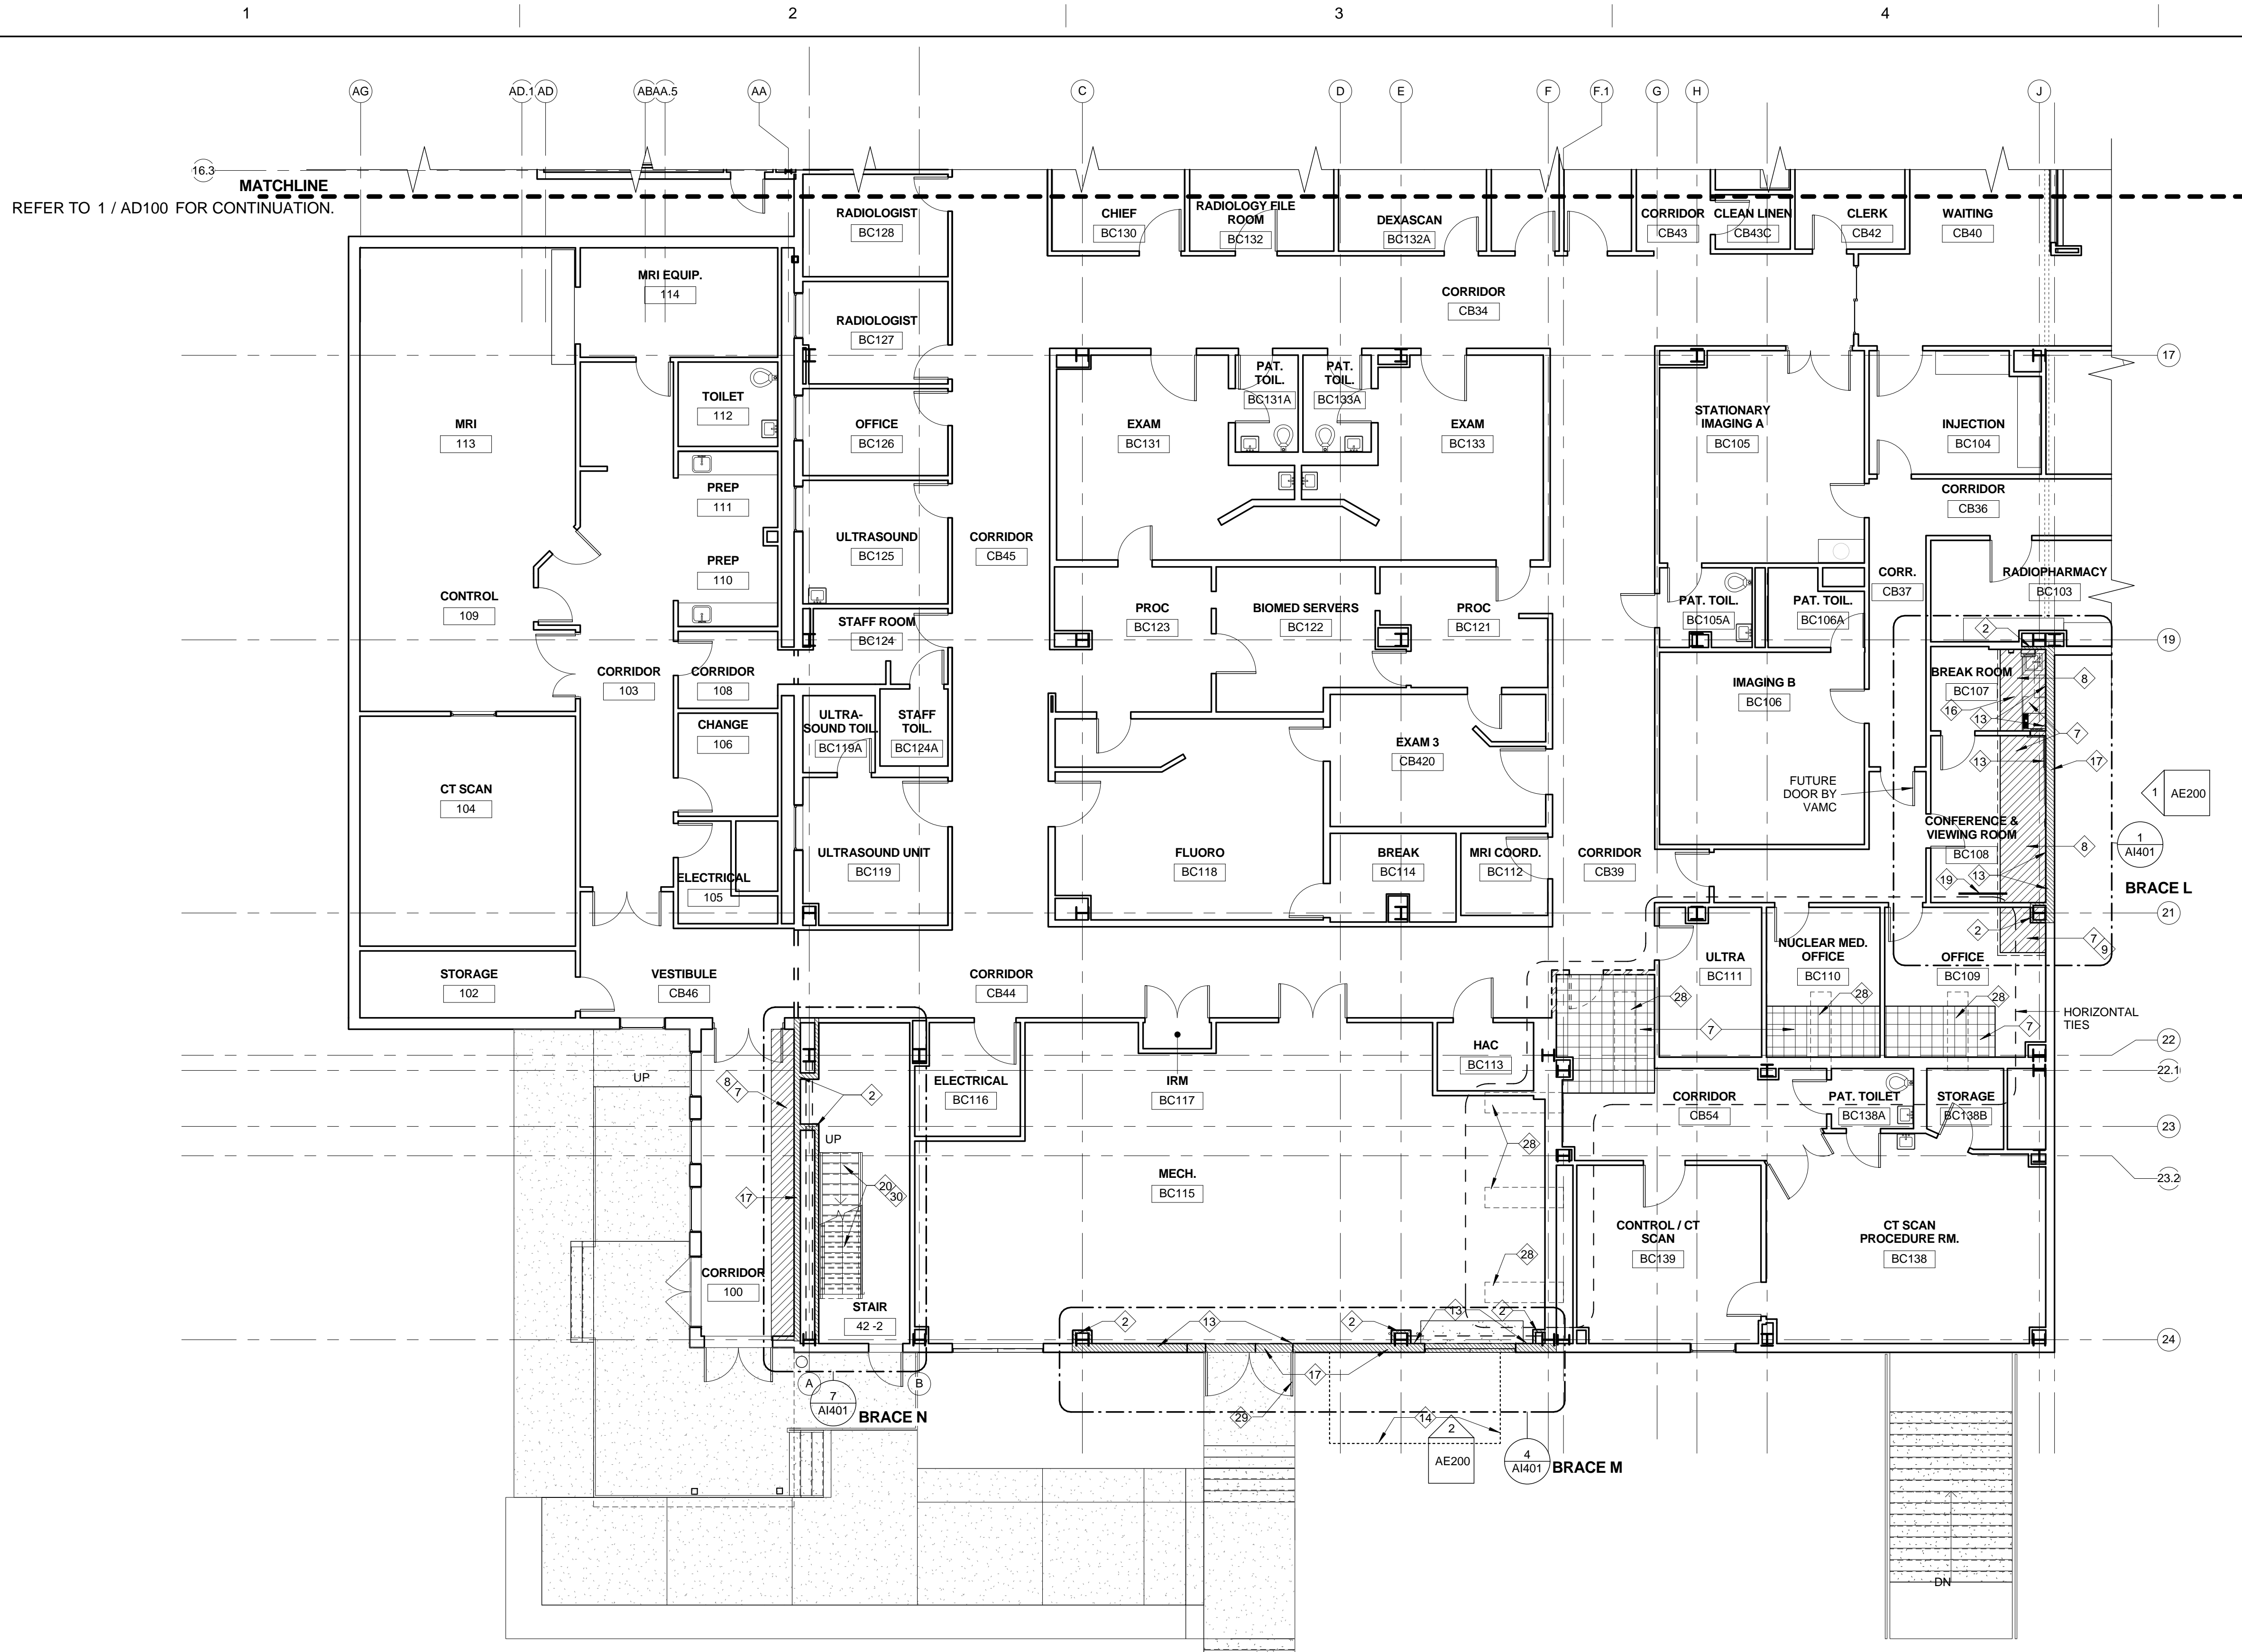

1 GROUND FLOOR AREA B FLOOR PLAN - DEMOLITION
1/8" = 1'-0"


- ### FINISH NOTES
1. IN SOME LOCATIONS WHERE BRACING IS TO BE INSTALLED, IT IS ASSUMED THAT ALL FINISH WORK ASSOCIATED WITH BRACE INSTALLATION WILL OCCUR ABOVE THE CEILING. SPECIFICALLY, THIS IS ANTICIPATED AT THE FOLLOWING LOCATIONS:
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- ### LEGEND: DEMOLITION FLOOR PLAN
- AREAS OF WALL DEMO
 - AREAS OF FLOOR DEMO
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 - TEMPORARY PARTITION/BARRIER, RE: PHASING AND INFECTION CONTROL PLAN.
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 - AREAS OF FLOOR SLAB, FLOOR DECK, ROOF SLAB, ROOF DECK, ROOF SYSTEM, AND JOIST AND BEAM REMOVAL. COORDINATE WITH STRUCTURAL.
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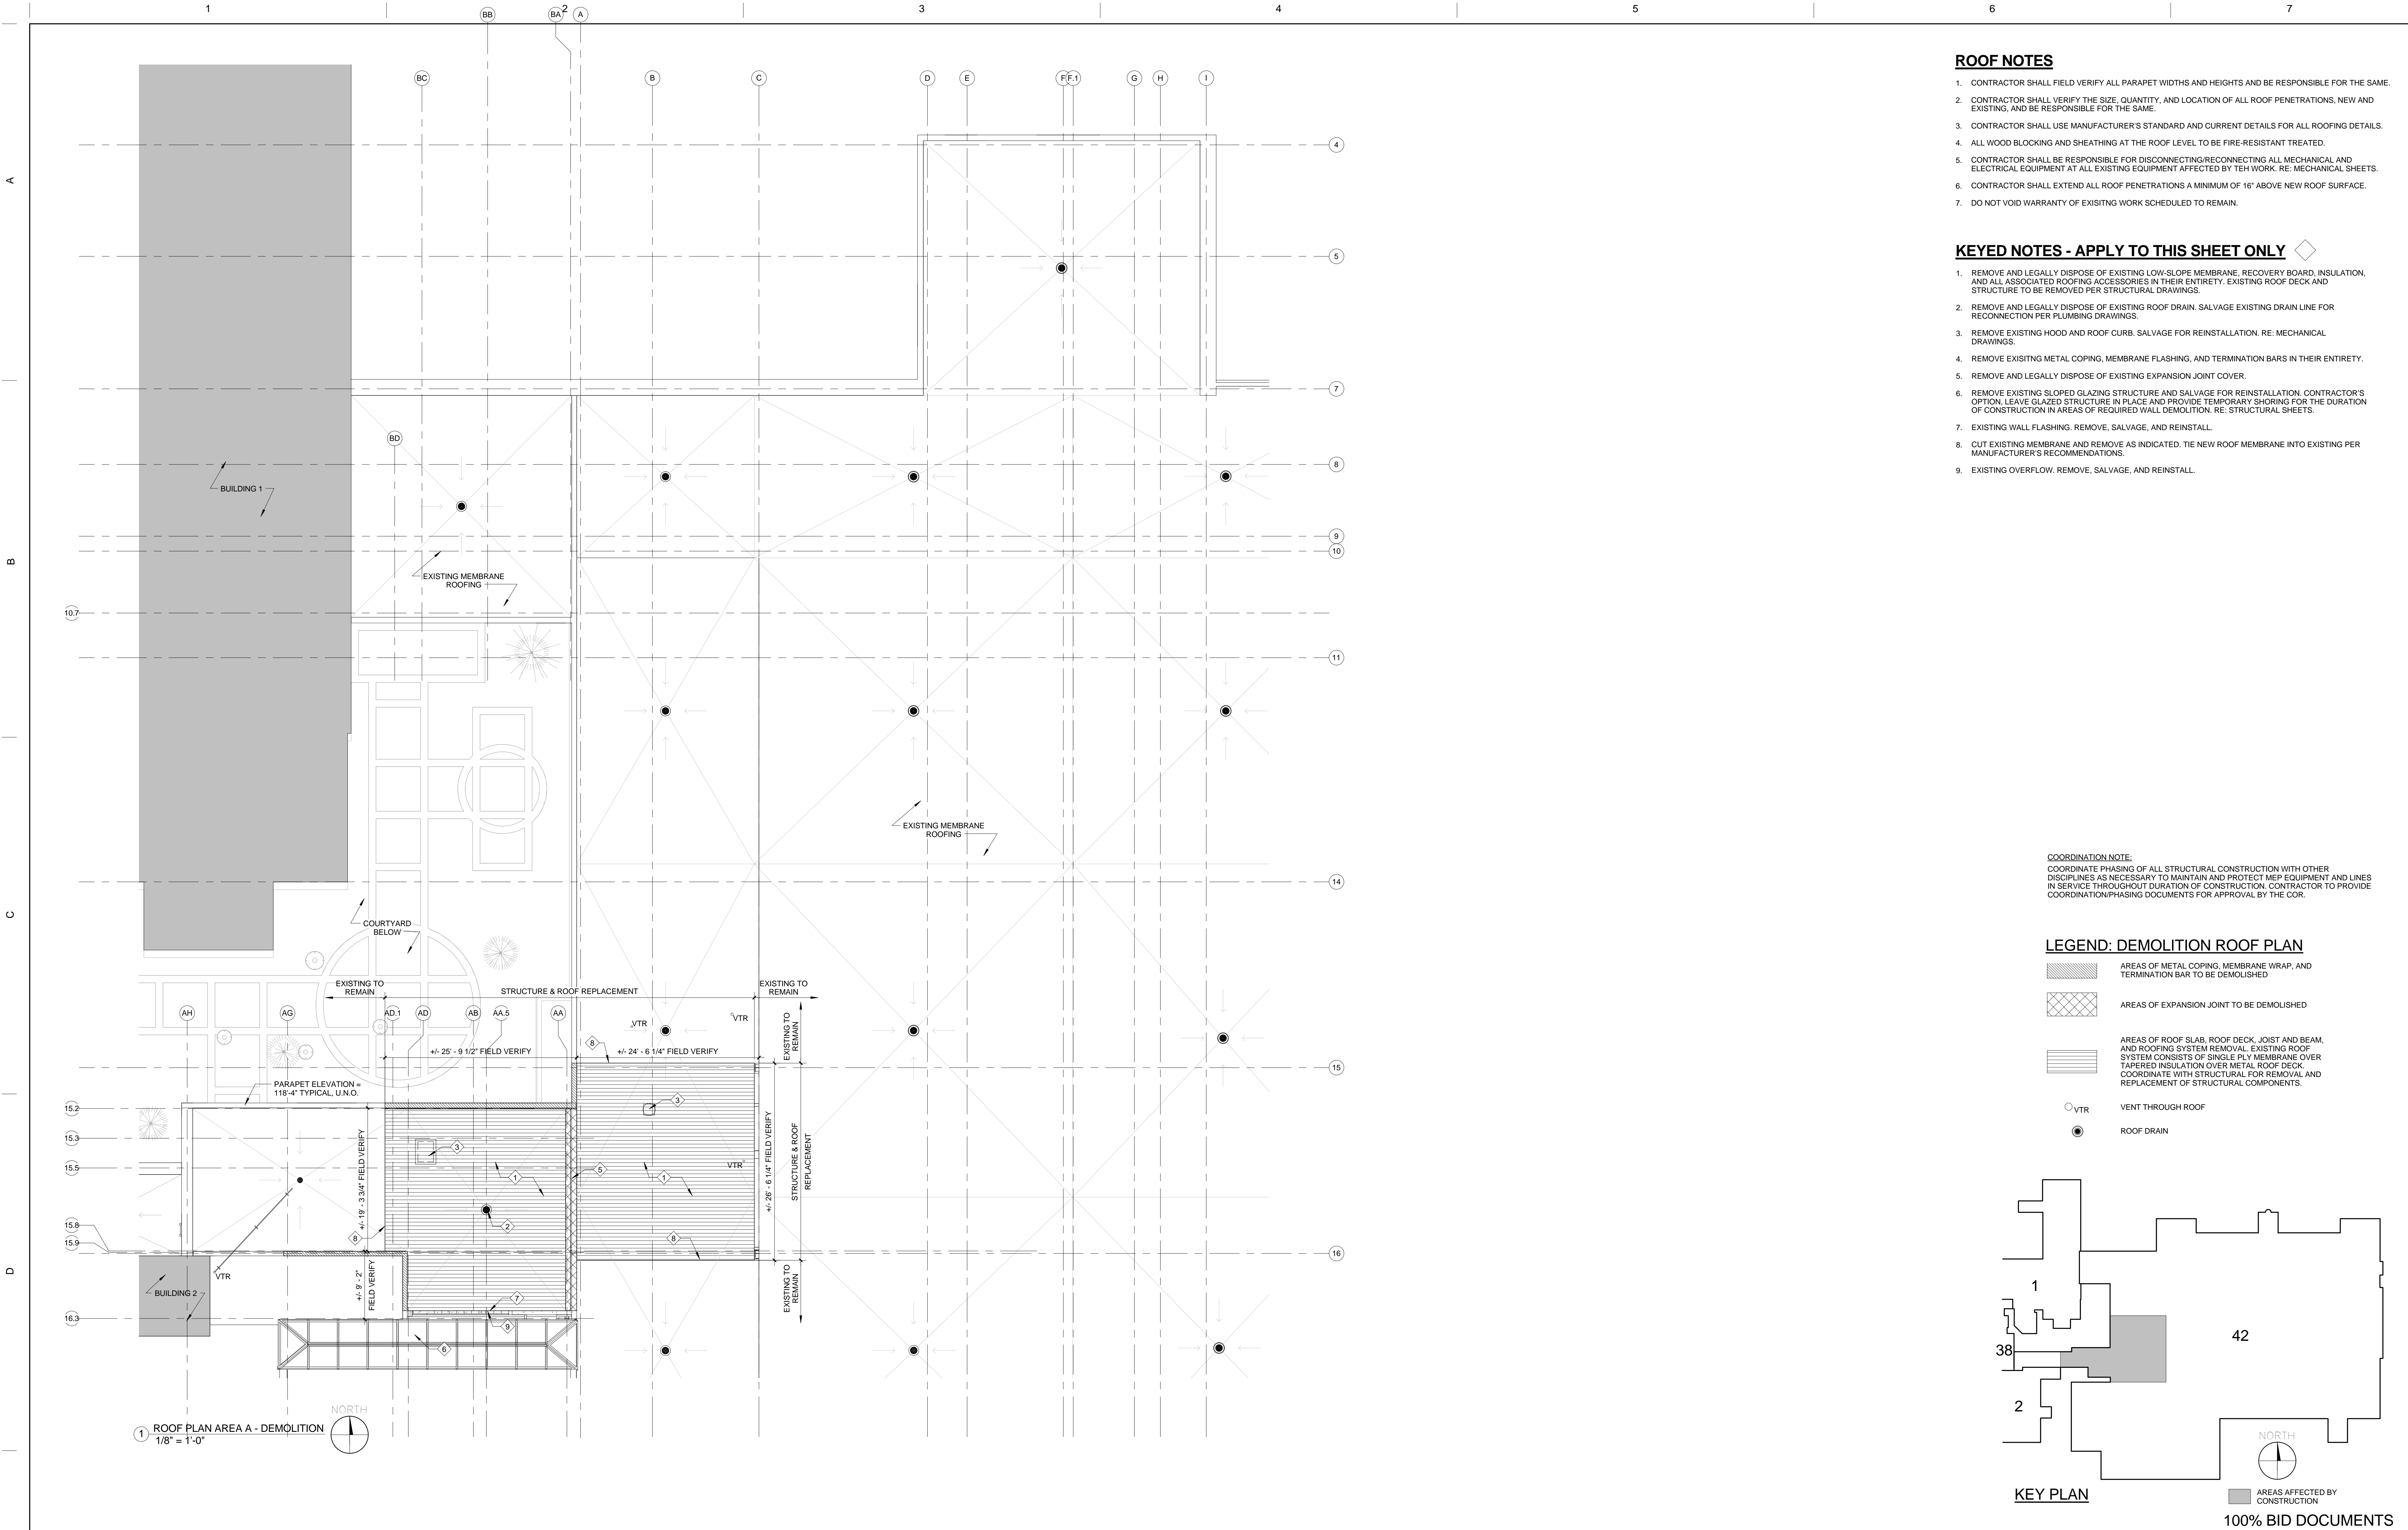
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7. REMOVE AND LEGALLY DISPOSE OF EXISTING 2x4 CEILING AND GRID TO EXTENTS SHOWN. PROTECT REMAINING CONSTRUCTION AND PREPARE FOR INSTALLATION AND TIE-IN OF NEW 2x4 CEILING AND GRID.
8. CUT AND REMOVE EXISTING VCT FLOORING TO EXTENTS NECESSARY TO PERFORM STRUCTURAL IMPROVEMENTS. PROTECT SUBSTRATE DURING CONSTRUCTION ACTIVITIES AND PREPARE FOR INSTALLATION OF NEW VCT FLOORING.
9. CUT AND REMOVE EXISTING CARPET FLOORING TO EXTENTS NECESSARY TO PERFORM STRUCTURAL IMPROVEMENTS. PROTECT SUBSTRATE DURING CONSTRUCTION ACTIVITIES AND PREPARE FOR INSTALLATION OF CARPET FLOORING.
10. REMOVE AND LEGALLY DISPOSE OF EXISTING BULKHEAD/SOFFIT CONSTRUCTION TO EXTENTS NECESSARY TO PERFORM STRUCTURAL IMPROVEMENTS.
11. REMOVE EXISTING STOREFRONT WINDOW SYSTEM IN ITS ENTIRETY. PROVIDE TEMPORARY SHORING/WEATHERPROOFING UNTIL STRUCTURAL MODIFICATIONS ARE COMPLETE.
12. REMOVE AND SALVAGE EXISTING 2x2 PATTERNED CEILING AND REMOVE AND LEGALLY DISPOSE OF GRID TO EXTENTS SHOWN. PROTECT REMAINING CONSTRUCTION AND PREPARE FOR INSTALLATION AND TIE-IN OF NEW 2x2 GRID AND SALVAGED CEILING TILE.
13. REMOVE AND LEGALLY DISPOSE OF PORTIONS OF EXISTING GYPSUM BOARD FROM INDICATED SIDE OF EXISTING PARTITION TO EXTENTS NECESSARY TO PERFORM STRUCTURAL IMPROVEMENTS. EXISTING METAL STUDS TO REMAIN. REMOVAL INCLUDES WALL BOARD, WALL BASE, CORNER GUARDS AND WALL PROTECTION, SIGNAGE, AND FIXED EQUIPMENT. COORDINATE WITH OTHER TRADES FOR REMOVAL OF ADDITIONAL WALL ELEMENTS. BRACE MAY BE INSTALLED OVER GYPSUM BOARD AT BRACE M LOCATION.
14. REMOVE PORTIONS OF EXISTING CHAINLINK FENCE TO THE EXTENT NECESSARY TO PERFORM STRUCTURAL IMPROVEMENTS. REMOVAL INCLUDES CHAINLINK, POSTS, VINYL FENCE SLATS, ETC.
15. REMOVE AND LEGALLY DISPOSE OF EXISTING GYPSUM BOARD AND METAL STUD PARTITION AS INDICATED TO CREATE NEW 4'-0" WIDE CASED OPENING.
16. REMOVE EXISTING BASE CABINETS, WORK SURFACE, WALL CABINETS, ICE MAKER, ETC. COORDINATE WITH OTHER TRADES FOR REMOVAL OF ADDITIONAL WALL MOUNTED ELEMENTS. SALVAGE FOR REINSTALLATION.
17. REMOVE AND LEGALLY DISPOSE OF PORTIONS OF EXISTING EXTERIOR WALL CONSTRUCTION TO EXTENTS NECESSARY TO PERFORM STRUCTURAL IMPROVEMENTS. REMOVAL INCLUDES EXTERIOR INSULATION FINISH SYSTEM, METAL STUD FRAMING, GYPSUM WALL BOARD, AND ALL ASSOCIATED WALL MOUNTED ITEMS. COORDINATE WITH OTHER TRADES FOR REMOVAL OF ADDITIONAL WALL MOUNTED ELEMENTS.
18. REMOVE EXISTING HOLLOW METAL DOOR, FRAME, AND HARDWARE. SALVAGE FOR REINSTALLATION.
19. REMOVE EXISTING PROJECTION SCREEN AND SALVAGE FOR REINSTALLATION.
20. REMOVE EXISTING INDUSTRIAL METAL PAN STAIRS INCLUDING ALL ASSOCIATED RAILING AND HARDWARE AND SALVAGE FOR REINSTALLATION.
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22. REMOVE PORTION OF EXISTING WALL CONSTRUCTION TO INSTALL NEW TEMPORARY WINDOW AND FRAME AS INDICATED. WALL CONSTRUCTION CONSISTS OF WALL BOARD, METAL STUDS, WALL BASE, ETC. RESTORE ADJACENT CONSTRUCTION TO EXISTING CONDITION AFTER WINDOW REMOVAL. RE: PHASING PLANS.
23. REMOVE DOOR(S), FRAME, AND WALL AT BRACE A AND K LOCATIONS. SALVAGE DOOR, FRAME, AND HARDWARE FOR REINSTALLATION. WHERE EXISTING DOOR IS ACCESS CONTROLLED, DISCONNECT AND RECONNECT ALL POWER OPERATED HARDWARE AS REQUIRED TO RESTORE FUNCTION TO ACCESS CONTROLS.
24. REMOVE EXISTING HYDRAULIC ELEVATOR IN ITS ENTIRETY, INCLUDING BUT NOT LIMITED TO ELEVATOR, ELEVATOR SHAFT, EQUIPMENT, AND SUPPORTS, ETC.
25. SAWCUT AND REMOVE EXISTING CONCRETE FLOOR SLAB AND METAL FLOOR DECK IN THEIR ENTIRETY WHERE INDICATED. COORDINATE WITH STRUCTURAL DRAWINGS FOR REMOVAL OF EXISTING STRUCTURAL COMPONENTS AT THESE AREAS. SHORE REMAINING STRUCTURE UNTIL NEW STRUCTURAL COMPONENTS, FLOOR DECKING, AND CONCRETE SLAB HAVE BEEN INSTALLED AND CURED TO SUPPORT PERMANENT LOADS.
26. EXISTING STRUCTURE AND ROOFING SYSTEM TO BE REMOVED ABOVE INDICATED AREA. RE: ROOF PLAN AND STRUCTURAL DRAWINGS FOR ADDITIONAL INFORMATION. SHORE ADJACENT REMAINING STRUCTURE UNTIL NEW STRUCTURAL COMPONENTS AND ROOF DECK HAVE BEEN INSTALLED.
27. IN AREAS OF ROOF SYSTEM AND STRUCTURE REMOVAL, REMOVE EXISTING SUSPENDED ACOUSTICAL CEILING SYSTEM IN ITS ENTIRETY. AT CONTRACTOR'S OPTION, REMOVE EXISTING METAL STUD AND GYPSUM BOARD PARTITIONS, WALL MOUNTED EQUIPMENT, AND REMAINING INTERIOR FINISHES IN THEIR ENTIRETY OR REMOVE AFORESAID ONLY TO THE EXTENT REQUIRED TO COMPLETE THE STRUCTURAL UPGRADES. UPON COMPLETION OF THE IMPROVEMENTS, CONTRACTOR SHALL REBUILD OR RESTORE SPACES TO EXISTING CONDITION. BUILDING SYSTEMS/SERVICES TRANSITING THE AREA SHALL REMAIN IN OPERATION AND BE PROTECTED DURING THE DURATION OF CONSTRUCTION. COORDINATE WITH PLUMBING, MECHANICAL, ELECTRICAL DRAWINGS FOR ADDITIONAL BUILDING SYSTEMS/SERVICES WORK.
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29. REMOVE ONE LEAF OF EXISTING DOUBLE DOORS AND SALVAGE FOR REINSTALLATION. REPLACE REMOVED LEAF WITH TEMPORARY LOUVER PER MECHANICAL DRAWINGS. UPON COMPLETION OF STRUCTURAL IMPROVEMENTS, REMOVE TEMPORARY LOUVER AND REINSTALL SALVAGED DOOR LEAF. RE: MECHANICAL DRAWINGS.
30. REMOVE EXISTING METAL PAN STAIRS WITH CONCRETE TREADS AND ALL ASSOCIATED RAILINGS AND SALVAGE FOR REINSTALLATION.
31. REMOVE AND LEGALLY DISPOSE OF EXISTING ELEVATOR SHAFTWALL IN ITS ENTIRETY. REMOVAL INCLUDES CMU, METAL FURRING, GYPSUM BOARD, WALL BASE, ETC. EXISTING WEST CMU SHAFTWALL SHALL REMAIN.
32. REMOVE AND LEGALLY DISPOSE OF EXISTING EXTERIOR WALL CONSTRUCTION IN ITS ENTIRETY. REMOVAL INCLUDES EXTERIOR INSULATION FINISH SYSTEM, METAL STUD FRAMING, CMU, GYPSUM WALL BOARD, INTERIOR FINISHES AND ALL ASSOCIATED WALL MOUNTED ITEMS, METAL CORING CAPS, AND PARAPET FRAMING, ETC. EXISTING FOUNDATION WALL AND STRUCTURAL STEEL FRAMING TO REMAIN U.N.O. COORDINATE WITH STRUCTURAL REQUIREMENTS.
33. REMOVE EXISTING STOREFRONT WINDOW SYSTEM IN ITS ENTIRETY AND SALVAGE FOR REINSTALLATION.



KEY PLAN

100% BID DOCUMENTS

<div>Revisions:</div> <div>Date:</div>	<div>CONSULTANTS:</div> <div><div><div>Baysinger Design Group, Inc.</div><div>431 West DuPont Street, Suite 100B Morton, Illinois 62450</div><div>Phone: 618.990.8015 Fax: 618.990.8012 Email: Design@Baysinger.com</div></div><div><div>AMERICAN STRUCTUREPOINT INC.</div><div>7260 Shadeland Station, Indianapolis, IN 46256 Tel: 317.543.5580 Fax: 317.543.8270 www.structurepoint.com</div></div></div>	<div><div>STATE OF ILLINOIS SHERILA Seal of the State of Illinois EXPIRES 11-30-18</div></div>	<div>PROJECT MANAGER:</div> <div><div><div>APOGEE Consulting Group Engineers Architects www.acgp-gsa.com 919-858-7420</div><div>Raleigh, NC Indianapolis, IN Pittsburgh, PA Virginia Beach, VA Fort Collins, CO</div></div><div>Project Number 16-198</div><div>Scale AS INDICATED</div></div>	<div>Office of Construction and Facilities Management</div> <div>VA U.S. Department of Veterans Affairs</div>	<div>Drawing Title: GROUND FLOOR AREA B FLOOR PLAN - DEMOLITION</div> <div>Location MARION VAMC MARION, IL, 62959</div>	<div>Project Title: ADD STRUCTURAL IMPROVEMENTS TO BUILDING 42</div> <div>Approved: Project Director</div> <div>Date 09/06/17</div> <div>Checked HKG</div> <div>Drawn MNH</div>	<div>VA PROJECT NUMBER 657-343</div> <div>Building Number 42</div> <div>Drawing Number AD101</div> <div>Dwg. 38 of 81</div>
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ROOF NOTES

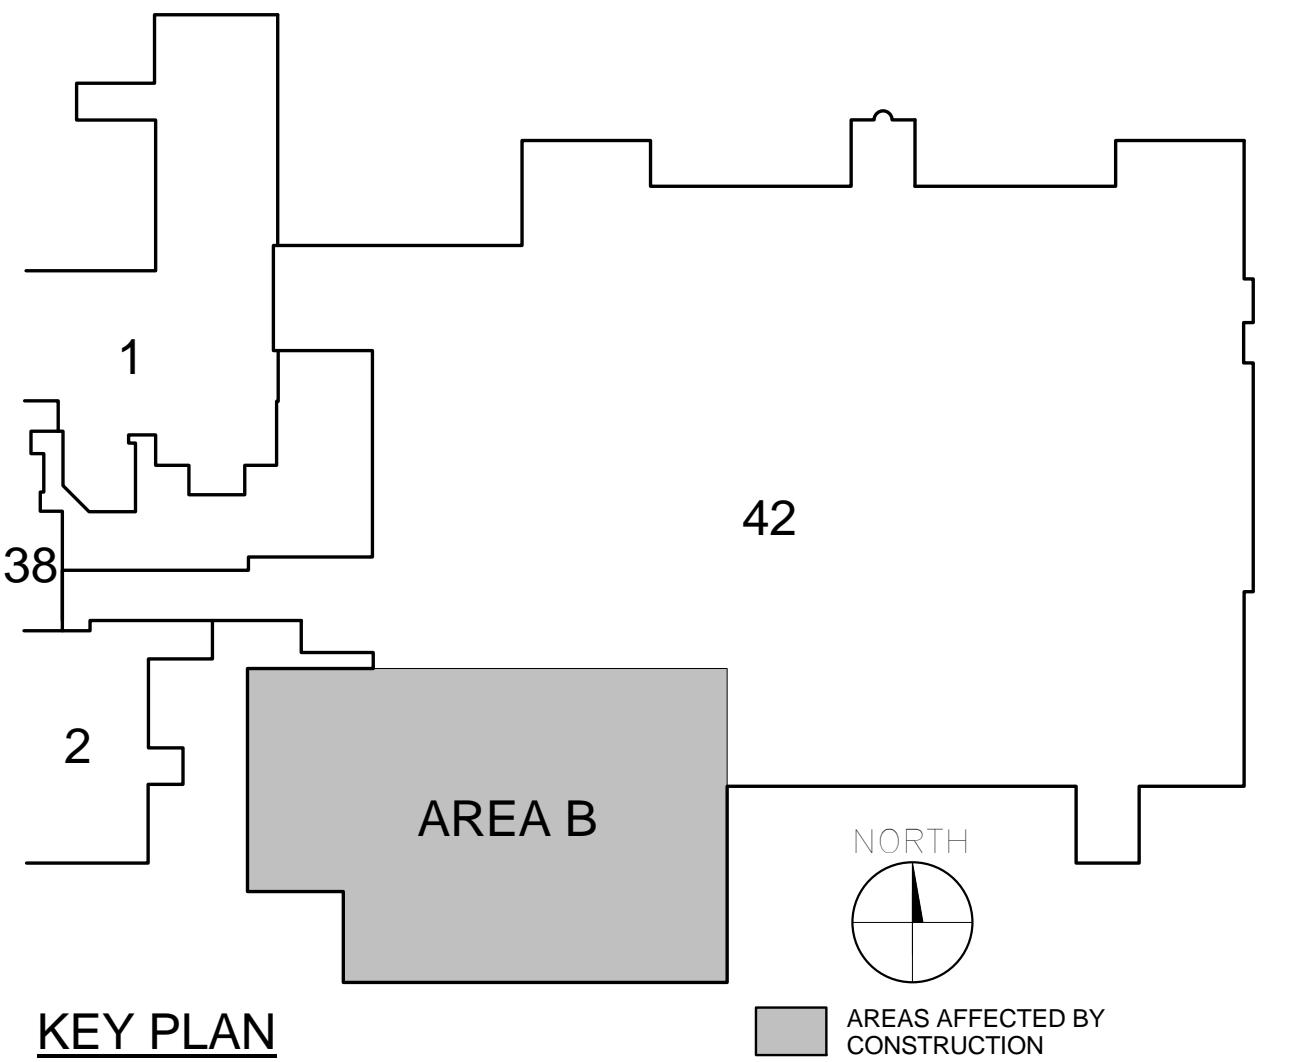1. CONTRACTOR SHALL FIELD VERIFY ALL PARAPET WIDTHS AND HEIGHTS AND BE RESPONSIBLE FOR THE SAME.
2. CONTRACTOR SHALL VERIFY THE SIZE, QUANTITY, AND LOCATION OF ALL ROOF PENETRATIONS, NEW AND EXISTING, AND BE RESPONSIBLE FOR THE SAME.
3. CONTRACTOR SHALL USE MANUFACTURER'S STANDARD AND CURRENT DETAILS FOR ALL ROOFING DETAILS.
4. ALL WOOD BLOCKING AND SHEATHING AT THE ROOF LEVEL TO BE FIRE-RESISTANT TREATED.
5. CONTRACTOR SHALL BE RESPONSIBLE FOR DISCONNECTING/RECONNECTING ALL MECHANICAL AND ELECTRICAL EQUIPMENT AT ALL EXISTING EQUIPMENT AFFECTED BY TEH WORK. RE: MECHANICAL SHEETS.
6. CONTRACTOR SHALL EXTEND ALL ROOF PENETRATIONS A MINIMUM OF 16" ABOVE NEW ROOF SURFACE.
7. DO NOT VOID WARRANTY OF EXISTING WORK SCHEDULED TO REMAIN.


KEYED NOTES - APPLY TO THIS SHEET ONLY

1. REMOVE AND LEGALLY DISPOSE OF EXISTING LOW-SLOPE MEMBRANE, RECOVERY BOARD, INSULATION, AND ALL ASSOCIATED ROOFING ACCESSORIES IN THEIR ENTIRETY. EXISTING ROOF DECK AND STRUCTURE TO BE REMOVED PER STRUCTURAL DRAWINGS.
2. REMOVE AND LEGALLY DISPOSE OF EXISTING ROOF DRAIN. SALVAGE EXISTING DRAIN LINE FOR RECONNECTION PER PLUMBING DRAWINGS.
3. REMOVE EXISTING HOOD AND ROOF CURB. SALVAGE FOR REINSTALLATION. RE: MECHANICAL DRAWINGS.
4. REMOVE EXISTING METAL COPING, MEMBRANE FLASHING, AND TERMINATION BARS IN THEIR ENTIRETY.
5. REMOVE AND LEGALLY DISPOSE OF EXISTING EXPANSION JOINT COVER.
6. REMOVE EXISTING SLOPED GLAZING STRUCTURE AND SALVAGE FOR REINSTALLATION. CONTRACTOR'S OPTION. LEAVE GLAZED STRUCTURE IN PLACE AND PROVIDE TEMPORARY SHORING FOR THE DURATION OF CONSTRUCTION IN AREAS OF REQUIRED WALL DEMOLITION. RE: STRUCTURAL SHEETS.
7. EXISTING WALL FLASHING. REMOVE, SALVAGE, AND REINSTALL.
8. CUT EXISTING MEMBRANE AND REMOVE AS INDICATED. TIE NEW ROOF MEMBRANE INTO EXISTING PER MANUFACTURER'S RECOMMENDATIONS.
9. EXISTING OVERFLOW. REMOVE, SALVAGE, AND REINSTALL.

COORDINATION NOTE:
COORDINATE PHASING OF ALL STRUCTURAL CONSTRUCTION WITH OTHER DISCIPLINES AS NECESSARY TO MAINTAIN AND PROTECT MEP EQUIPMENT AND LINES IN SERVICE THROUGHOUT DURATION OF CONSTRUCTION. CONTRACTOR TO PROVIDE COORDINATION/PHASING DOCUMENTS FOR APPROVAL BY THE COR.

LEGEND: DEMOLITION ROOF PLAN

- AREAS OF METAL COPING, MEMBRANE WRAP, AND TERMINATION BAR TO BE DEMOLISHED
- AREAS OF EXPANSION JOINT TO BE DEMOLISHED
- AREAS OF ROOF SLAB, ROOF DECK, JOIST AND BEAM, AND ROOFING SYSTEM REMOVAL. EXISTING ROOF SYSTEM CONSISTS OF SINGLE PLY MEMBRANE OVER TAPERED INSULATION OVER METAL ROOF DECK. COORDINATE WITH STRUCTURAL FOR REMOVAL AND REPLACEMENT OF STRUCTURAL COMPONENTS.
- VTR VENT THROUGH ROOF
- ROOF DRAIN

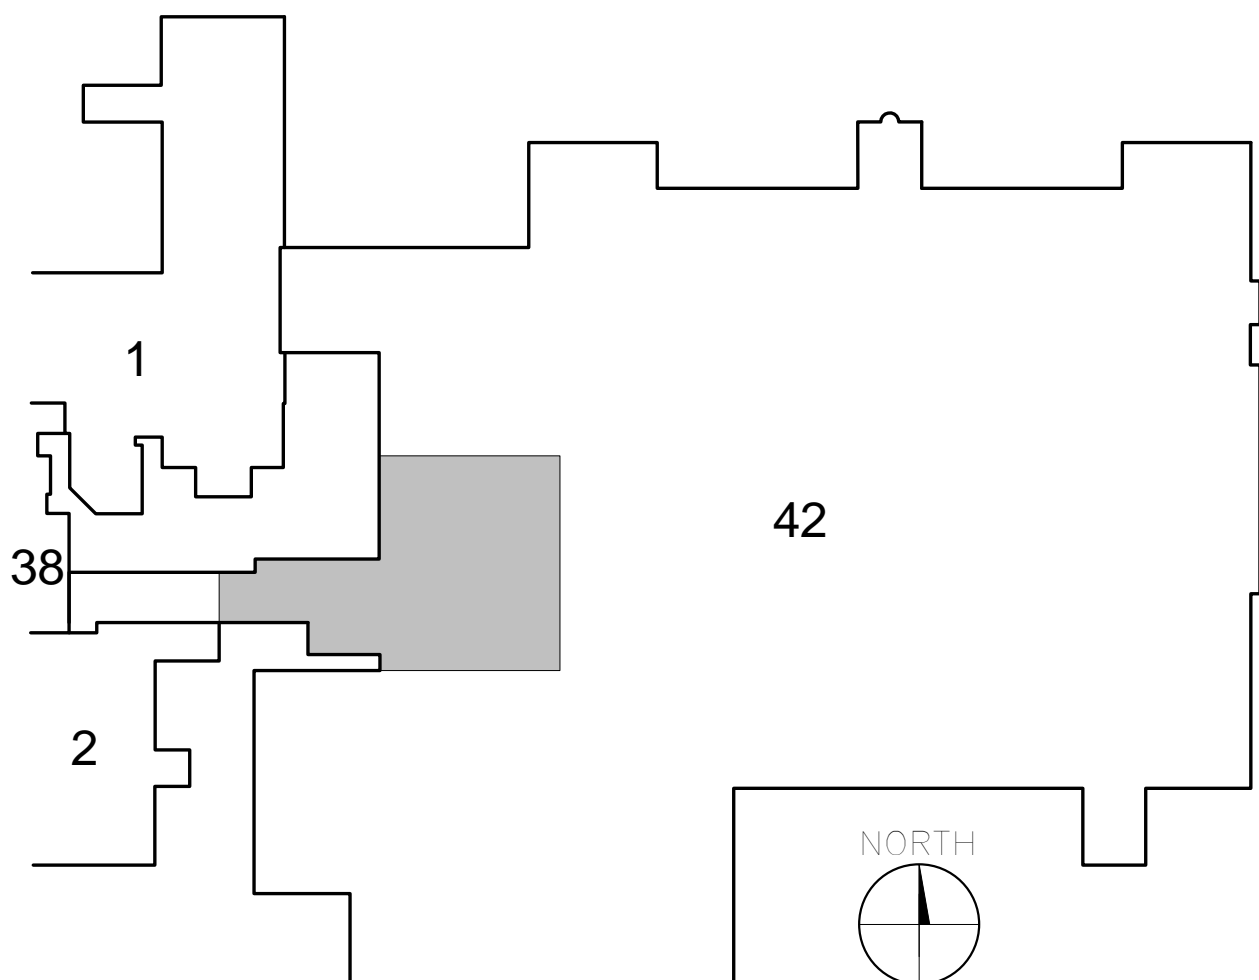

KEY PLAN

100% BID DOCUMENTS

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State of Illinois
Professional Seal
EXPIRES: 11-30-18

PROJECT MANAGER:

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Raleigh, NC
Indianapolis, IN
Pittsburgh, PA
Virginia Beach, VA
Fort Collins, CO

Project Number
16-198

Scale
AS INDICATED

Office of
Construction
and Facilities
Management



Drawing Title:
ENLARGED ROOF PLAN - DEMOLITION

Location
MARION VAMC
MARION, IL, 62959

Project Title:
ADD STRUCTURAL
IMPROVEMENTS TO BUILDING
42

Approved: Project Director

Date
09/06/17

Checked
HKG

Drawn
SPH

VA PROJECT NUMBER
657-343
Building Number
42
Drawing Number
AD200
Dwg. 39 of 81


KEYED NOTES - APPLY TO THIS SHEET ONLY

- REMOVE AND LEGALLY DISPOSE OF EXISTING GYPSUM BOARD AND METAL STUD PARTITION IN ITS ENTIRETY. REMOVAL INCLUDES WALL BOARD, WALL BASE, CORNER GUARDS AND WALL PROTECTION, SIGNAGE, AND METAL STUD FRAMING. COORDINATE WITH OTHER TRADES FOR REMOVAL OF ADDITIONAL WALL MOUNTED ELEMENTS. SALVAGE INTERIOR SIGNAGE FOR REINSTALLATION.
- INDICATES EXPECTED EXTENT OF FLOOR SLAB DEMOLITION. AT CONTRACTOR'S OPTION AND AT NO ADDITIONAL COST TO THE VA, METAL PAN STAIR WITH POURED CONCRETE TREADS MAY BE REMOVED AND SALVAGED FOR THE DURATION OF SUBGRADE STRUCTURAL WORK. SUBSEQUENTLY INSTALLED IN A CONDITION MATCHING EXISTING. PREP, PRIME, AND FINISH STRUCTURE, AND ALL ASSOCIATED RAILINGS. COORDINATE WITH STRUCTURAL DRAWINGS. IN INSTANCES WHERE CONTRACTOR HAS CHOSEN TO LEAVE EXISTING STAIRS IN PLACE DURING CONSTRUCTION, CONTRACTOR SHALL PROPERLY SHORE THE STAIRS AND LANDINGS UNTIL NEW STRUCTURE AND FLOOR/ROOF ASSEMBLIES HAVE BEEN INSTALLED AND ARE CAPABLE OF SUPPORTING PERMANENT LOADS. RAILINGS SHALL BE REMOVED AND SALVAGED FOR REINSTALLATION AS REQUIRED REGARDLESS OF STAIR REMOVAL.
- REMOVE AND LEGALLY DISPOSE OF EXISTING ELEVATOR IN ITS ENTIRETY, INCLUDING BUT NOT LIMITED TO ELEVATOR, EQUIPMENT, AND SUPPORTS. COORDINATE WITH STRUCTURAL, MECHANICAL, ELECTRICAL, AND PLUMBING FOR RELATED WORK.
- DEMOLISH AND REMOVE EXISTING ELEVATOR PIT SLAB IN ITS ENTIRETY. REMOVAL INCLUDES, BUT IS NOT LIMITED TO SLAB, SUMP GRATE, LADDER, ETC. COORDINATE WITH STRUCTURAL.
- REMOVE AND LEGALLY DISPOSE OF PORTIONS OF THE EXISTING GYPSUM BOARD, FRP, AND METAL STUD PARTITIONS TO THE EXTENT NECESSARY TO PERFORM STRUCTURAL MODIFICATIONS. REMOVAL INCLUDES WALL BASE, WALL PROJECTION, SIGNAGE, AND WALL MOUNTED EQUIPMENT.
- REMOVE AND SALVAGE EXISTING DOOR, FRAME, AND HARDWARE FOR REINSTALLATION.
- REMOVE EXISTING CMU ELEVATOR SHAFT WALL IN ITS ENTIRETY. REMOVAL INCLUDES BUT IS NOT LIMITED TO CMU, REINFORCING, AND SURFACE MOUNTED OR FURRED OUT FINISHES. COORDINATE WITH STRUCTURAL, MECHANICAL, ELECTRICAL, AND PLUMBING FOR RELATED WORK.


COORDINATION NOTE:
COORDINATE PHASING OF ALL STRUCTURAL CONSTRUCTION WITH OTHER DISCIPLINES AS NECESSARY TO MAINTAIN AND PROTECT MEP EQUIPMENT AND LINES IN SERVICE THROUGHOUT DURATION OF CONSTRUCTION. CONTRACTOR TO PROVIDE COORDINATION/PHASING DOCUMENTS FOR APPROVAL BY THE COR.

LEGEND: DEMOLITION FLOOR PLAN

- AREAS OF WALL DEMO
- AREAS OF FLOOR DEMO
- AREAS OF CEILING REMOVAL
- AREAS OF FLOOR DEMO & CEILING REMOVAL
- TEMPORARY PARTITION/BARRIER, RE: PHASING AND INFECTION CONTROL PLAN.
- TEMPORARY PARTITION/BARRIER AND DOOR, RE: PHASING AND INFECTION CONTROL PLAN.
- AREAS OF FLOOR SLAB, FLOOR DECK, ROOF SLAB, ROOF DECK, ROOF SYSTEM AND JOIST AND BEAM REMOVAL. COORDINATE WITH STRUCTURAL.
- AREAS OF ROOF SLAB, ROOF DECK, JOIST AND BEAM, AND ROOFING SYSTEM REMOVAL. COORDINATE WITH STRUCTURAL.

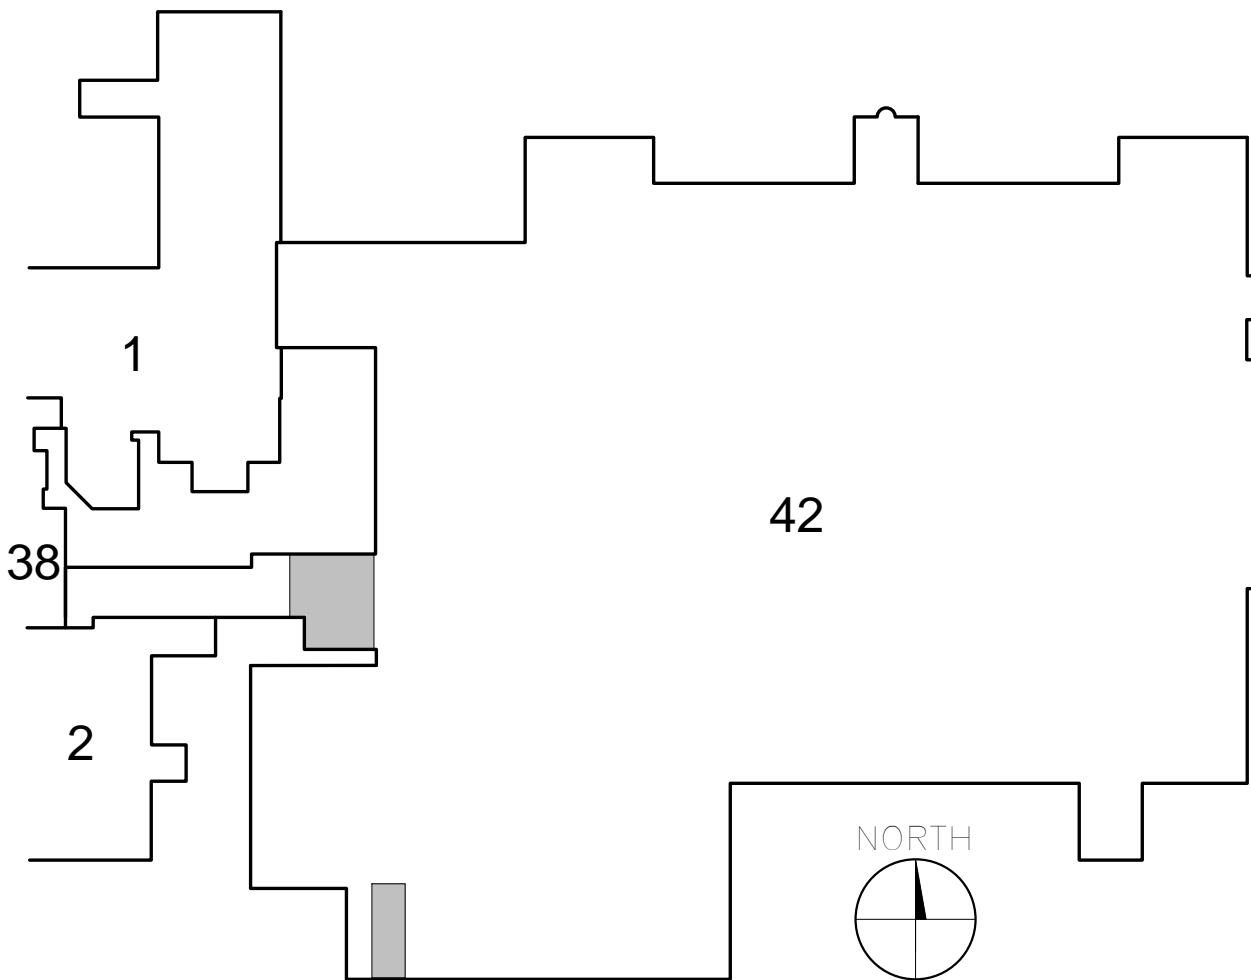


KEY PLAN

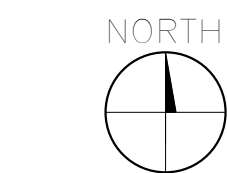


AREAS AFFECTED BY CONSTRUCTION

100% BID DOCUMENTS

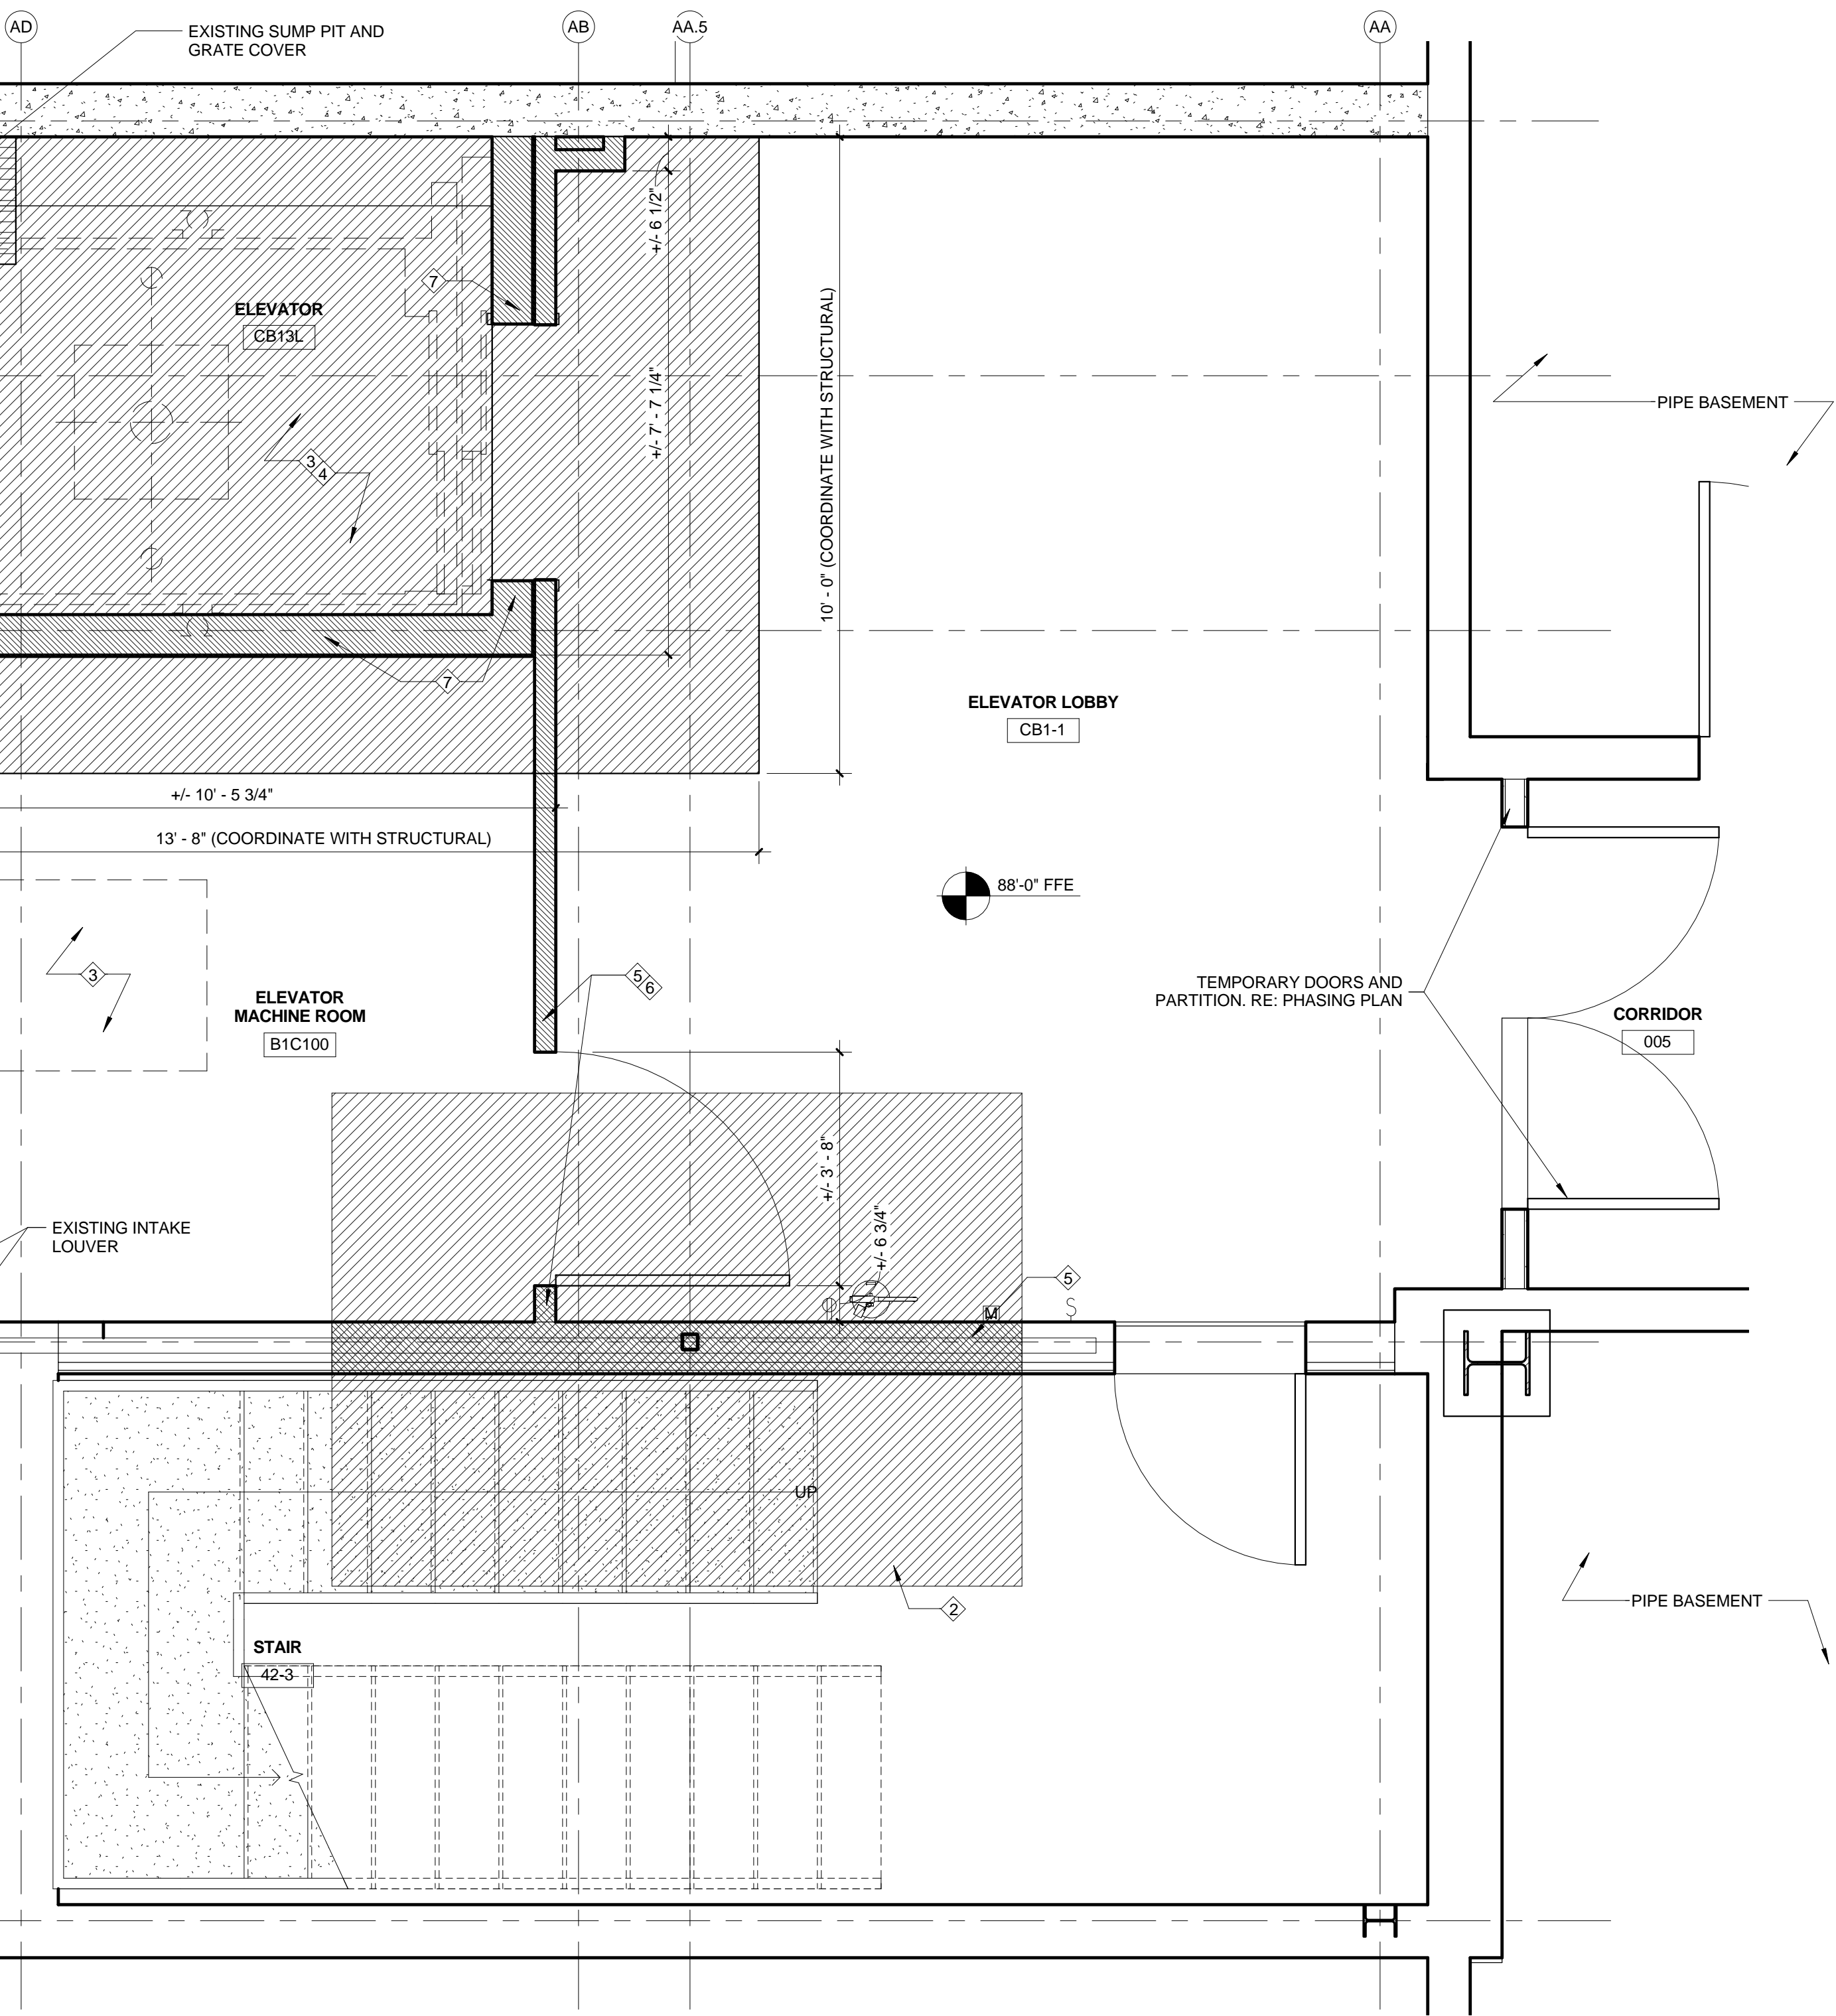

1 ENLARGED SUB BASEMENT ELEVATOR PLAN - DEMOLITION
1/2" = 1'-0"

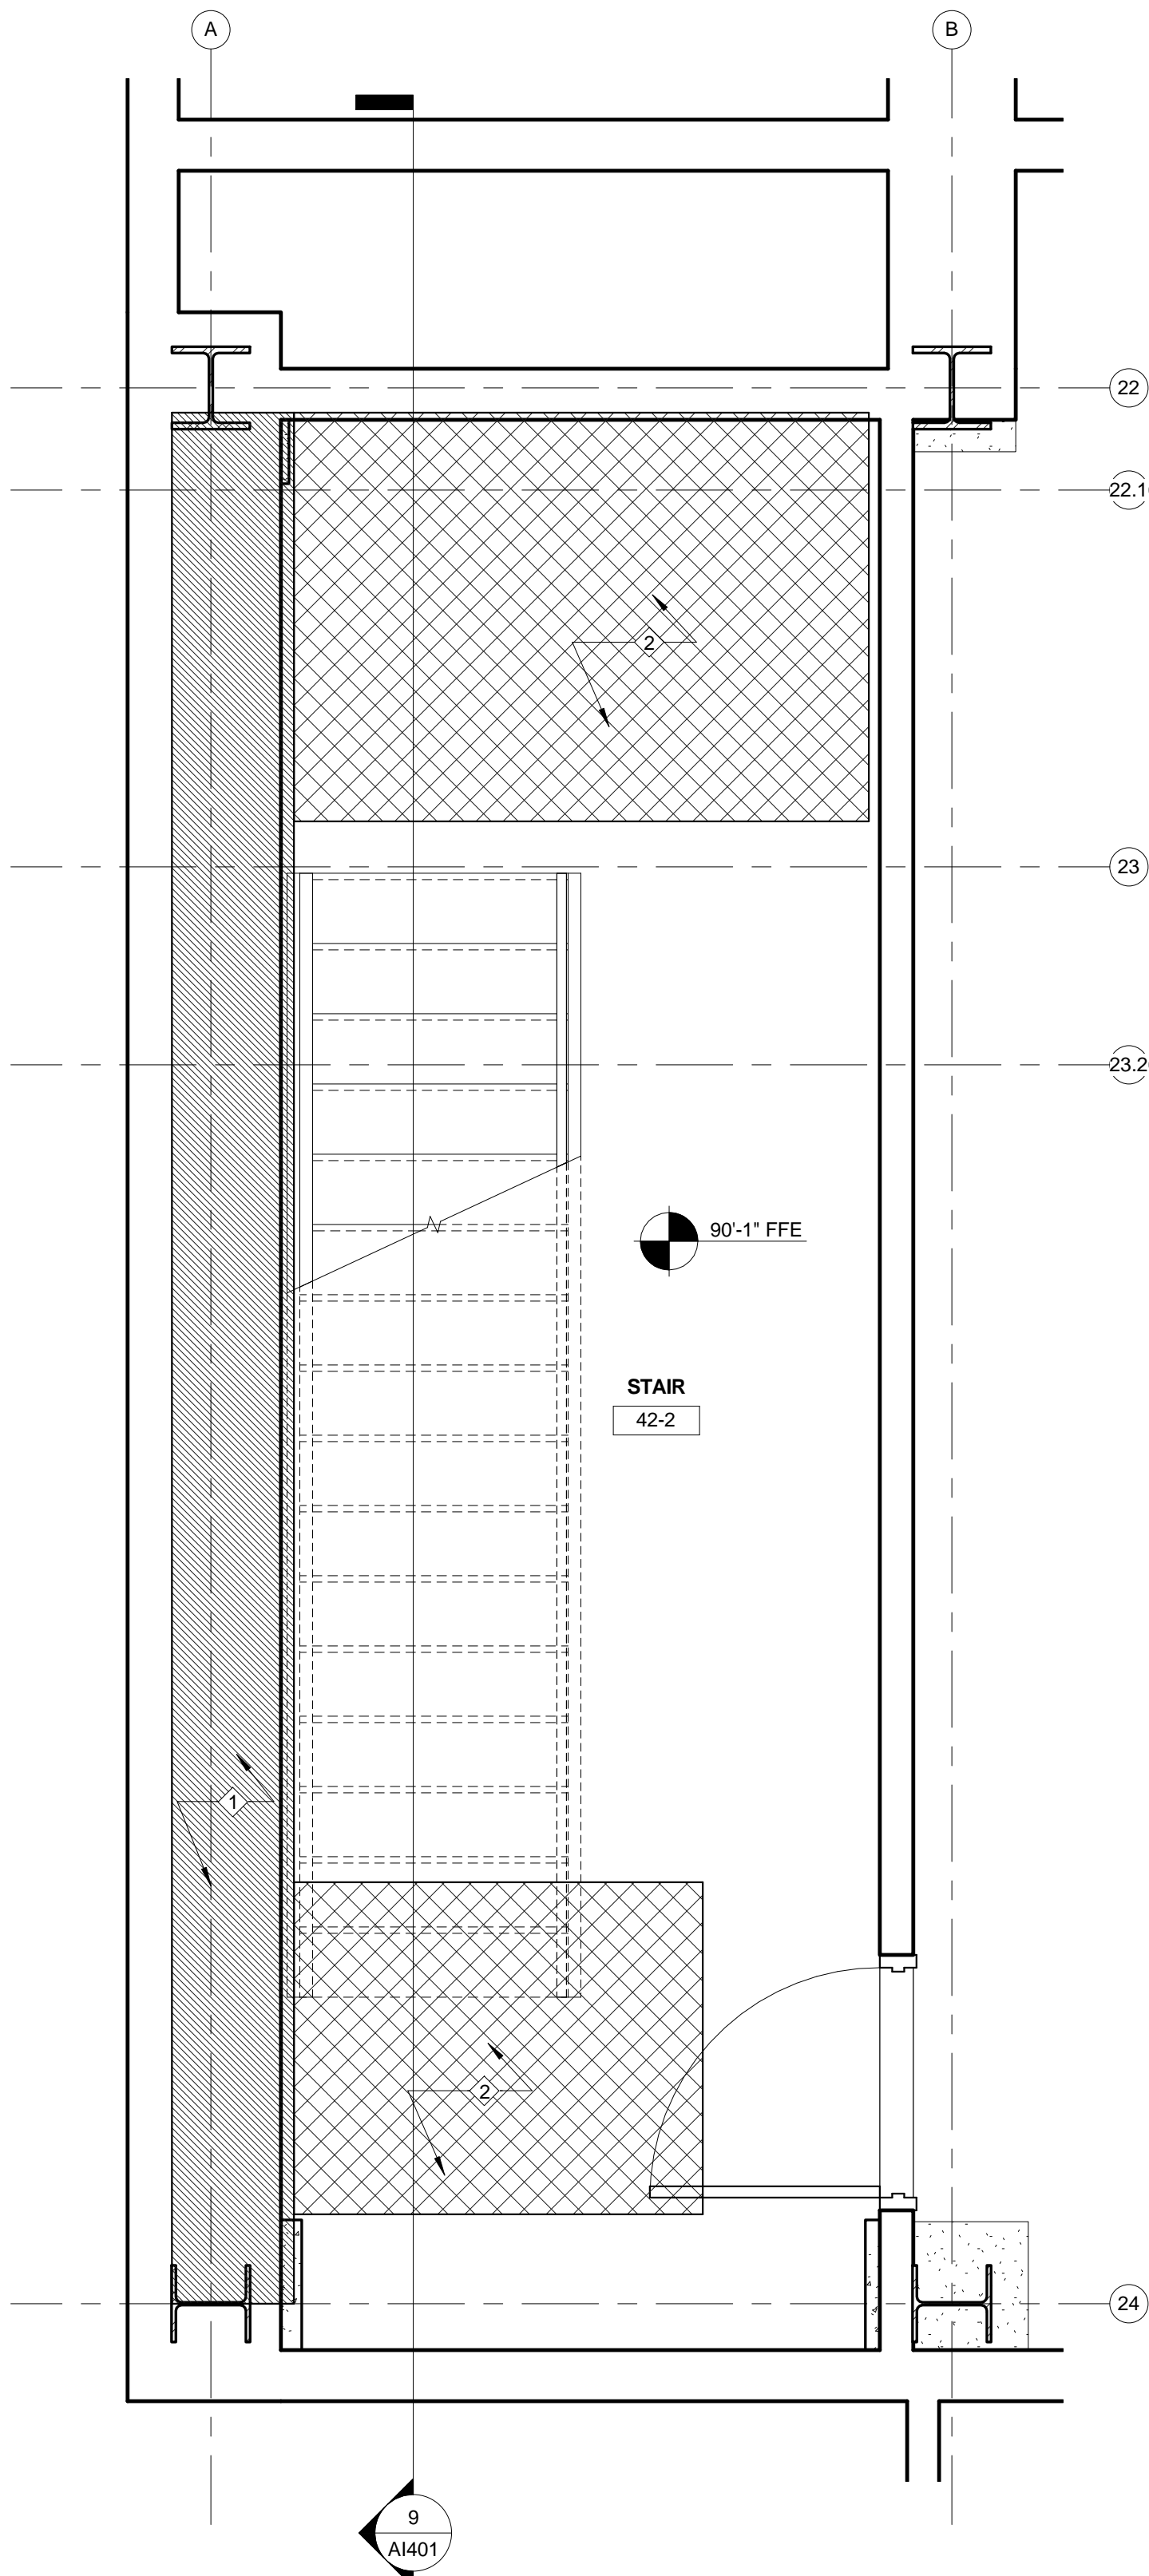

2 ENLARGED SUB BASEMENT STAIR PLAN - DEMOLITION
1/2" = 1'-0"

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EXPIRES: 11-30-18

PROJECT MANAGER:



Raleigh, NC
Indianapolis, IN
Pittsburgh, PA
Virginia Beach, VA
Fort Collins, CO

Project Number
16-198

Scale
AS INDICATED

Office of
Construction
and Facilities
Management



U.S. Department
of Veterans Affairs

Drawing Title:
PIPE BASEMENT ENLARGED PLANS -
DEMOLITION

Location

MARION VAMC
MARION, IL, 62959

Project Title:
ADD STRUCTURAL
IMPROVEMENTS TO BUILDING
42

Approved: Project Director

Date
09/06/17

Checked
HKG

Drawn
SPH


VA PROJECT NUMBER
657-343

Building Number
42

Drawing Number

AD420

Dwg. 40 of 81

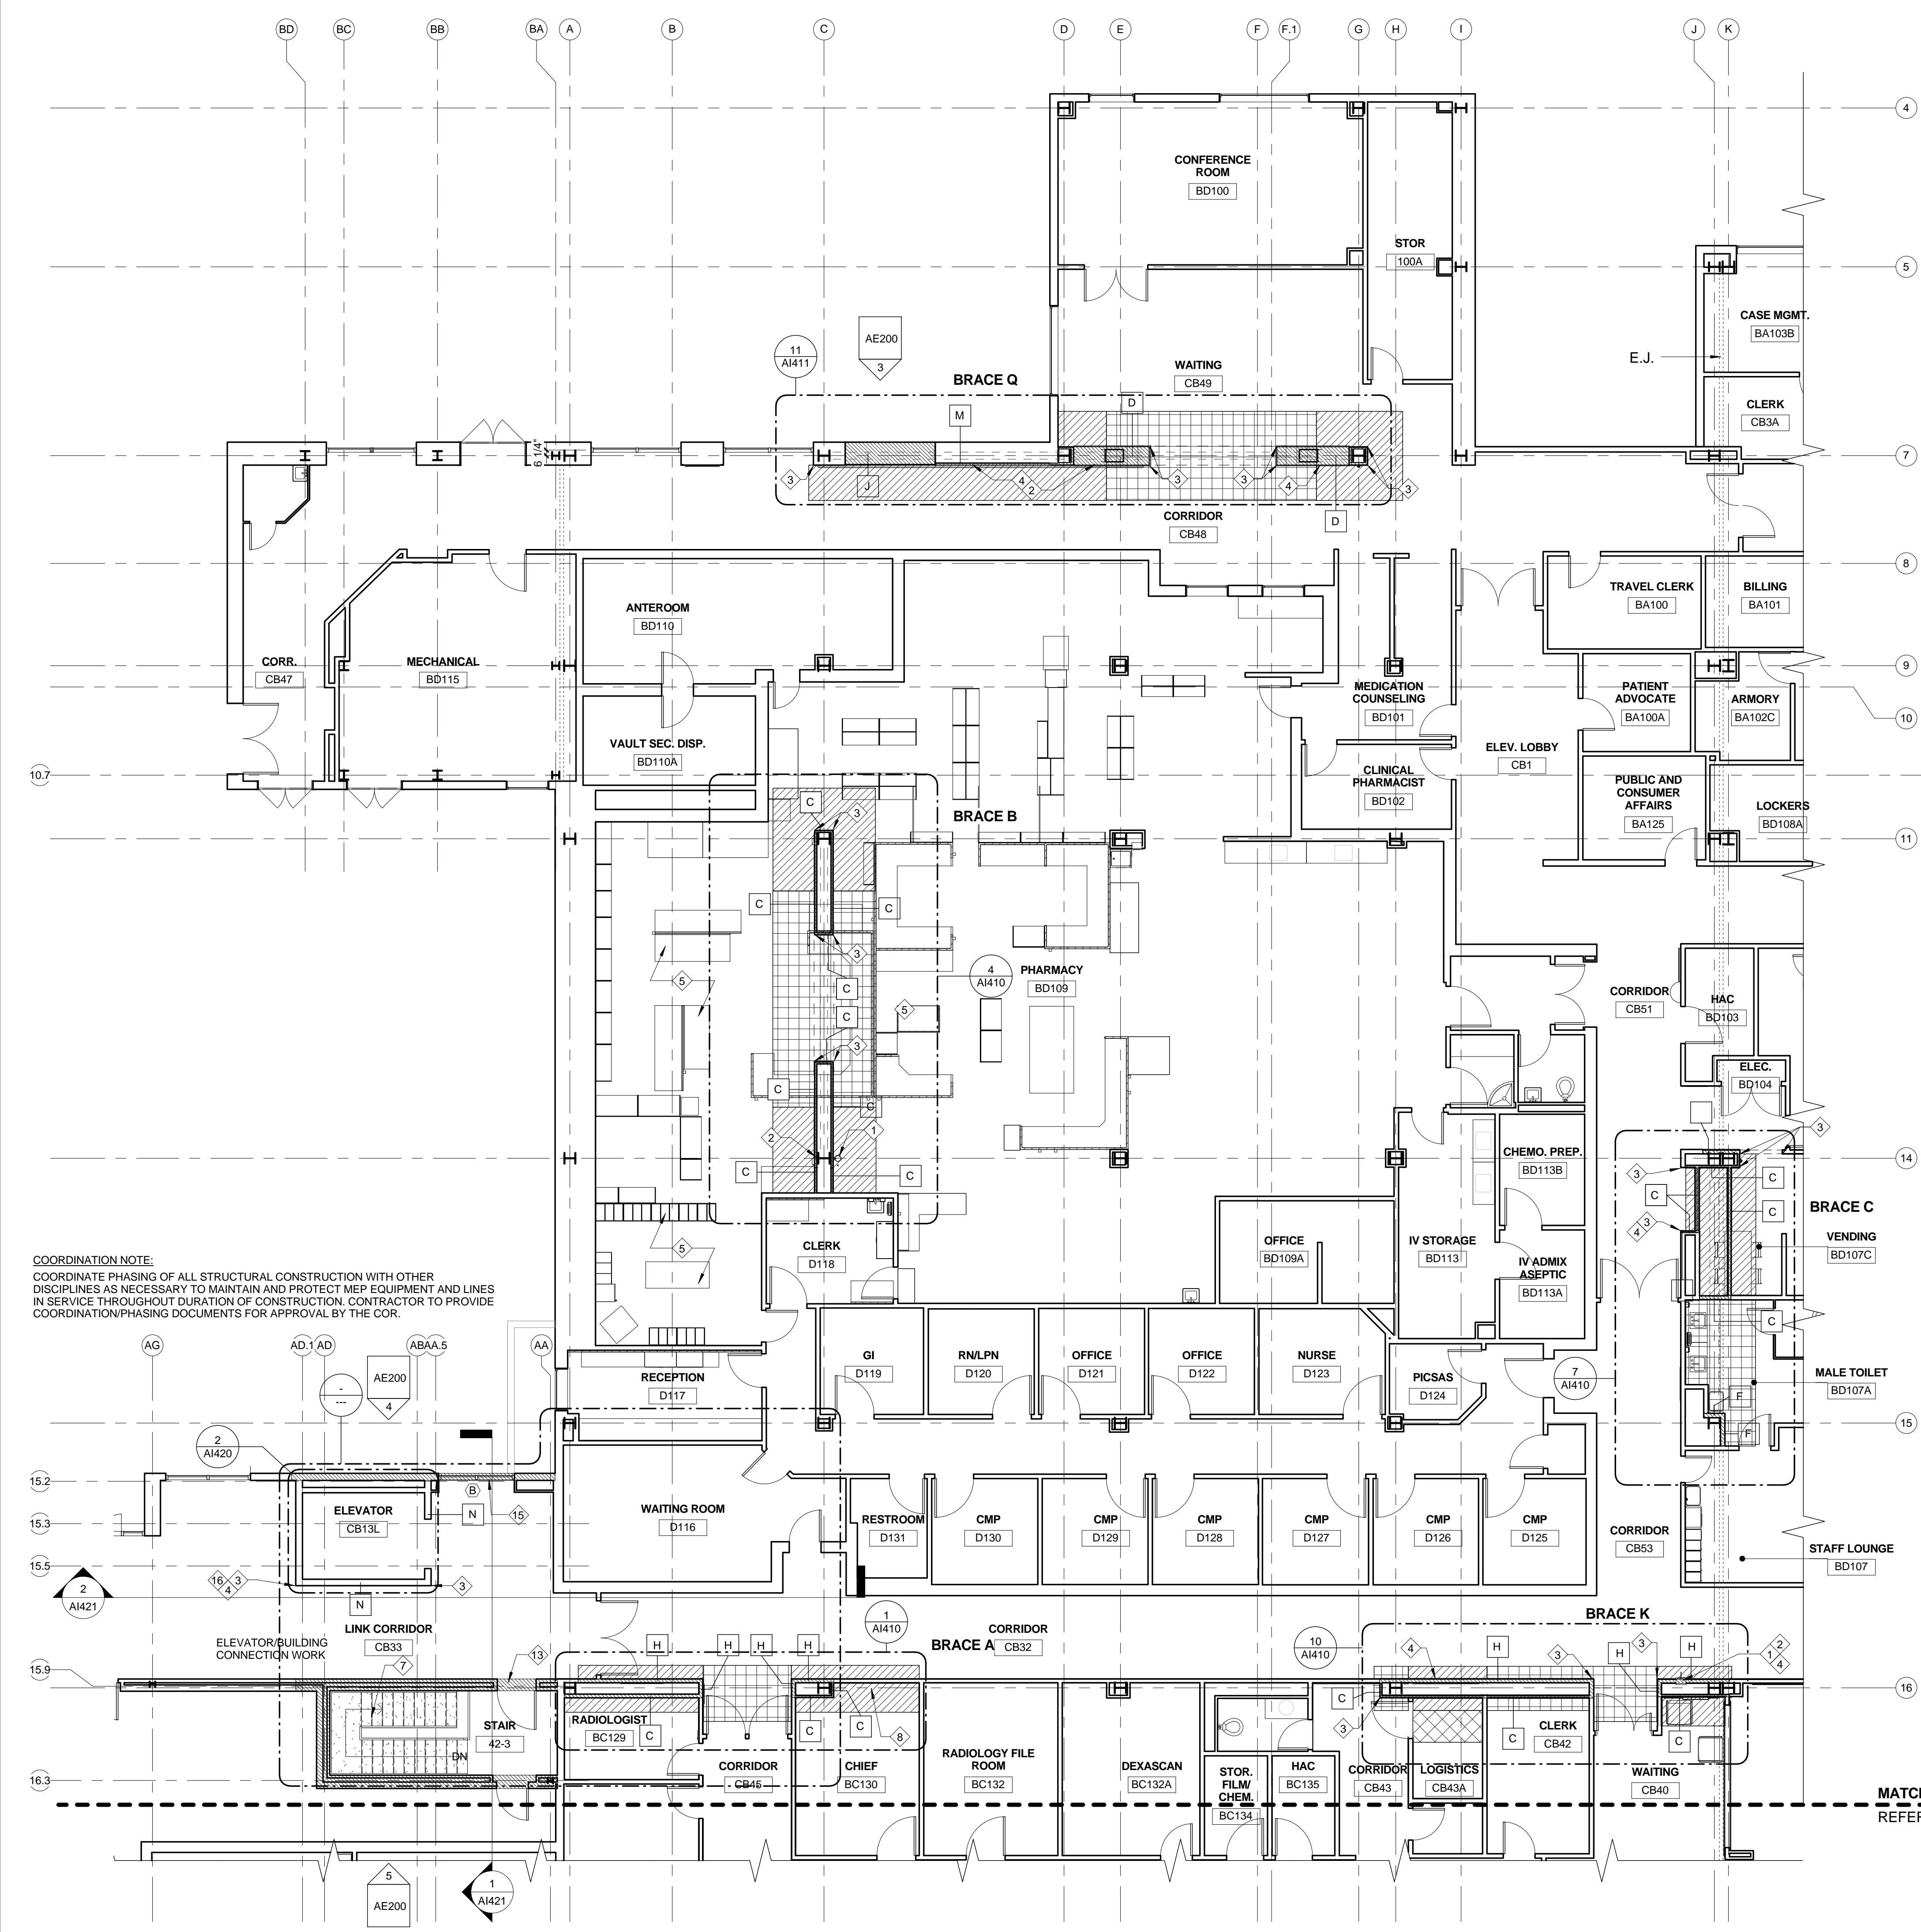


COORDINATION NOTE:
COORDINATE PHASING OF ALL STRUCTURAL CONSTRUCTION WITH OTHER DISCIPLINES AS NECESSARY TO MAINTAIN AND PROTECT MEP EQUIPMENT AND LINES IN SERVICE THROUGHOUT DURATION OF CONSTRUCTION. CONTRACTOR TO PROVIDE COORDINATION/PHASING DOCUMENTS FOR APPROVAL BY THE COR.

1 GROUND FLOOR PLAN AREA A - NEW WORK
1/8" = 1'-0"

- ### RENOVATION KEYED NOTES
1. REINSTALL SALVAGED FIRE EXTINGUISHER AND ALL ASSOCIATED HARDWARE.
 2. REINSTALL SALVAGED INTERIOR SIGNAGE.
 3. INSTALL NEW RESILIENT WALL CORNER GUARDS.
 4. REINSTALL SALVAGED WALL BUMPER GUARDS AND HANDRAILS. SUPPLEMENT WITH NEW WHERE REQUIRED. MATCH EXISTING.
 5. REINSTALL SALVAGED SYSTEMS FURNITURE COMPONENTS AS DIRECTED BY VA COR.
 6. REINSTALL EXISTING PROJECTION SCREEN.
 7. REINSTALL EXISTING METAL PAN STAIRS INCLUDING ALL ASSOCIATED RAILING AND HARDWARE.
 8. REINSTALL SALVAGED WALL MOUNTED EQUIPMENT.
 9. REINSTALL OR REPLACE PORTIONS OF CHAINLINK FENCE AND SLATS.
 10. REINSTALL BASE AND UPPER CABINETS AND SINK. COORDINATE WITH PLUMBING SHEETS FOR RELATED WORK.
 11. REINSTALL DOOR AND FRAME AT NEW LOCATION.
 12. REPAIR OPENINGS IN METAL STUD AND GYPSUM BOARD PARTITION. MATCH EXISTING STUD SIZES AND CONFIGURATION. FINISH AND PAINT GYPSUM TO MATCH ADJACENT SURFACES.
 13. REINSTALL SALVAGED DOOR SLAB AND ASSOCIATED HARDWARE.
 14. INSTALL NEW STOREFRONT WINDOW IN NEW EXTERIOR WALL.
 15. REINSTALL ALUMINUM STOREFRONT WINDOW SYSTEM.
 16. EXTEND WEST WALL OF ELEVATOR SHAFT AS INDICATED. MATCH EXISTING CONSTRUCTION.



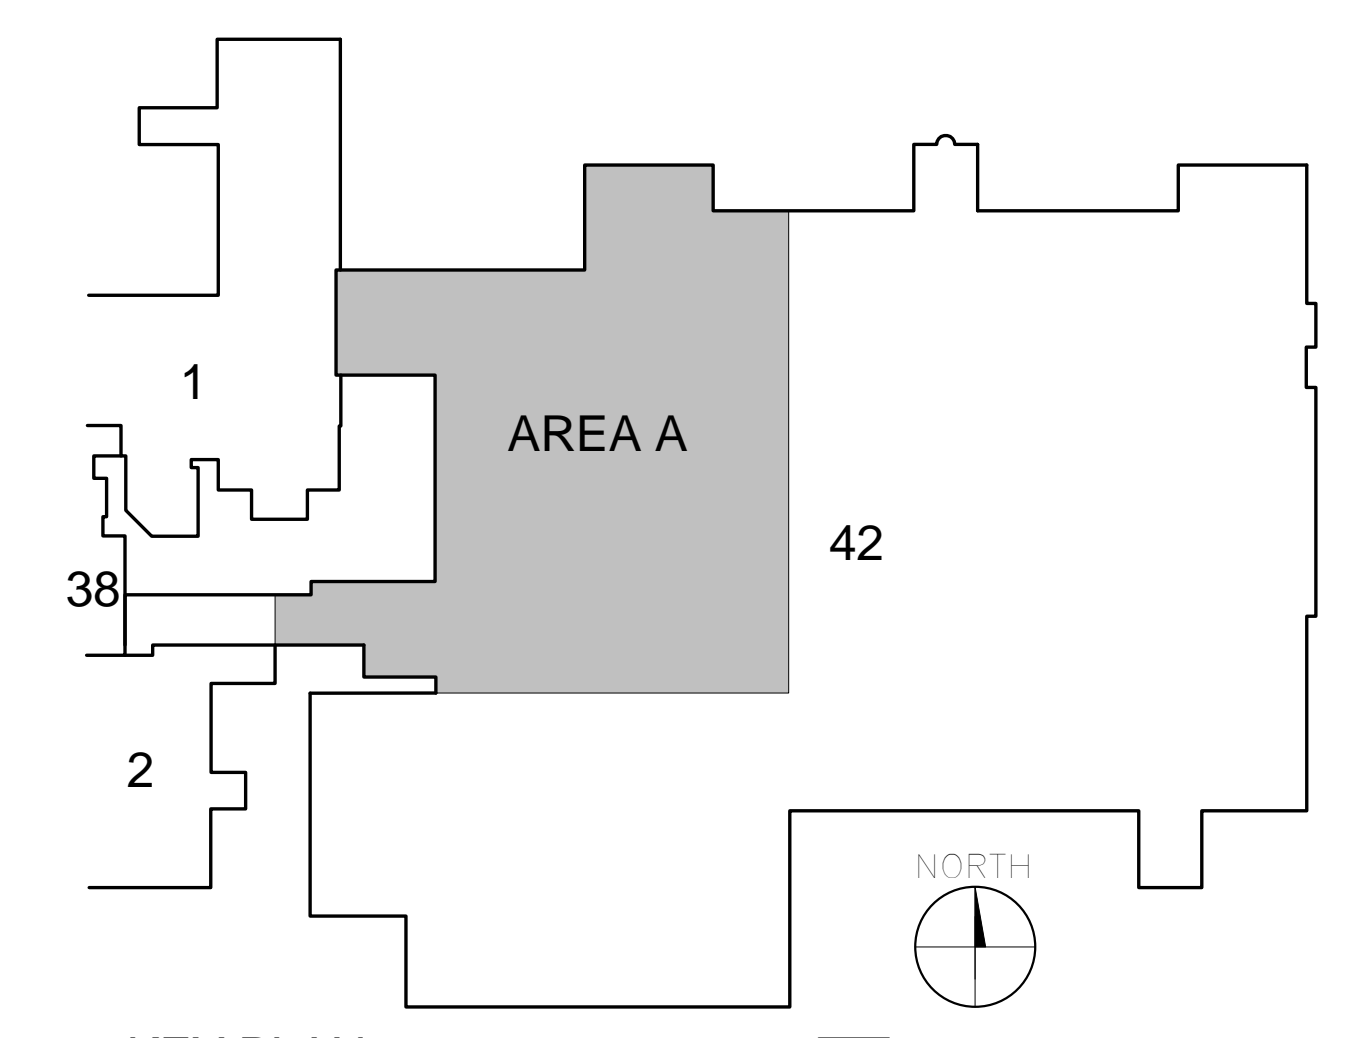


LEGEND: NEW WORK FLOOR PLAN

- INDICATES NEW PARTITION/WALL INFILL
- AREAS OF FLOOR REPLACEMENT. MATCH EXISTING.
- AREAS OF CEILING REPLACEMENT. MATCH EXISTING.
- AREAS OF FLOOR & CEILING REPLACEMENT. MATCH EXISTING.



KEY PLAN

100% BID DOCUMENTS

CONSULTANTS:  Baysinger Design Group, Inc. <small>4301 West DuPont Street, Suite 100B Metairie, Illinois 60120 Phone: 630.990.8015 Fax: 630.990.8012 Email: info@baysingerdesigngroup.com</small>		 AMERICAN STRUCTUREPOINT <small>7260 Shadeland Station, Indianapolis, IN 46256 Tel: 317.543.5500 Fax: 317.543.8270 www.structurepoint.com</small>				PROJECT MANAGER:  APOGEE <small>Consulting Group Engineers Architects www.acgp-gsa.com 919-858-7420</small> Raleigh, NC Indianapolis, IN Pittsburgh, PA Virginia Beach, VA Fort Collins, CO		Project Number 16-198	Scale AS INDICATED	Office of Construction and Facilities Management  U.S. Department of Veterans Affairs		Drawing Title: GROUND FLOOR AREA A FLOOR PLAN - RENOVATION		Project Title: ADD STRUCTURAL IMPROVEMENTS TO BUILDING 42		VA PROJECT NUMBER 657-343	
Revisions:		Date										Location MARION VAMC MARION, IL, 62959		Approved: Project Director		Drawing Number AE100	
														Date 09/06/17		Checked HKG	
																Drawn MNH	
																Dwg. 41 of 81	

A

B

C

D

E

A

B

C

D

E

KEYED NOTES

1.

REMOVE EXISTING STOREFRONT WINDOW SYSTEM IN ITS ENTIRETY. INSTALL TEMPORARY SHORING AND WEATHERPROOFING UNTIL STRUCTURAL MODIFICATIONS HAVE BEEN COMPLETED. UPON COMPLETION OF STRUCTURAL WORK, REMOVE TEMPORARY CONSTRUCTION AND INFILL REMAINING OPENING TO MATCH EXISTING ADJACENT WALL CONSTRUCTION. REFER TO SHEET A1600 FOR PARTITION DETAILS.
2.

REMOVE AND REPLACE PORTIONS OF EXISTING WALL CONSTRUCTION TO THE EXTENT REQUIRED TO COMPLETE STRUCTURAL MODIFICATIONS. INFILL TO MATCH EXISTING ADJACENT CONSTRUCTION. REFER TO SHEET A1600 FOR PARTITION DETAILS.
3.

REMOVE ONE LEAF OF EXISTING DOUBLE DOORS AND SALVAGE FOR REINSTALLATION. REPLACE REMOVED LEAF WITH TEMPORARY LOUVER PER MECHANICAL DRAWINGS. UPON COMPLETION OF STRUCTURAL MODIFICATIONS, REMOVE TEMPORARY LOUVER AND REINSTALL EXISTING DOOR LEAF. PREP, PRIME, AND PAINT DOORS AND FRAME IN THEIR ENTIRETY INCLUDING INTERIOR AND EXTERIOR.
4.

REMOVE AND REINSTALL PORTIONS OF EXISTING CHAINLINK FENCE AND VINYL FENCE SLATS TO THE EXTENT REQUIRED TO COMPLETE STRUCTURAL MODIFICATIONS.
5.

REMOVE EXISTING EXTERIOR WALL SYSTEM IN ITS ENTIRETY. COORDINATE WITH STRUCTURAL FOR REMOVAL OF STRUCTURAL COMPONENTS. INSTALL TEMPORARY SHORING AND WEATHERPROOFING UNTIL STRUCTURAL MODIFICATIONS AND NEW WALL CONSTRUCTION IS COMPLETE.
6.

REMOVE EXISTING STOREFRONT WINDOW SYSTEM AND SALVAGE FOR REINSTALLATION AT INDICATED LOCATION. RE: FLOOR PLAN FOR NEW LOCATION.
7.

REMOVE EXISTING METAL DOOR, FRAME, AND HARDWARE AND SALVAGE FOR REINSTALLATION.
8.

REMOVE EXISTING SLOPED GLAZING STRUCTURE AND SALVAGE FOR REINSTALLATION. CONTRACTOR'S OPTION: LEAVE GLAZED STRUCTURE IN PLACE AND PROVIDE TEMPORARY SHORING FOR THE DURATION OF CONSTRUCTION IN AREAS OF REQUIRED WALL DEMOLITION.

COORDINATION NOTE:
COORDINATE PHASING OF ALL STRUCTURAL CONSTRUCTION WITH OTHER DISCIPLINES AS NECESSARY TO MAINTAIN AND PROTECT MEP EQUIPMENT AND LINES IN SERVICE THROUGHOUT DURATION OF CONSTRUCTION. CONTRACTOR TO PROVIDE COORDINATION/PHASING DOCUMENTS FOR APPROVAL BY THE COR.

LEGEND:

- INDICATES AREAS OF BUILDING ENVELOPE REMOVAL AND REPLACEMENT
- EXISTING CHAINLINK FENCE

100% BID DOCUMENTS

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EXPIRES 11-30-18

PROJECT MANAGER:

Project Number
16-198

Scale
AS INDICATED



Raleigh, NC
Indianapolis, IN
Pittsburgh, PA
Virginia Beach, VA
Fort Collins, CO

Office of
Construction
and Facilities
Management



U.S. Department
of Veterans Affairs

Drawing Title:

EXTERIOR BUILDING ELEVATIONS

Location

MARION VAMC
MARION, IL, 62959

Project Title:

ADD STRUCTURAL
IMPROVEMENTS TO BUILDING
42

Approved: Project Director

Date
09/06/17

Checked
HKG

Drawn
MNH


VA PROJECT NUMBER
657-343

Building Number
42

Drawing Number

AE200

Dwg. 43 of 81

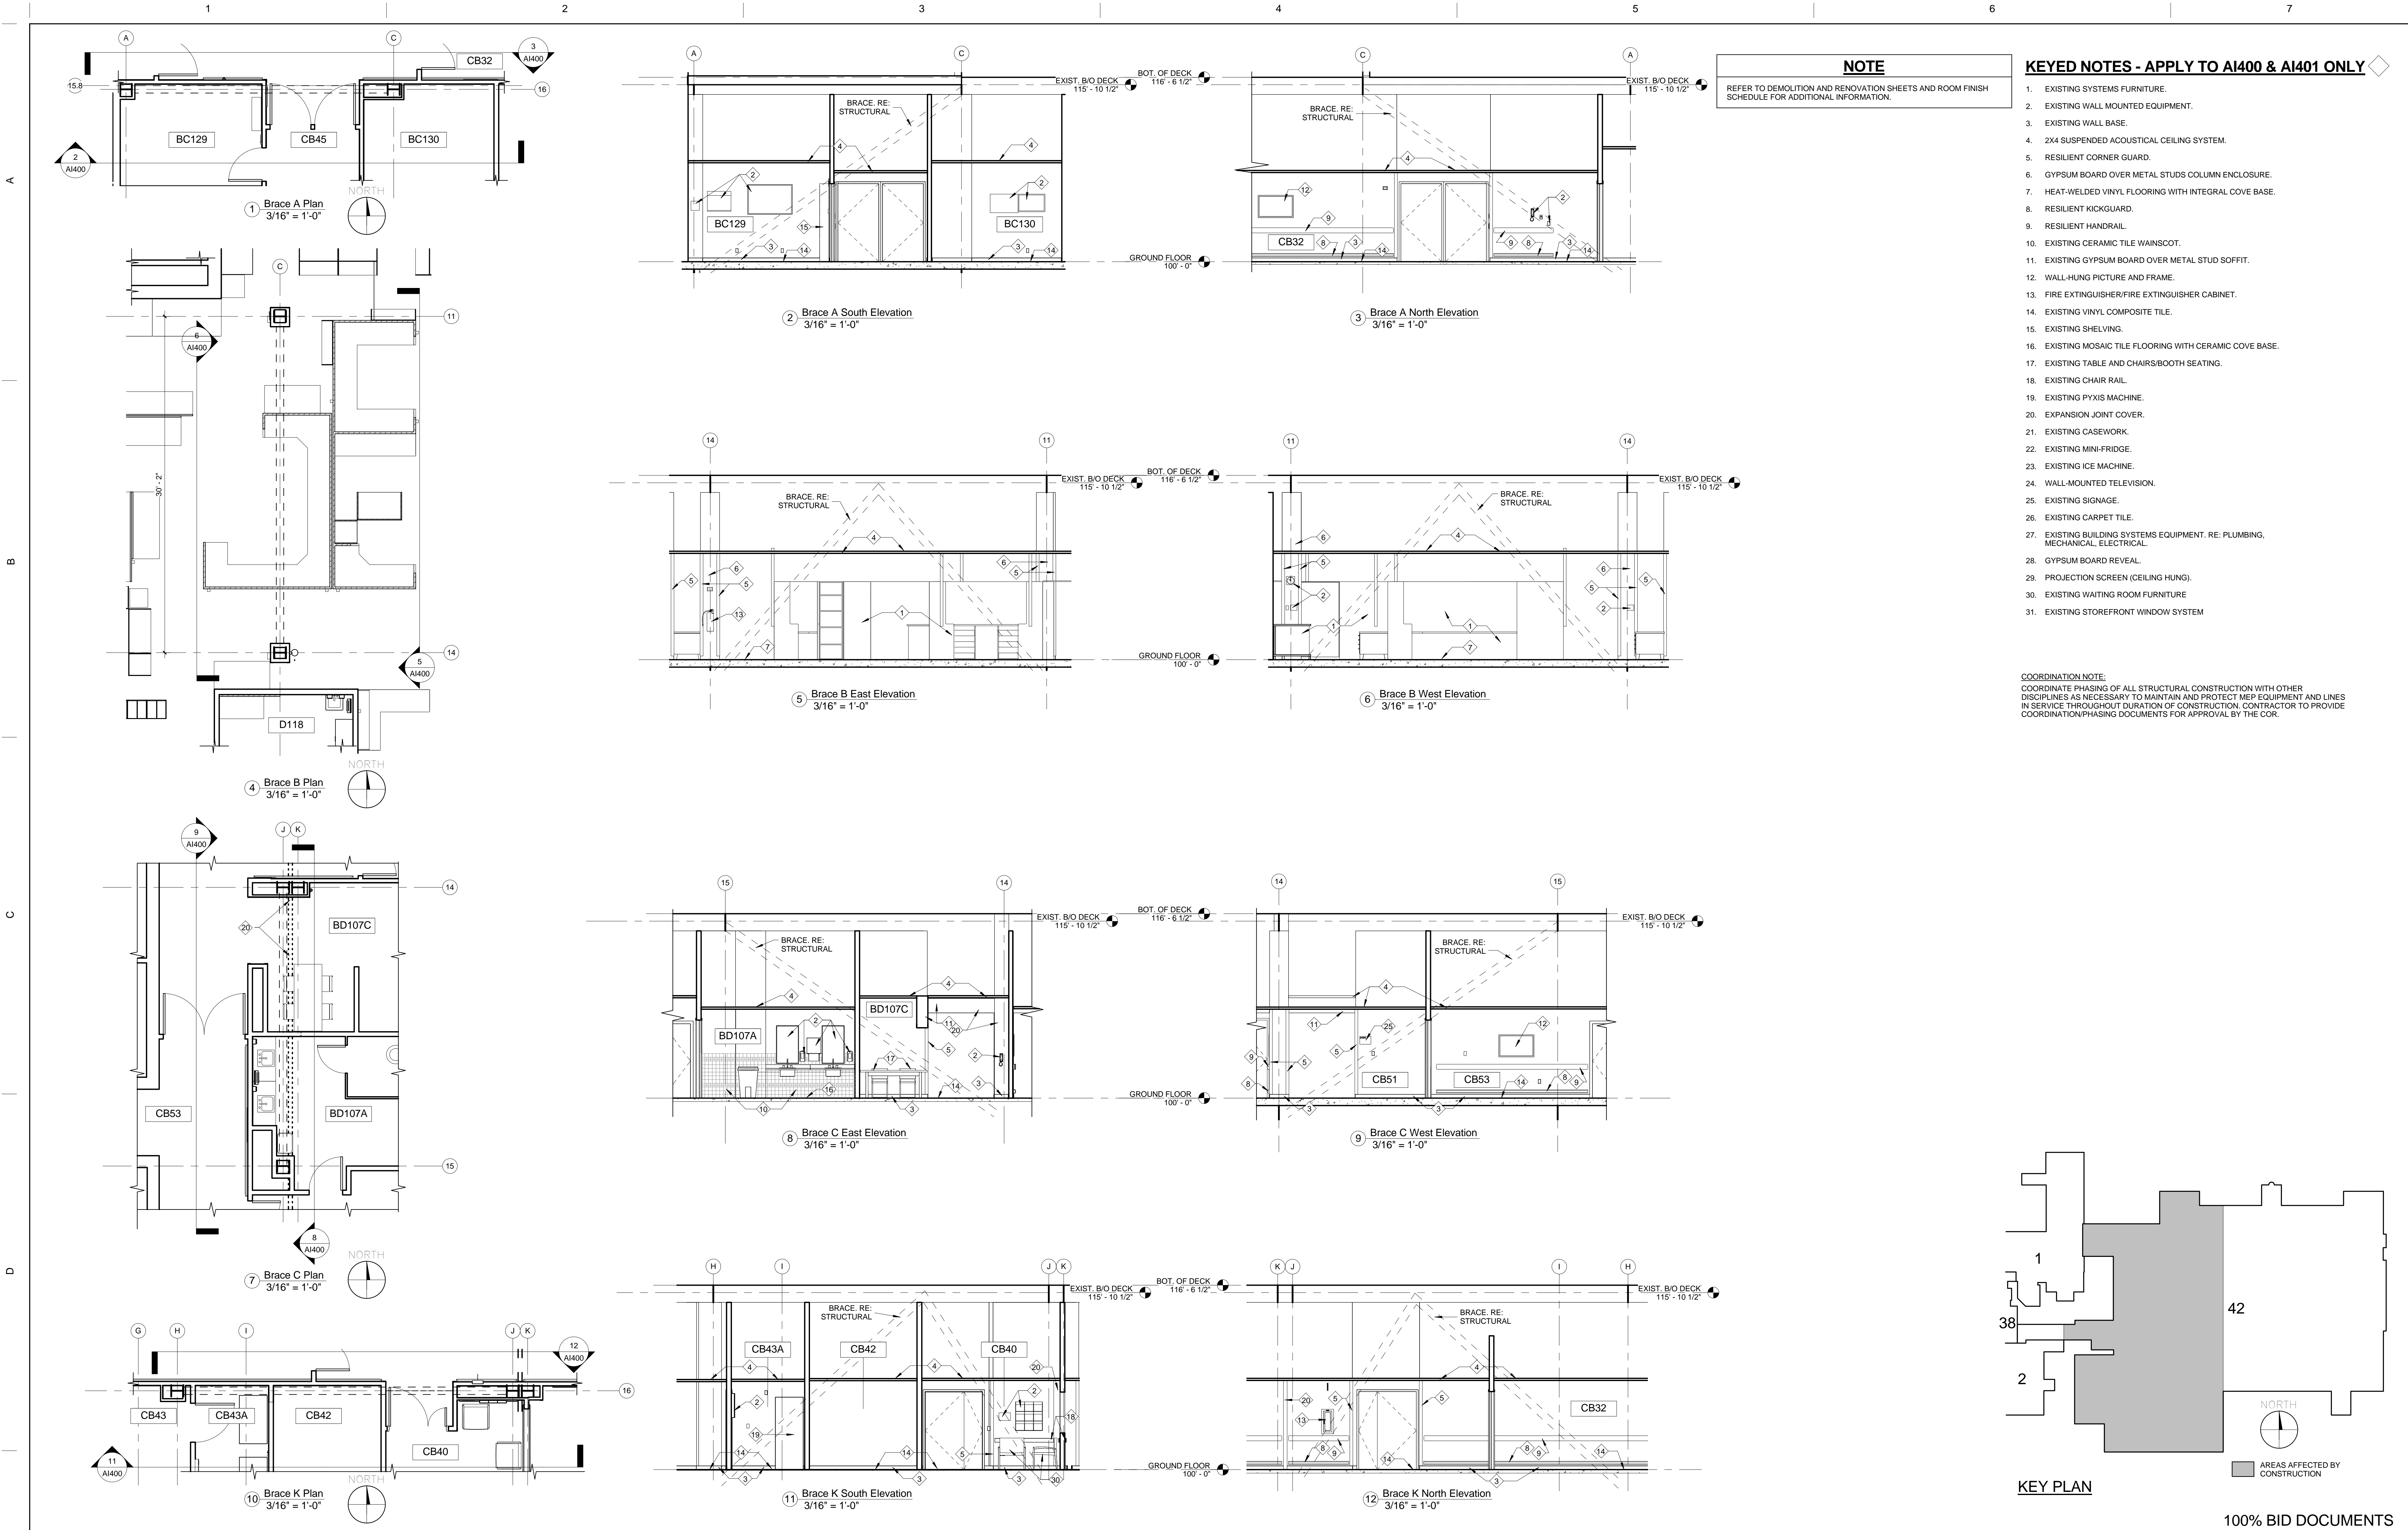

KEYED NOTES - APPLY TO AI400 & AI401 ONLY

1. EXISTING SYSTEMS FURNITURE.
2. EXISTING WALL MOUNTED EQUIPMENT.
3. EXISTING WALL BASE.
4. 2X4 SUSPENDED ACOUSTICAL CEILING SYSTEM.
5. RESILIENT CORNER GUARD.
6. GYPSUM BOARD OVER METAL STUDS COLUMN ENCLOSURE.
7. HEAT-WELDED VINYL FLOORING WITH INTEGRAL COVE BASE.
8. RESILIENT KICKGUARD.
9. RESILIENT HANDRAIL.
10. EXISTING CERAMIC TILE WAINSCOT.
11. EXISTING GYPSUM BOARD OVER METAL STUD SOFFIT.
12. WALL-HUNG PICTURE AND FRAME.
13. FIRE EXTINGUISHER/FIRE EXTINGUISHER CABINET.
14. EXISTING VINYL COMPOSITE TILE.
15. EXISTING SHELVEING.
16. EXISTING MOSAIC TILE FLOORING WITH CERAMIC COVE BASE.
17. EXISTING TABLE AND CHAIRS/BOOTH SEATING.
18. EXISTING CHAIR RAIL.
19. EXISTING PYXIS MACHINE.
20. EXPANSION JOINT COVER.
21. EXISTING CASEWORK.
22. EXISTING MINI-FRIDGE.
23. EXISTING ICE MACHINE.
24. WALL-MOUNTED TELEVISION.
25. EXISTING SIGNAGE.
26. EXISTING CARPET TILE.
27. EXISTING BUILDING SYSTEMS EQUIPMENT: RE: PLUMBING, MECHANICAL, ELECTRICAL.
28. GYPSUM BOARD REVEAL.
29. PROJECTION SCREEN (CEILING HUNG).
30. EXISTING WAITING ROOM FURNITURE.
31. EXISTING STOREFRONT WINDOW SYSTEM.

COORDINATION NOTE:
COORDINATE PHASING OF ALL STRUCTURAL CONSTRUCTION WITH OTHER DISCIPLINES AS NECESSARY TO MAINTAIN AND PROTECT MEP EQUIPMENT AND LINES IN SERVICE THROUGHOUT DURATION OF CONSTRUCTION. CONTRACTOR TO PROVIDE COORDINATION/PHASING DOCUMENTS FOR APPROVAL BY THE COR.

KEY PLAN

100% BID DOCUMENTS

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SEAL OF ILLINOIS
Shirley A. Baysinger
REGISTERED ARCHITECT
EXPIRES 11-30-18

PROJECT MANAGER:

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Raleigh, NC
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Pittsburgh, PA
Virginia Beach, VA
Fort Collins, CO

Project Number
16-198

Scale
AS INDICATED

Office of
Construction
and Facilities
Management



U.S. Department
of Veterans Affairs

Drawing Title:

ENLARGED PLANS AND INTERIOR
ELEVATIONS - EXG. CONDITIONS

Location

MARION VAMC
MARION, IL, 62959

Project Title:

ADD STRUCTURAL
IMPROVEMENTS TO BUILDING
42

Approved: Project Director

Date
09/06/17

Checked
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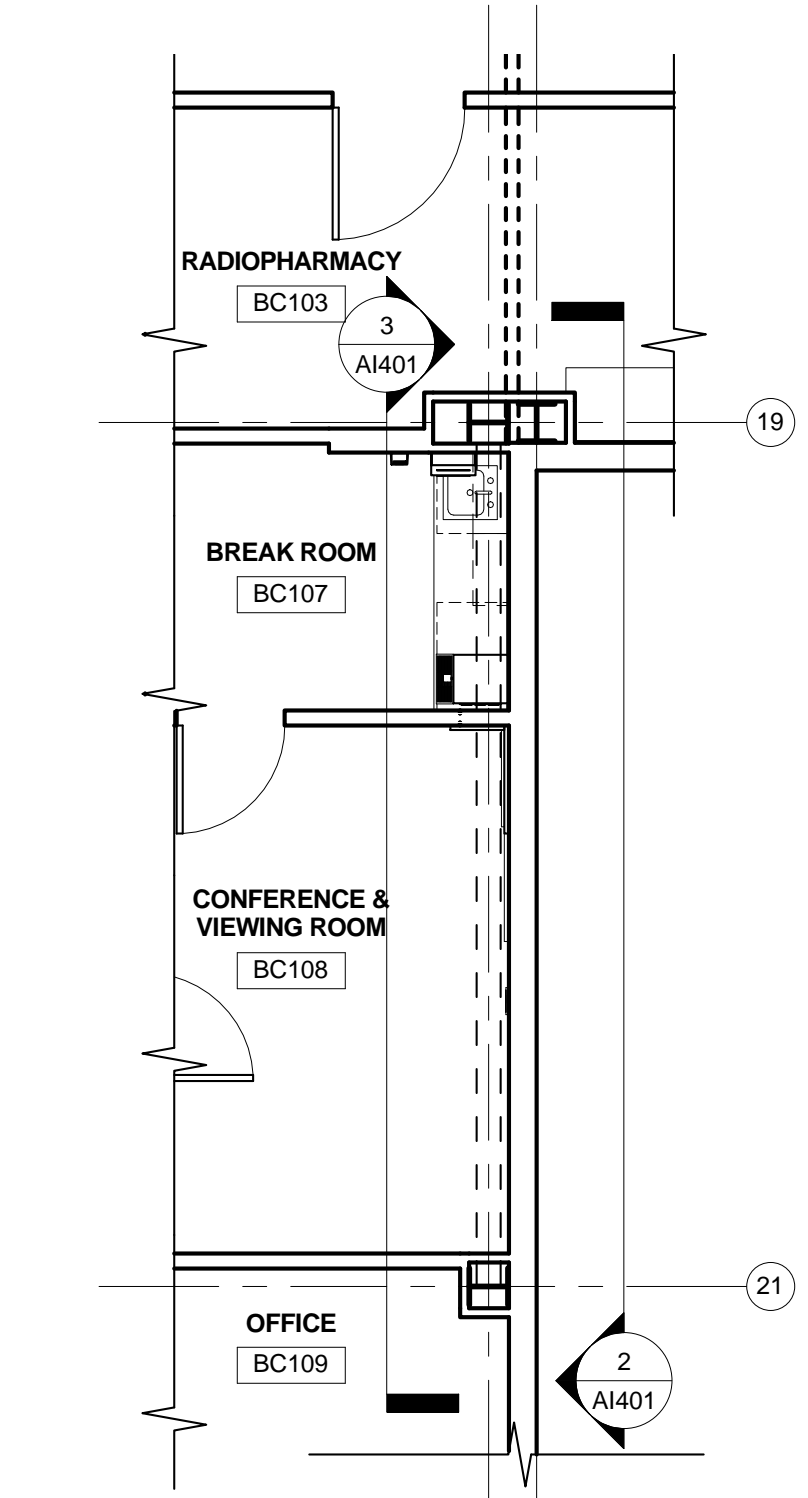
VA PROJECT NUMBER
657-343

Building Number
42


Drawing Number

AI400


Dwg. 44 of 81




1 Brace L Plan
3/16" = 1'-0"

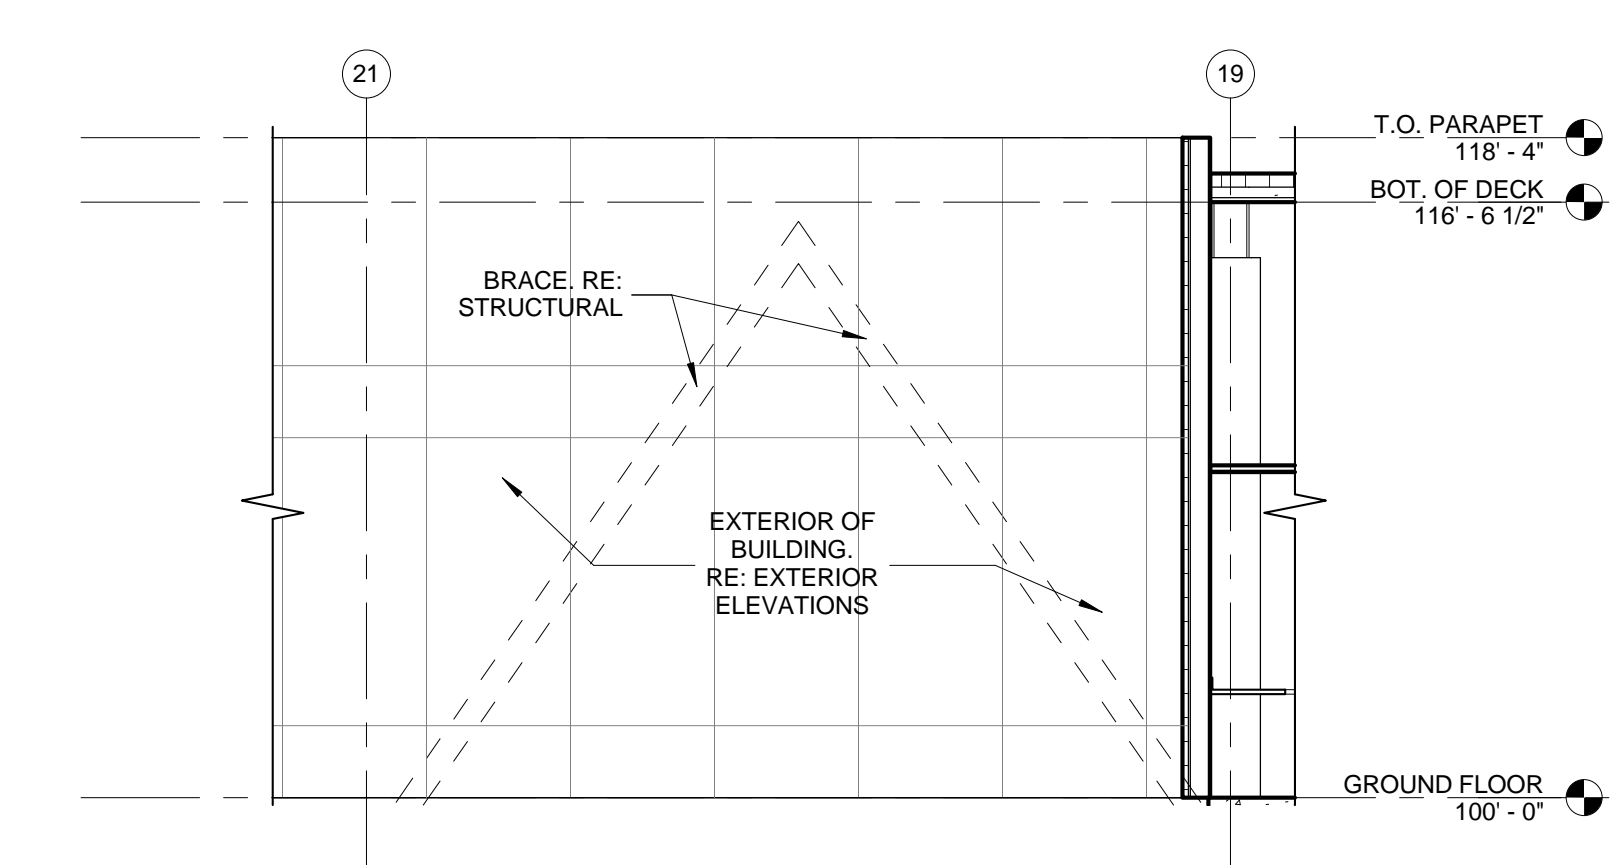


2 Brace L East Elevation
3/16" = 1'-0"

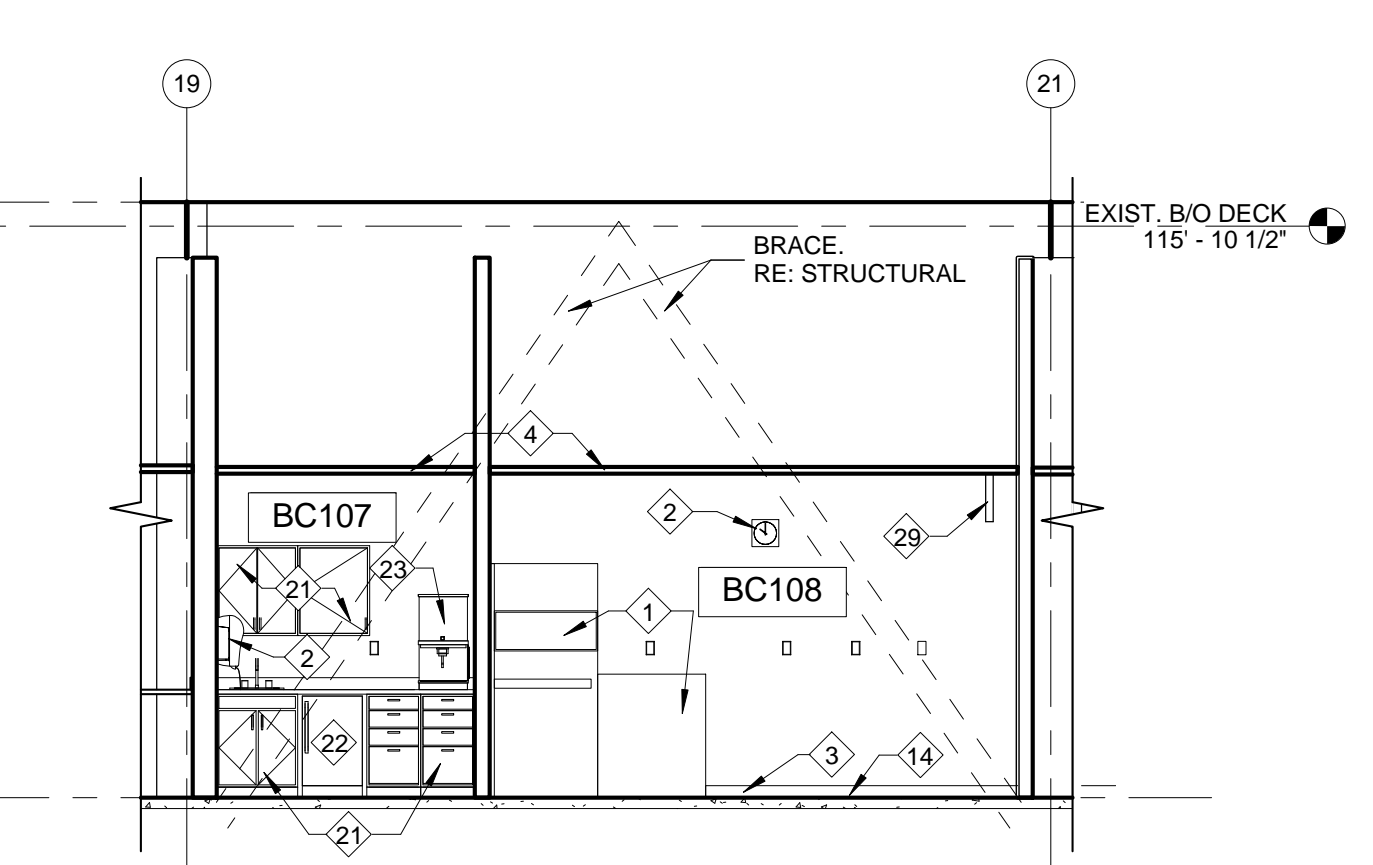


3 Brace L West Elevation
3/16" = 1'-0"

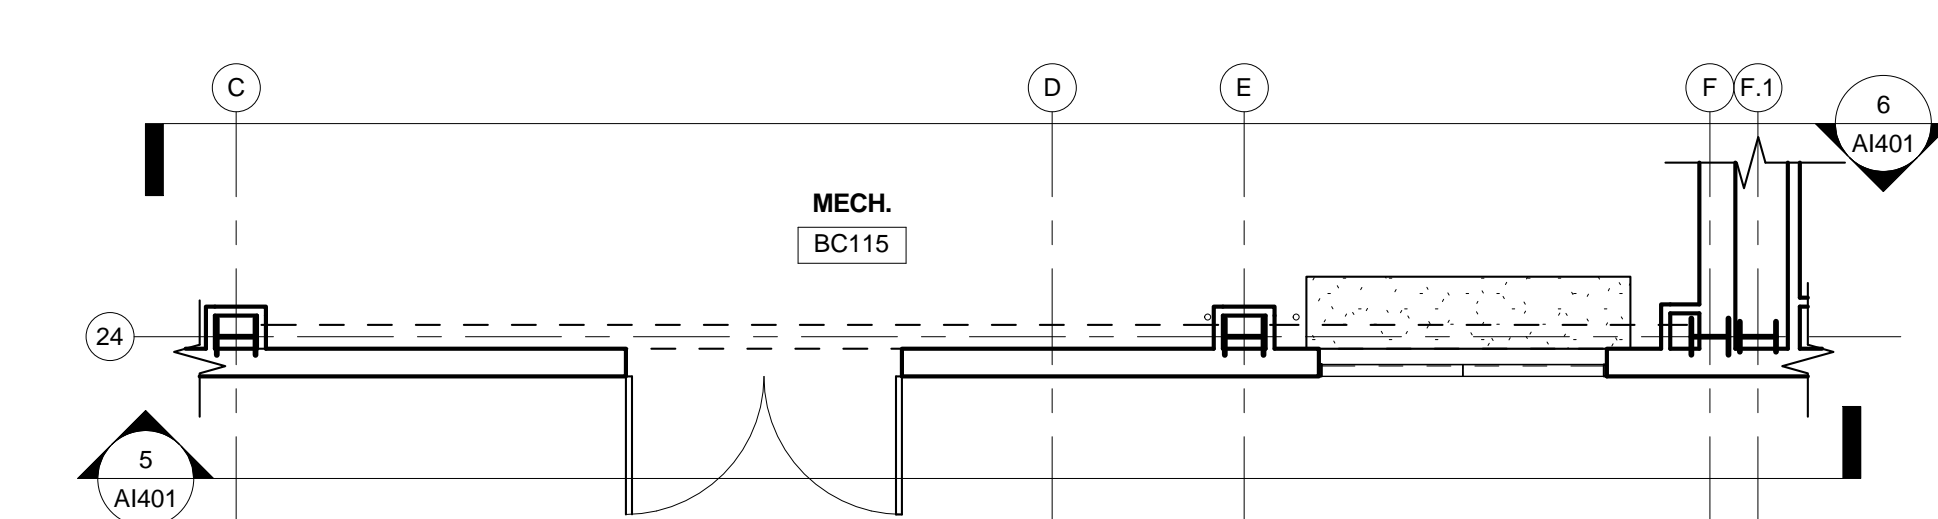


4 Brace M Plan
3/16" = 1'-0"

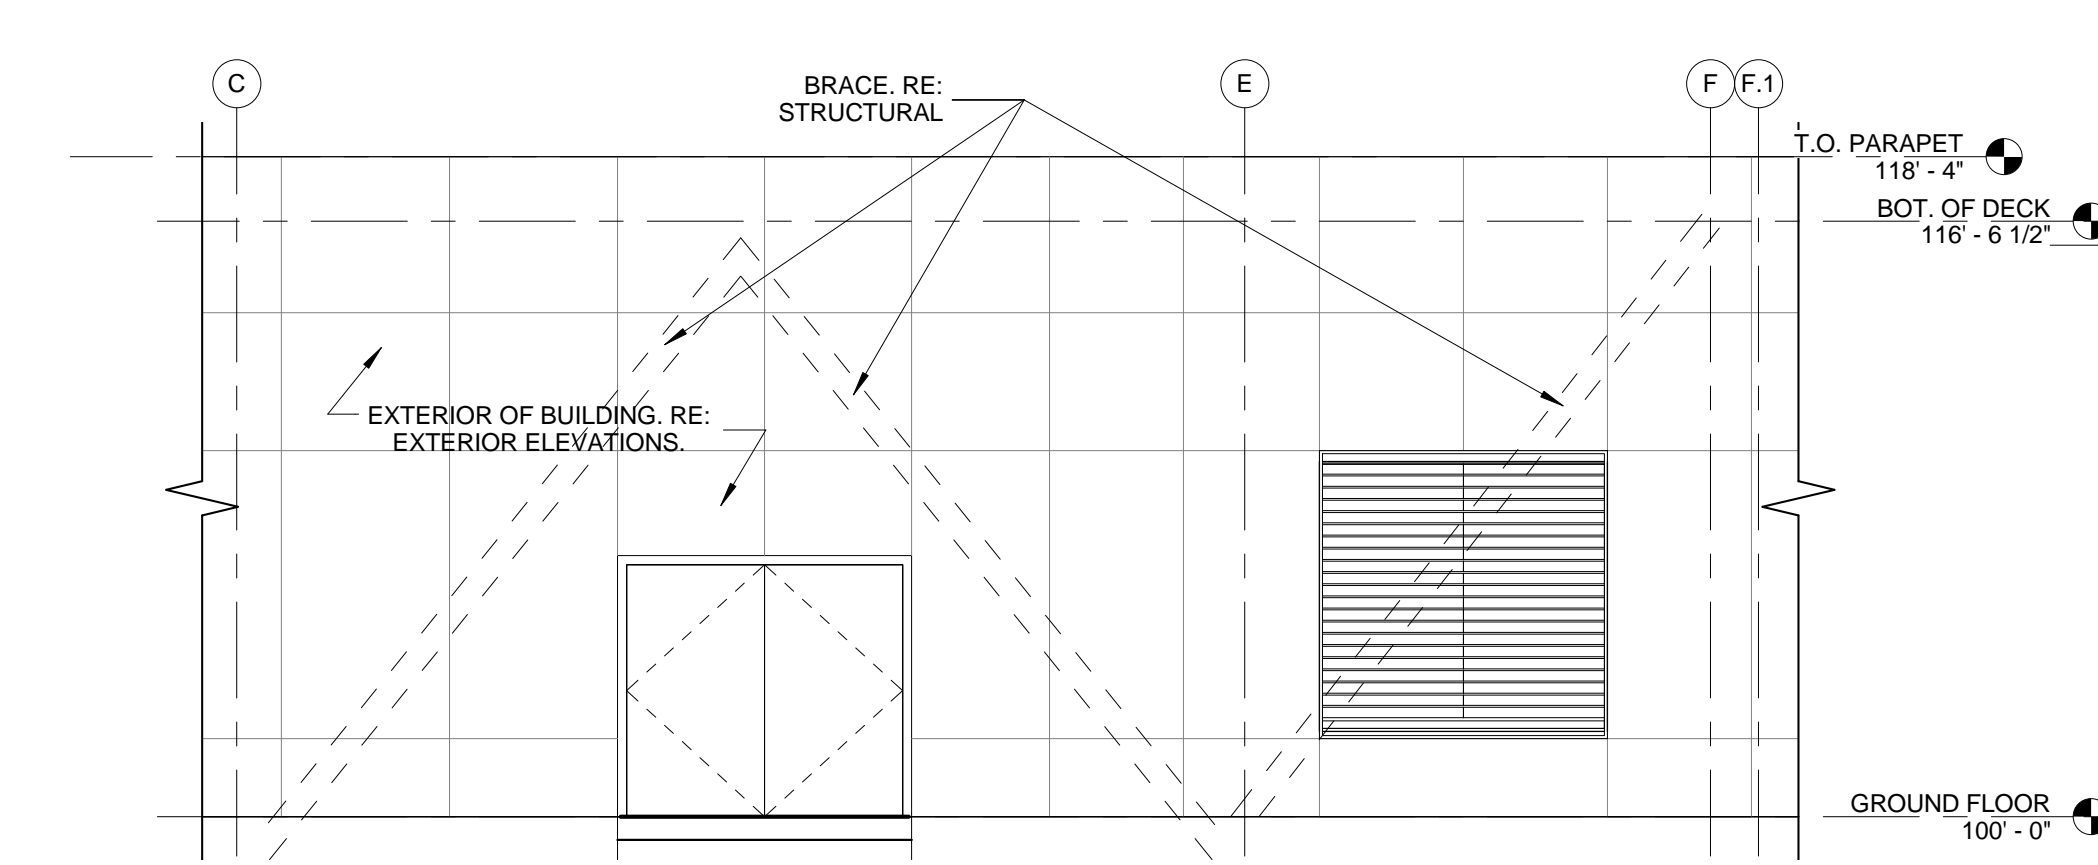

5 Brace M South Elevation
3/16" = 1'-0"

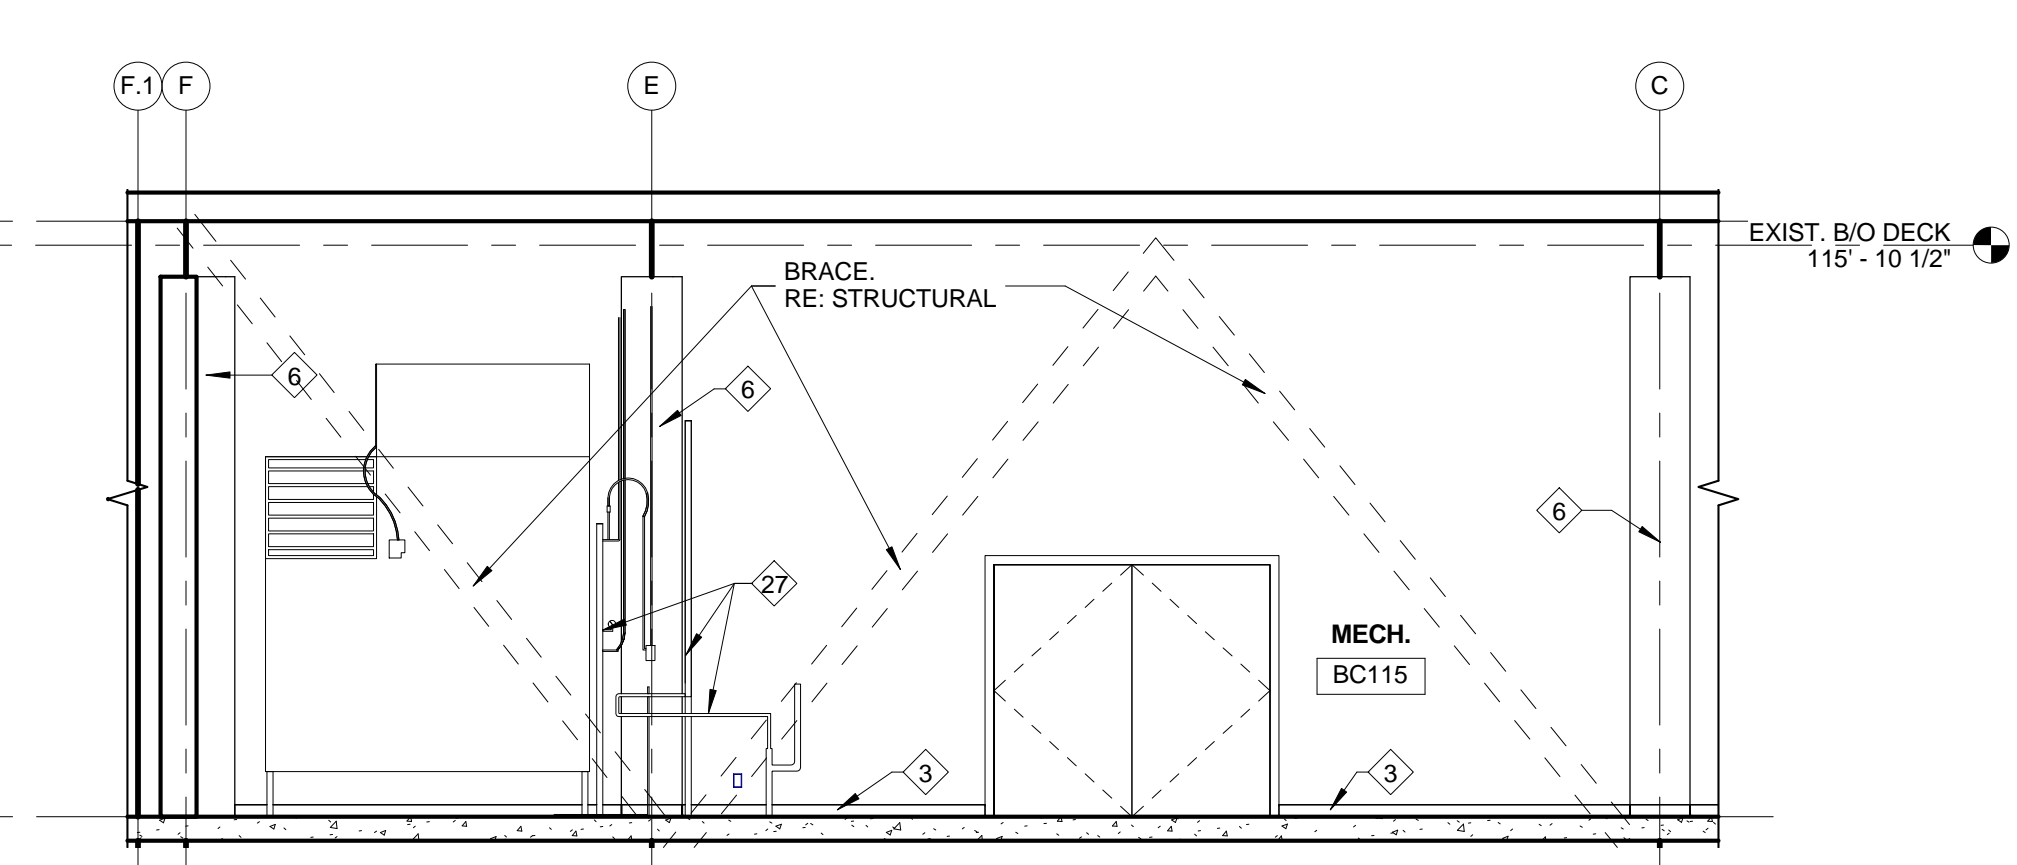


6 Brace M North Elevation
3/16" = 1'-0"

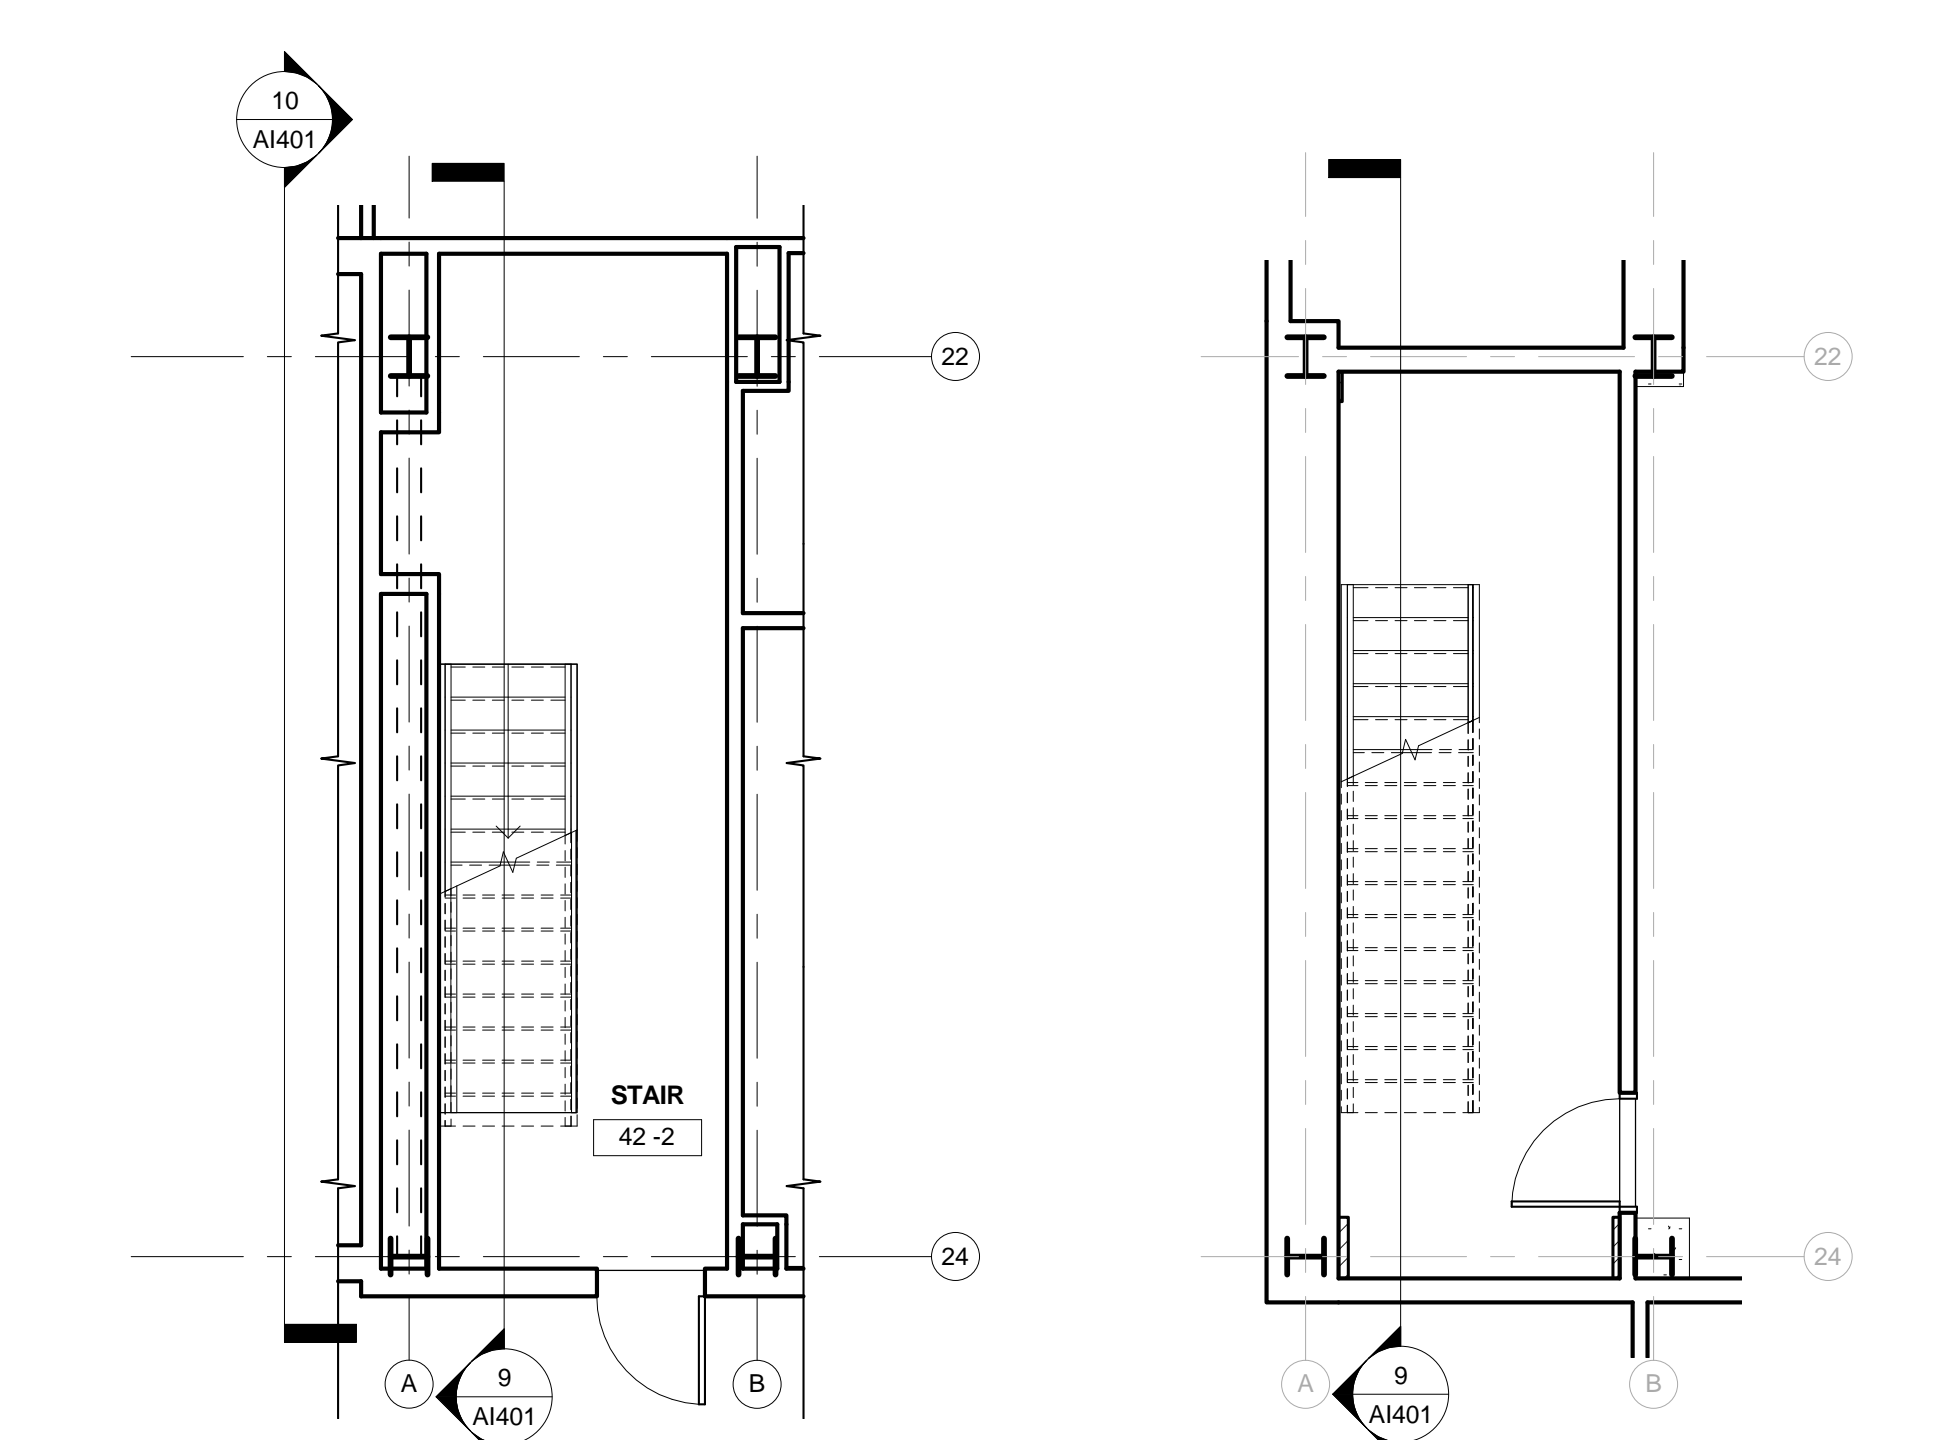


7 Brace N Plan - GROUND FLOOR LEVEL
3/16" = 1'-0"


8 BRACE N PLAN - SUB-BASEMENT LEVEL
3/16" = 1'-0"

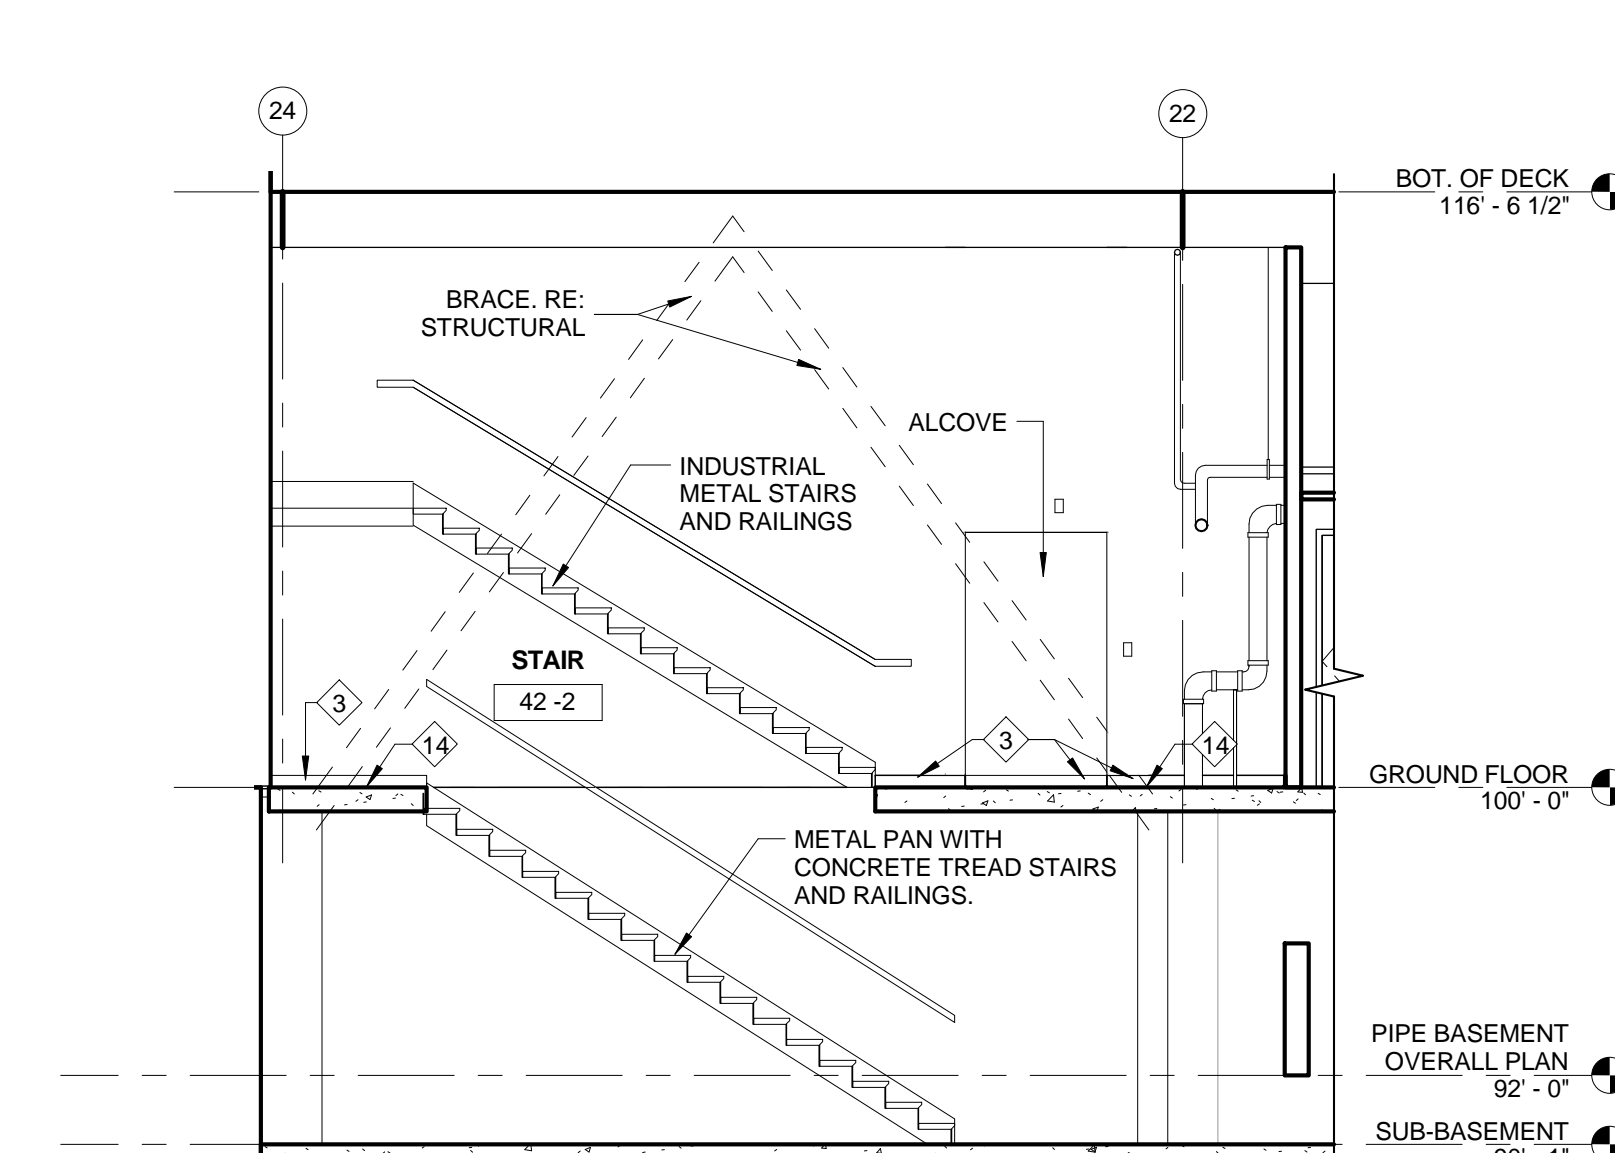


9 Brace N East Elevation
3/16" = 1'-0"

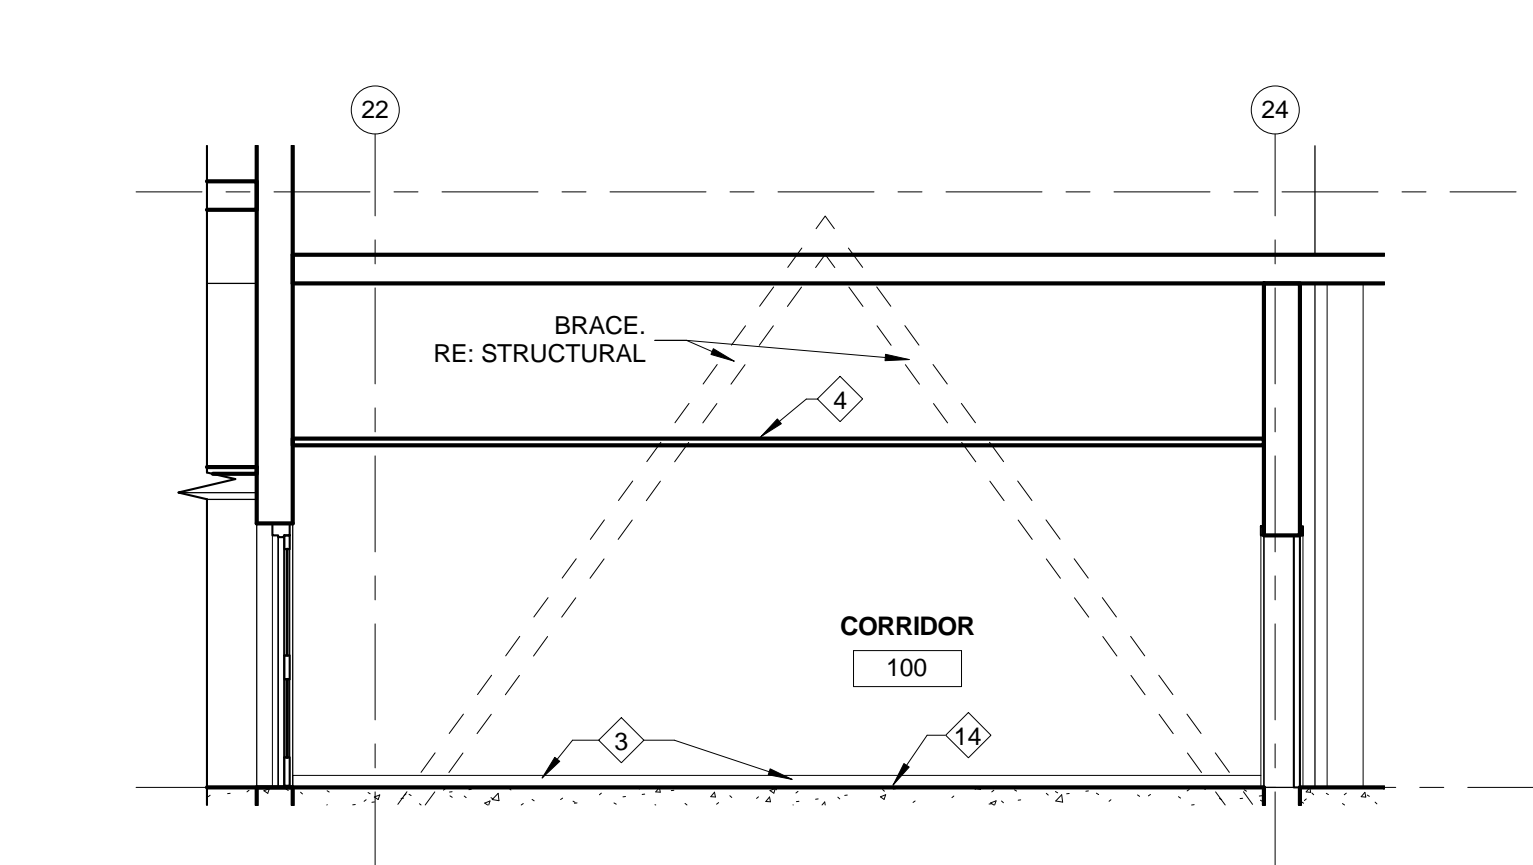


10 Brace N West Elevation
3/16" = 1'-0"

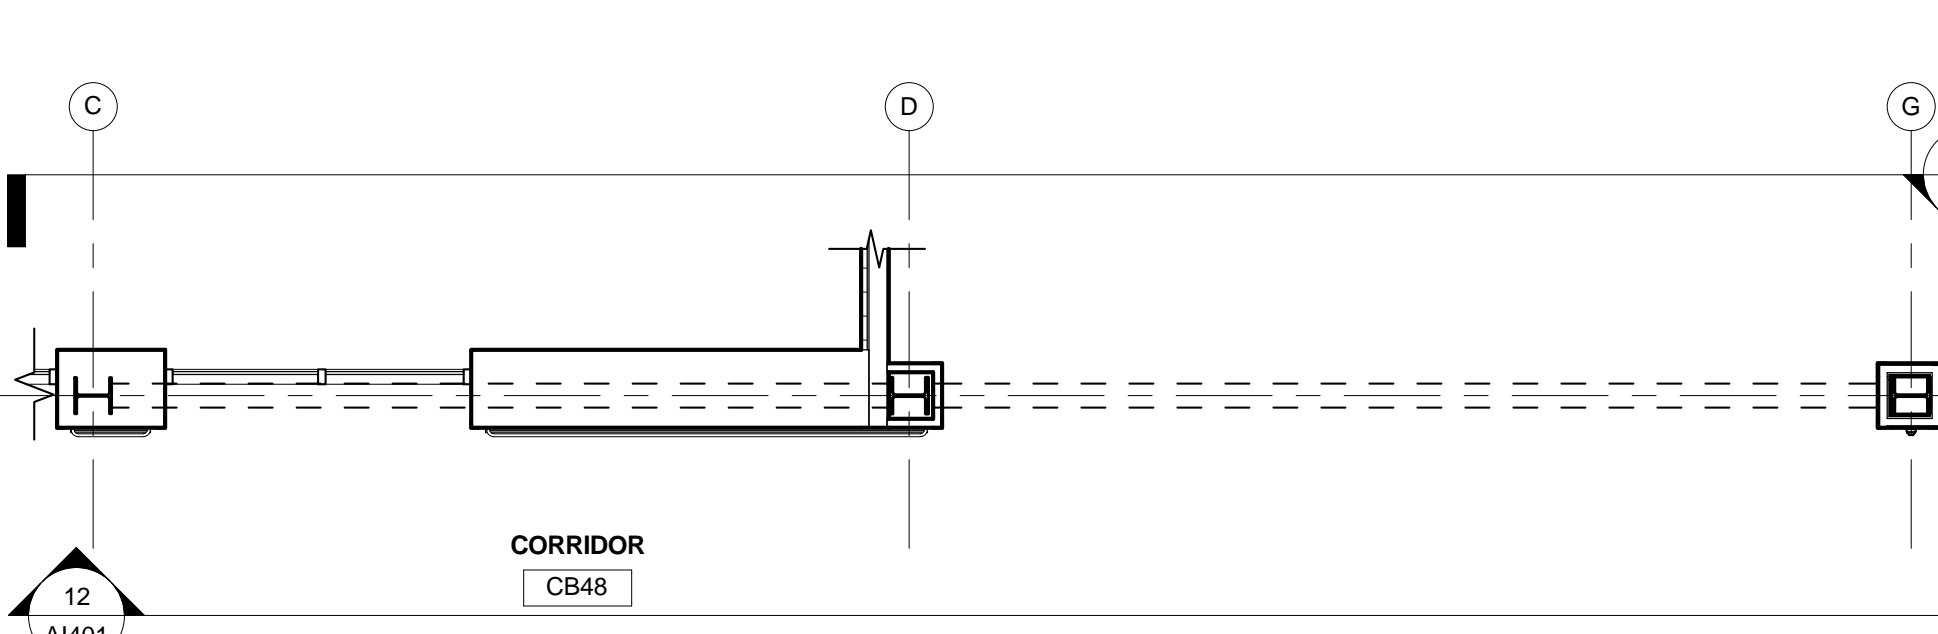

11 Brace Q Plan
3/16" = 1'-0"

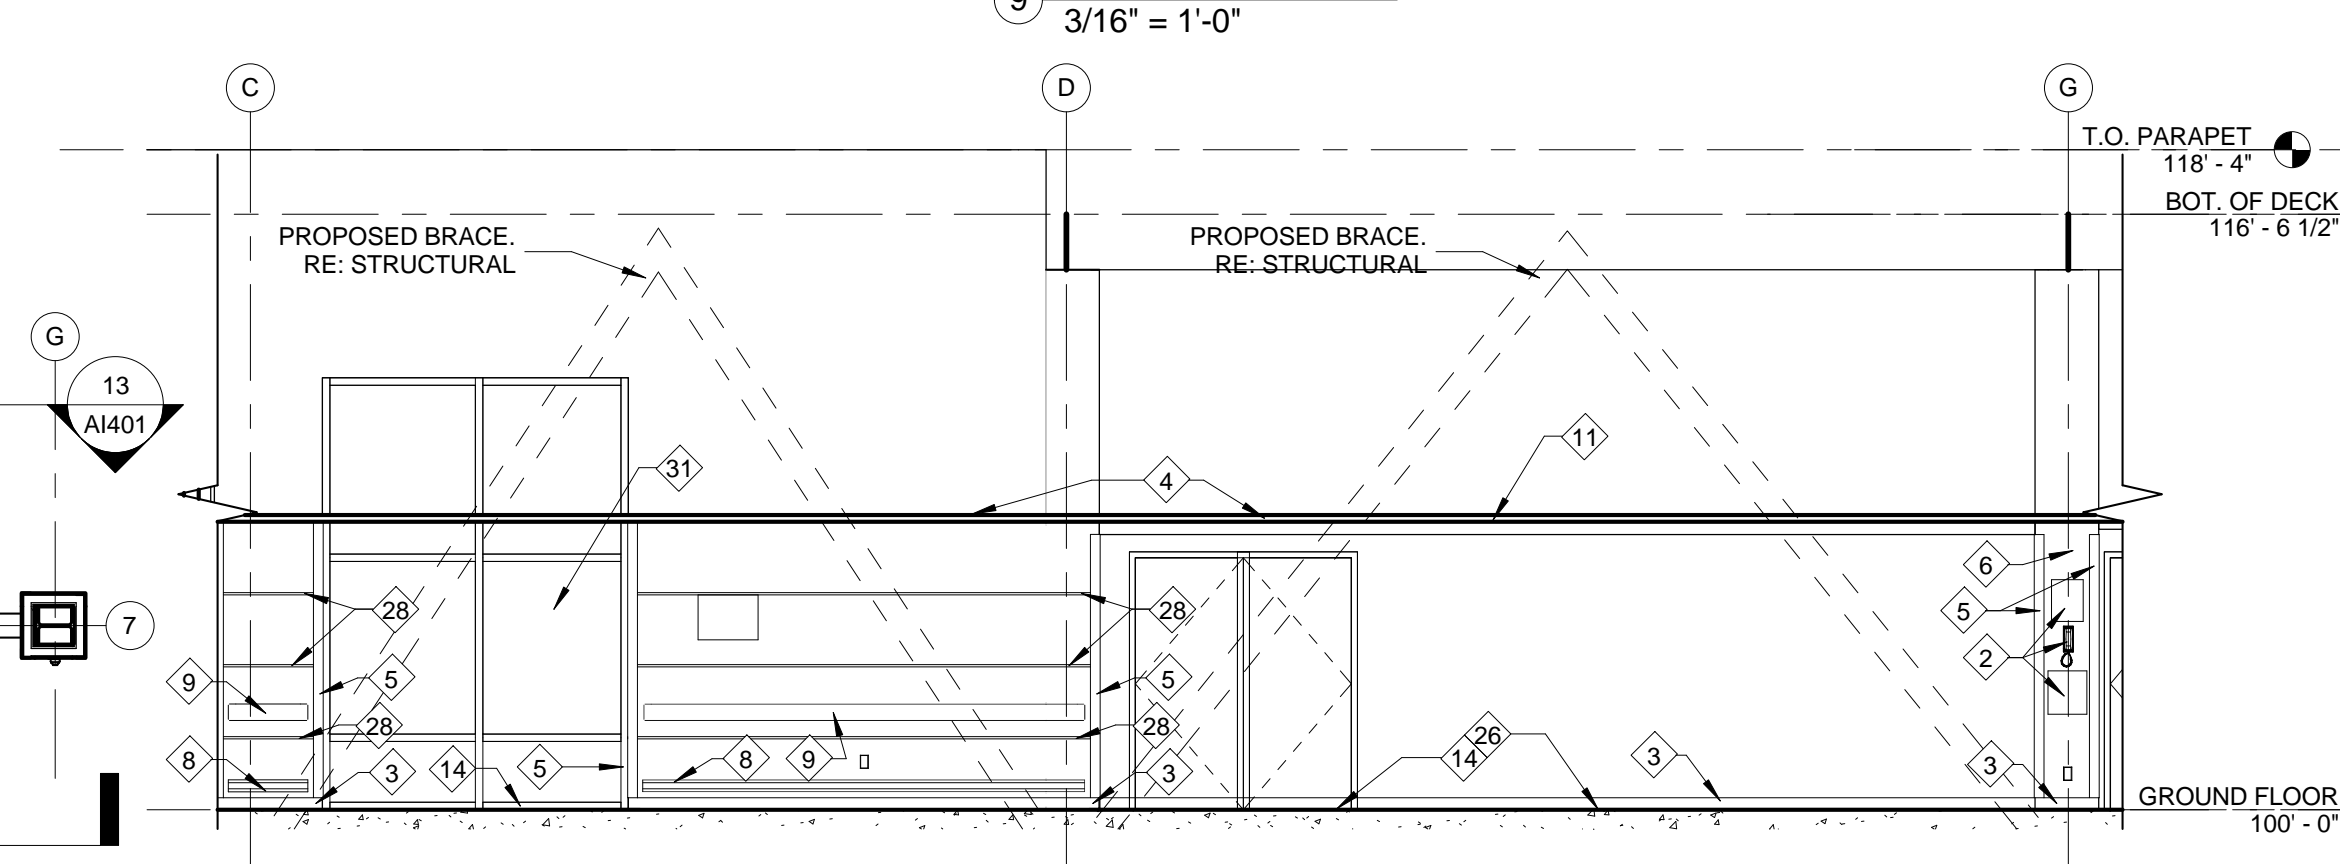

12 Brace Q South Elevation
3/16" = 1'-0"

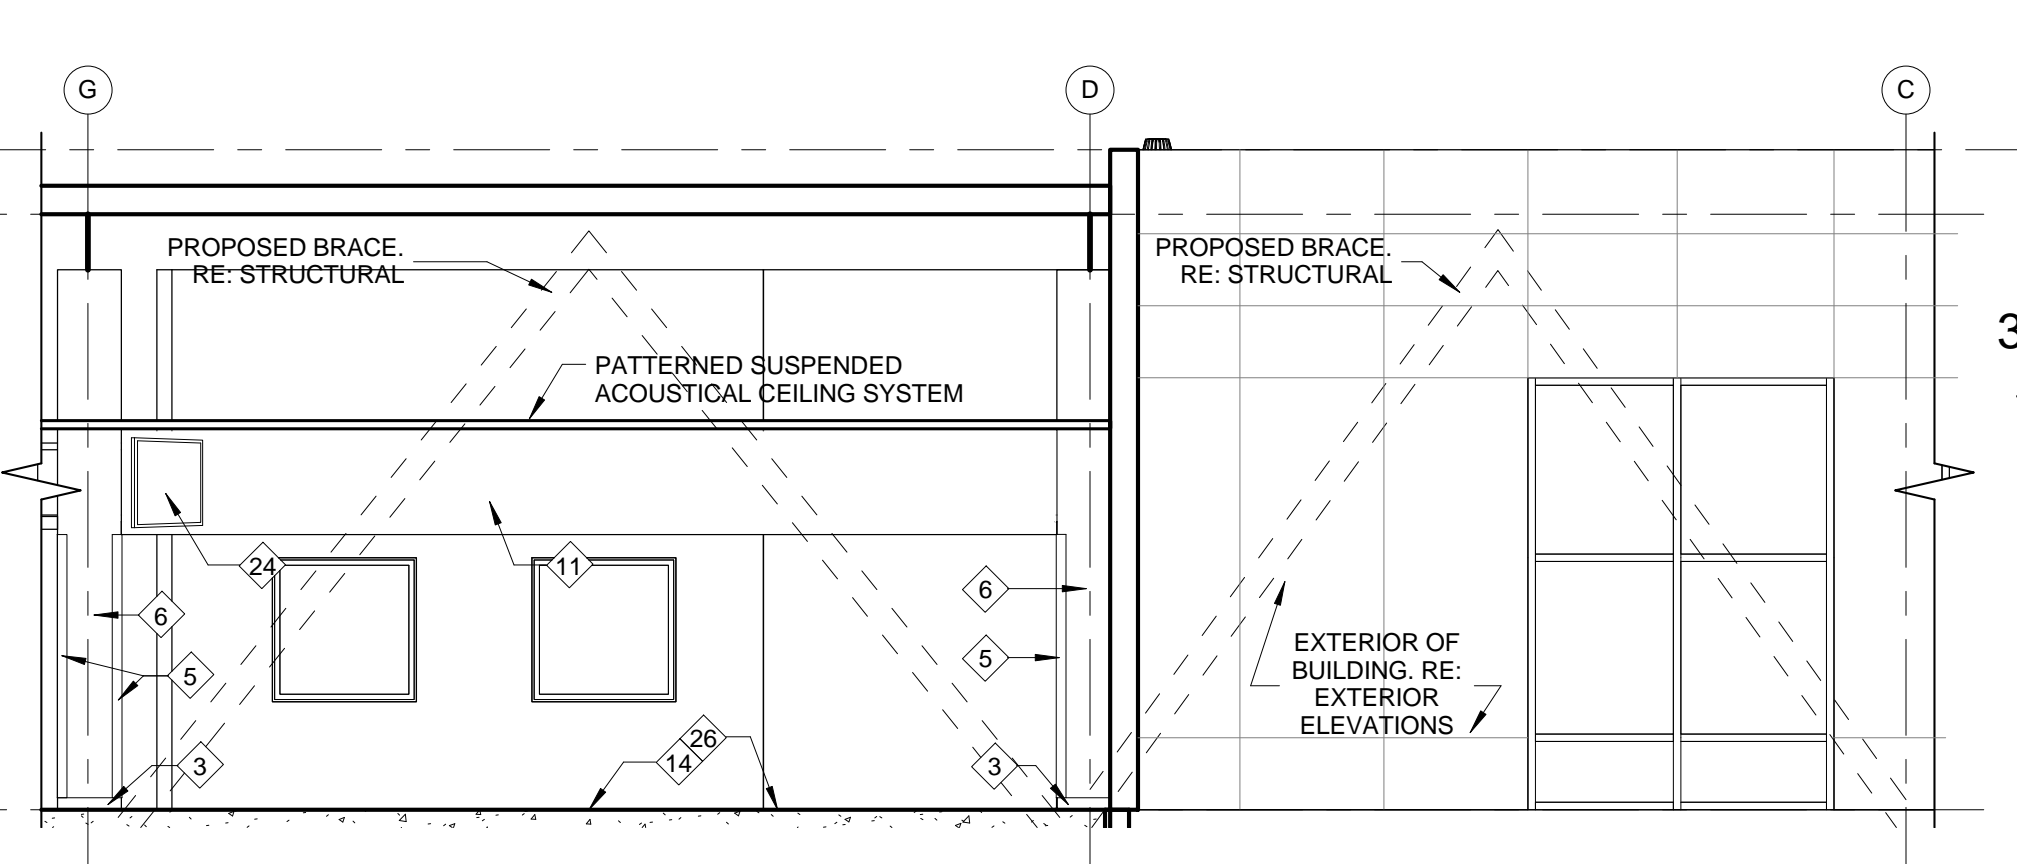

13 Brace Q North Elevation
3/16" = 1'-0"


NOTE

REFER TO DEMOLITION AND RENOVATION SHEETS AND ROOM FINISH SCHEDULE FOR ADDITIONAL INFORMATION.

KEYED NOTES - APPLY TO AI400 & AI401 ONLY

1. EXISTING SYSTEMS FURNITURE.
2. EXISTING WALL MOUNTED EQUIPMENT.
3. EXISTING WALL BASE.
4. 2X4 SUSPENDED ACOUSTICAL CEILING SYSTEM.
5. RESILIENT CORNER GUARD.
6. GYPSUM BOARD OVER METAL STUDS COLUMN ENCLOSURE.
7. HEAT-WELDED VINYL FLOORING WITH INTEGRAL COVE BASE.
8. RESILIENT KICKGUARD.
9. RESILIENT HANDRAIL.
10. EXISTING CERAMIC TILE WAINSCOT.
11. EXISTING GYPSUM BOARD OVER METAL STUD SOFFIT.
12. WALL-HUNG PICTURE AND FRAME.
13. FIRE EXTINGUISHER/FIRE EXTINGUISHER CABINET.
14. EXISTING VINYL COMPOSITE TILE.
15. EXISTING SHELVING.
16. EXISTING MOSAIC TILE FLOORING WITH CERAMIC COVE BASE.
17. EXISTING TABLE AND CHAIRS/BOOTH SEATING.
18. EXISTING CHAIR RAIL.
19. EXISTING PYXIS MACHINE.
20. EXPANSION JOINT COVER.
21. EXISTING CASEWORK.
22. EXISTING MINI-FRIDGE.
23. EXISTING ICE MACHINE.
24. WALL-MOUNTED TELEVISION.
25. EXISTING SIGNAGE.
26. EXISTING CARPET TILE.
27. EXISTING BUILDING SYSTEMS EQUIPMENT. RE: PLUMBING, MECHANICAL, ELECTRICAL.
28. GYPSUM BOARD REVEAL.
29. PROJECTION SCREEN (CEILING HUNG).
30. EXISTING WAITING ROOM FURNITURE.
31. EXISTING STOREFRONT WINDOW SYSTEM.

COORDINATION NOTE:
COORDINATE PHASING OF ALL STRUCTURAL CONSTRUCTION WITH OTHER DISCIPLINES AS NECESSARY TO MAINTAIN AND PROTECT MEP EQUIPMENT AND LINES IN SERVICE THROUGHOUT DURATION OF CONSTRUCTION. CONTRACTOR TO PROVIDE COORDINATION/PHASING DOCUMENTS FOR APPROVAL BY THE COR.

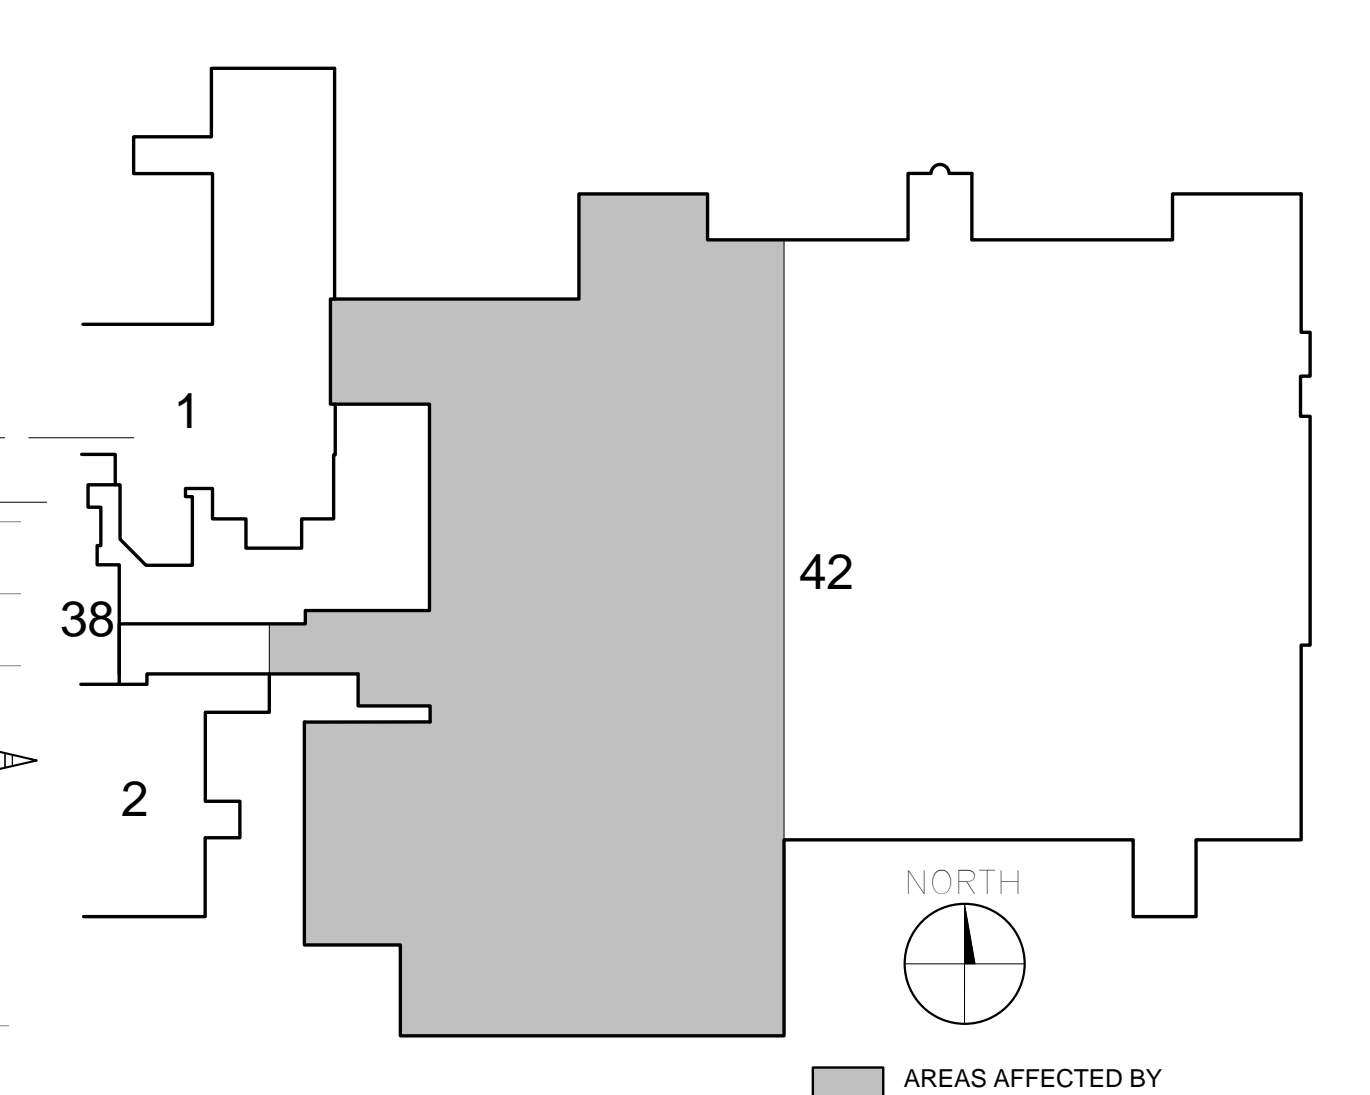

KEY PLAN

100% BID DOCUMENTS

CONSULTANTS:

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AMERICAN STRUCTUREPOINT INC.
7260 Shadeland Station, Indianapolis, IN 46256
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www.structurepoint.com



PROJECT MANAGER:

APOGEE
Consulting Group
Engineers / Architects
www.acgp-gsa.com
919-858-7420

Raleigh, NC
Indianapolis, IN
Pittsburgh, PA
Virginia Beach, VA
Fort Collins, CO

Project Number
16-198

Scale
AS INDICATED

Office of Construction and Facilities Management

VA U.S. Department of Veterans Affairs

Drawing Title:
ENLARGED PLANS AND INTERIOR ELEVATIONS - EXG. CONDITIONS

Location:
**MARION VAMC
MARION, IL, 62959**

Project Title:
ADD STRUCTURAL IMPROVEMENTS TO BUILDING 42

Approved: Project Director

Date: 09/06/17

Checked: HKG

Drawn: MNH

VA PROJECT NUMBER
657-343

Building Number
42

Drawing Number
AI401

Dwg. 45 of 81

A

B

C

D

E

A

B

C


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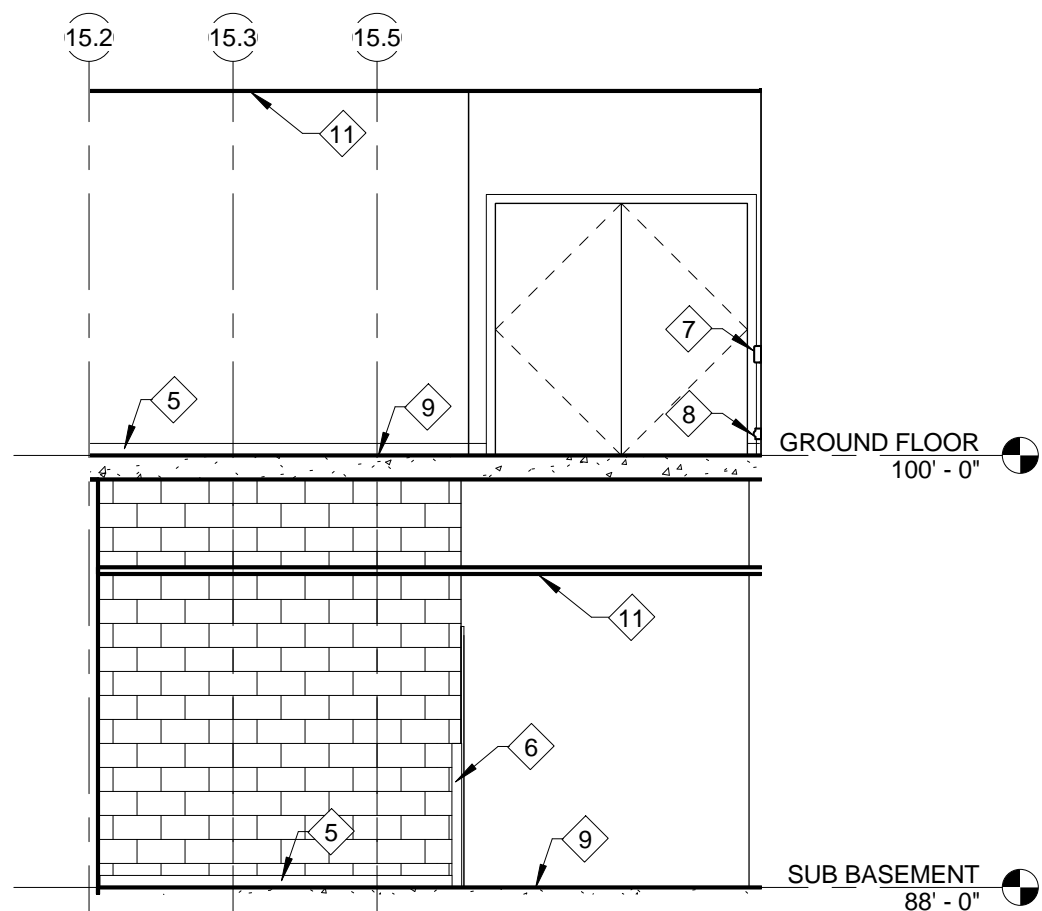
KEYED NOTES - APPLY TO THIS SHEET ONLY

1. EXISTING ELEVATOR DOOR.
2. EXISTING ELEVATOR CALLS.
3. EXISTING INTERIOR SIGNAGE.
4. EXISTING FRP WAINSCOT.
5. EXISTING WALL BASE.
6. EXISTING CORNER GUARD.
7. RESILIENT HANDRAIL.
8. RESILIENT KICKGUARD.
9. EXISTING VINYL COMPOSITE TILE.
10. EXISTING FIRE EXTINGUISHER.
11. SUSPENDED ACOUSTICAL CEILING TILE.
12. EXISTING METAL PAN STAIRS WITH CONCRETE TREADS.


COORDINATION NOTE:
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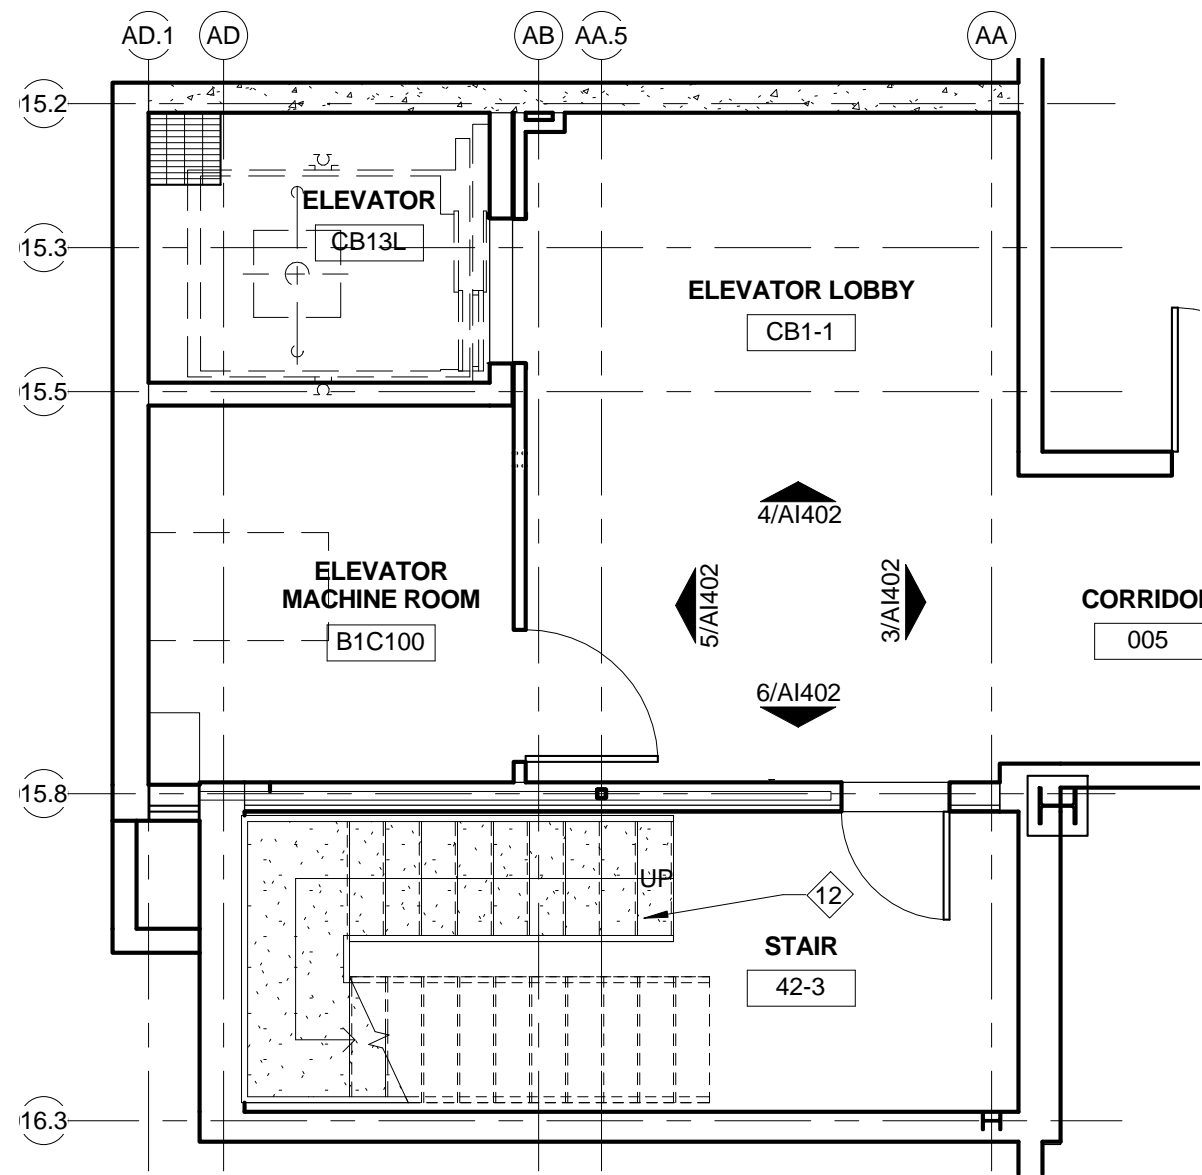
1 ENLARGED BUILDING CONNECTOR PLAN
3/16" = 1'-0"




3 EAST ELEVATION AT BUILDING CONNECTION
3/16" = 1'-0"

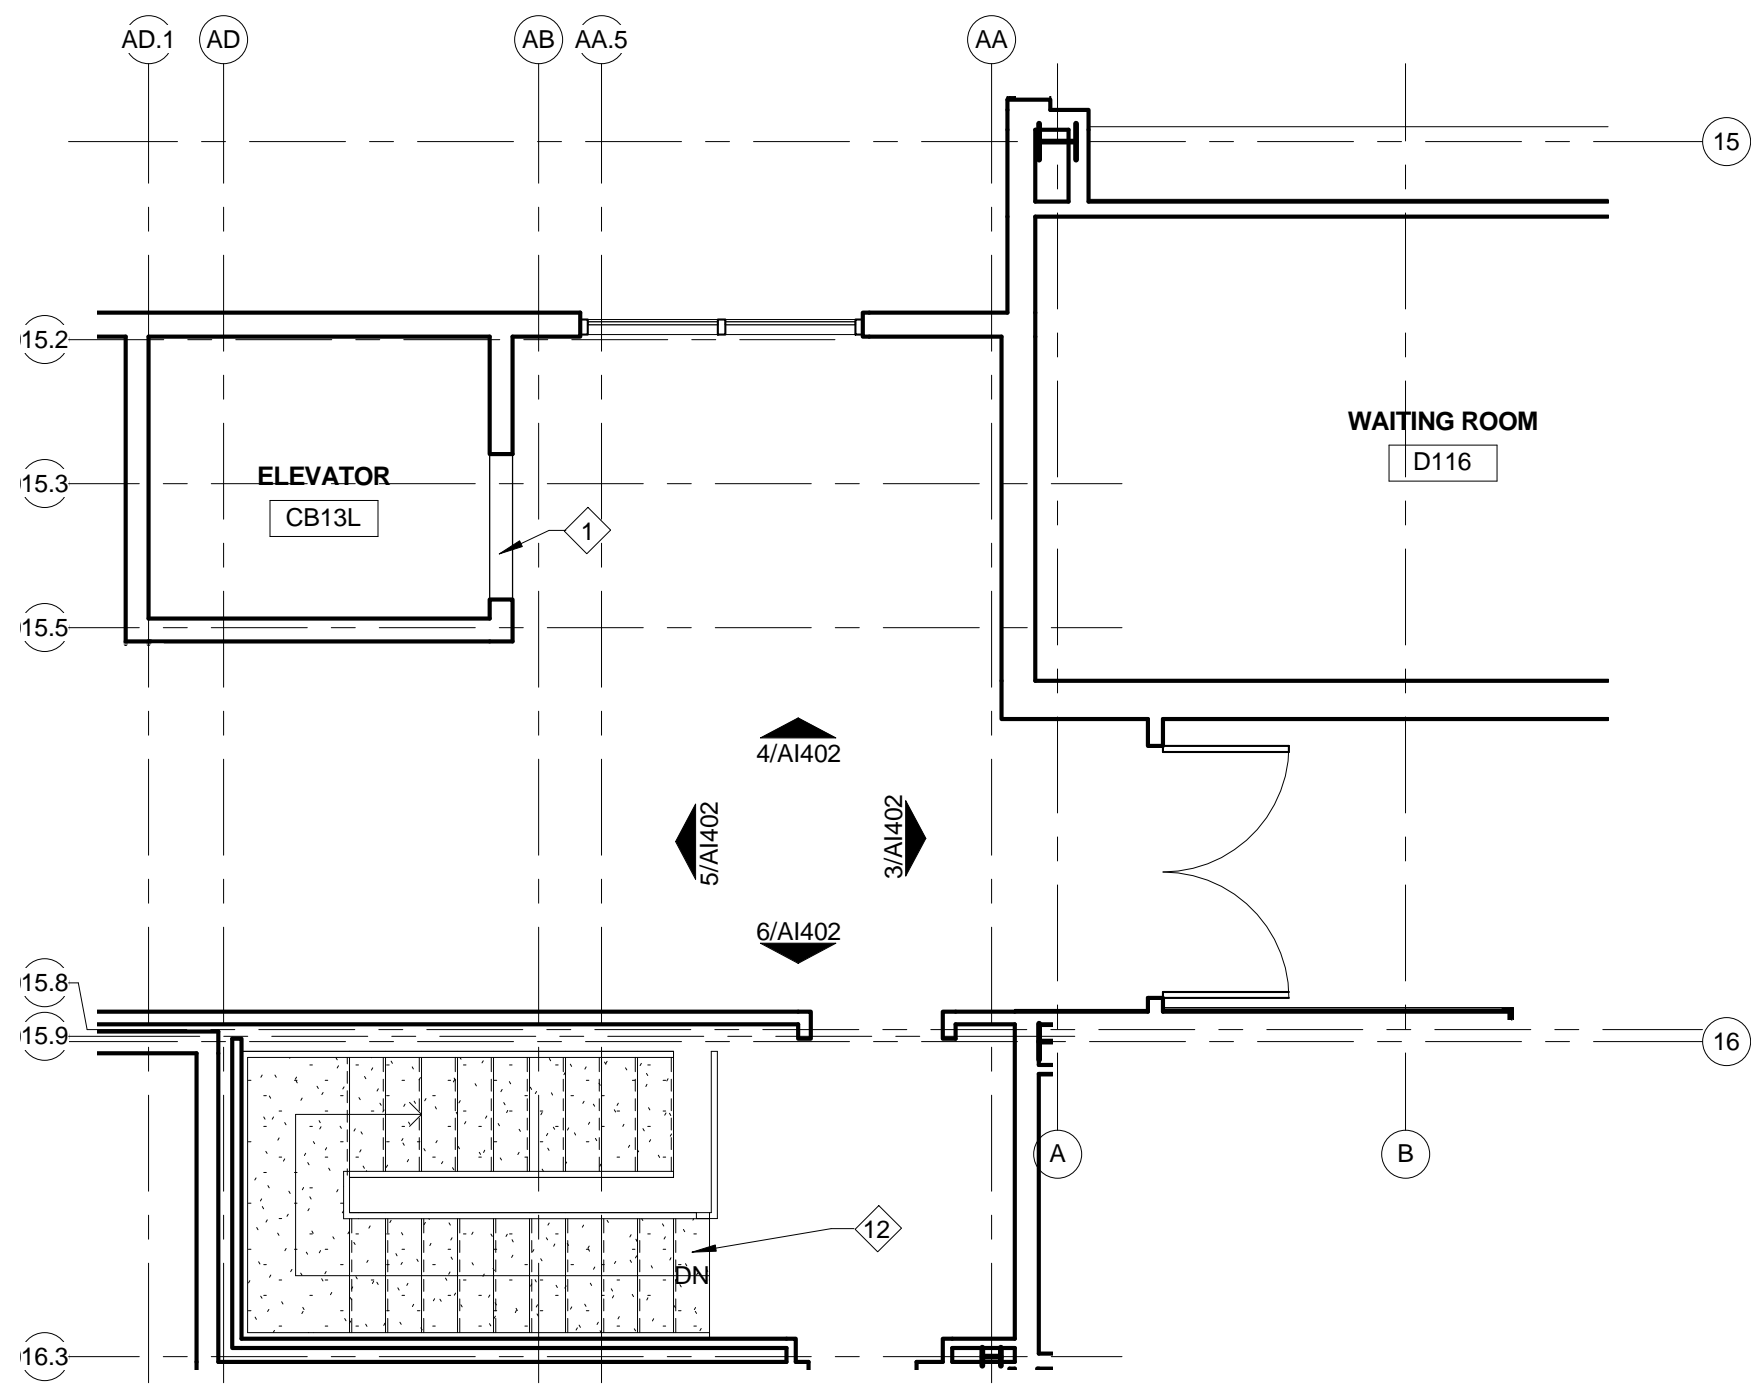


5 WEST ELEVATION AT BUILDING CONNECTION
3/16" = 1'-0"

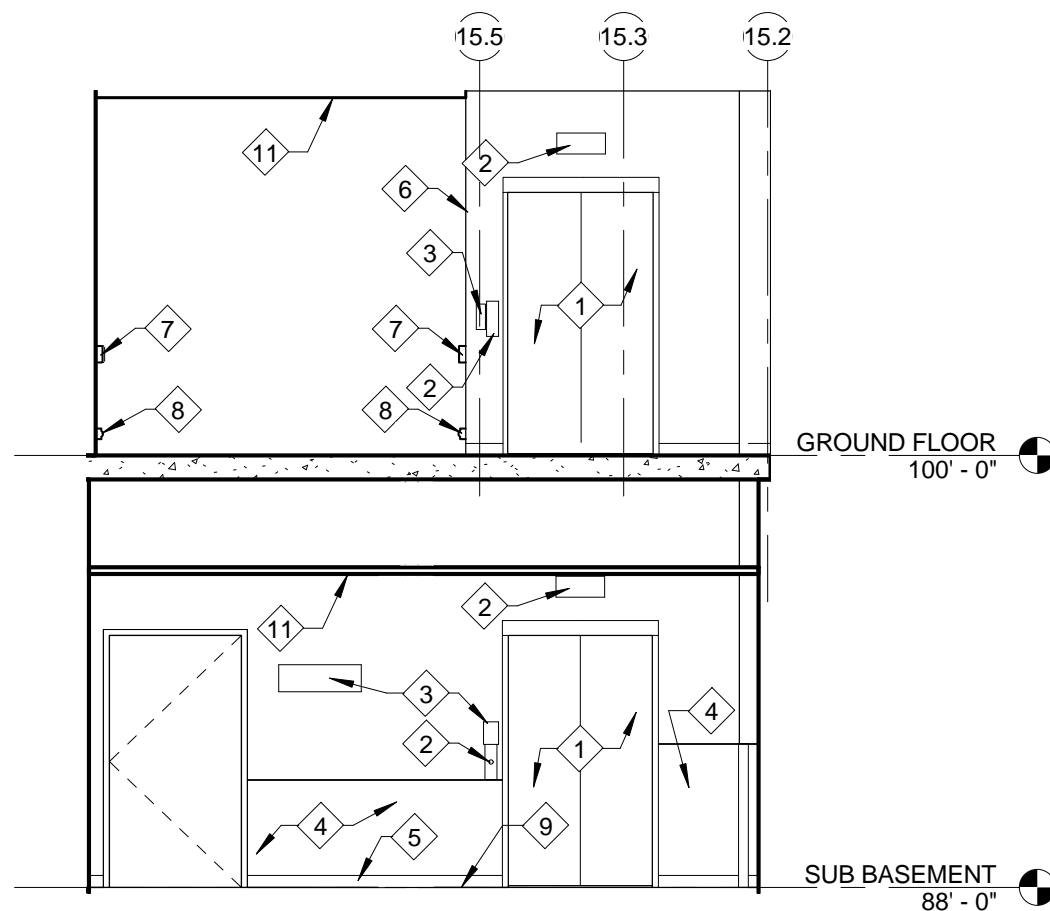

2 ENLARGED SUB BASEMENT ELEVATOR PLAN
3/16" = 1'-0"

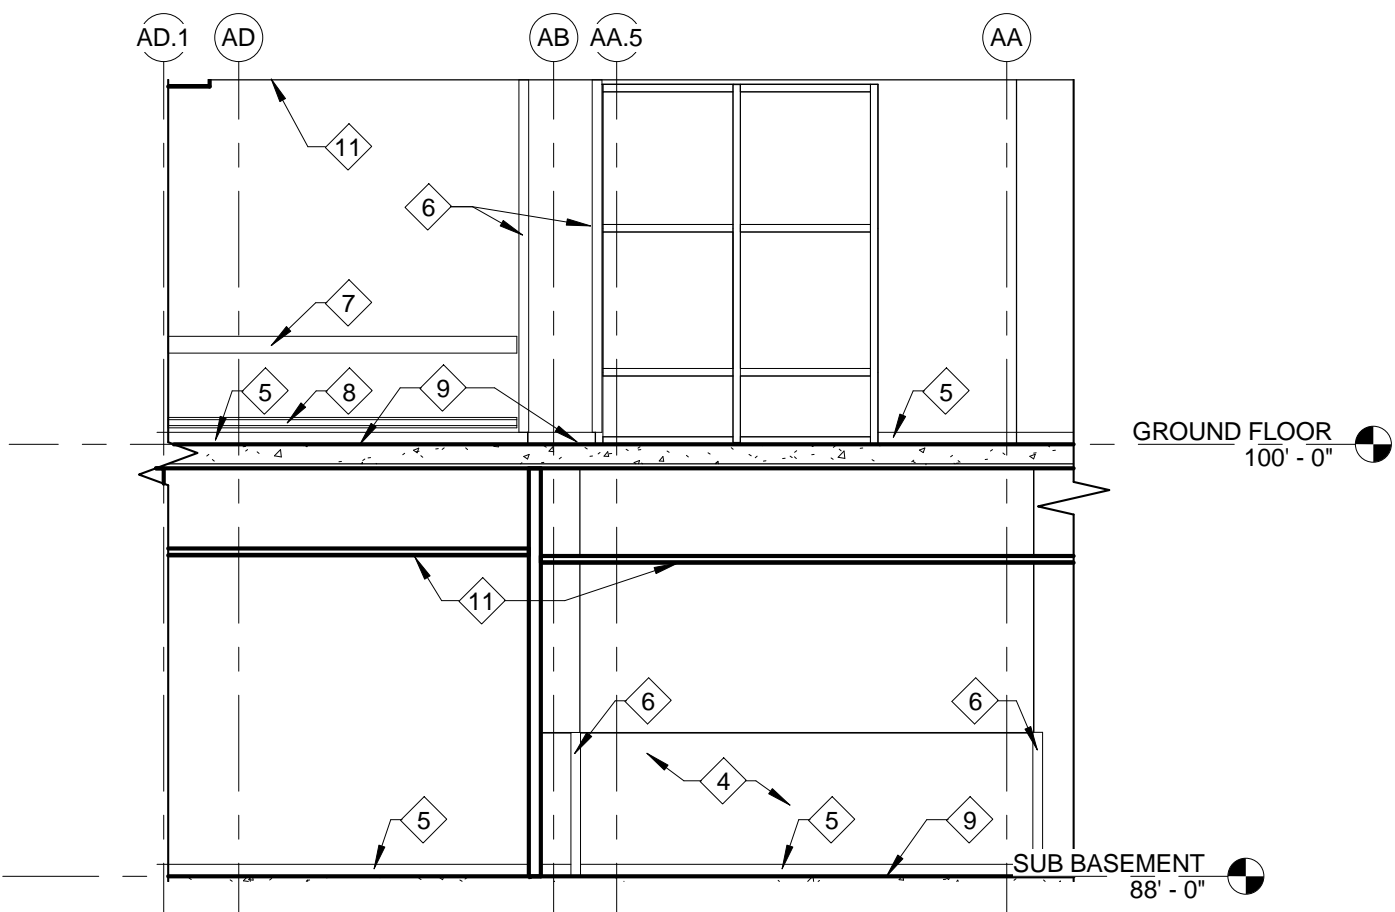

4 NORTH ELEVATION AT BUILDING CONNECTION
3/16" = 1'-0"

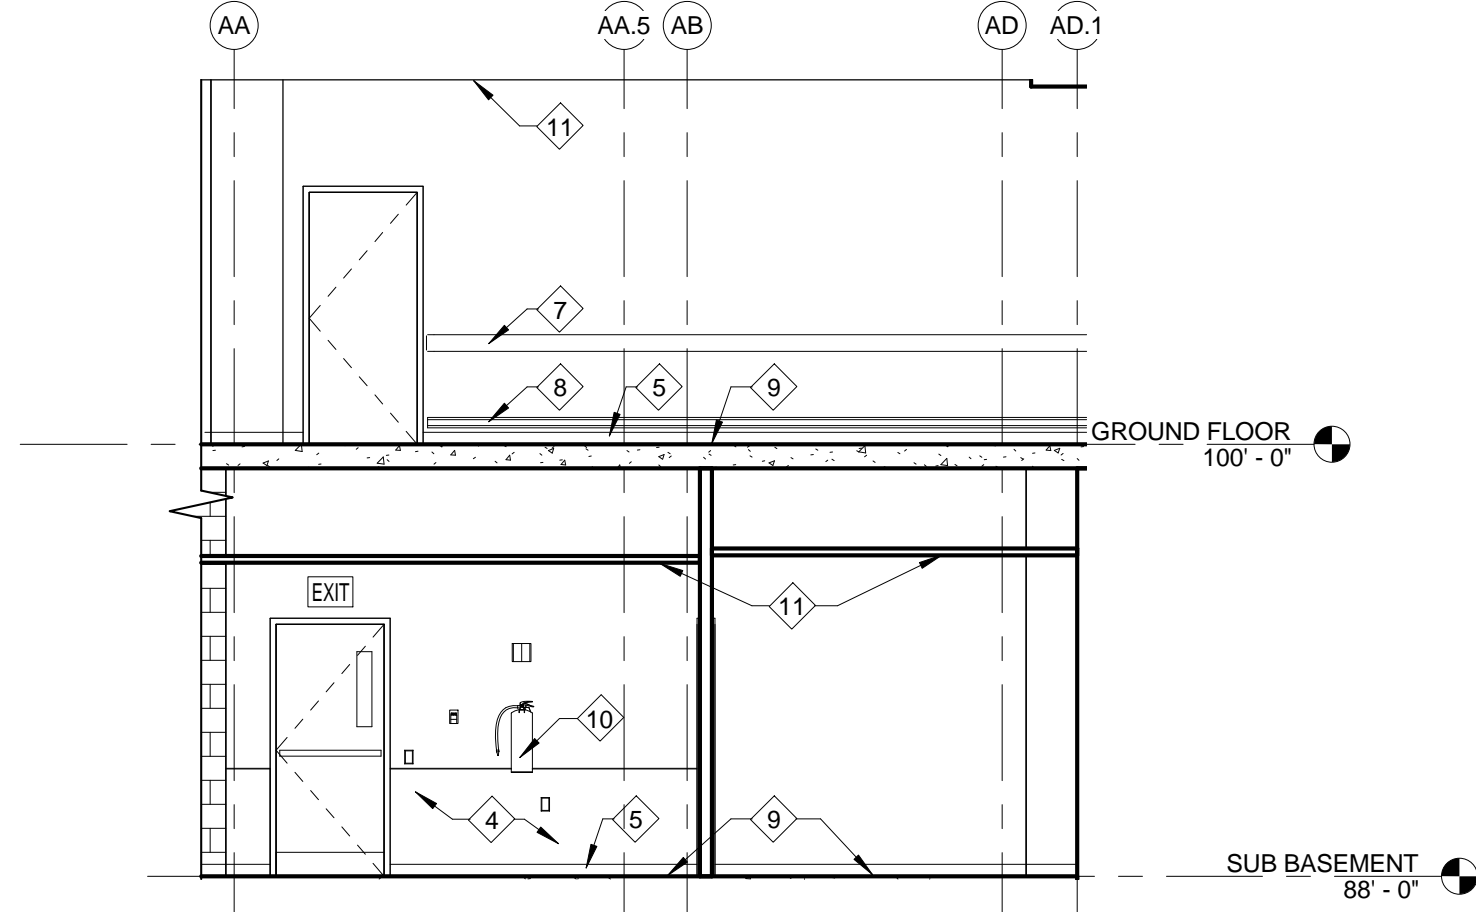

6 SOUTH ELEVATION AT BUILDING CONNECTOR
3/16" = 1'-0"

100% BID DOCUMENTS

CONSULTANTS:



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PROJECT MANAGER:

Project Number
16-198

Scale
AS INDICATED



Raleigh, NC
Indianapolis, IN
Pittsburgh, PA
Virginia Beach, VA
Fort Collins, CO

Office of
Construction
and Facilities
Management



U.S. Department
of Veterans Affairs

Drawing Title:

ENLARGED PLANS AND INTERIOR
ELEVATIONS - EXG. CONDITIONS

Location

MARION VAMC
MARION, IL, 62959

Project Title:

ADD STRUCTURAL
IMPROVEMENTS TO BUILDING
42

Approved: Project Director

Date

09/06/17

Checked

HKG

Drawn

SPH

VA PROJECT NUMBER
657-343

Building Number
42

Drawing Number

AI402

Dwg. 46 of 81

Revisions:

Date

1

2

3

4

5

6

7

A

B

C

D

E


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B


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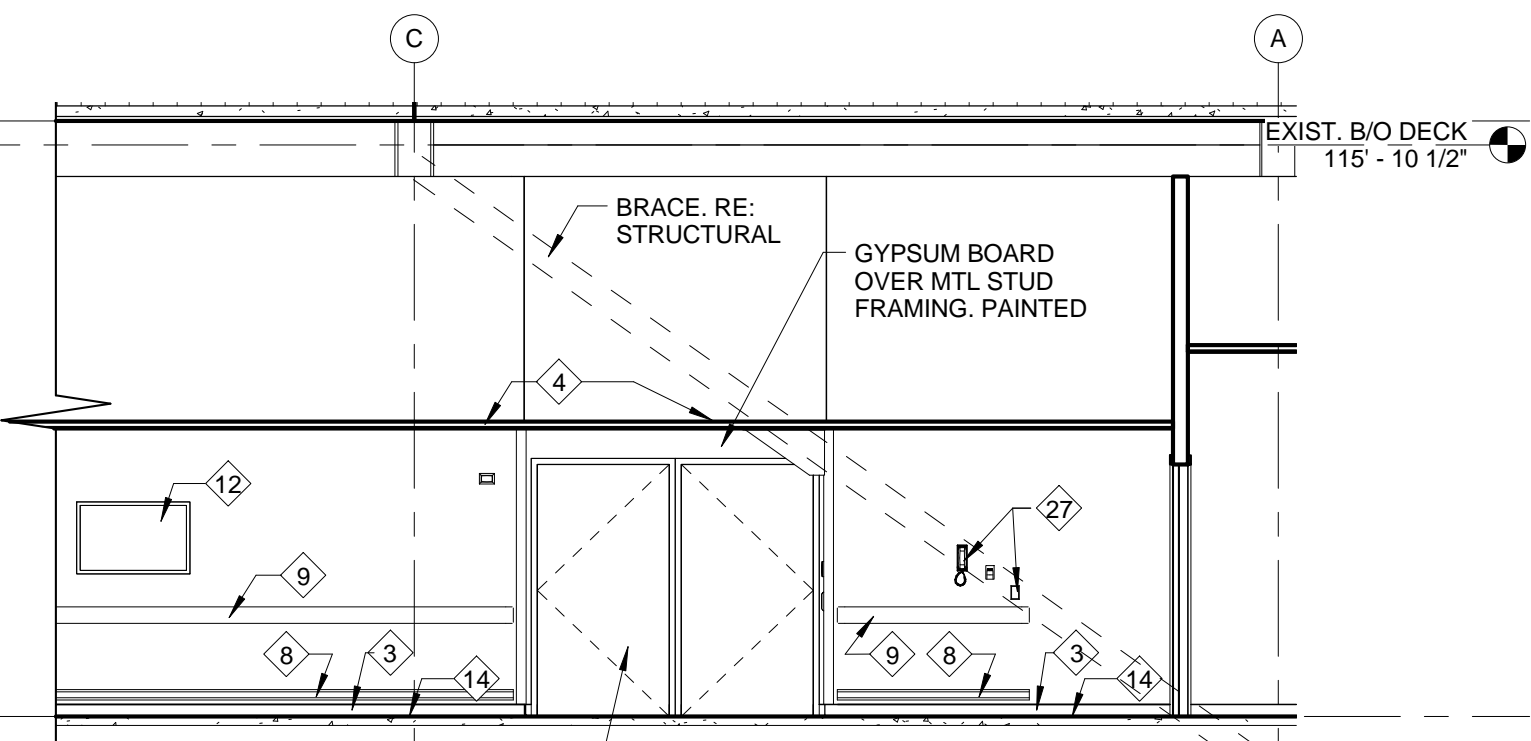
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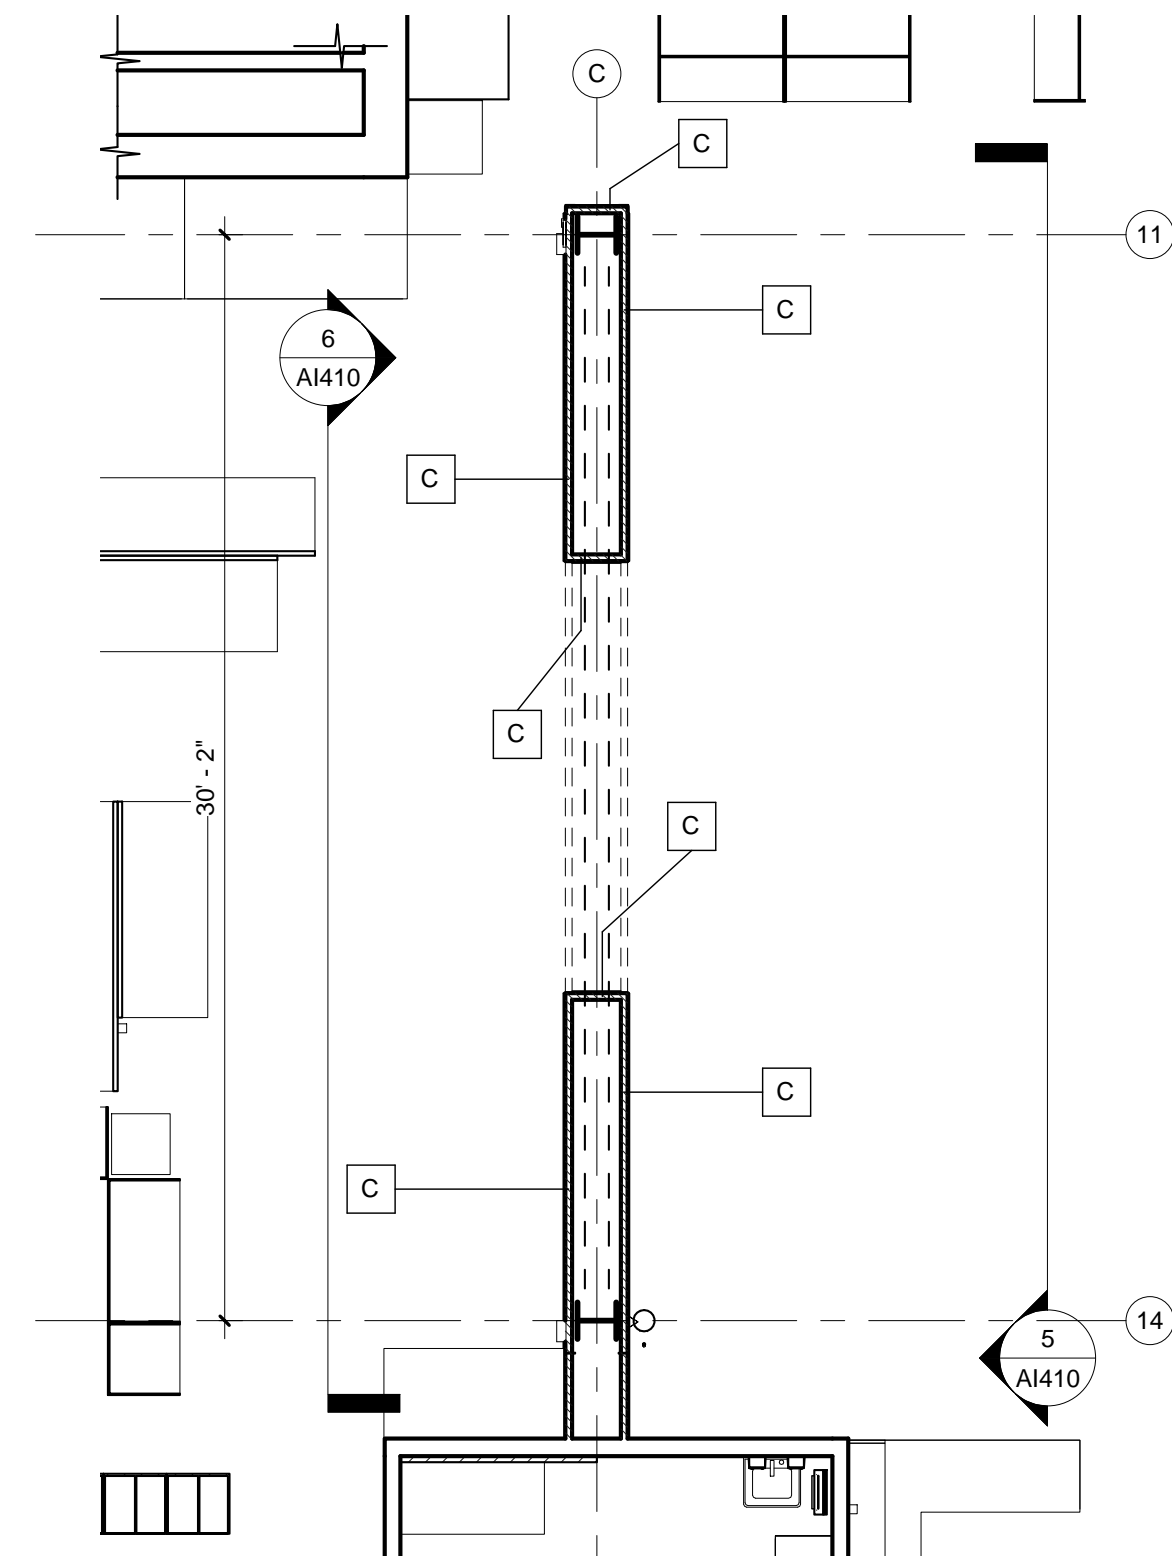
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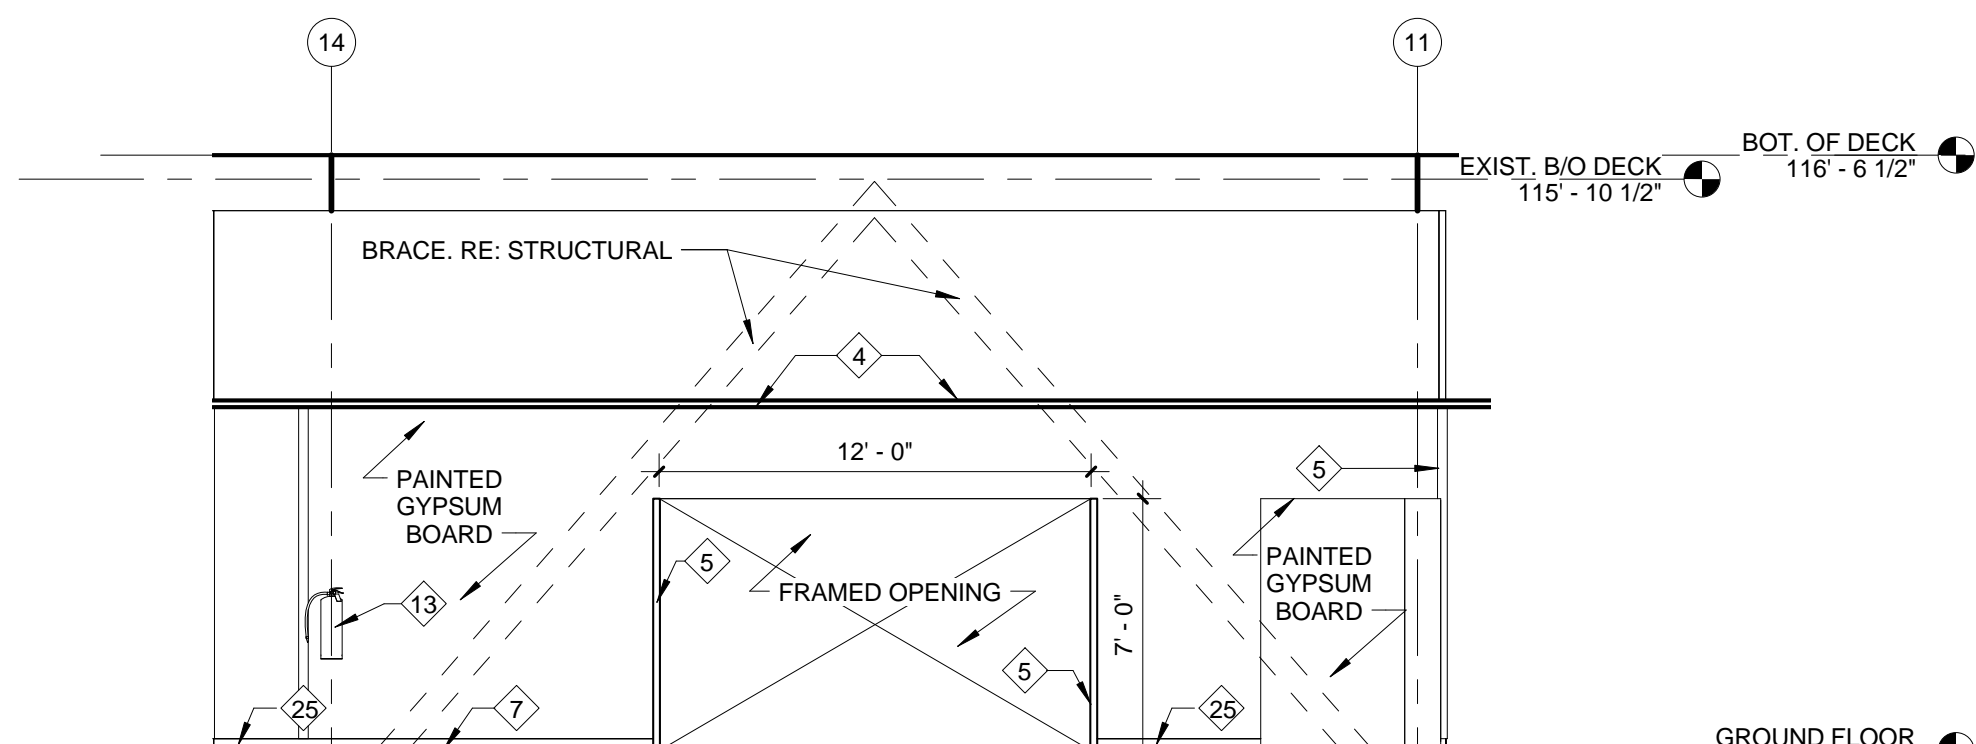
2 Brace A South Elevation - Renovation
3/16" = 1'-0"




3 Brace A North Elevation - Renovation
3/16" = 1'-0"

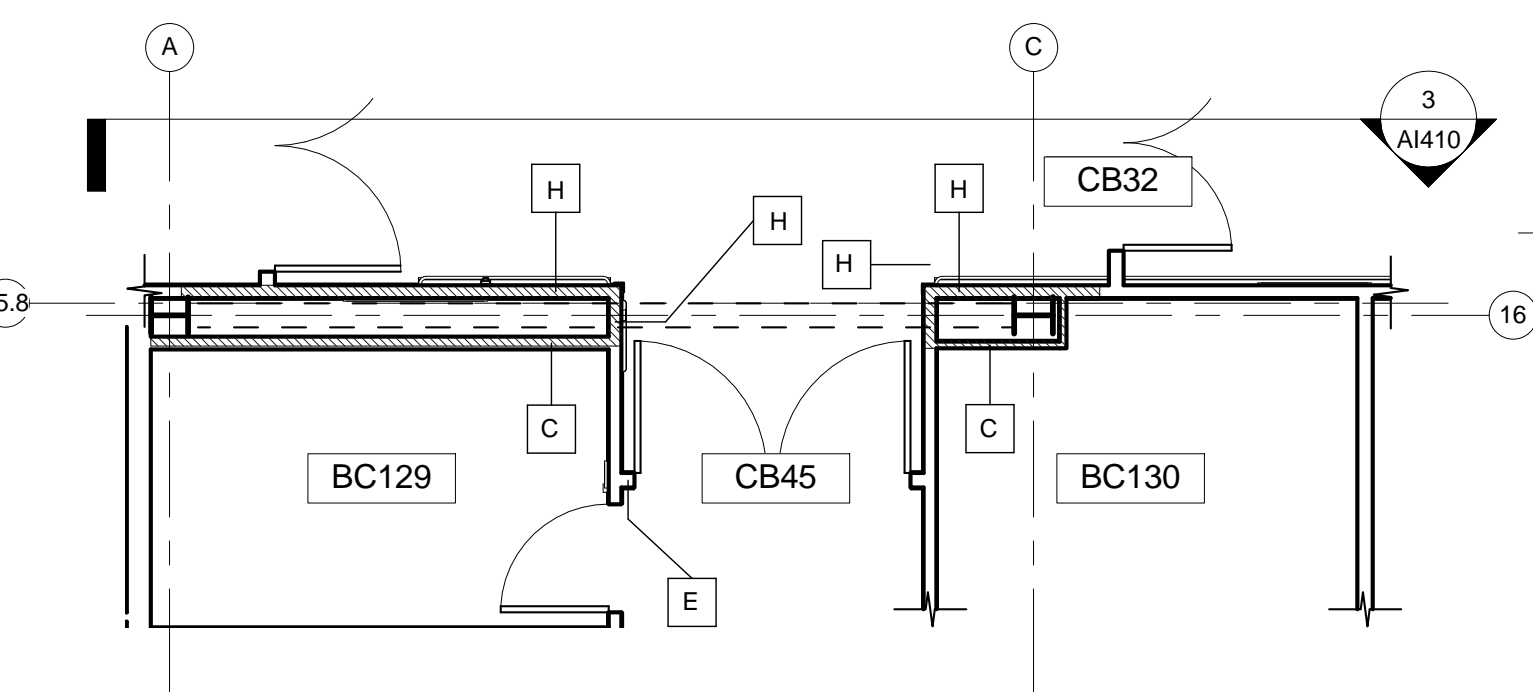


4 Brace B Plan - Renovation
3/16" = 1'-0"

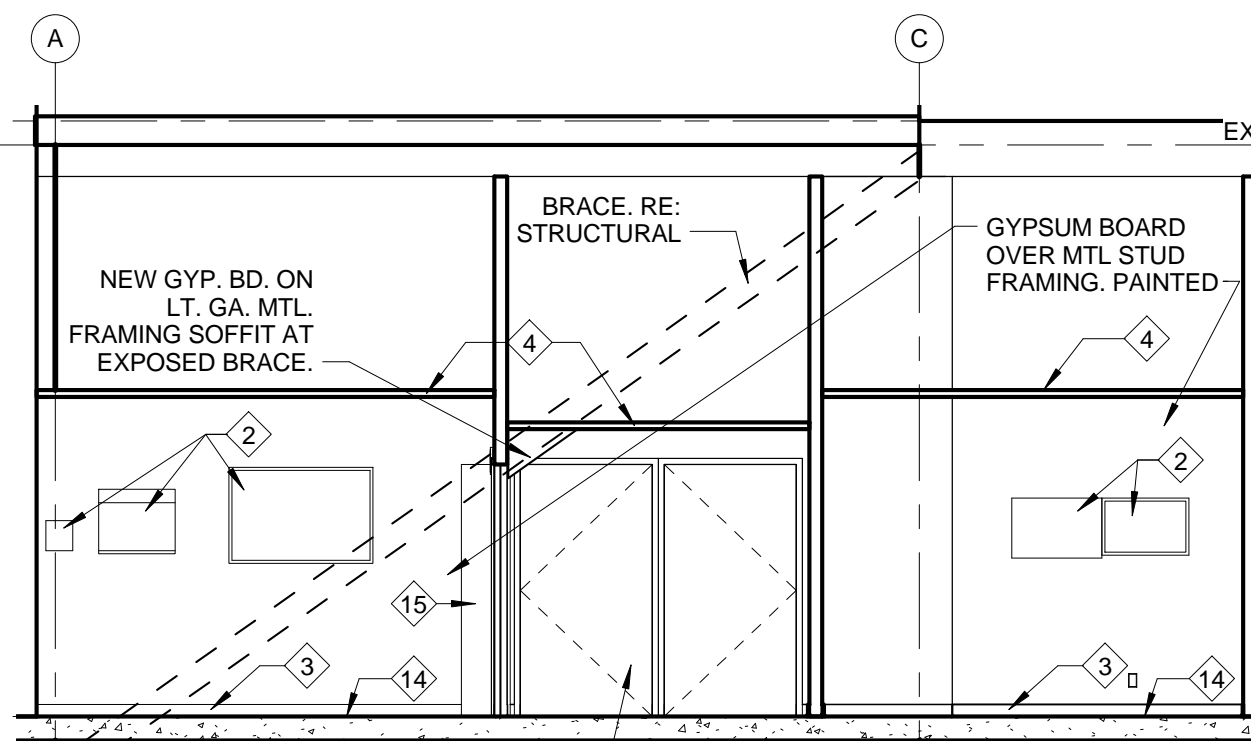


5 Brace B East Elevation - Renovation
3/16" = 1'-0"

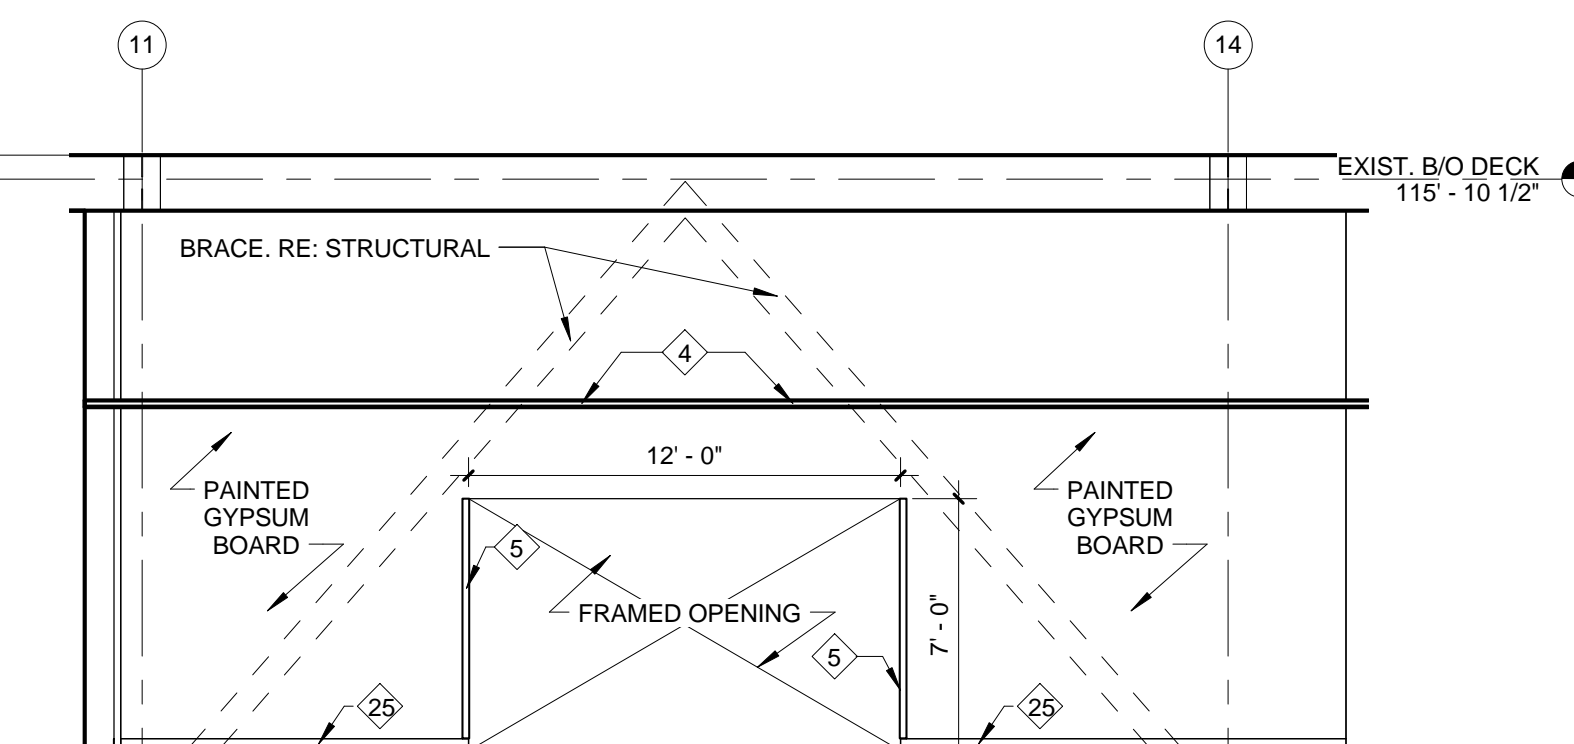


6 Brace B West Elevation - Renovation
3/16" = 1'-0"

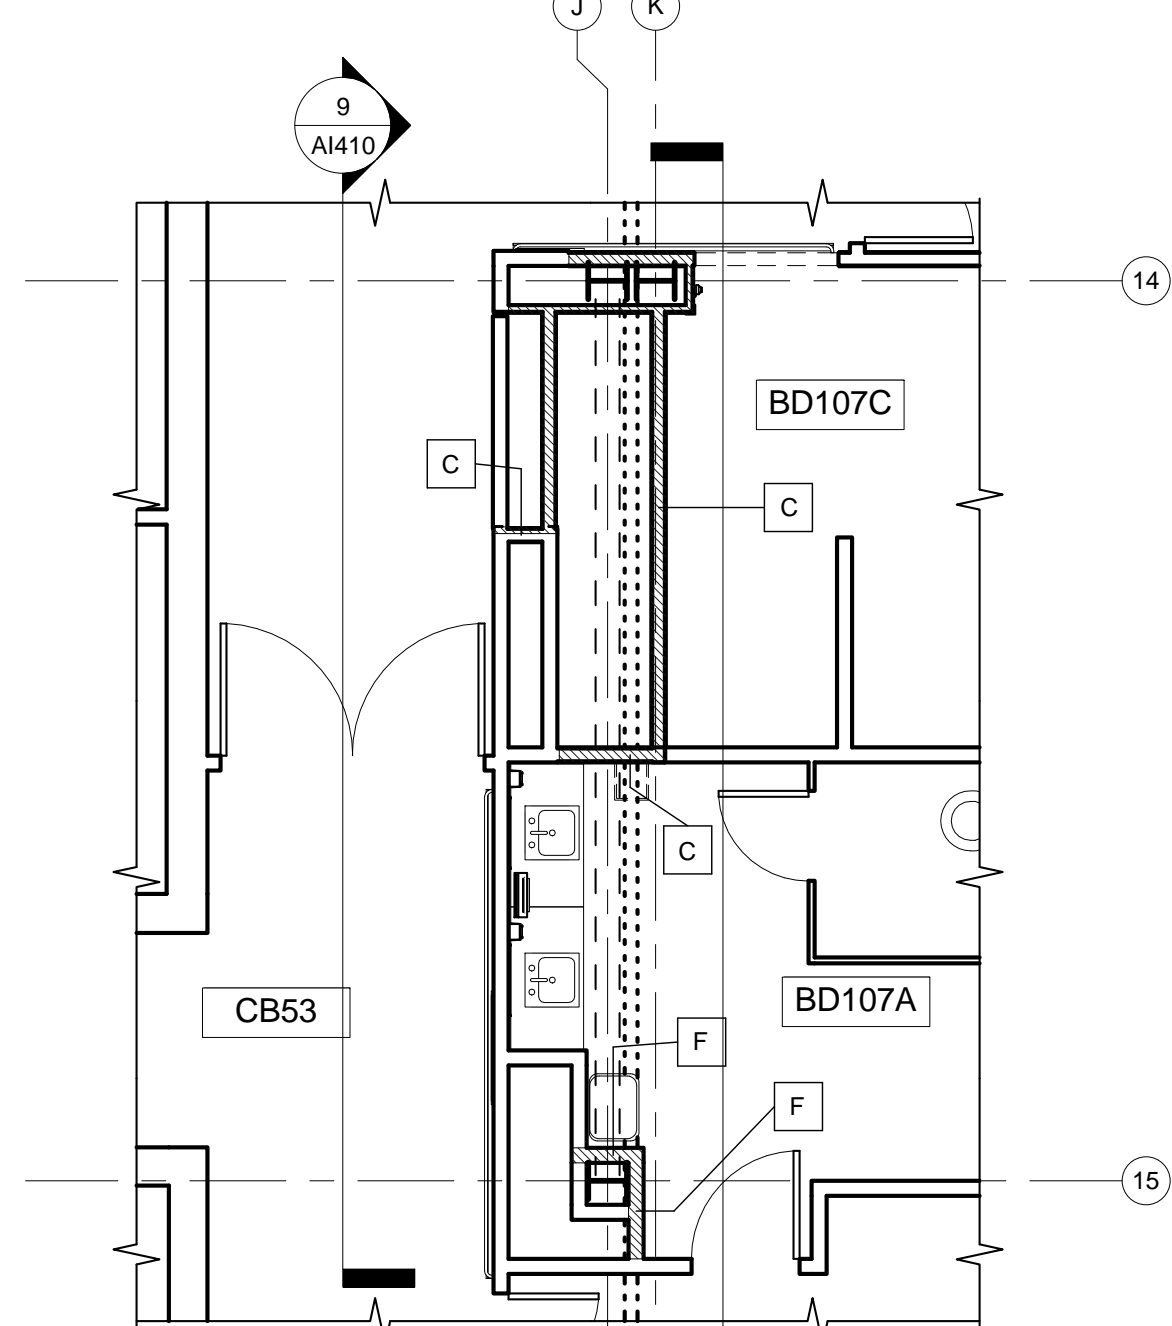


7 Brace C Plan - Renovation
3/16" = 1'-0"

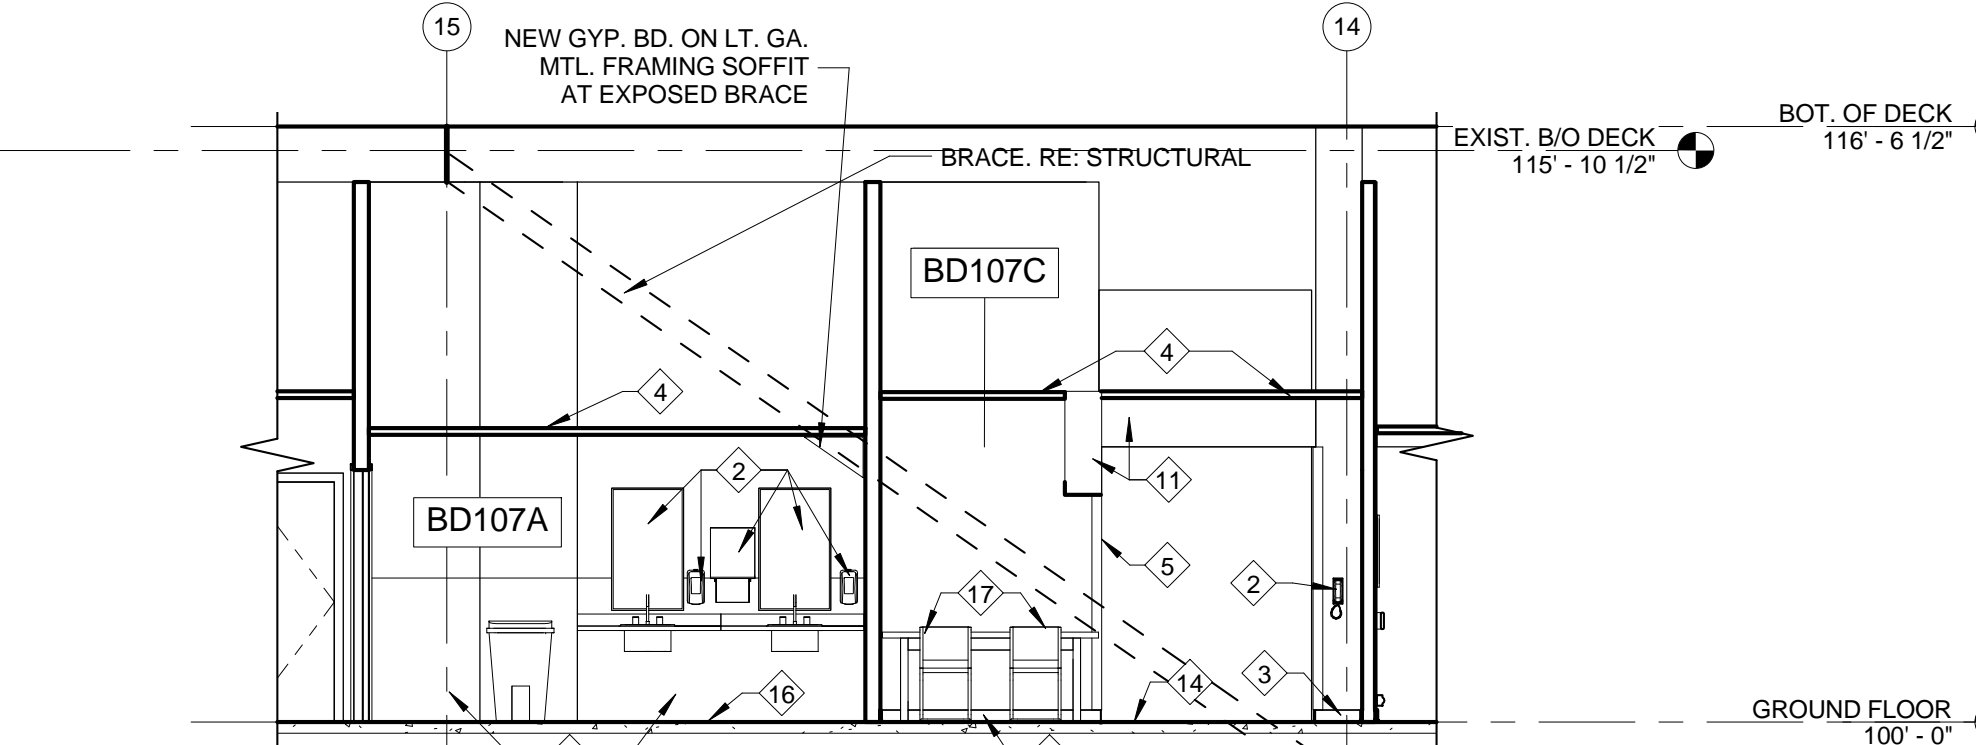


8 Brace C East Elevation - Renovation
3/16" = 1'-0"

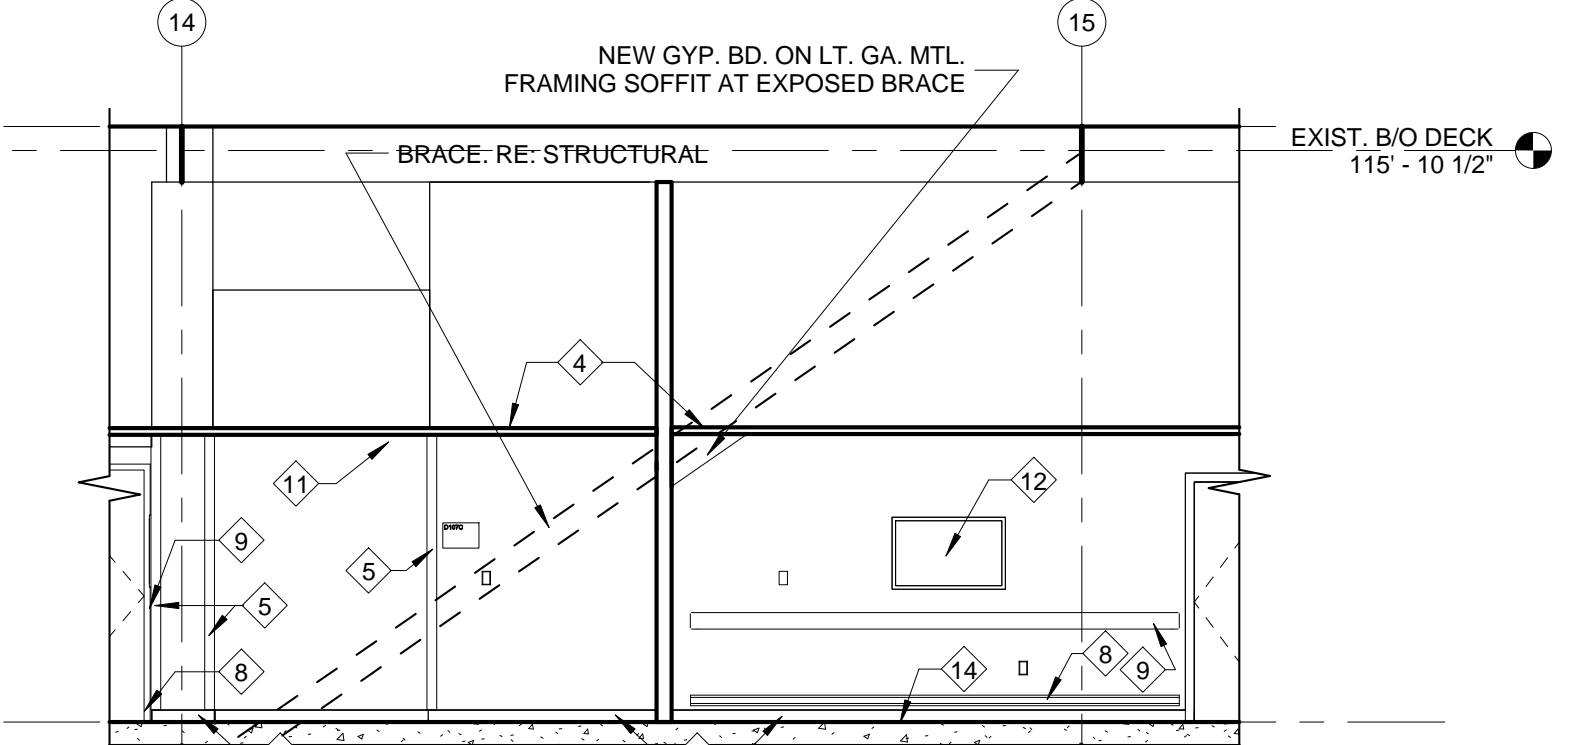


9 Brace C West Elevation - Renovation
3/16" = 1'-0"

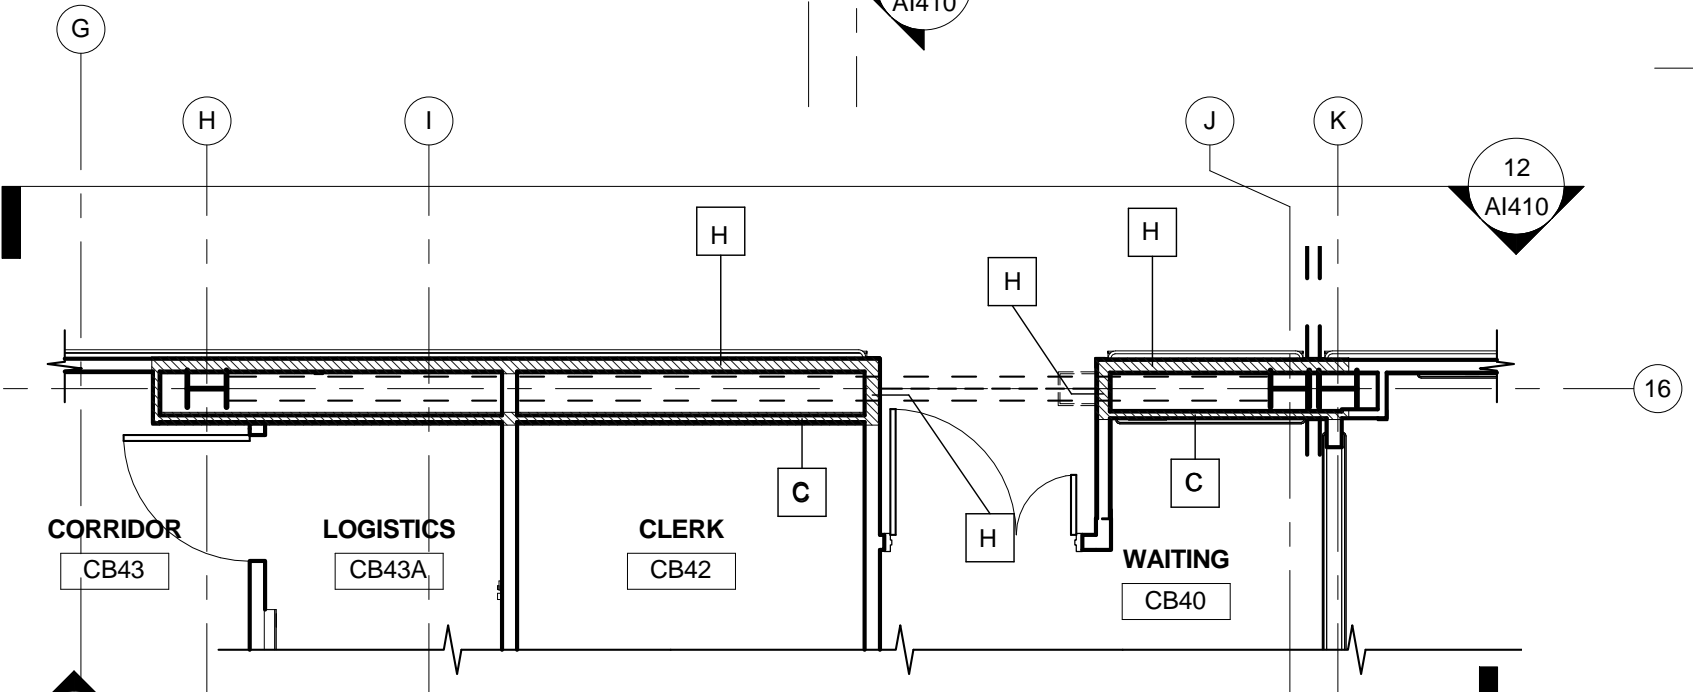

10 Brace K Plan - Renovation
3/16" = 1'-0"

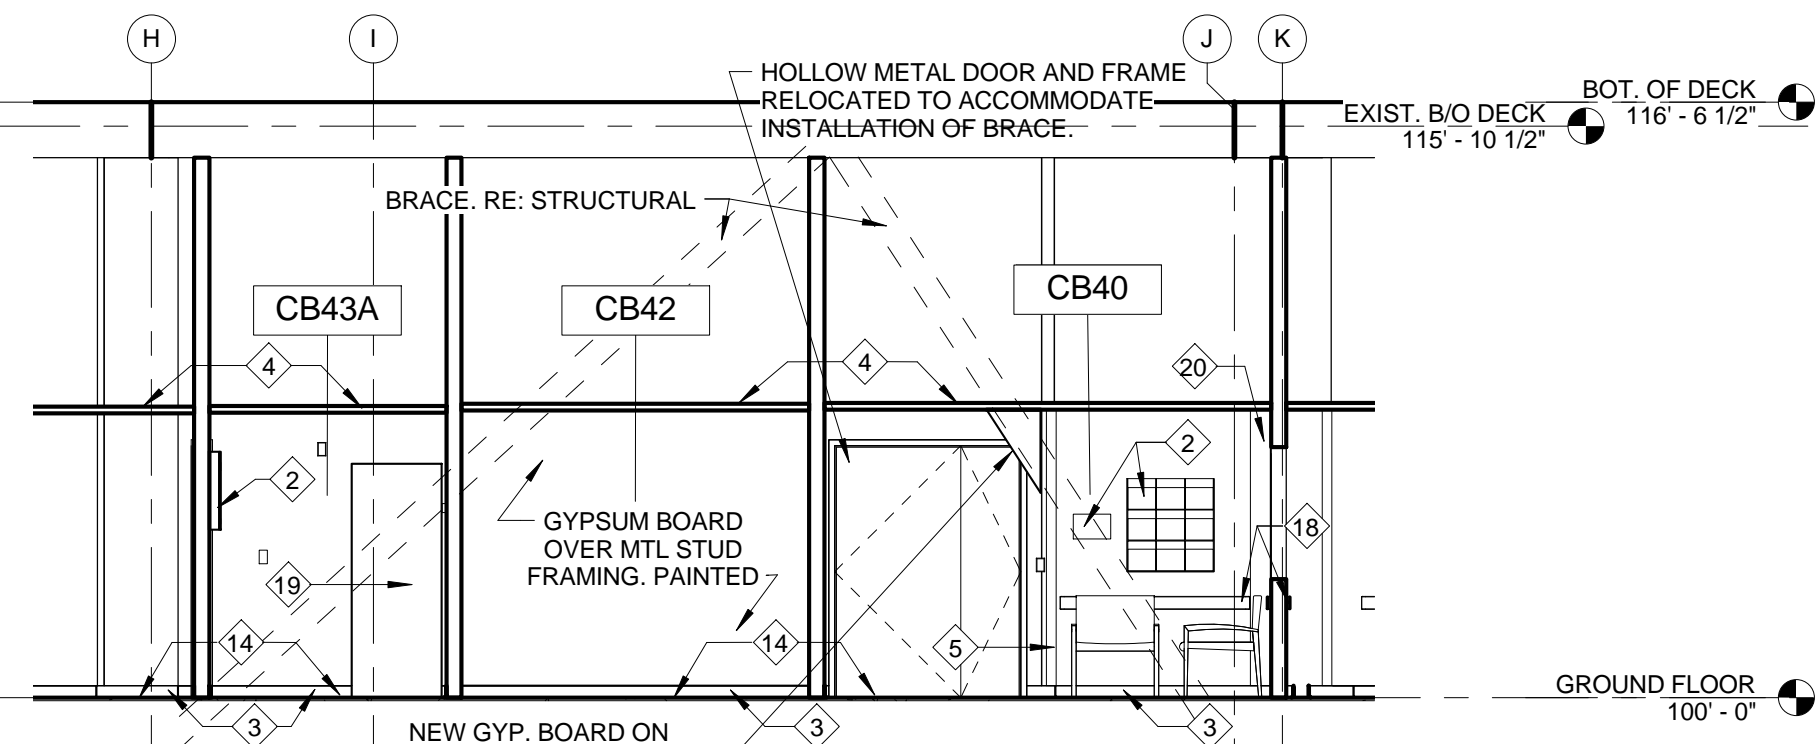

11 Brace K South Elevation - Renovation
3/16" = 1'-0"

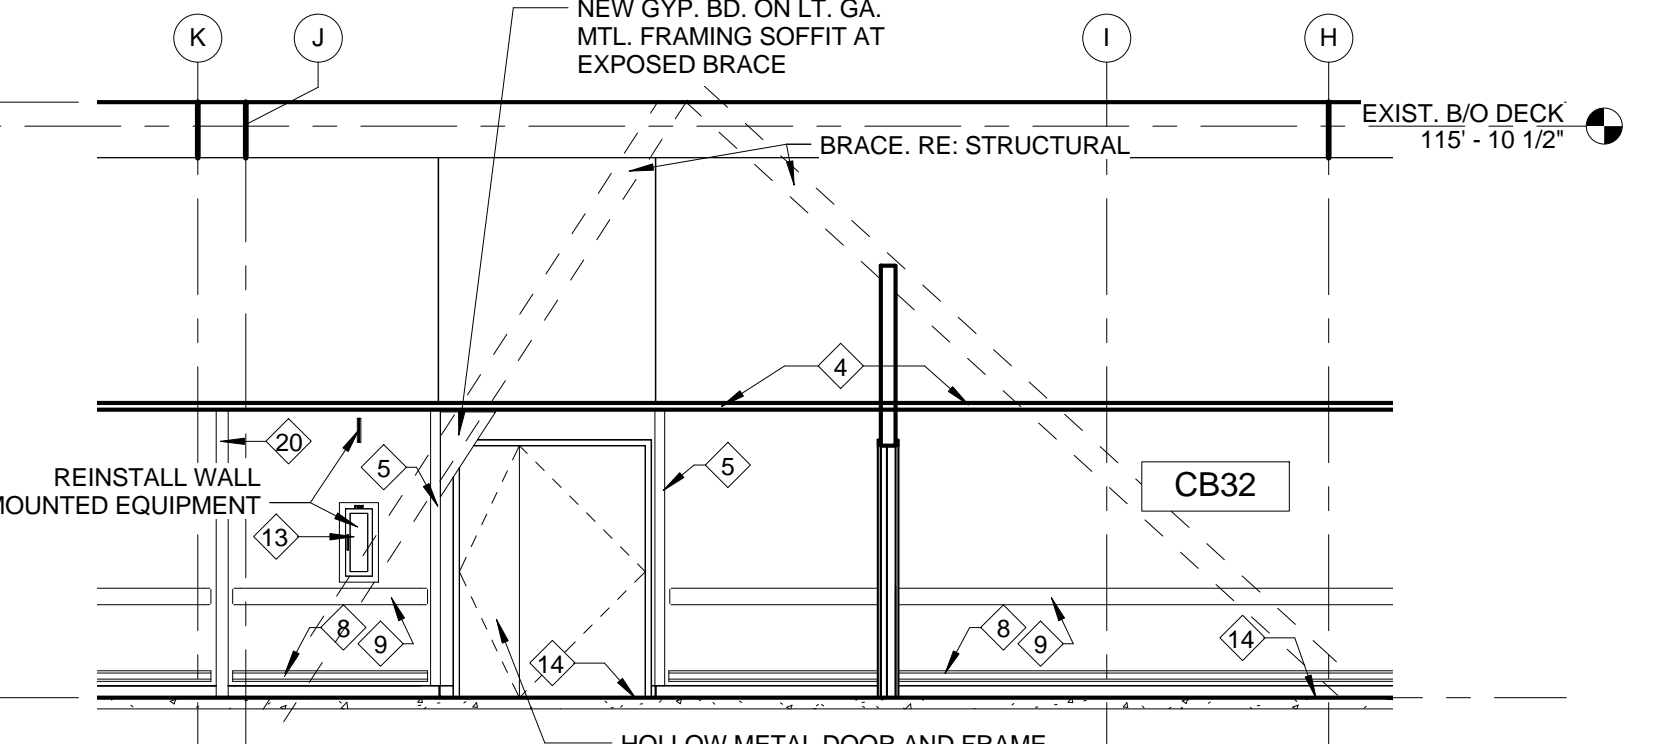

12 Brace K North Elevation - Renovation
3/16" = 1'-0"


NOTE

REFER TO DEMOLITION AND RENOVATION SHEETS AND ROOM FINISH SCHEDULE FOR ADDITIONAL INFORMATION.

KEYED NOTES - APPLY TO A1410 AND A1411 ONLY

1. REINSTALL/REPLACE EXISTING SYSTEMS FURNITURE.
2. REINSTALLED WALL MOUNTED EQUIPMENT.
3. EXISTING WALL BASE. SUPPLEMENT AS REQUIRED.
4. 2X4 SUSPENDED ACOUSTICAL CEILING SYSTEM.
5. RESILIENT CORNER GUARD. SUPPLEMENT AS REQUIRED.
6. GYPSUM BOARD OVER METAL STUDS COLUMN ENCLOSURE.
7. HEAT-WELDED VINYL FLOORING. REPLACE AS INDICATED.
8. REINSTALLED RESILIENT KICKGUARD. SUPPLEMENT AS REQUIRED.
9. REINSTALLED RESILIENT HANDRAIL. SUPPLEMENT AS REQUIRED.
10. EXISTING CERAMIC TILE WAINSCOT.
11. EXISTING GYPSUM BOARD OVER METAL STUD SOFFIT.
12. REINSTALLED WALL-HUNG PICTURE AND FRAME.
13. REINSTALLED FIRE EXTINGUISHER/FIRE EXTINGUISHER CABINET.
14. VINYL COMPOSITE TILE.
15. EXISTING SHELVING.
16. EXISTING MOSAIC TILE FLOORING.
17. EXISTING TABLE AND CHAIRS.
18. REINSTALLED EXISTING CHAIR RAIL.
19. REINSTALLED EXISTING PYXIS MACHINE.
20. REINSTALLED EXPANSION JOINT COVER.
21. EXISTING CASEWORK.
22. EXISTING MINI-FRIDGE.
23. EXISTING ICE MACHINE.
24. REINSTALLED WALL-MOUNTED TELEVISION.
25. EXISTING SIGNAGE.
26. EXISTING CARPET TILE.
27. EXISTING BUILDING SYSTEMS EQUIPMENT. RE: PLUMBING, MECHANICAL ELECTRICAL.
28. GYPSUM BOARD REVEAL.
29. PROJECTION SCREEN (CEILING HUNG).
30. EXISTING WAITING ROOM FURNITURE.
31. EXISTING STOREFRONT WINDOW SYSTEM.
32. WALL BASE.

COORDINATION NOTE:
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KEY PLAN

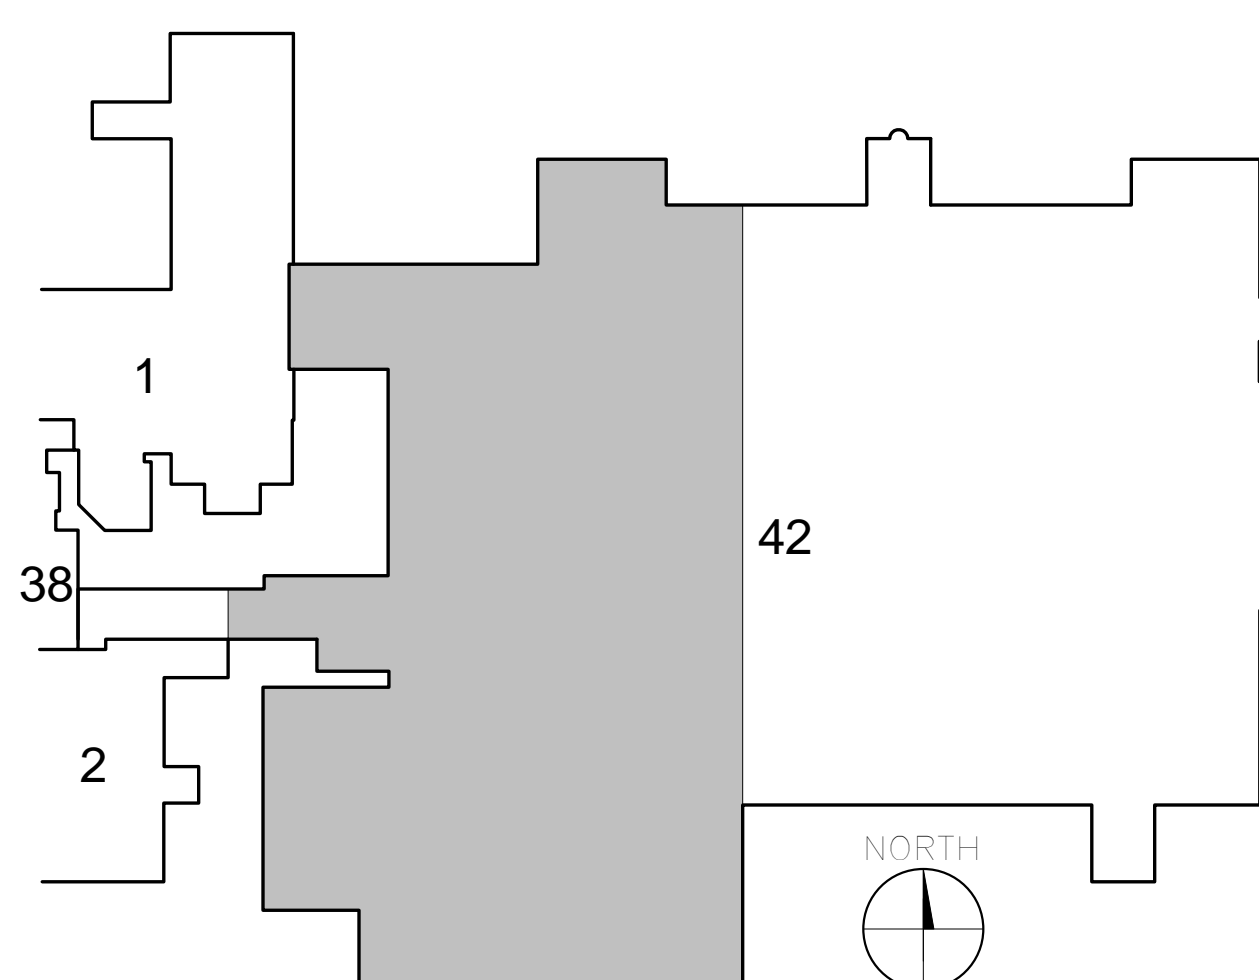100% BID DOCUMENTS

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SHEILA A. BAYSINGER
Professional Engineer
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PROJECT MANAGER:

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Raleigh, NC
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Pittsburgh, PA
Virginia Beach, VA
Fort Collins, CO

Project Number
16-198

Scale
AS INDICATED

Office of
Construction
and Facilities
Management



Drawing Title:
ENLARGED PLANS AND INTERIOR ELEVATIONS - RENOVATION

Location

**MARION VAMC
MARION, IL, 62959**

Project Title:
ADD STRUCTURAL IMPROVEMENTS TO BUILDING 42

Approved: Project Director

Date
09/06/17

Checked
HKG

Drawn
MNH


VA PROJECT NUMBER
657-343

Building Number
42


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A1410


Dwg. 47 of 81

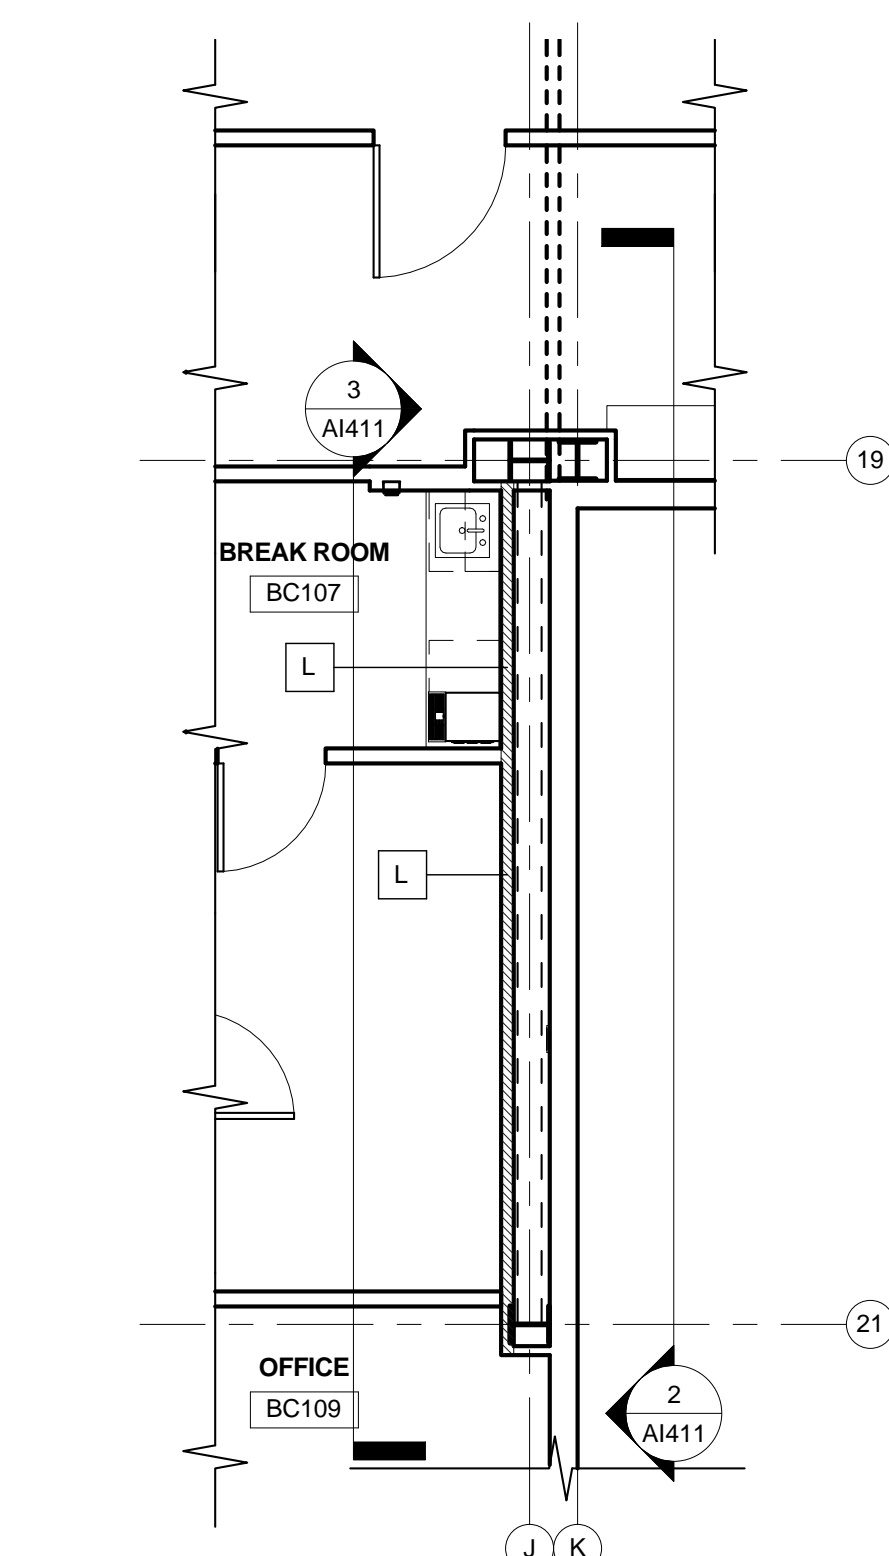


1 Brace L Plan - Renovation
3/16" = 1'-0"

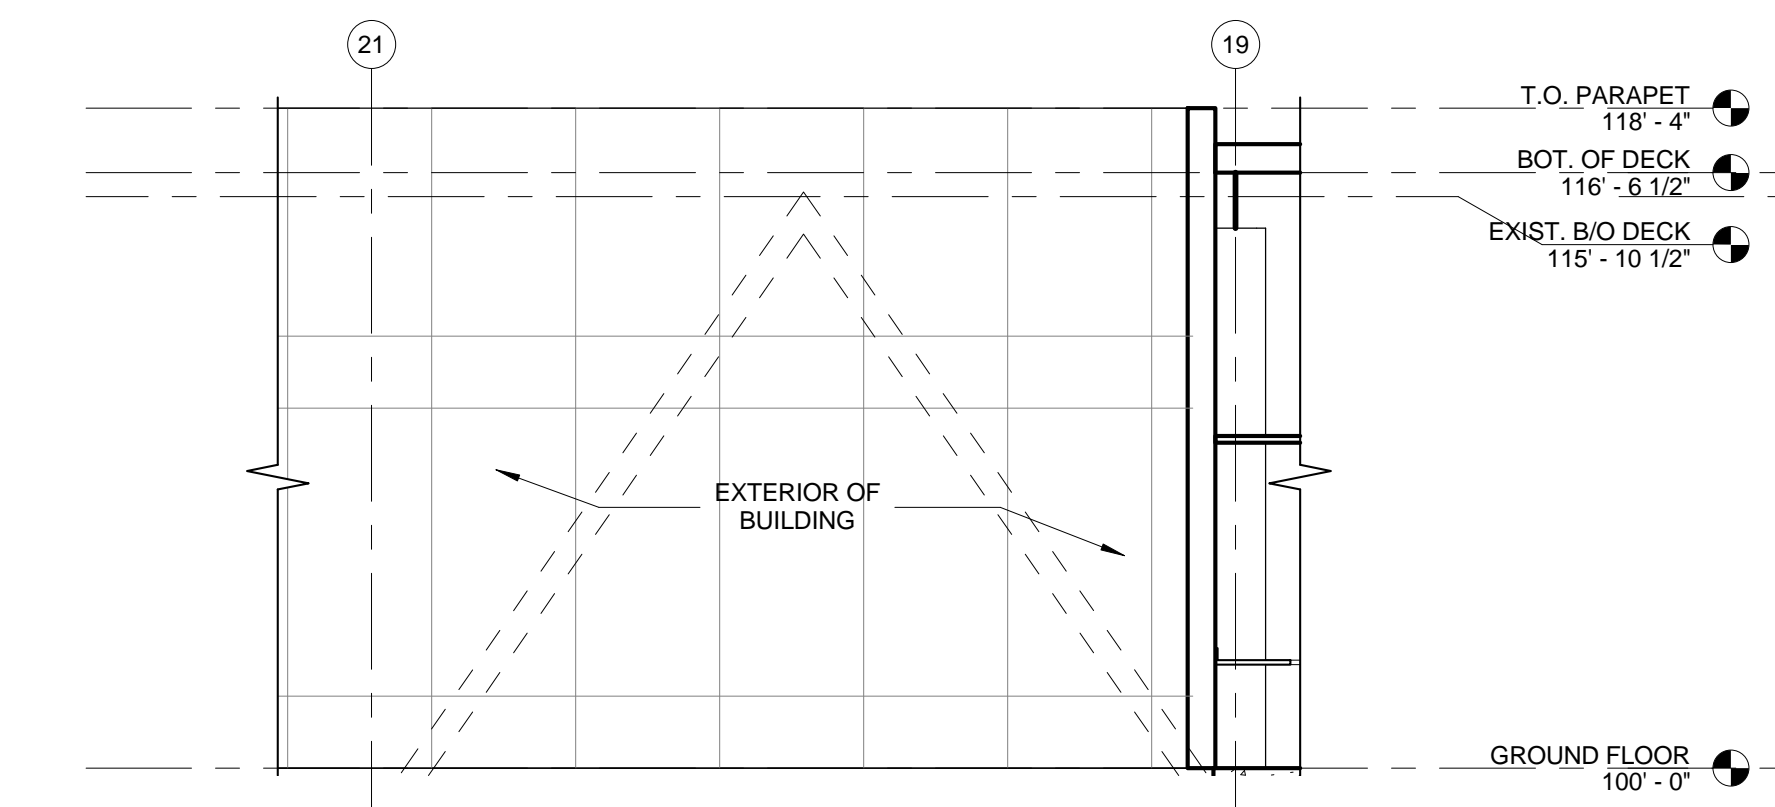


2 Brace L East Elevation - Renovation
3/16" = 1'-0"

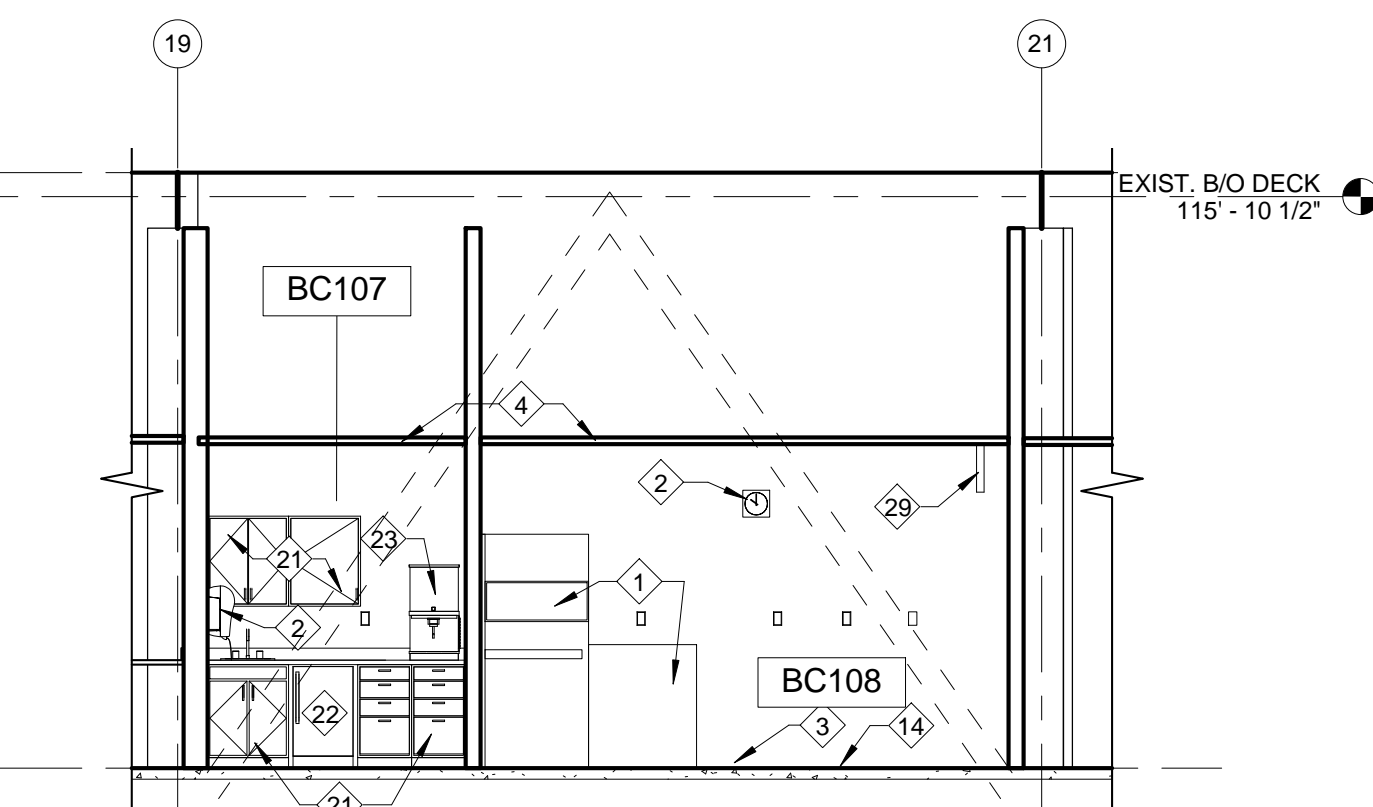


3 Brace L West Elevation - Renovation
3/16" = 1'-0"

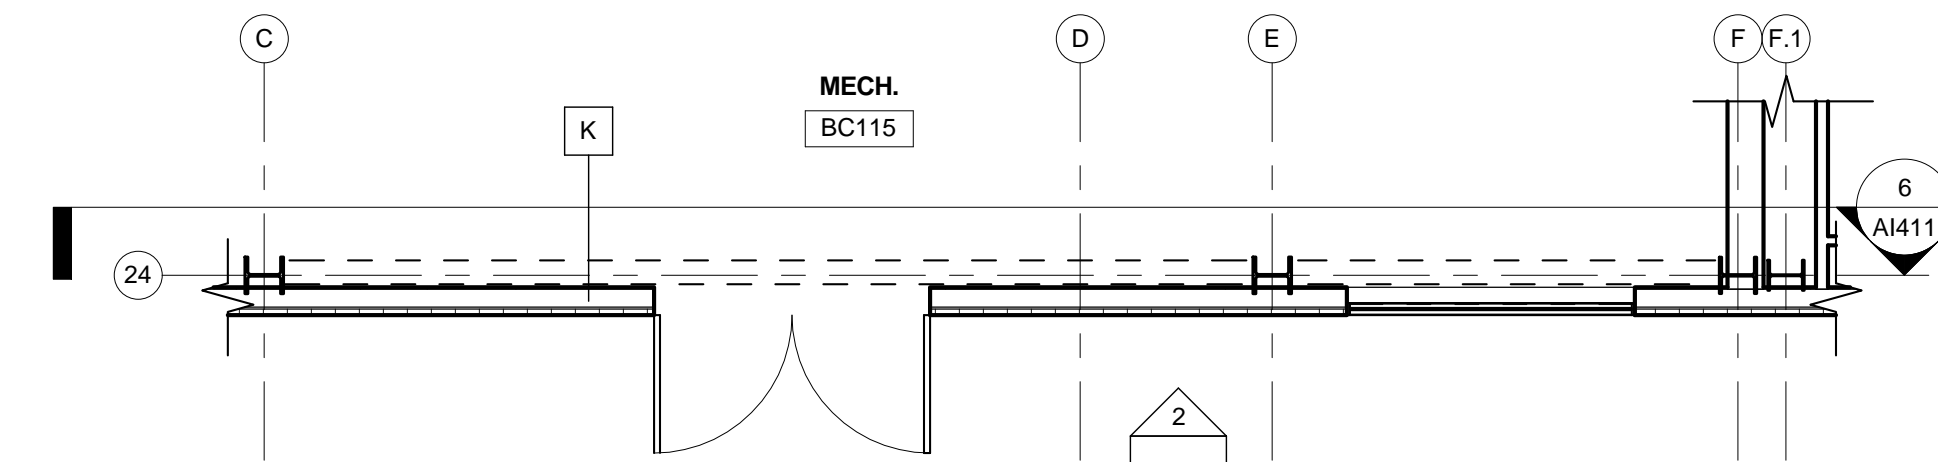

4 Brace M Plan - Renovation
3/16" = 1'-0"

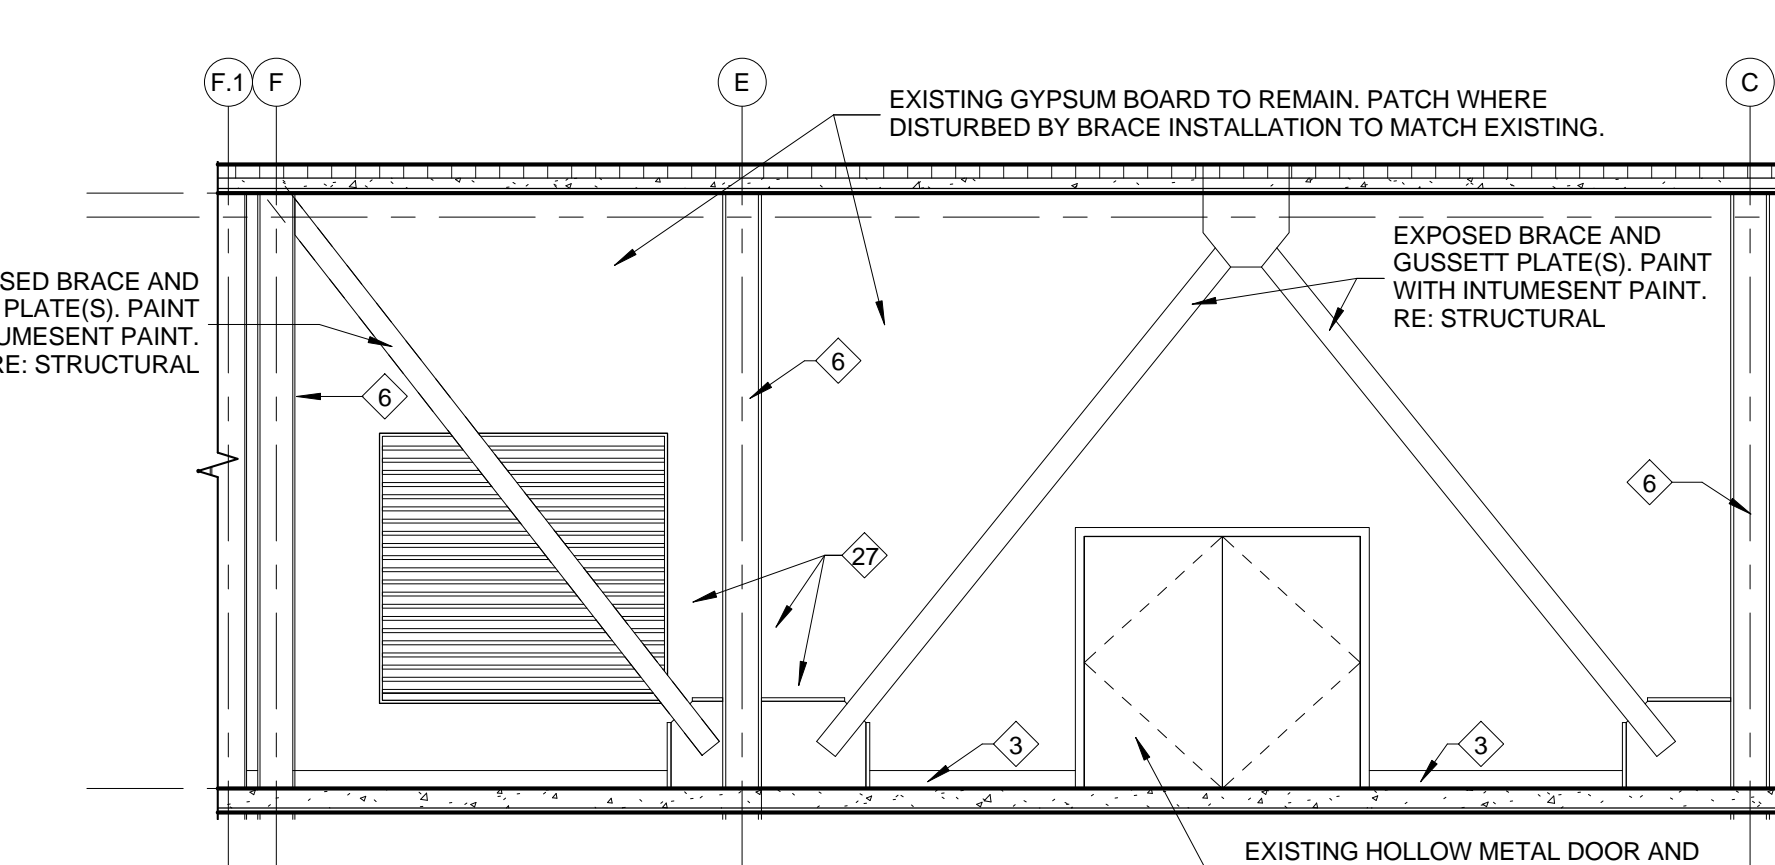


6 Brace M North Elevation - Renovation
3/16" = 1'-0"

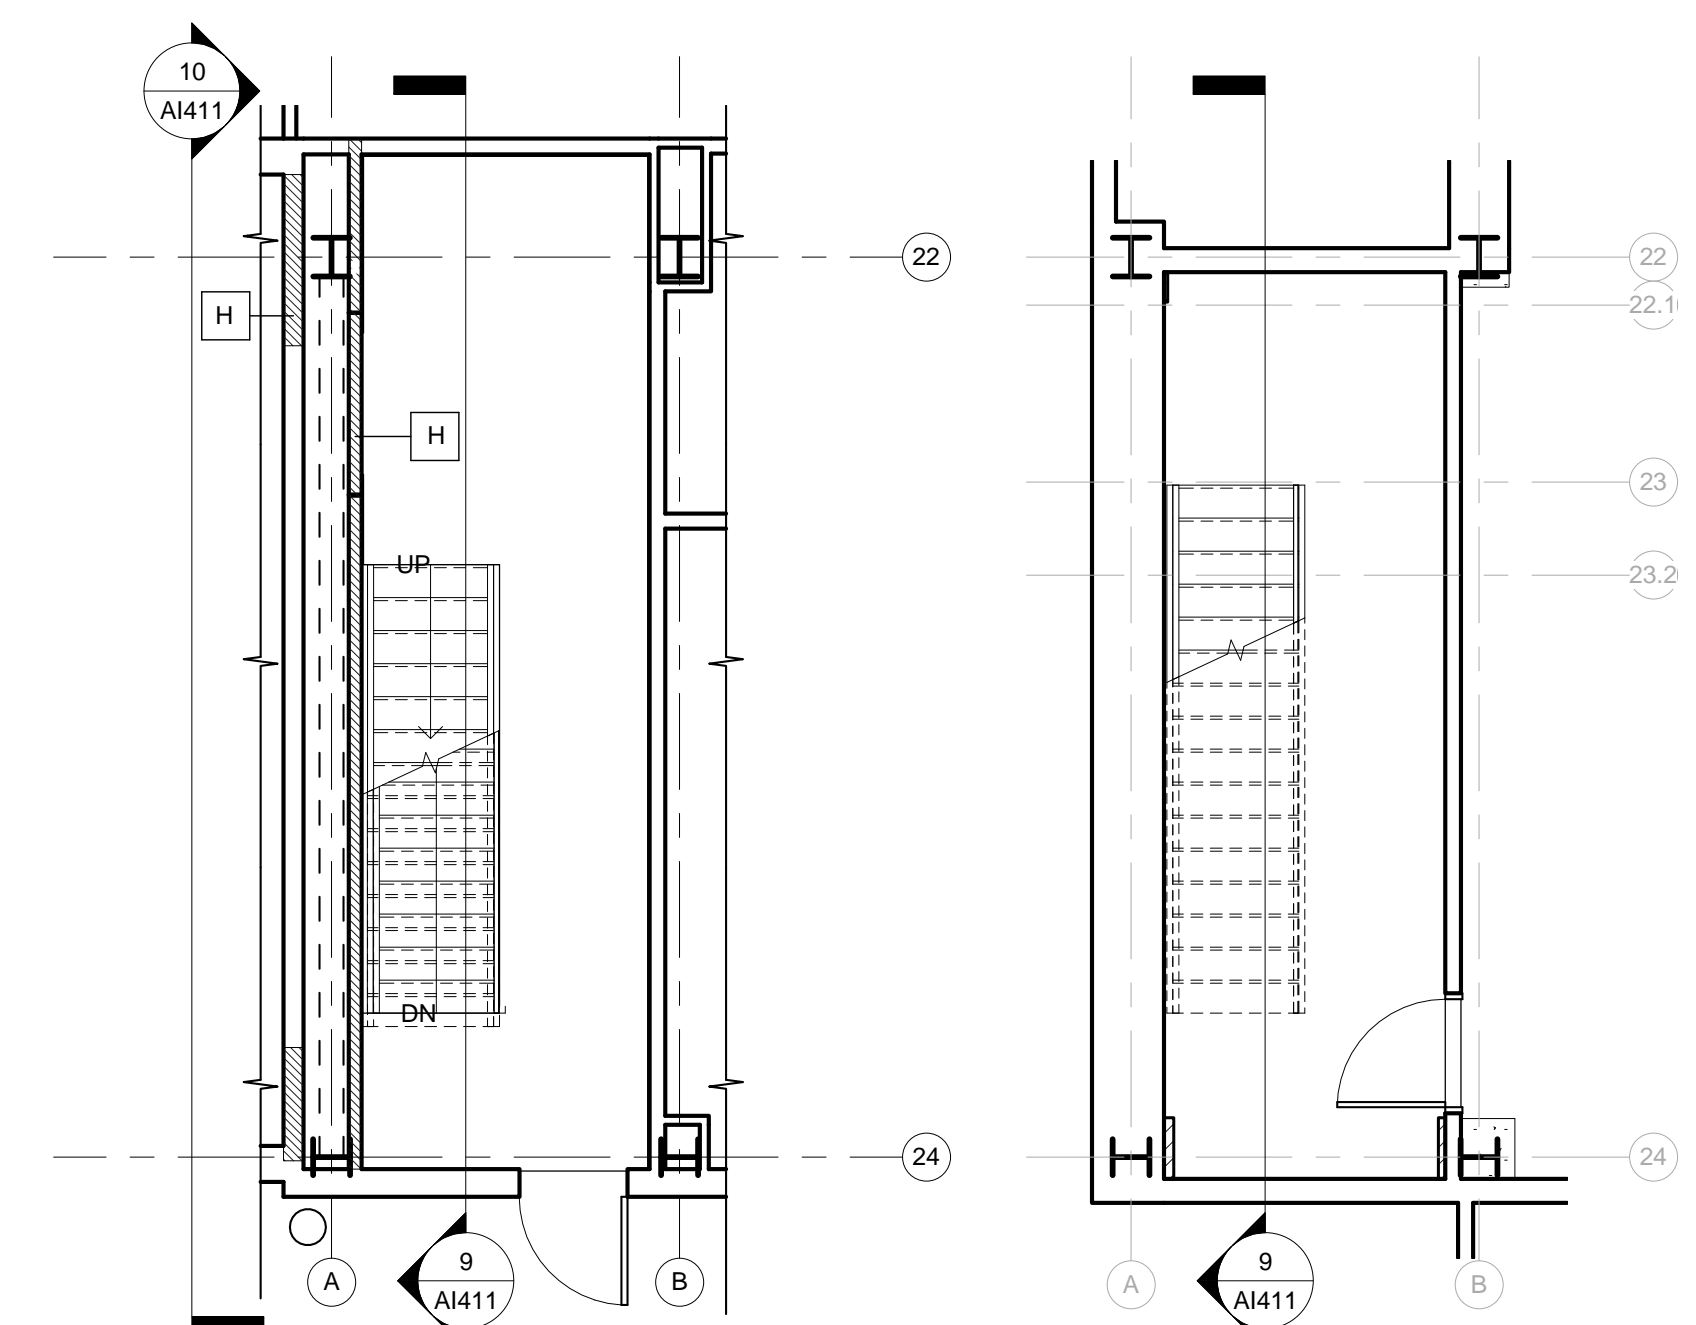


7 Brace N Plan - Renovation
3/16" = 1'-0"


8 BRACE N PLAN - SUB-BASEMENT LEVEL - RENOVATIONS
3/16" = 1'-0"

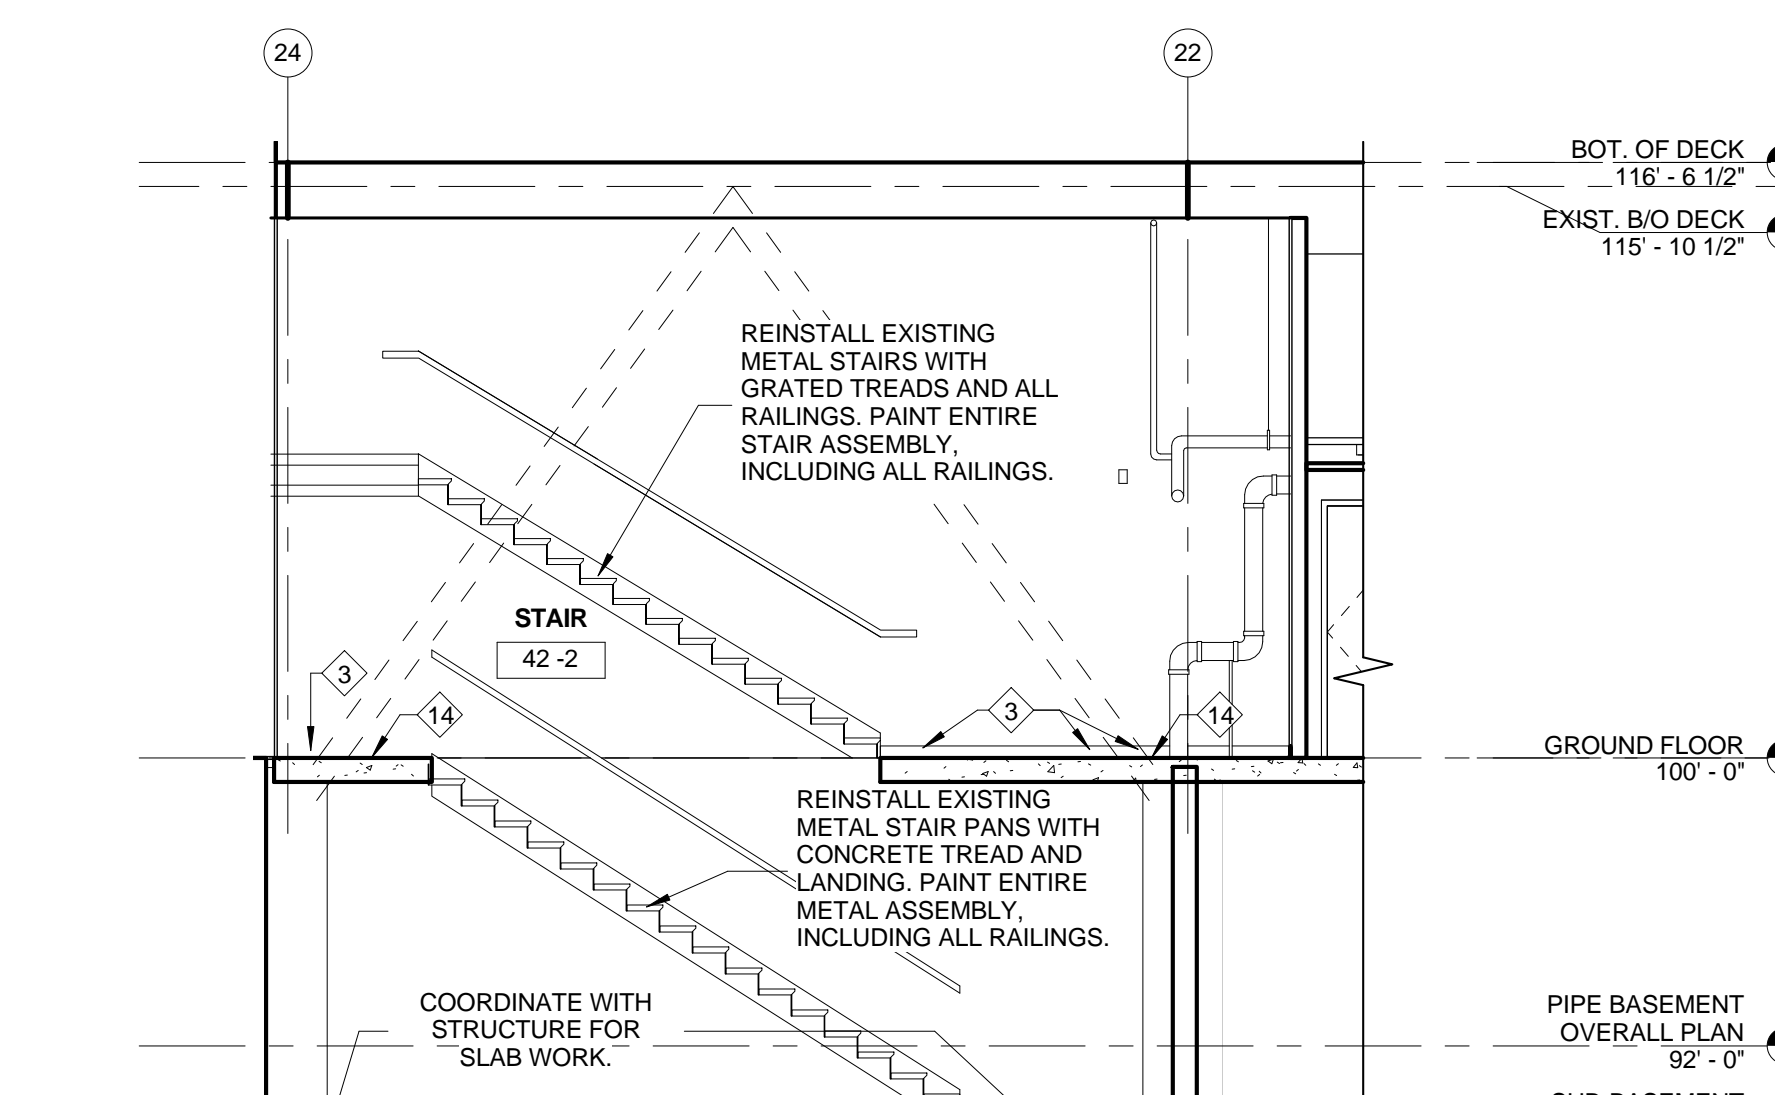


9 Brace N East Elevation - Renovation
3/16" = 1'-0"

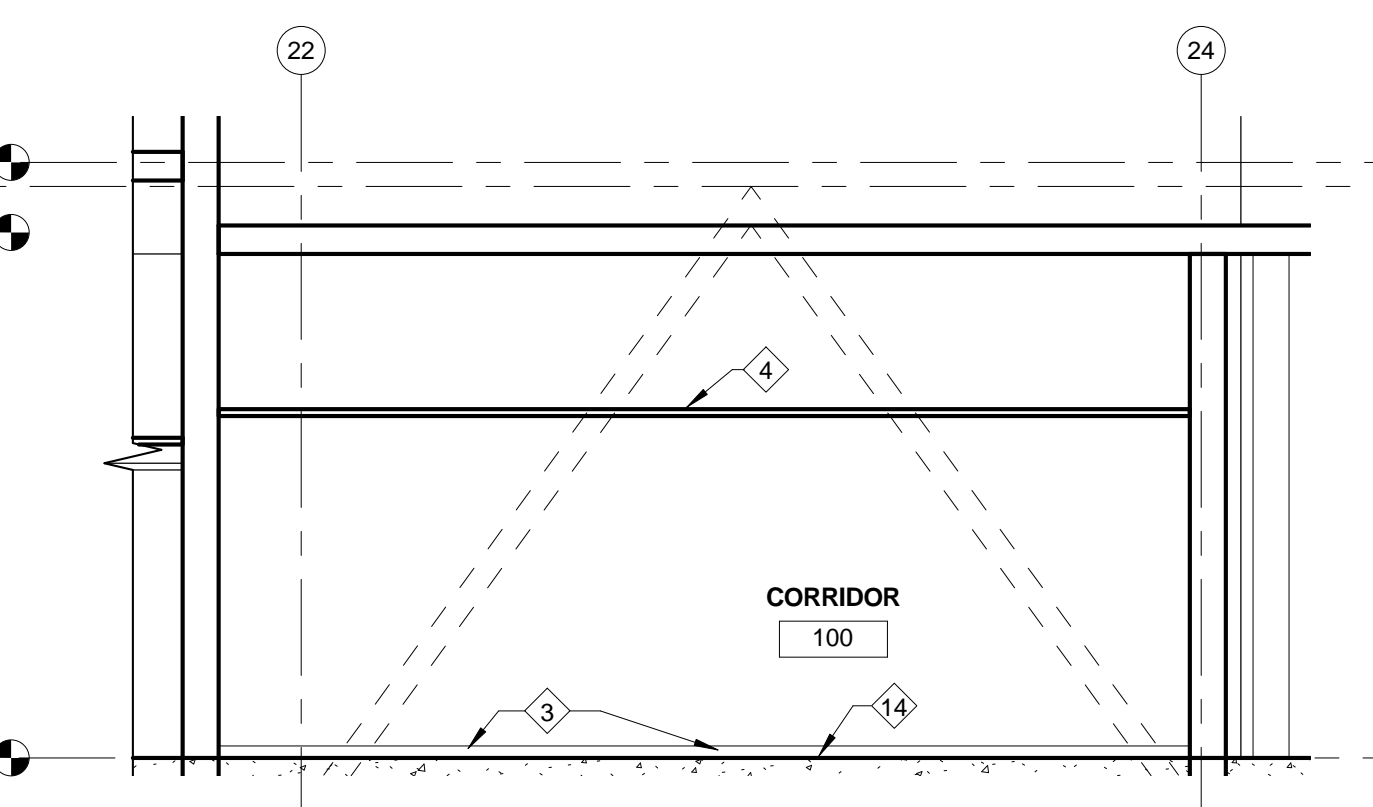


10 Brace N West Elevation - Renovation
3/16" = 1'-0"

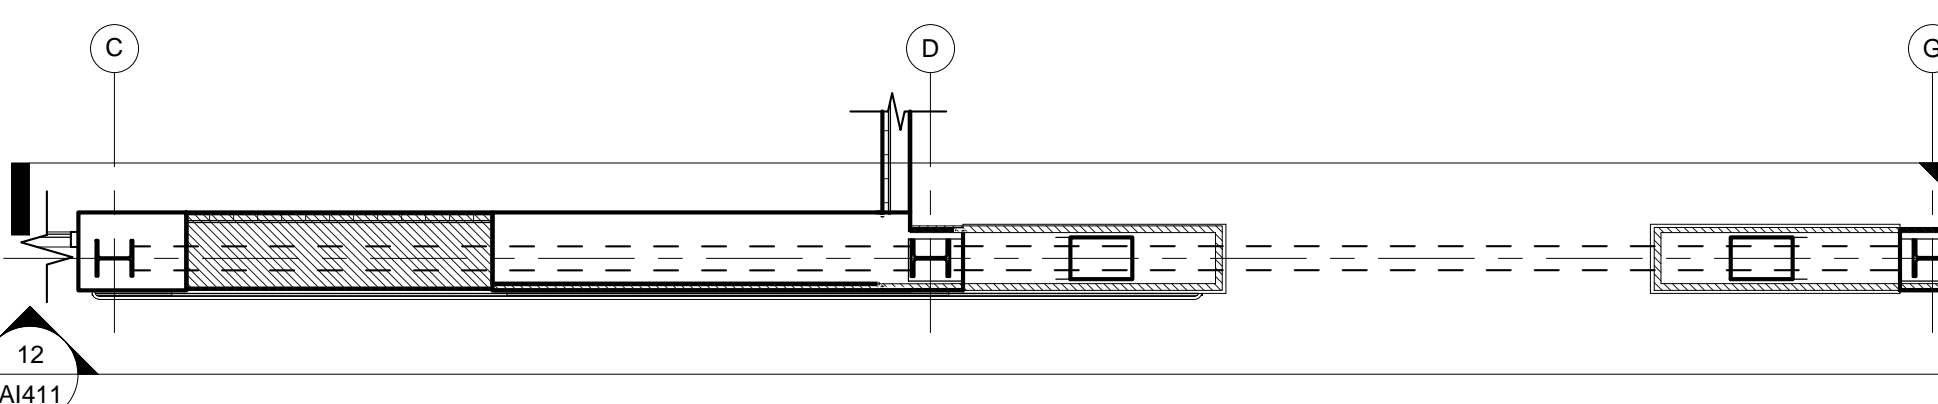

11 Brace Q Plan - Renovation
3/16" = 1'-0"

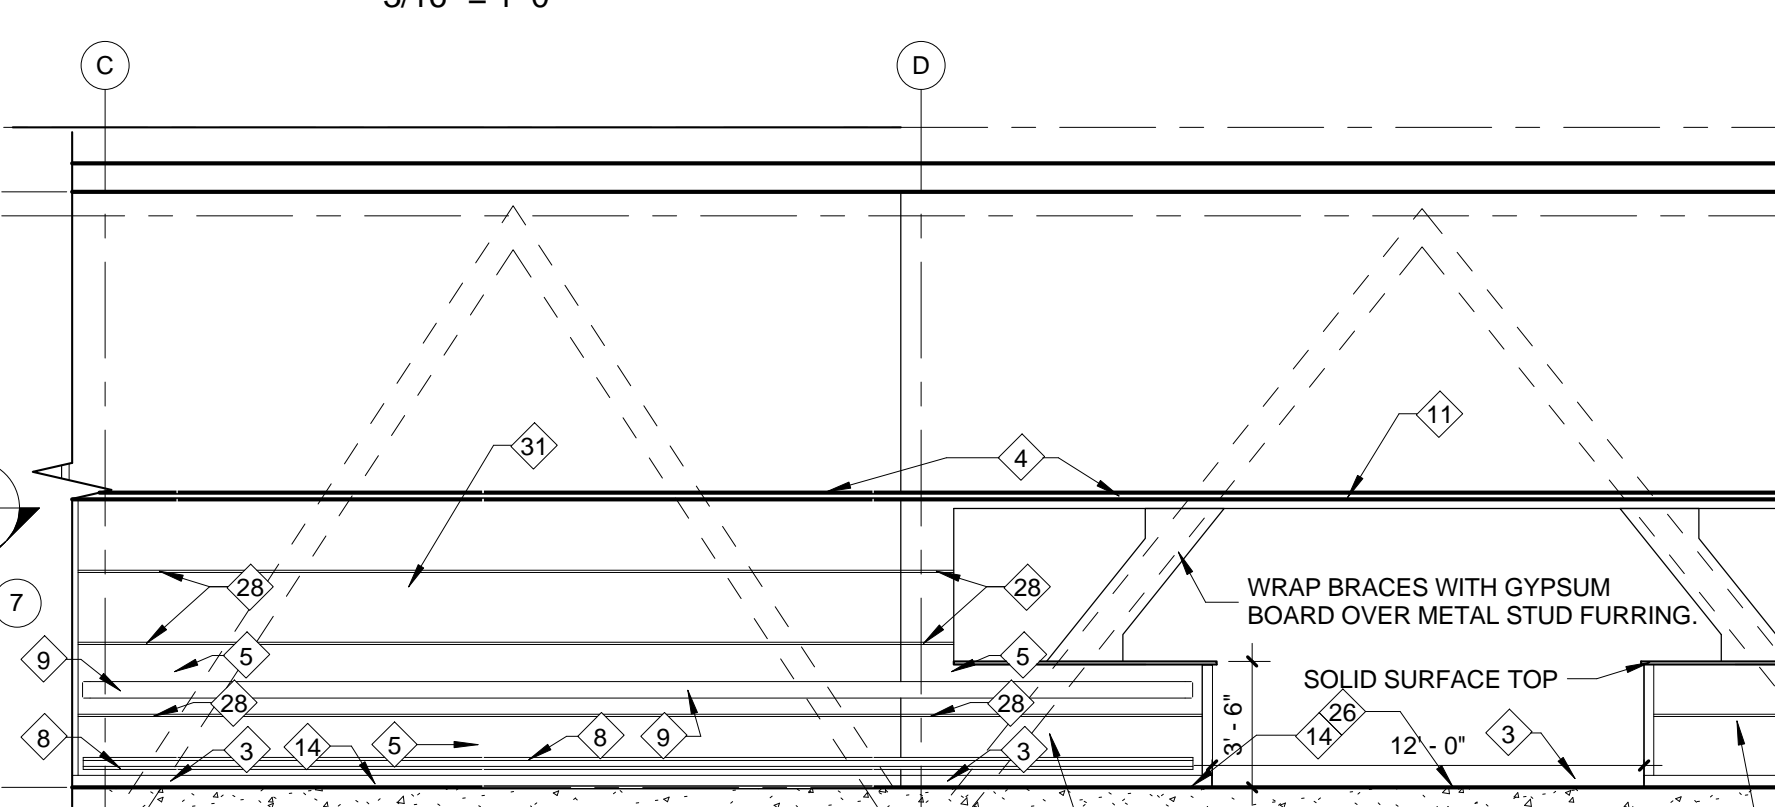

12 Brace Q South Elevation - Renovation
3/16" = 1'-0"

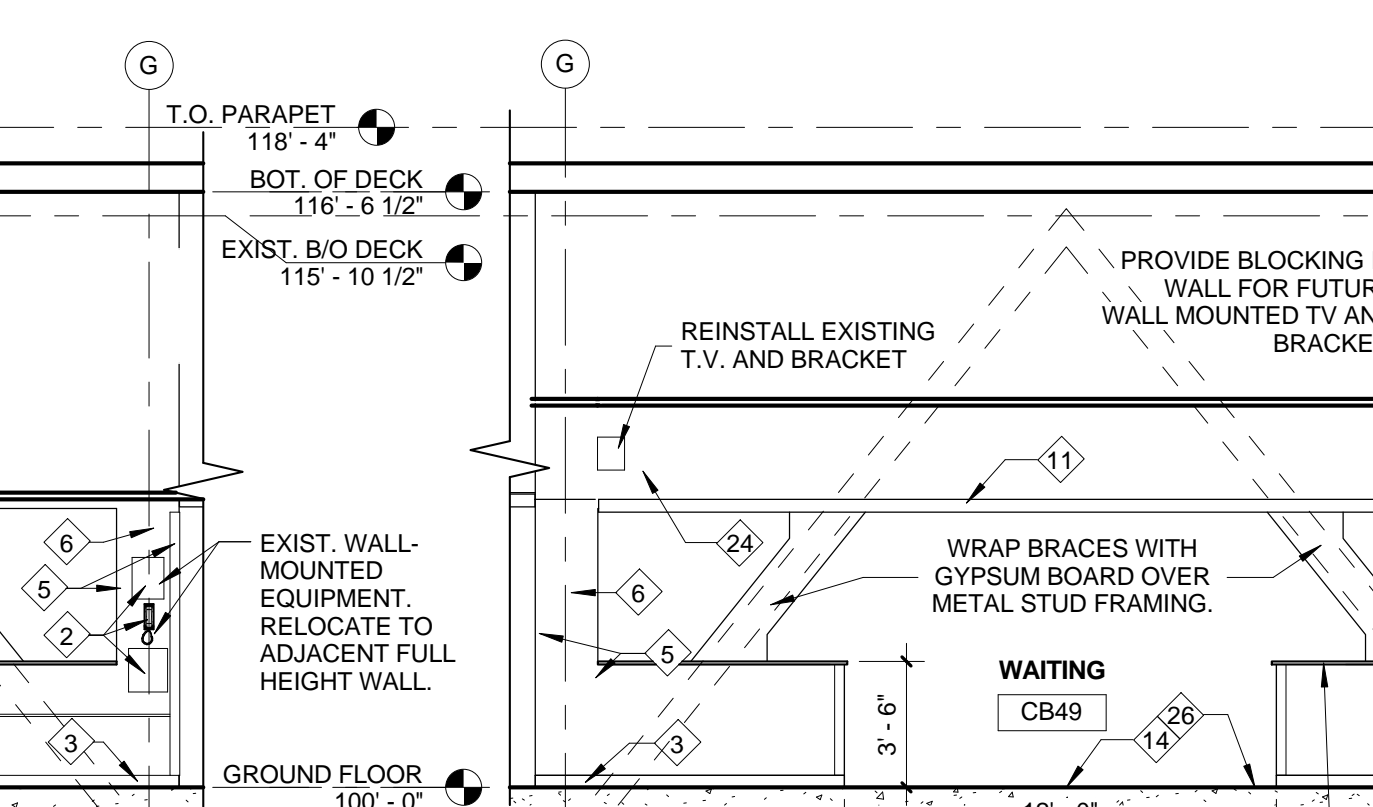


13 Brace Q North Elevation - Renovation
3/16" = 1'-0"

NOTE
REFER TO DEMOLITION AND RENOVATION SHEETS AND ROOM FINISH SCHEDULE FOR ADDITIONAL INFORMATION.

KEYED NOTES - APPLY TO AI410 AND AI411 ONLY

1. REINSTALL/REPLACE EXISTING SYSTEMS FURNITURE.
2. REINSTALLED WALL MOUNTED EQUIPMENT.
3. EXISTING WALL BASE. SUPPLEMENT AS REQUIRED.
4. 2X4 SUSPENDED ACOUSTICAL CEILING SYSTEM.
5. RESILIENT CORNER GUARD. SUPPLEMENT AS REQUIRED.
6. GYPSUM BOARD OVER METAL STUDS COLUMN ENCLOSURE.
7. HEAT-WELDED VINYL FLOORING. REPLACE AS INDICATED.
8. REINSTALLED RESILIENT KICKGUARD. SUPPLEMENT AS REQUIRED.
9. REINSTALLED RESILIENT HANDRAIL. SUPPLEMENT AS REQUIRED.
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12. REINSTALLED WALL-HUNG PICTURE AND FRAME.
13. REINSTALLED FIRE EXTINGUISHER/FIRE EXTINGUISHER CABINET.
14. VINYL COMPOSITE TILE.
15. EXISTING SHELVING.
16. EXISTING MOSAIC TILE FLOORING.
17. EXISTING TABLE AND CHAIRS.
18. REINSTALLED EXISTING CHAIR RAIL.
19. REINSTALLED EXISTING PYXIS MACHINE.
20. REINSTALLED EXPANSION JOINT COVER.
21. EXISTING CASEWORK.
22. EXISTING MINI-FRIDGE.
23. EXISTING ICE MACHINE.
24. REINSTALLED WALL-MOUNTED TELEVISION.
25. EXISTING SIGNAGE.
26. EXISTING CARPET TILE.
27. EXISTING BUILDING SYSTEMS EQUIPMENT. RE: PLUMBING, MECHANICAL, ELECTRICAL.
28. GYPSUM BOARD REVEAL.
29. PROJECTION SCREEN (CEILING HUNG).
30. EXISTING WAITING ROOM FURNITURE.
31. EXISTING STOREFRONT WINDOW SYSTEM.
32. WALL BASE.

COORDINATION NOTE:
COORDINATE PHASING OF ALL STRUCTURAL CONSTRUCTION WITH OTHER DISCIPLINES AS NECESSARY TO MAINTAIN AND PROTECT MEP EQUIPMENT AND LINES IN SERVICE THROUGHOUT DURATION OF CONSTRUCTION. CONTRACTOR TO PROVIDE COORDINATION/PHASING DOCUMENTS FOR APPROVAL BY THE COR.

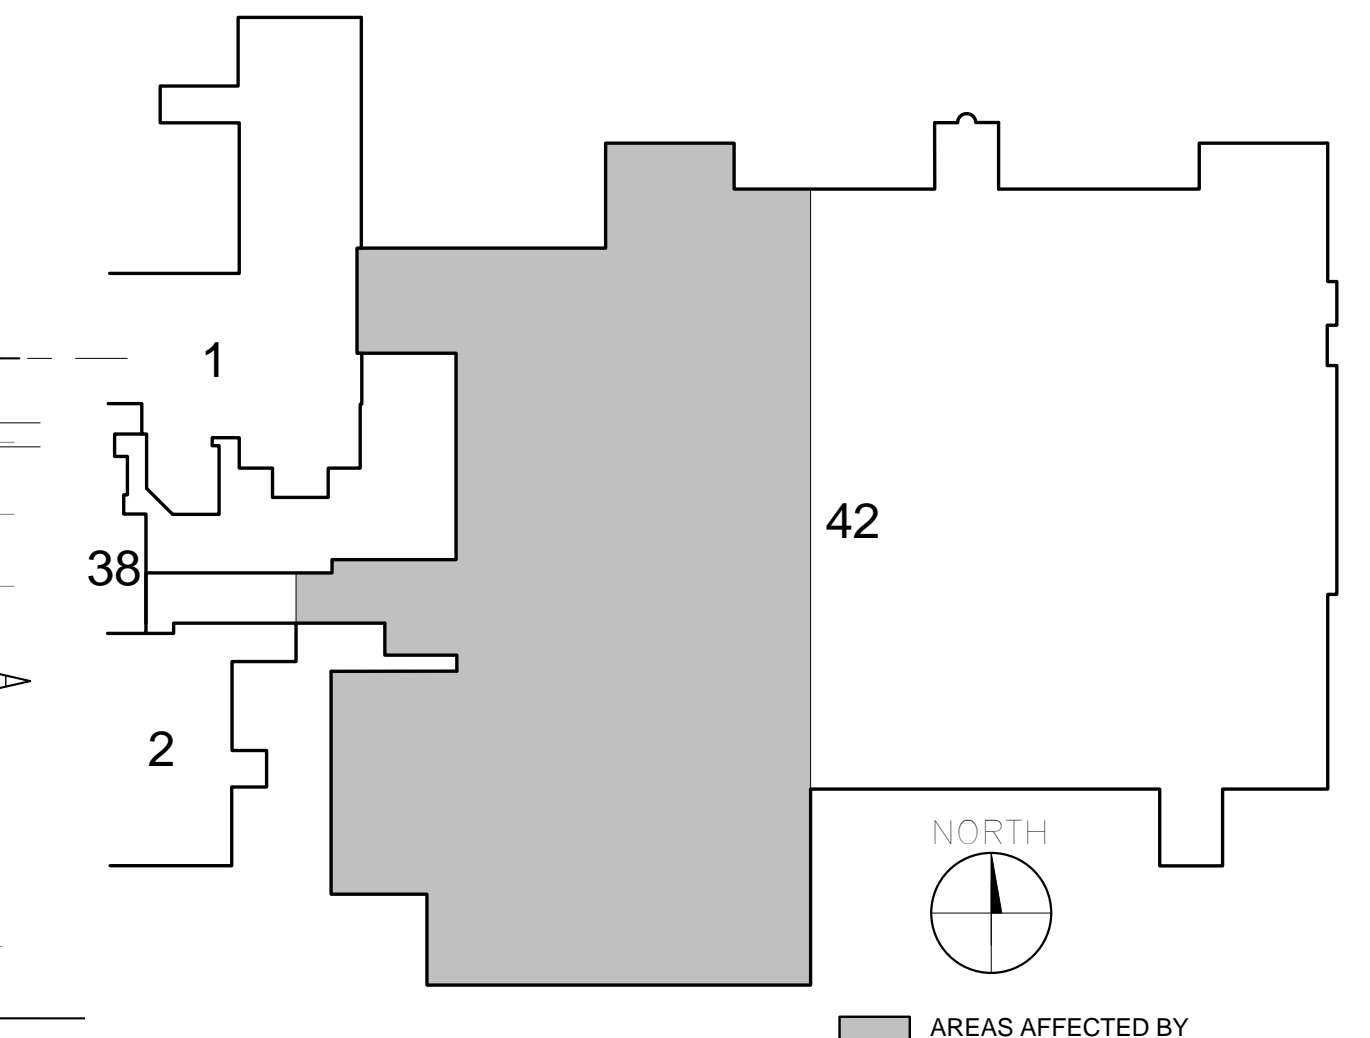

KEY PLAN

100% BID DOCUMENTS


CONSULTANTS:



PROJECT MANAGER:



Project Number 16-198
Scale AS INDICATED

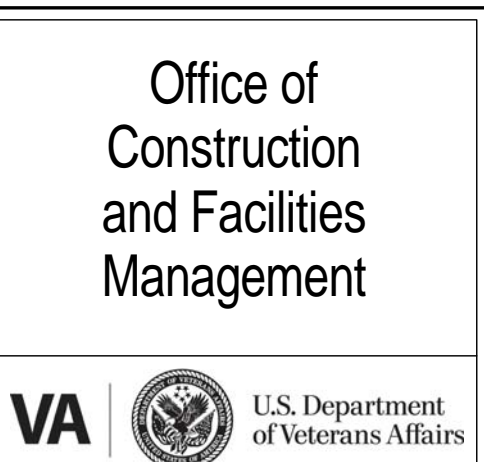

Drawing Title:
ENLARGED PLANS AND INTERIOR ELEVATIONS - RENOVATION


Location
**MARION VAMC
MARION, IL, 62959**

Project Title:
ADD STRUCTURAL IMPROVEMENTS TO BUILDING 42

Approved: Project Director
Date 09/06/17
Checked HKG
Drawn MNH

VA PROJECT NUMBER 657-343
Building Number 42
Drawing Number **AI411**
Dwg. 48 of 81



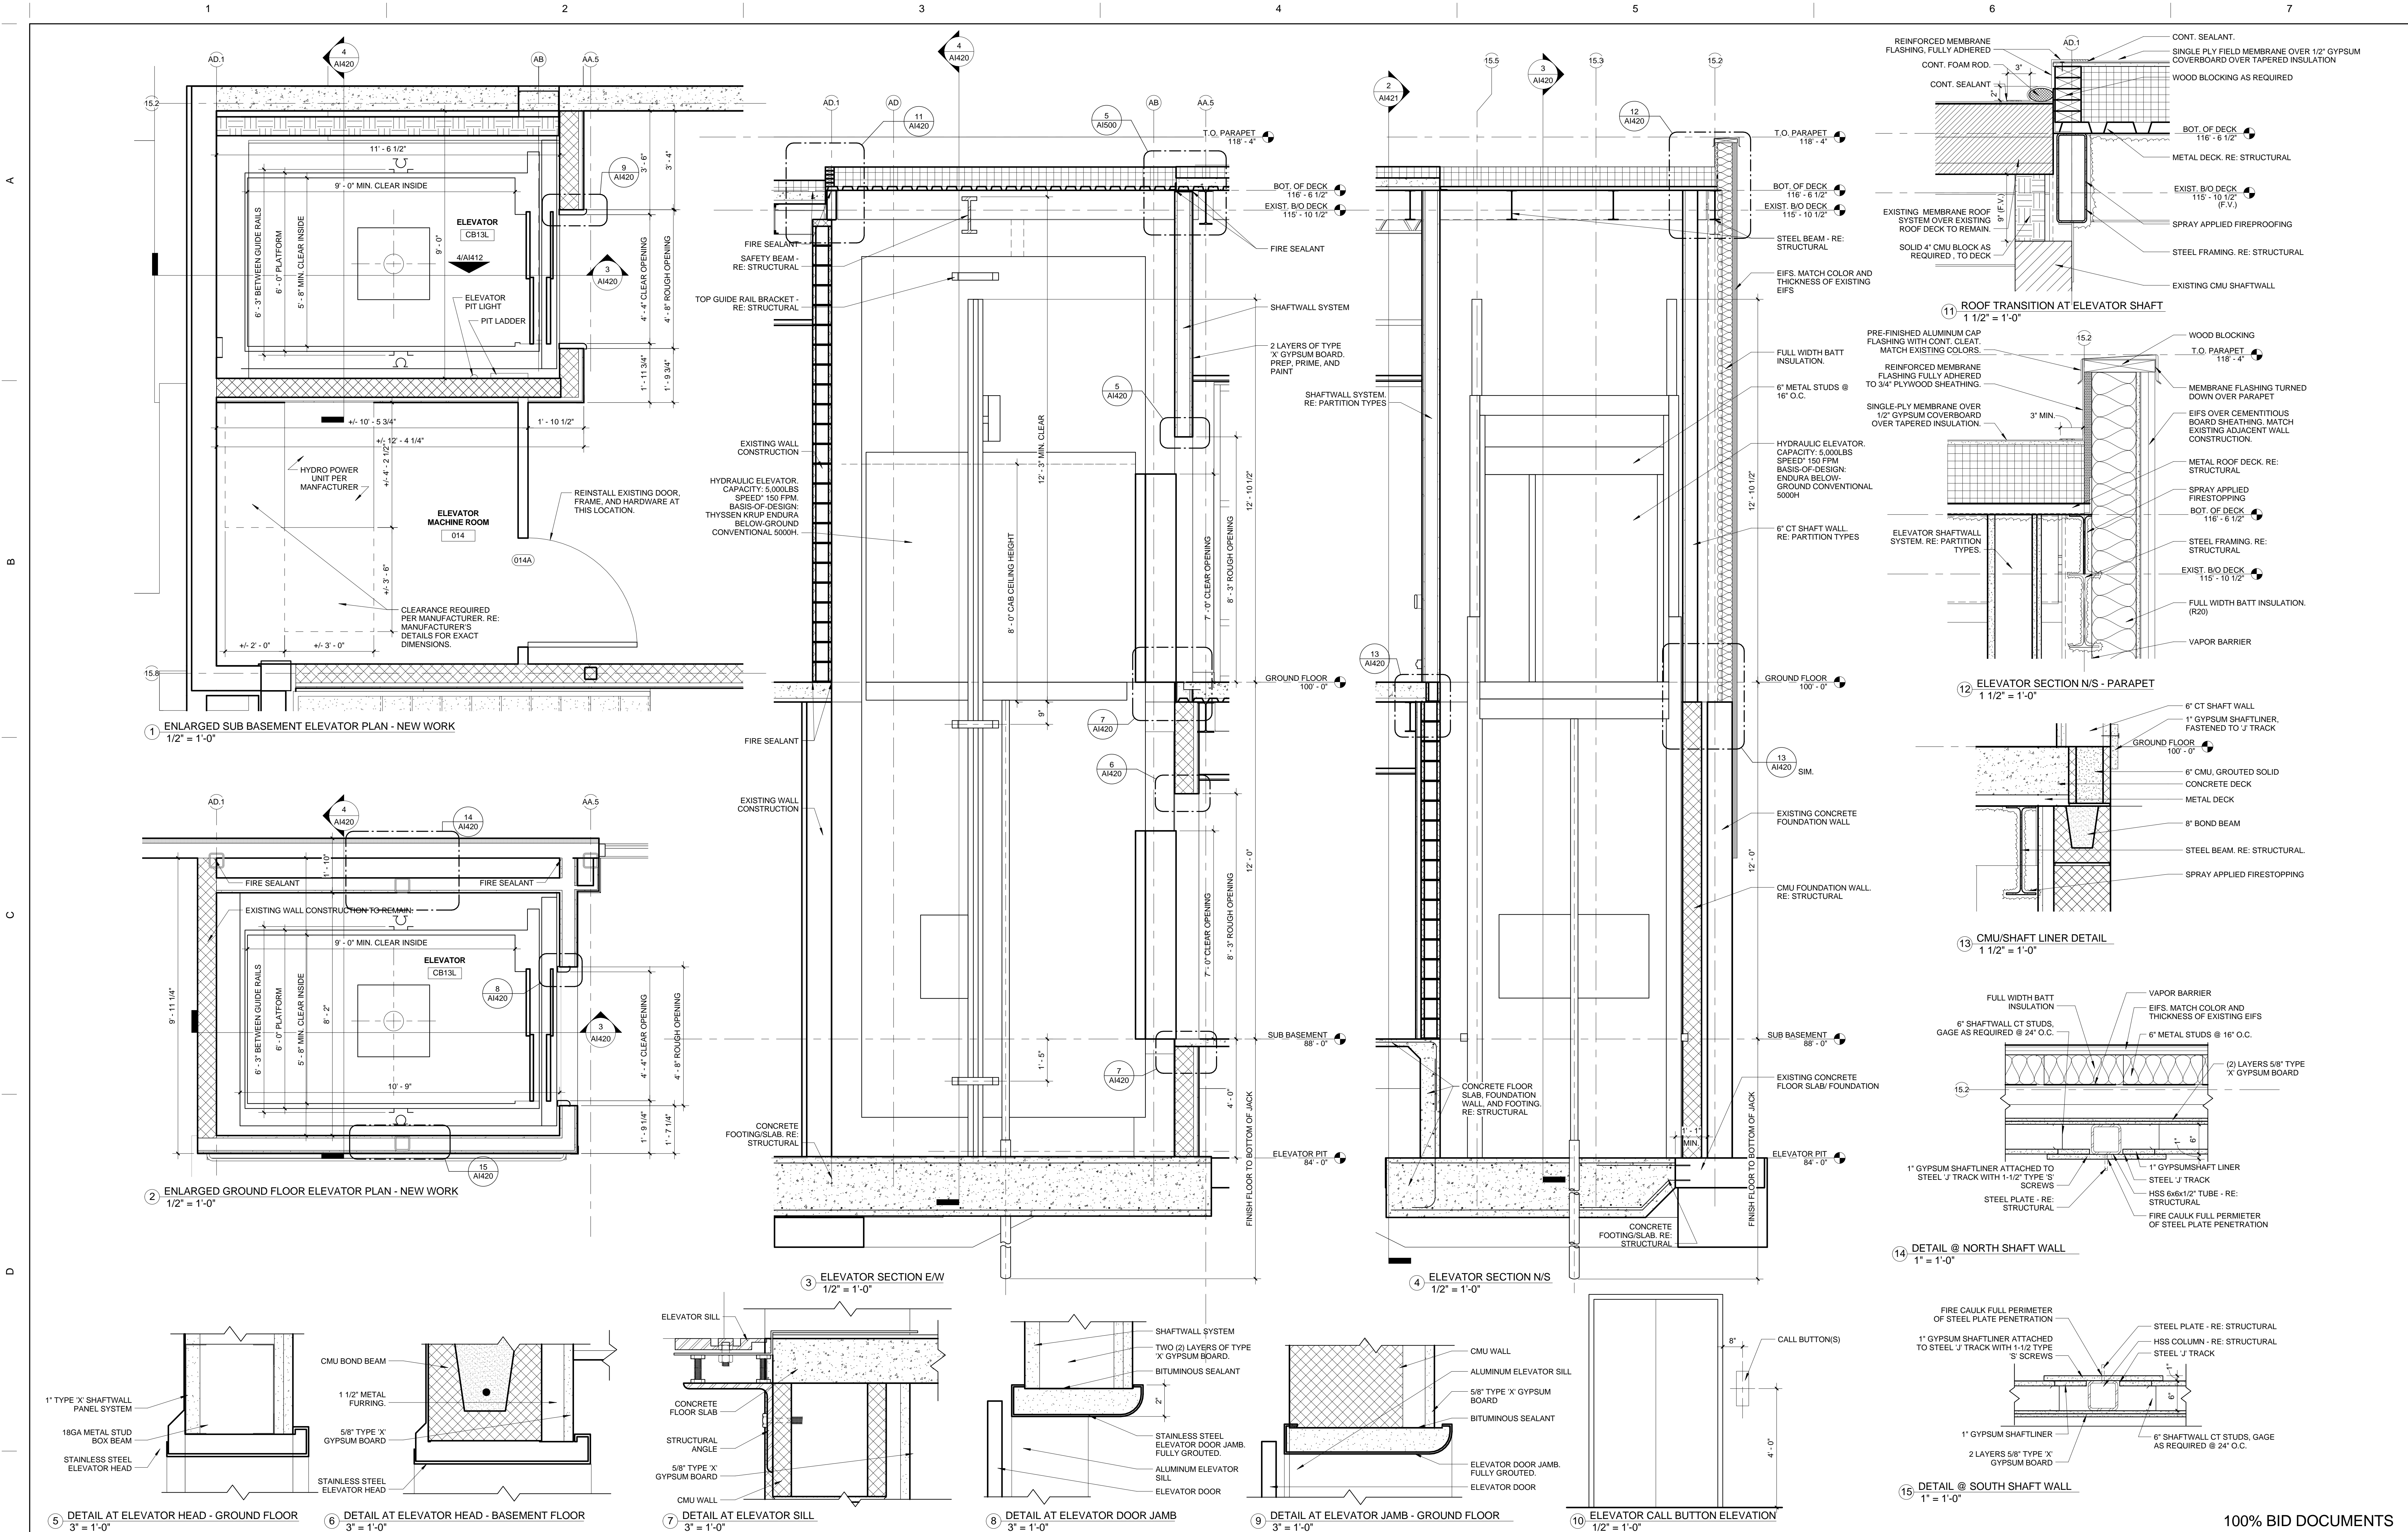

CONSULTANTS:

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PROJECT MANAGER:

APOGEE
Consulting Group
Engineers | Architects
www.apogee-gpa.com
919-858-7420

Project Number
16-198

Scale
AS INDICATED

Office of
Construction
and Facilities
Management



Drawing Title:
**ENLARGED ELEVATOR PLANS AND
SECTIONS**

Location

**MARION VAMC
MARION, IL, 62959**

Project Title:
**ADD STRUCTURAL
IMPROVEMENTS TO BUILDING
42**

Approved: Project Director

Date
09/06/17

Checked
HKG

Drawn
SPH

VA PROJECT NUMBER
657-343


Building Number
42

Drawing Number

A1420


Dwg. 50 of 81

100% BID DOCUMENTS

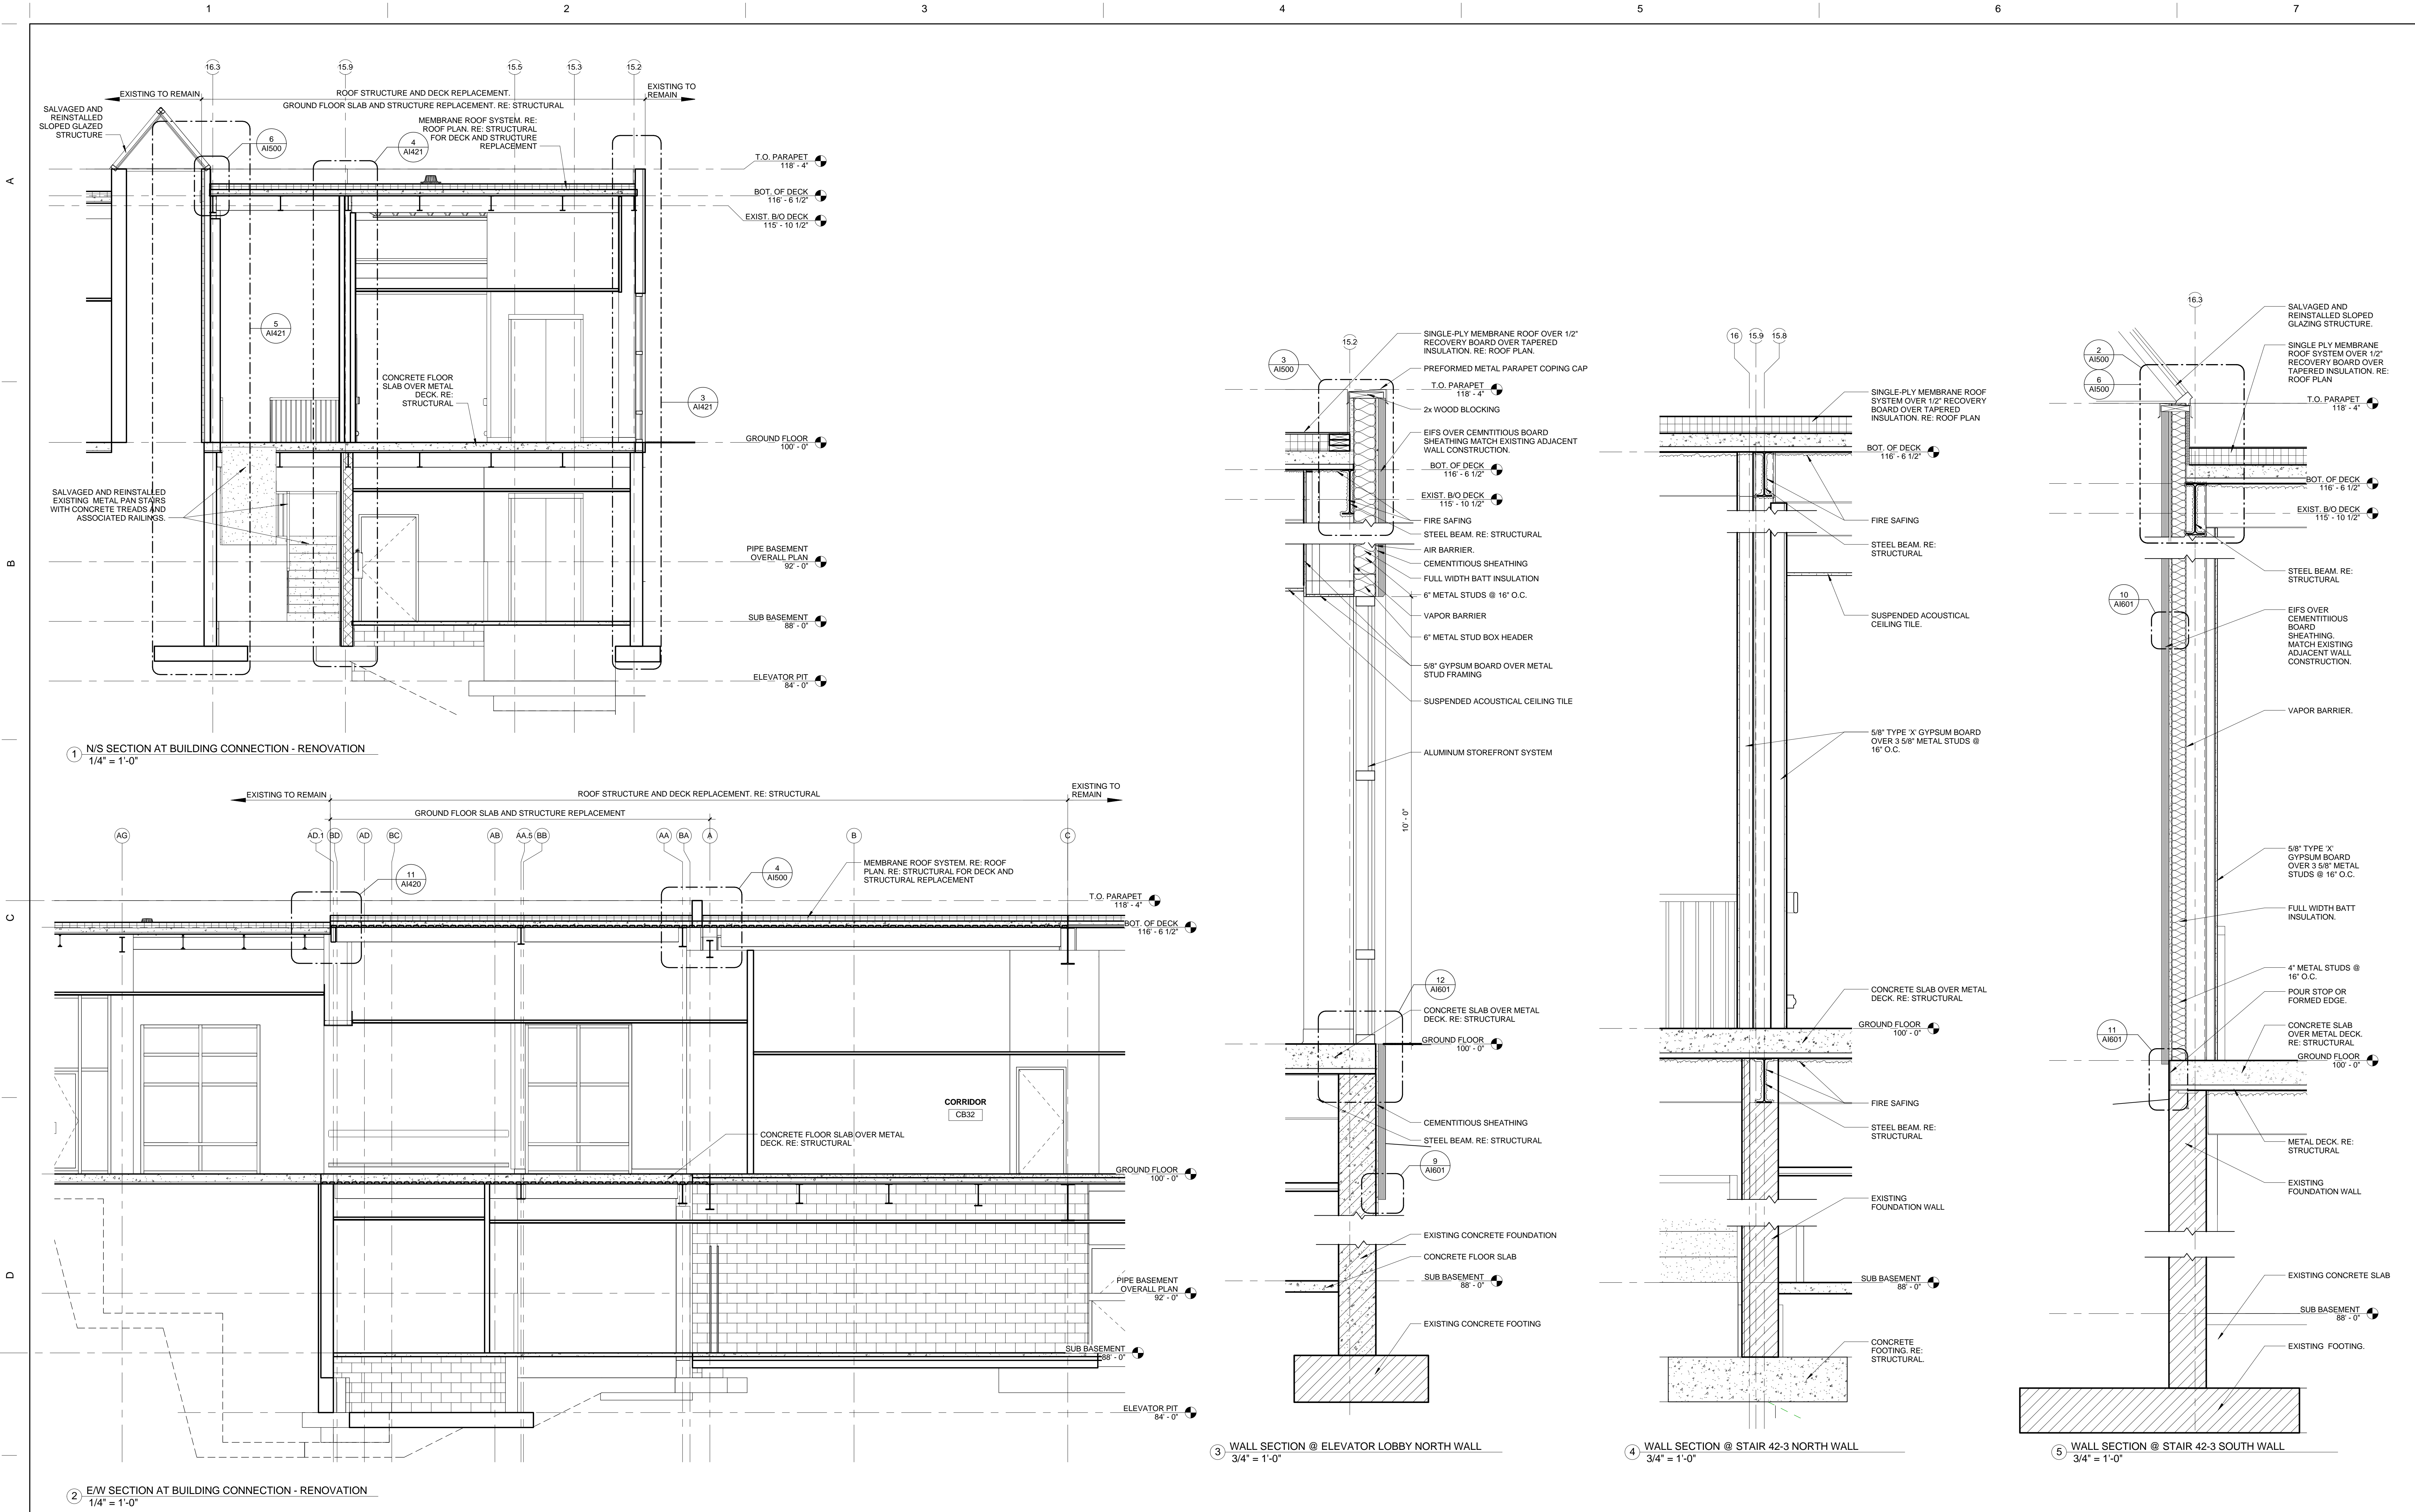

100% BID DOCUMENTS

<div>Revision 1</div> <div>Revisions:</div>		<div>Date 1</div> <div>Date</div>		<div>CONSULTANTS:</div> <div><div><div><div></div><div>Baysinger Design Group, Inc.</div><div>4301 West DuPont Street, Suite 100B Metairie, Illinois 60120</div></div><div><div>Phone: 630.990.8015</div><div>Fax: 630.990.8012</div><div>www.BaysingerDesignGroup.com</div></div><div><div>Illness Design Firm No. 16491012</div><div>www.BaysingerDesignGroup.com</div></div></div><div><div><div></div><div>AMERICAN STRUCTUREPOINT INC.</div><div>7240 Shadeland Station, Indianapolis, IN 46256</div><div>TEL: 317.543.5500 FAX: 317.543.5570</div><div>www.structurepoint.com</div></div></div><div><div><div>STATE OF ILLINOIS SHEILA ARCHITECT</div><div>EXPIRES 11-30-18</div></div></div></div>		<div>PROJECT MANAGER:</div> <div><div><div><div></div><div>APOGEE</div><div>Consulting Group</div><div>Engineers Architects</div><div>www.acgp-gsa.com</div><div>919-858-7420</div></div><div><div>Raleigh, NC</div><div>Indianapolis, IN</div><div>Pittsburgh, PA</div><div>Virginia Beach, VA</div><div>Fort Collins, CO</div></div></div><div><div>Project Number</div><div>16-198</div></div><div><div>Scale</div><div>AS INDICATED</div></div></div>		<div>Office of Construction and Facilities Management</div> <div><div>VA</div><div><div>U.S. Department of Veterans Affairs</div></div></div>		<div>Drawing Title:</div> <div>BUILDING AND WALL SECTIONS</div> <div><div>Location</div><div>MARION VAMC MARION, IL, 62959</div></div>		<div>Project Title</div> <div>ADD STRUCTURAL IMPROVEMENTS TO BUILDING 42</div> <div><div>Approved: Project Director</div><div>Date</div><div>09/06/17</div><div>Checked</div><div>HKG</div><div>Drawn</div><div>SPH</div></div>		<div>VA PROJECT NUMBER</div> <div>657-343</div> <div><div>Building Number</div><div>42</div></div> <div><div>Drawing Number</div><div>A1421</div></div> <div><div>Dwg. 51 of 81</div></div>	
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ROOF NOTES

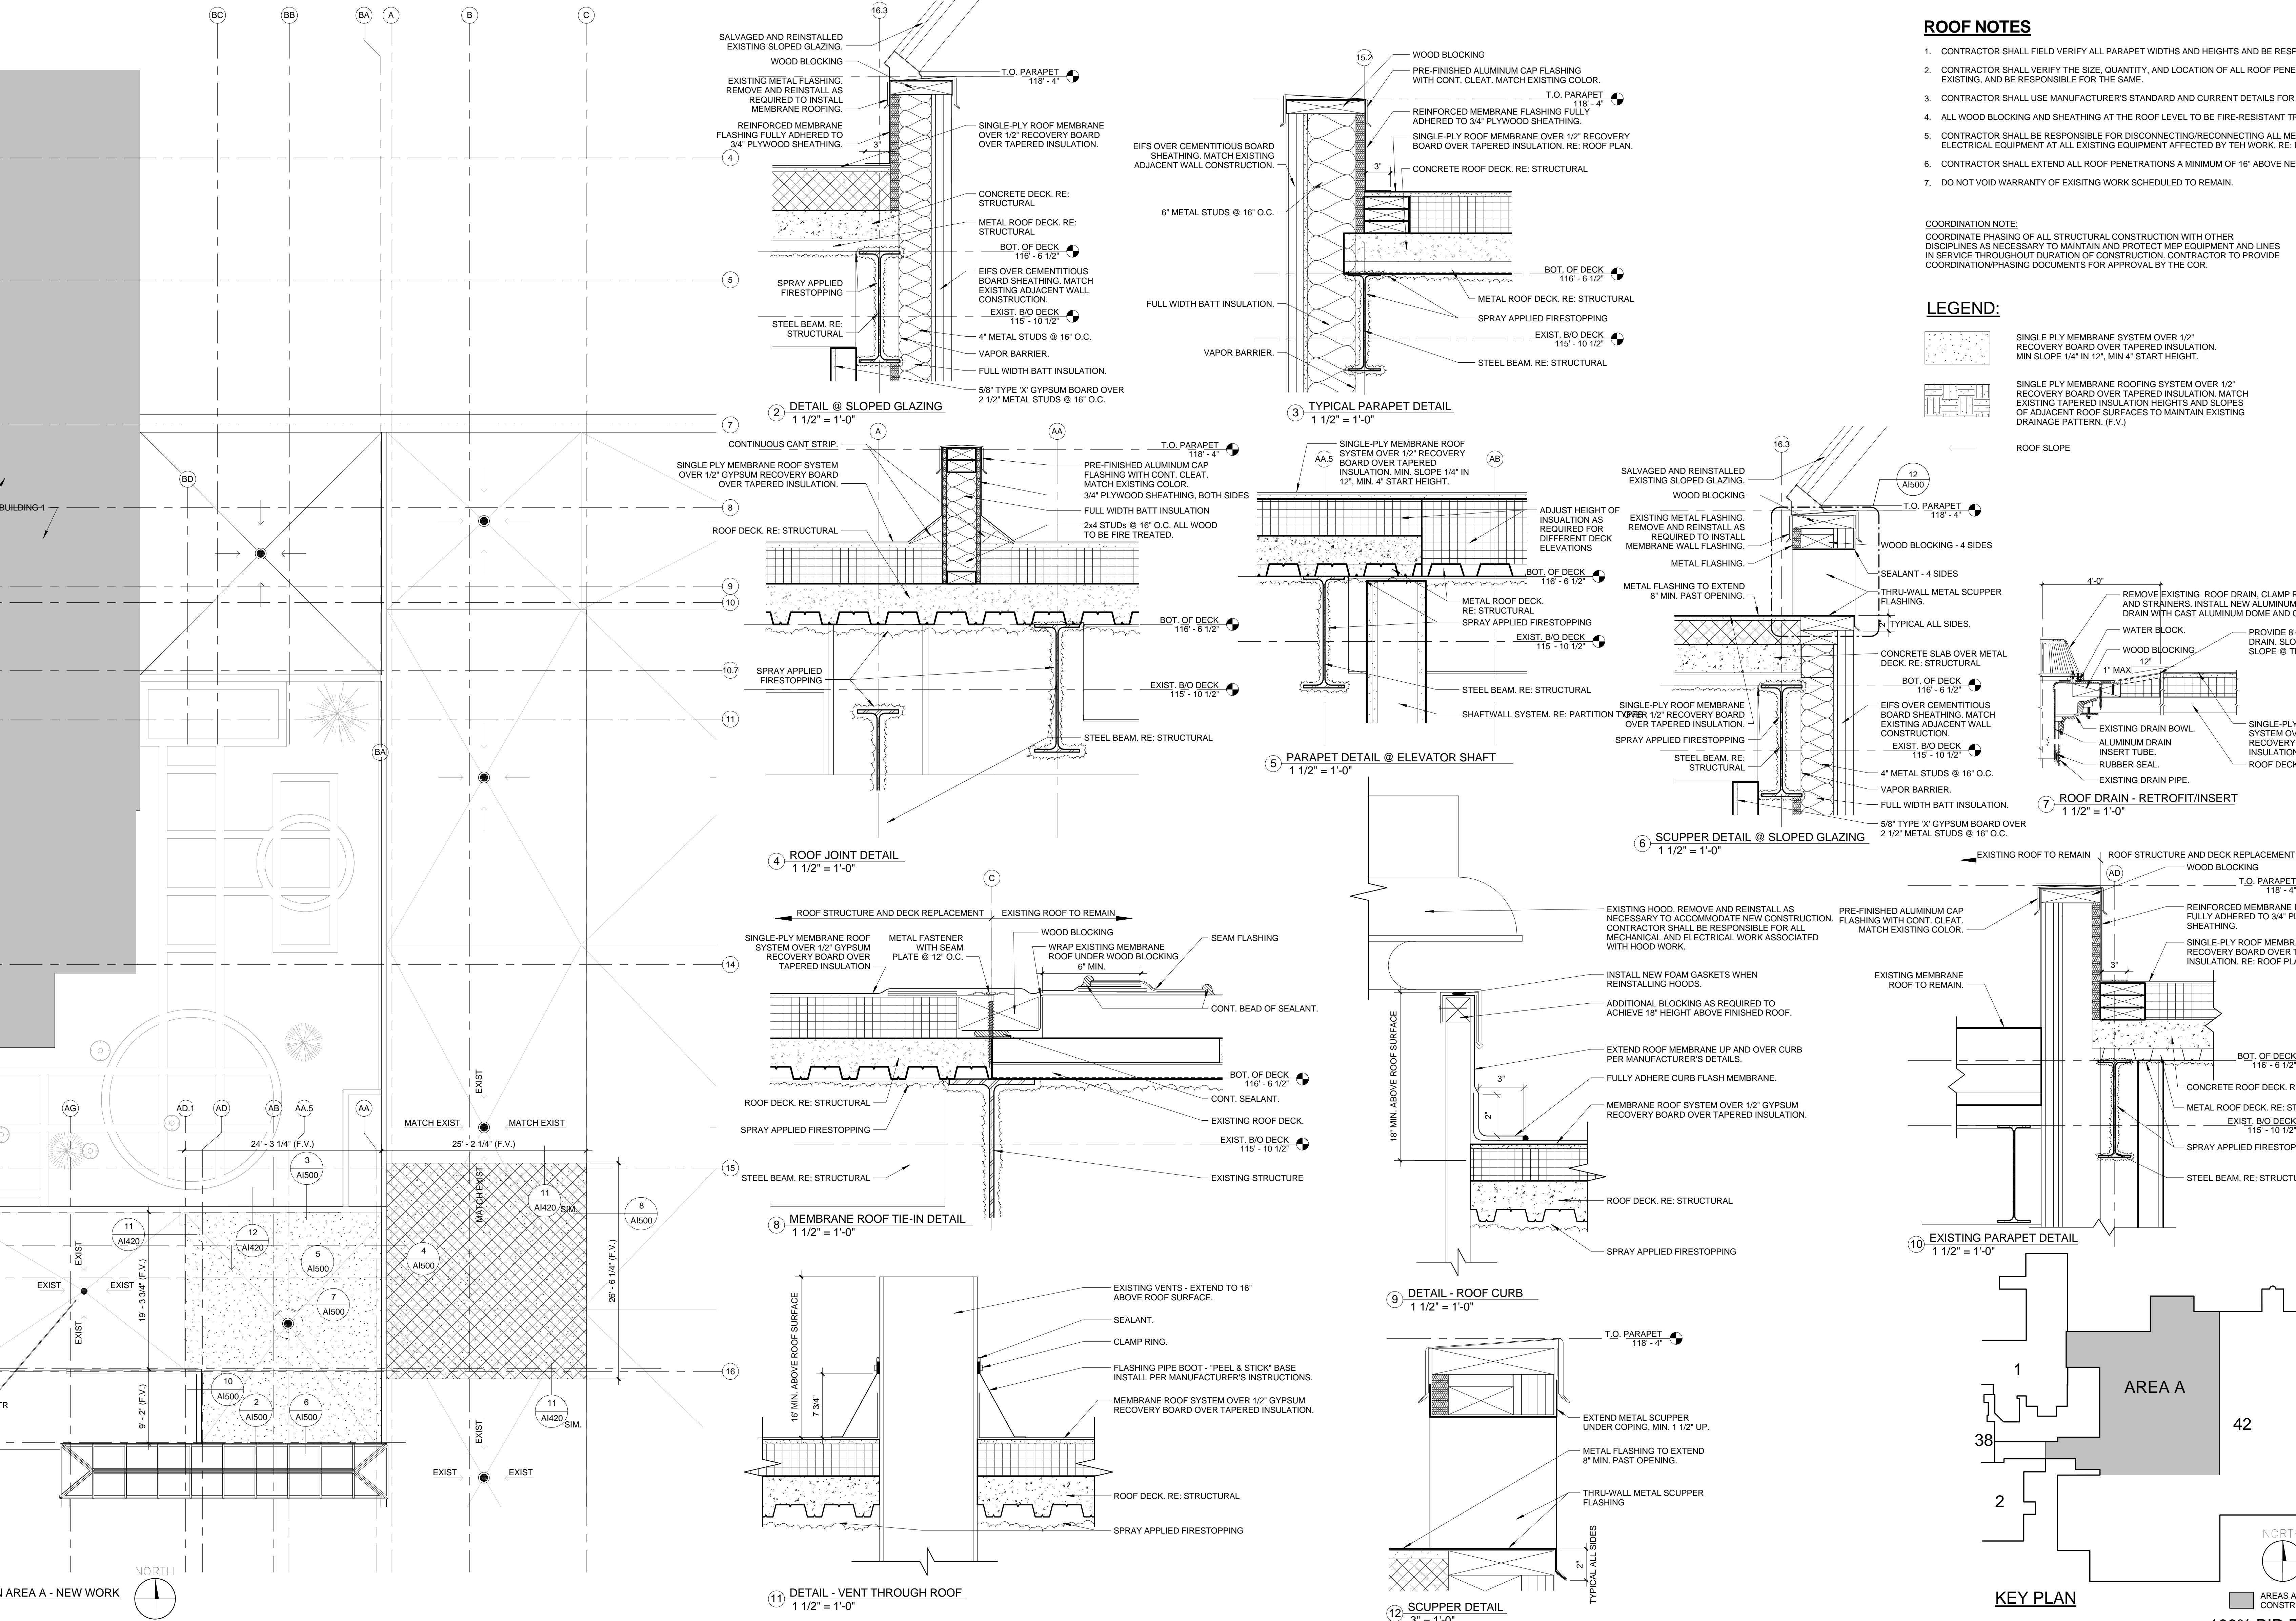1. CONTRACTOR SHALL FIELD VERIFY ALL PARAPET WIDTHS AND HEIGHTS AND BE RESPONSIBLE FOR THE SAME.
2. CONTRACTOR SHALL VERIFY THE SIZE, QUANTITY, AND LOCATION OF ALL ROOF PENETRATIONS, NEW AND EXISTING, AND BE RESPONSIBLE FOR THE SAME.
3. CONTRACTOR SHALL USE MANUFACTURER'S STANDARD AND CURRENT DETAILS FOR ALL ROOFING DETAILS.
4. ALL WOOD BLOCKING AND SHEATHING AT THE ROOF LEVEL TO BE FIRE-RESISTANT TREATED.
5. CONTRACTOR SHALL BE RESPONSIBLE FOR DISCONNECTING/RECONNECTING ALL MECHANICAL AND ELECTRICAL EQUIPMENT AT ALL EXISTING EQUIPMENT AFFECTED BY THE WORK. RE: MECHANICAL SHEETS.
6. CONTRACTOR SHALL EXTEND ALL ROOF PENETRATIONS A MINIMUM OF 16" ABOVE NEW ROOF SURFACE.
7. DO NOT VOID WARRANTY OF EXISTING WORK SCHEDULED TO REMAIN.

COORDINATION NOTE:

COORDINATE PHASING OF ALL STRUCTURAL CONSTRUCTION WITH OTHER DISCIPLINES AS NECESSARY TO MAINTAIN AND PROTECT MEP EQUIPMENT AND LINES IN SERVICE THROUGHOUT DURATION OF CONSTRUCTION. CONTRACTOR TO PROVIDE COORDINATION/PHASING DOCUMENTS FOR APPROVAL BY THE COR.

LEGEND:

SINGLE PLY MEMBRANE SYSTEM OVER 1/2" RECOVERY BOARD OVER TAPERED INSULATION. MIN SLOPE 1/4" IN 12", MIN 4" START HEIGHT.

SINGLE PLY MEMBRANE ROOFING SYSTEM OVER 1/2" RECOVERY BOARD OVER TAPERED INSULATION. MATCH EXISTING TAPERED INSULATION HEIGHTS AND SLOPES OF ADJACENT ROOF SURFACES TO MAINTAIN EXISTING DRAINAGE PATTERN. (F.V.)

ROOF SLOPE

REMOVE EXISTING ROOF DRAIN, CLAMP RINGS AND STRAINERS. INSTALL NEW ALUMINUM RETRO-FIT DRAIN WITH CAST ALUMINUM DOME AND CLAMP RINGS.

WATER BLOCK.

WOOD BLOCKING.

PROVIDE 8'-0" x 8'-0" SUMP @ ROOF DRAIN. SLOPE TO 2x THE FIELD SLOPE @ THE SUMP.

SINGLE PLY MEMBRANE ROOF SYSTEM OVER 1/2" GYPSUM RECOVERY BOARD OVER TAPERED INSULATION.

ROOF DECK, RE: STRUCTURAL.

EXISTING DRAIN BOWL.

ALUMINUM DRAIN INSERT TUBE.

RUBBER SEAL.

EXISTING DRAIN PIPE.

7 ROOF DRAIN - RETROFIT/INSERT

1 1/2" = 1'-0"

EXISTING ROOF TO REMAIN

ROOF STRUCTURE AND DECK REPLACEMENT

WOOD BLOCKING

T.O. PARAPET 118'-4"

REINFORCED MEMBRANE FLASHING FULLY ADHERED TO 3/4" PLYWOOD SHEATHING.

SINGLE PLY ROOF MEMBRANE OVER 1/2" RECOVERY BOARD OVER TAPERED INSULATION. RE: ROOF PLAN.

BOT. OF DECK 116'-6 1/2"

EXIST. B/O DECK 115'-10 1/2"

SPRAY APPLIED FIRESTOPPING

STEEL BEAM, RE: STRUCTURAL

EXISTING PARAPET DETAIL

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ROOM FINISH SCHEDULE																
ROOM NUMBER	ROOM NAME	FLOOR	BASE	WALL MATERIAL				WALL FINISH				CEILING				REMARKS
				N	E	S	W	N	E	S	W	MATERIAL	HEIGHT	FINISH	SIGNAGE	
012	ELEVATOR LOBBY	EXIST/VCT	EXIST/RBR	EXIST	EXIST	EXIST	EXIST/GYP	EXIST	EXIST	EXIST	EXIST	PAINT	EXIST	-	-	-
014	ELEVATOR MACHINE ROOM	EXIST	EXIST/RBR	GYP	GYP	EXIST	EXIST	PAINT	PAINT	EXIST	EXIST	-	-	-	-	-
42-2	STAIR	EXIST	EXIST/RBR	EXIST	EXIST	EXIST	EXIST	GYP	EXIST	EXIST	EXIST	EXIST	-	-	-	-
42-3	STAIR	EXIST	EXIST	EXIST	EXIST	EXIST	EXIST	EXIST	EXIST	EXIST	EXIST	EXIST	EXIST	-	-	-
100	CORRIDOR	EXIST/VCT	EXIST/RBR	EXIST	EXIST/GYP	EXIST	EXIST	EXIST	PAINT	EXIST	EXIST	EXIST	EXIST/SAT	9'-6"	-	-
BC103	RADIO PHARMACY	EXIST/VCT	EXIST/RBR	EXIST	GYP	EXIST/GYP	EXIST	EXIST	EXIST	EXIST	PAINT	EXIST	EXIST/SAT	9'-0 1/2"	-	-
BC107	BREAK ROOM	EXIST/VCT	EXIST/RBR	EXIST	GYP	EXIST	EXIST	EXIST	PAINT	EXIST	EXIST	EXIST	EXIST/SAT	8'-11"	-	-
BC108	CONFERENCE & VIEWING ROOM	EXIST/VCT	EXIST/RBR	EXIST	GYP	EXIST/GYP	EXIST	EXIST	PAINT	PAINT	PAINT	EXIST	EXIST/SAT	9'-0"	-	-
BC109	OFFICE	EXIST/CPT	EXIST/RBR	EXIST/GYP	EXIST/GYP	EXIST	EXIST	PAINT	PAINT	EXIST	EXIST	EXIST	EXIST	8'-11 3/4"	-	-
BC115	MECH.	EXIST	EXIST/RBR	EXIST	EXIST	EXIST/GYP	EXIST	EXIST	EXIST	EXIST	PAINT	EXIST	EXIST	-	-	-
BC129	RADIOLOGIST	EXIST/VCT	EXIST/RBR	GYP	EXIST/GYP	EXIST	EXIST/GYP	PAINT	PAINT	EXIST	PAINT	EXIST/SAT	8'-10 1/2"	-	-	EXISTING RUBBER BASE IS 6" TALL.
BC130	CHIEF	EXIST/VCT	EXIST/RBR	EXIST/GYP	EXIST	EXIST	EXIST/GYP	PAINT	EXIST	PAINT	PAINT	EXIST	EXIST/SAT	8'-10 1/2"	-	-
BD107A	MALE TOILET	EXIST/CT	EXIST/CT	EXIST/GYP/CT	EXIST	EXIST/GYP/CT	EXIST	EXIST/GYP/CT	PAINT/CT	EXIST	PAINT/CT	PAINT/CT	EXIST/SAT	7'-11 3/4"	-	-
BD107C	VENDING	EXIST/VCT	EXIST/RBR	EXIST/GYP	EXIST	EXIST/GYP	GYP	PAINT	EXIST	PAINT	PAINT	EXIST/SAT/GYP	9'-0"	-	-	-
BD109	PHARMACY	EXIST/HWSF	EXIST/RBR	EXIST	EXIST	EXIST	EXIST	EXIST	EXIST	EXIST	EXIST	EXIST	EXIST/SAT	9'-6 1/2"	-	-
CB13L	ELEVATOR	-	-	EXIST	CMU/SHAFTWALL	CMU/SHAFTWALL	EXIST/SHAFTWALL	-	-	-	-	-	-	-	-	-
CB32	CORRIDOR	EXIST	EXIST/RBR	EXIST	EXIST	EXIST/GYP	EXIST	EXIST	EXIST	EXIST	PAINT	EXIST	EXIST	8'-0"	-	-
CB33	LINK CORRIDOR	EXIST	EXIST/RBR	EXIST/GYP	EXIST	EXIST	EXIST	EXIST	EXIST	PAINT	EXIST	EXIST	EXIST	-	-	-
CB40	WAITING	EXIST	EXIST/RBR	EXIST/GYP	EXIST	EXIST	EXIST	EXIST	EXIST	EXIST	EXIST	EXIST	EXIST/SAT	8'-0"	-	-
CB42	CLERK	EXIST	EXIST/RBR	EXIST/GYP	EXIST	EXIST	EXIST/GYP	PAINT	EXIST	EXIST	EXIST	EXIST	EXIST/SAT	7'-11 3/4"	-	-
CB43	CORRIDOR	EXIST	EXIST/RBR	EXIST/GYP	EXIST/GYP	EXIST	EXIST	EXIST	PAINT	PAINT	EXIST	EXIST	EXIST	7'-10 3/4"	-	-
CB43A	LOGISTICS	EXIST	EXIST/RBR	GYP	EXIST/GYP	EXIST	EXIST/GYP	PAINT	PAINT	PAINT	PAINT	EXIST	EXIST/SAT	7'-11"	-	-
CB45	CORRIDOR	EXIST/VCT	EXIST	EXIST	EXIST/GYP	EXIST	EXIST/GYP	EXIST	PAINT	PAINT	EXIST	PAINT	EXIST	7'-11 3/4"	-	-
CB48	CORRIDOR	EXIST/VCT	EXIST/RBR	EXIST/GYP	EXIST	EXIST	EXIST	EXIST	PAINT	EXIST	EXIST	EXIST	EXIST/SAT/GYP	8'-0"	-	-
CB49	WAITING	EXIST/CPT	EXIST/RBR	EXIST	EXIST	EXIST/GYP	EXIST	EXIST	EXIST	PAINT	PAINT	PAINT	EXIST/SAT/GYP	10'-7 1/4"	-	REINSTALL SALVAGED PATTERNED ACT IN NEW GRID.
CB51	CORRIDOR	EXIST/VCT	EXIST/RBR	EXIST	EXIST/GYP	EXIST	EXIST	EXIST	EXIST	EXIST	EXIST	EXIST	EXIST	7'-11 3/4"	-	-

SCHEDULE NOTES

1. REPLACE FINISHES ONLY TO THE EXTENT REQUIRED TO COMPLETE THE STRUCTURAL MODIFICATIONS UNLESS SPECIFICALLY NOTED OTHERWISE. CONTRACTOR SHALL NOTE/PHOTOGRAPHICALLY DOCUMENT EXISTING FINISHES OF SPACES AND PROVIDE AND INSTALL MATERIALS THAT MATCH IN QUALITY AND APPEARANCE IN ORDER TO RETURN SPACES TO PRE-DEMOLITION CONDITIONS.

2. AT LOCATIONS WHERE VINYL WALL COVERING WILL BE REMOVED, REMOVAL SHALL EXTEND FROM FLOOR TO CEILING AND CORNER TO CORNER OR CORNER TO NEAREST WALL INTERSECTION. REMAINING WALL BOARD SUBSTRATE TO BE PREPARED TO RECEIVE NEW PAINT FINISHES.

3. AT LOCATIONS WHERE PAINT IS REQUIRED, NEW PAINT SHALL EXTEND FROM FLOOR TO CEILING AND CORNER TO CORNER OR CORNER TO NEAREST WALL INTERSECTION.

FINISH MATERIAL NOTES

1. KNOWN INTERIOR FINISHES ARE LISTED BELOW. WHEN FINISHES ARE NOT KNOWN, CONTRACTOR SHALL SUBMIT MATERIAL SAMPLES BASED UPON THE BEST AVAILABLE MATCH FOR COLOR AND PATTERN SELECTION DURING CONSTRUCTION.

2. EXTERIOR FINISHES SHALL MATCH EXISTING MATERIALS. COLORS, PATTERNS, TEXTURES, REVEALS, ETC. CONTRACTOR SHALL SUBMIT SAMPLES FOR APPROVAL / VERIFICATION.

3. METAL DOORS AND FRAMES SHALL BE PAINTED TO MATCH ADJACENT WALL COLORS, UNLESS DIRECTED OTHERWISE.

4. COORDINATE THE LOCATION OF PAINT COLORS WITH THE VA'S INTERIOR DESIGNER.

KNOWN EXISTING FINISHES

PHARMACY BD109 (BRACE B):

HEAT WELDED VINYL FLOORING
MANUFACTURER: ARMSTRONG
COLOR: TWEED, SLIGHT OF HAND (38050)
VINYL WELD ROD: GREY SMOKE (W0739)

WAITING CB49 (BRACE Q):

CARPET
MANUFACTURER: LEE'S SQUARED CARPET
COLOR: INDIGO

VARIOUS LOCATIONS

PAINT
MANUFACTURER: SHERWIN WILLIAMS
COLORS: SW 6088 - PACER WHITE
SW 6100 - PRACTICAL BEIGE
SW 6149 - RELAXED KHAKI

10'-0"

4'-0"

4'-0"

2'-0"

3'-7"

7'-1 3/4"

3'-7"

2 HEAD DETAIL
1" = 1'-0"

3 HORIZONTAL MULLION DETAIL
1" = 1'-0"

4 SILL DETAIL
1" = 1'-0"

5 JAMB DETAIL
1" = 1'-0"

6 VERTICAL MULLION DETAIL
1" = 1'-0"

NEW ALUMINUM STOREFRONT SYSTEM

WINDOW TYPES
3/8" = 1'-0"

EIFS
6" METAL STUD
BOX-HEADER
5/8" TYPE 'X' GYPSUM BOARD
ALUMINUM STOREFRONT SYSTEM
SEALANT

EIFS
ALUMINUM STOREFRONT SYSTEM
6" METAL STUD WALL
SEALANT
5/8" TYPE 'X' GYPSUM BOARD

ALUMINUM STOREFRONT SYSTEM

ALUMINUM STOREFRONT SYSTEM

PARTITION TYPE SCHEDULE

EXIST. ROOF DECK

FIRE RATED SEALANT, TYP. EACH SIDE

3 5/8" MTL. STUDS @ 16" O.C.

5/8" TYPE 'X' M.R. GYP. BD., TYP. EACH SIDE - TAPE AND PAINT SIDE(S) EXPOSED TO PUBLIC / V.A. STAFF

FIRE RATED SEALANT, TYP. EACH SIDE

FINISH FLOOR

FIRE CAULK AND SEAL ALL PENETRATIONS.
PROVIDE TEMPORARY PARTITIONS WHERE INDICATED AND AS REQUIRED BY V.A. INFECTION CONTROL POLICY.

TEMP. CONSTRUCTION PARTITION - 1 HR

1 1/2" = 1'-0"

A

EXIST. ROOF DECK

FIRE RATED SEALANT, TYP. EACH SIDE

3 5/8" MTL. STUDS @ 16" O.C.

16 ga. 1 1/2" DIAMOND CARBON STEEL MESH BEHIND GYPSUM BOARD

5/8" TYPE 'X' M.R. GYP. BD., TYP. EACH SIDE - TAPE AND PAINT SIDE(S) EXPOSED TO PUBLIC / V.A. STAFF

FIRE RATED SEALANT, TYP. EACH SIDE

FINISH FLOOR

FIRE CAULK AND SEAL ALL PENETRATIONS.
PROVIDE TEMPORARY PARTITIONS WHERE INDICATED AND AS REQUIRED BY V.A. INFECTION CONTROL POLICY.

TEMP. CONSTRUCTION PARTITION w/ EXPANDED STEEL MESH - 1 HR

1 1/2" = 1'-0"

B

EXIST. ROOF DECK

FIRE RATED SEALANT, TYP. EACH SIDE

2 1/2" MTL. STUDS @ 16" O.C.

5/8" TYPE 'X' M.R. GYP. BD., TYP. EACH SIDE - TAPE AND PAINT SIDE(S) EXPOSED TO PUBLIC / V.A. STAFF

FIRE RATED SEALANT, TYP. EACH SIDE

FINISH FLOOR

FIRE CAULK AND SEAL ALL PENETRATIONS.

INT. GYP. BD. ON MTL. STUD FURRING

1 1/2" = 1'-0"

C

1'-8" +/-

1" SOLID SURFACE CAP

TOP OF WALL, ELEV. 3'-6" A.F.F.

CAULK, TYP. EACH SIDE

5/8" TYPE 'X' M.R. GYP. BD., TYP. EACH SIDE

1/2" O.S.B. SHEATHING

2 1/2" MTL. STUDS @ 16" O.C.

CONT. 1/2" ALUMINUM REVEALS @ 24" O.C. HORIZ. - MATCH EXG. ADJACENT REVEALS

WALL BASE - RE: ROOM FINISH SCHEDULE

TREATED 2x BLOCKING IN FLOOR CHANNEL - ANCHOR TO SLAB @ 16" O.C.

SEALANT, TYP. EACH SIDE

FINISH FLOOR

REFER TO INTERIOR ELEVATIONS FOR MORE DETAIL.

INTERIOR - BRACE Q

1 1/2" = 1'-0"

D

EXIST. ROOF DECK

SEALANT, TYP. EACH SIDE

5/8" TYPE 'X' GYP. BD. - BOTH SIDES

3 5/8" MTL. STUDS @ 16" O.C.

WALL BASE - RE: ROOM FINISH SCHEDULE

SEALANT, TYP. EACH SIDE

FINISH FLOOR

FIRE CAULK AND SEAL ALL PENETRATIONS.

INTERIOR STUD WALL

1 1/2" = 1'-0"

E

EXIST. ROOF DECK

SEALANT, TYP. EACH SIDE

5/8" TYPE 'X' M.R. GYP. BD.

CERAMIC TILE WAINSCOT ELEV. +/- 3'-6" A.F.F.

CERAMIC TILE WAINSCOT ON 5/8" CEMENTITIOUS BACKER BOARD

18 ga. 3 5/8" MTL. STUDS @ 16" O.C.

WALL BASE - RE: ROOM FINISH SCHEDULE

SEALANT, TYP. EACH SIDE

FINISH FLOOR

FIRE CAULK AND SEAL ALL PENETRATIONS.

INTERIOR - RESTROOM

1 1/2" = 1'-0"

F

EXIST. ROOF DECK

SEALANT, TYP. EACH SIDE

5/8" TYPE 'X' M.R. GYP. BD.

CERAMIC TILE WAINSCOT ELEV. +/- 3'-6" A.F.F.

CERAMIC TILE WAINSCOT ON 5/8" CEMENTITIOUS BACKER BOARD

18 ga. 3 5/8" MTL. STUDS @ 16" O.C.

WALL BASE - RE: ROOM FINISH SCHEDULE

SEALANT, TYP. EACH SIDE

FINISH FLOOR

FIRE CAULK AND SEAL ALL PENETRATIONS.

INTERIOR RESTROOM

1 1/2" = 1'-0"

G

EXIST. ROOF DECK

SEALANT, TYP. EACH SIDE

5/8" TYPE 'X' GYP. BD.

3 5/8" MTL. STUDS @ 16" O.C.

WALL BASE - RE: ROOM FINISH SCHEDULE

SEALANT, TYP. EACH SIDE

FINISH FLOOR

FIRE CAULK AND SEAL ALL PENETRATIONS.

INTERIOR - BRACE N

1 1/2" = 1'-0"

H

EXIST. ROOF DECK

FIRE RATED SEALANT, TYP. EACH SIDE

CEMENT BOARD SHEATHING - SIZE TO MATCH EXG.

5/8" TYPE 'X' M.R. GYP. BD., TYP. EACH SIDE

CONT. 1/2" ALUMINUM REVEALS @ 24" O.C. HORIZ. - MATCH EXG. ADJACENT REVEALS

STRUCTURAL MTL. STUDS @ 16" O.C. - SIZE TO MATCH EXISTING

WALL BASE - RE: ROOM FINISH SCHEDULE

FIRE RATED SEALANT, TYP. EACH SIDE

FINISH FLOOR

FIELD VERIFY

EXTERIOR - BRACE Q

1 1/2" = 1'-0"

J

EXIST. ROOF DECK

FIRE RATED SEALANT, TYP. EACH SIDE

CEMENT BOARD SHEATHING - SIZE TO MATCH EXG.

5/8" TYPE 'X' M.R. GYP. BD., TYP. EACH SIDE

CONT. 1/2" ALUMINUM REVEALS @ 24" O.C. HORIZ. - MATCH EXG. ADJACENT REVEALS

STRUCTURAL MTL. STUDS @ 16" O.C. - SIZE TO MATCH EXISTING

WALL BASE - RE: ROOM FINISH SCHEDULE

FIRE RATED SEALANT, TYP. EACH SIDE

FINISH FLOOR

FIELD VERIFY

EXTERIOR - BRACE M

1 1/2" = 1'-0"

K

EXIST. ROOF DECK

FIRE RATED SEALANT, TYP. EACH SIDE

CEMENT BOARD SHEATHING - SIZE TO MATCH EXG.

5/8" TYPE 'X' M.R. GYP. BD., TYP. EACH SIDE

CONT. 1/2" ALUMINUM REVEALS @ 24" O.C. HORIZ. - MATCH EXG. ADJACENT REVEALS

STRUCTURAL MTL. STUDS @ 16" O.C. - SIZE TO MATCH EXISTING

WALL BASE - RE: ROOM FINISH SCHEDULE

FIRE RATED SEALANT, TYP. EACH SIDE

FINISH FLOOR

FIELD VERIFY

EXTERIOR - BRACE L

1 1/2" = 1'-0"

L

EXIST. ROOF DECK

FIRE RATED SEALANT, TYP. EACH SIDE

2 1/2" MTL. STUDS @ 16" O.C.

5/8" TYPE 'X' M.R. GYP. BD., TYP. EACH SIDE - TAPE AND PAINT SIDE(S) EXPOSED TO PUBLIC / V.A. STAFF

FIRE RATED SEALANT, TYP. EACH SIDE

FINISH FLOOR

FIRE CAULK AND SEAL ALL PENETRATIONS.

INT. GYP. BD. ON MTL. STUD FURRING

1 1/2" = 1'-0"

M

EXIST. ROOF DECK

FIRE RATED SEALANT, TYP. EACH SIDE

MECHANICALLY FASTEN 2"x2" 20 ga. ANGLE @ 24" O.C. MAX

18 ga. 'J' TRACK - MECHANICALLY FASTEN @ 24" O.C. MAX

1" GYPSUM SHAFTLINER

2 LAYERS 5/8" TYPE 'X' GYP. BD.

6" CT STUDS @ 16" O.C.

18 ga. 'J' TRACK - MECHANICALLY FASTEN @ 24" O.C. MAX

WALL BASE - RE: ROOM FINISH SCHEDULE

FIRE RATED SEALANT, TYP. EACH SIDE

FINISH FLOOR

FIRE CAULK AND SEAL ALL PENETRATIONS.

ELEVATOR SHAFTWALL DETAIL

1 1/2" = 1'-0"

N

EXIST. ROOF DECK

8" CMU WALL - RE: STRUCTURAL SHEETS

FINISH FLOOR

FIRE CAULK AND SEAL ALL PENETRATIONS.

PARTITION TYPE DETAIL

1 1/2" = 1'-0"

P

EXIST. ROOF DECK

SEALANT, TYP. EACH SIDE

SLOTTED SLIP TRACK

TOP OF STUDS

ATTACH WALLBOARD TO STUDS DO NOT ATTACH TO TOP TRACK

MTL. STUDS @ 16" O.C.

WALL BASE - RE: ROOM FINISH SCHEDULE

SEALANT, TYP. EACH SIDE

FINISH FLOOR

FIELD VERIFY

STAIR TOWER WALL - 2HR

1 1/2" = 1'-0"

R

EXIST. ROOF DECK

SEALANT, TYP. EACH SIDE

5 1/2" MTL. STUDS @ 16" O.C.

WALL BASE - RE: ROOM FINISH SCHEDULE

SEALANT, TYP. EACH SIDE

FINISH FLOOR

FIELD VERIFY

STAIR TOWER WALL - 2HR

1 1/2" = 1'-0"

R

EXIST. ROOF DECK

SEALANT, TYP. EACH SIDE

5 1/2" MTL. STUDS @ 16" O.C.

WALL BASE - RE: ROOM FINISH SCHEDULE

SEALANT, TYP. EACH SIDE

FINISH FLOOR

FIELD VERIFY

STAIR TOWER WALL - 2HR

1 1/2" = 1'-0"

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EXIST. ROOF DECK

SEALANT, TYP. EACH SIDE

5 1/2" MTL. STUDS @ 16" O.C.

WALL BASE - RE: ROOM FINISH SCHEDULE

SEALANT, TYP. EACH SIDE

FINISH FLOOR

FIELD VERIFY

STAIR TOWER WALL - 2HR

1 1/2" = 1'-0"

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EXIST. ROOF DECK

SEALANT, TYP. EACH SIDE

5 1/2" MTL. STUDS @ 16" O.C.

WALL BASE - RE: ROOM FINISH SCHEDULE

SEALANT, TYP. EACH SIDE

FINISH FLOOR

FIELD VERIFY

STAIR TOWER WALL - 2HR

1 1/2" = 1'-0"

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EXIST. ROOF DECK

SEALANT, TYP. EACH SIDE

5 1/2" MTL. STUDS @ 16" O.C.

WALL BASE - RE: ROOM FINISH SCHEDULE

SEALANT, TYP. EACH SIDE

FINISH FLOOR

FIELD VERIFY

STAIR TOWER WALL - 2HR

1 1/2" = 1'-0"

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SEALANT, TYP. EACH SIDE

5 1/2" MTL. STUDS @ 16" O.C.

WALL BASE - RE: ROOM FINISH SCHEDULE

SEALANT, TYP. EACH SIDE

FINISH FLOOR

FIELD VERIFY

STAIR TOWER WALL - 2HR

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SEALANT, TYP. EACH SIDE

5 1/2" MTL. STUDS @ 16" O.C.

WALL BASE - RE: ROOM FINISH SCHEDULE

SEALANT, TYP. EACH SIDE

FINISH FLOOR

FIELD VERIFY

STAIR TOWER WALL - 2HR

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FINISH FLOOR

FIELD VERIFY

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FINISH FLOOR

FIELD VERIFY

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SEALANT, TYP. EACH SIDE

FINISH FLOOR

FIELD VERIFY

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1 1/2" = 1'-0"

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FINISH FLOOR

FIELD VERIFY

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1 1/2" = 1'-0"

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EXIST. ROOF DECK

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5 1/2" MTL. STUDS @ 16" O.C.

WALL BASE - RE: ROOM FINISH SCHEDULE

SEALANT, TYP. EACH SIDE

FINISH FLOOR

FIELD VERIFY

STAIR TOWER WALL - 2HR

1 1/2" = 1'-0"

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EXIST. ROOF DECK

SEALANT, TYP. EACH SIDE

5 1/2" MTL. STUDS @ 16" O.C.

WALL BASE - RE: ROOM FINISH SCHEDULE

SEALANT, TYP. EACH SIDE

FINISH FLOOR

FIELD VERIFY

STAIR TOWER WALL - 2HR

1 1/2" = 1'-0"

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EXIST. ROOF DECK

SEALANT, TYP. EACH SIDE

5 1/2" MTL. STUDS @ 16" O.C.

WALL BASE - RE: ROOM FINISH SCHEDULE

SEALANT, TYP. EACH SIDE

FINISH FLOOR

FIELD VERIFY

STAIR TOWER WALL - 2HR

1 1/2" = 1'-0"

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EXIST. ROOF DECK

SEALANT, TYP. EACH SIDE

5 1/2" MTL. STUDS @ 16" O.C.

WALL BASE - RE: ROOM FINISH SCHEDULE

SEALANT, TYP. EACH SIDE

FINISH FLOOR

FIELD VERIFY

STAIR TOWER WALL - 2HR

1 1/2" = 1'-0"

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EXIST. ROOF DECK

SEALANT, TYP. EACH SIDE

5 1/2" MTL. STUDS @ 16" O.C.

WALL BASE - RE: ROOM FINISH SCHEDULE

SEALANT, TYP. EACH SIDE

FINISH FLOOR

FIELD VERIFY

STAIR TOWER WALL - 2HR

1 1/2" = 1'-0"

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EXIST. ROOF DECK

SEALANT, TYP. EACH SIDE

5 1/2" MTL. STUDS @ 16" O.C.

WALL BASE - RE: ROOM FINISH SCHEDULE

SEALANT, TYP. EACH SIDE

FINISH FLOOR

FIELD VERIFY

STAIR TOWER WALL - 2HR

1 1/2" = 1'-0"

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EXIST. ROOF DECK

SEALANT, TYP. EACH SIDE

5 1/2" MTL. STUDS @ 16" O.C.

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SEALANT, TYP. EACH SIDE

FINISH FLOOR

FIELD VERIFY

STAIR TOWER WALL - 2HR

1 1/2" = 1'-0"

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EXIST. ROOF DECK

SEALANT, TYP. EACH SIDE

5 1/2" MTL. STUDS @ 16" O.C.

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SEALANT, TYP. EACH SIDE

FINISH FLOOR

FIELD VERIFY

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EXIST. ROOF DECK

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5 1/2" MTL. STUDS @ 16" O.C.

WALL BASE - RE: ROOM FINISH SCHEDULE

SEALANT, TYP. EACH SIDE

FINISH FLOOR

FIELD VERIFY

STAIR TOWER WALL - 2HR

1 1/2" = 1'-0"

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EXIST. ROOF DECK

SEALANT, TYP. EACH SIDE

5 1/2" MTL. STUDS @ 16" O.C.

WALL BASE - RE: ROOM FINISH SCHEDULE

SEALANT, TYP. EACH SIDE

FINISH FLOOR

FIELD VERIFY

STAIR TOWER WALL - 2HR

1 1/2" = 1'-0"

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EXIST. ROOF DECK

SEALANT, TYP. EACH SIDE

5 1/2" MTL. STUDS @ 16" O.C.

WALL BASE - RE: ROOM FINISH SCHEDULE

SEALANT, TYP. EACH SIDE

FINISH FLOOR

FIELD VERIFY

STAIR TOWER WALL - 2HR

1 1/2" = 1'-0"

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EXIST. ROOF DECK

SEALANT, TYP. EACH SIDE

5 1/2" MTL. STUDS @ 16" O.C.

WALL BASE - RE: ROOM FINISH SCHEDULE

SEALANT, TYP. EACH SIDE

FINISH FLOOR

FIELD VERIFY

STAIR TOWER WALL - 2HR

1 1/2" = 1'-0"

R

EXIST. ROOF DECK

SEALANT, TYP. EACH SIDE

5 1/2" MTL. STUDS @ 16" O.C.

WALL BASE - RE: ROOM FINISH SCHEDULE

SEALANT, TYP. EACH SIDE

FINISH FLOOR

FIELD VERIFY

STAIR TOWER WALL - 2HR

1 1/2" = 1'-0"

R

EXIST. ROOF DECK

SEALANT, TYP. EACH SIDE

5 1/2" MTL. STUDS @ 16" O.C.

WALL BASE - RE: ROOM FINISH SCHEDULE

SEALANT, TYP. EACH SIDE

FINISH FLOOR

FIELD VERIFY

STAIR TOWER WALL - 2HR

1 1/2" = 1'-0"

R

EXIST. ROOF DECK

SEALANT, TYP. EACH SIDE

5 1/2" MTL. STUDS @ 16" O.C.

WALL BASE - RE: ROOM FINISH SCHEDULE

SEALANT, TYP. EACH SIDE

FINISH FLOOR

FIELD VERIFY

STAIR TOWER WALL - 2HR

1 1/2" = 1'-0"

R

EXIST. ROOF DECK

SEALANT, TYP. EACH SIDE

5 1/2" MTL. STUDS @ 16" O.C.

WALL BASE - RE: ROOM FINISH SCHEDULE

SEALANT, TYP. EACH SIDE

FINISH FLOOR

FIELD VERIFY

STAIR TOWER WALL - 2HR

1 1/2" = 1'-0"

R

EXIST. ROOF DECK

SEALANT, TYP. EACH SIDE

5 1/2" MTL. STUDS @ 16" O.C.

WALL BASE - RE: ROOM FINISH SCHEDULE

SEALANT, TYP. EACH SIDE

FINISH FLOOR

FIELD VERIFY

STAIR TOWER WALL - 2HR

1 1/2" = 1'-0"

R

EXIST. ROOF DECK

SEALANT, TYP. EACH SIDE

5 1/2" MTL. STUDS @ 16" O.C.

WALL BASE - RE: ROOM FINISH SCHEDULE

SEALANT, TYP. EACH SIDE

FINISH FLOOR

FIELD VERIFY

STAIR TOWER WALL - 2HR

1 1/2" = 1'-0"

R

EXIST. ROOF DECK

SEALANT, TYP. EACH SIDE

5 1/2" MTL. STUDS @ 16" O.C.

WALL BASE - RE: ROOM FINISH SCHEDULE

SEALANT, TYP. EACH SIDE

FINISH FLOOR

FIELD VERIFY

STAIR TOWER WALL - 2HR

1 1/2" = 1'-0"

R

EXIST. ROOF DECK

SEALANT, TYP. EACH SIDE

5 1/2" MTL. STUDS @ 16" O.C.

WALL BASE - RE: ROOM FINISH SCHEDULE

SEALANT, TYP. EACH SIDE

FINISH FLOOR

FIELD VERIFY

STAIR TOWER WALL - 2HR

1 1/2" = 1'-0"

R

EXIST. ROOF DECK

SEALANT, TYP. EACH SIDE

5 1/2" MTL. STUDS @ 16" O.C.

WALL BASE - RE: ROOM FINISH SCHEDULE

SEALANT, TYP. EACH SIDE

FINISH FLOOR

FIELD VERIFY

STAIR TOWER WALL - 2HR

1 1/2" = 1'-0"

R

EXIST. ROOF DECK

SEALANT, TYP. EACH SIDE

5 1/2" MTL. STUDS @ 16" O.C.

WALL BASE - RE: ROOM FINISH SCHEDULE

SEALANT, TYP. EACH SIDE

FINISH FLOOR

FIELD VERIFY


STAIR TOWER WALL - 2HR

1 1/2" = 1'-0"


R

A
B
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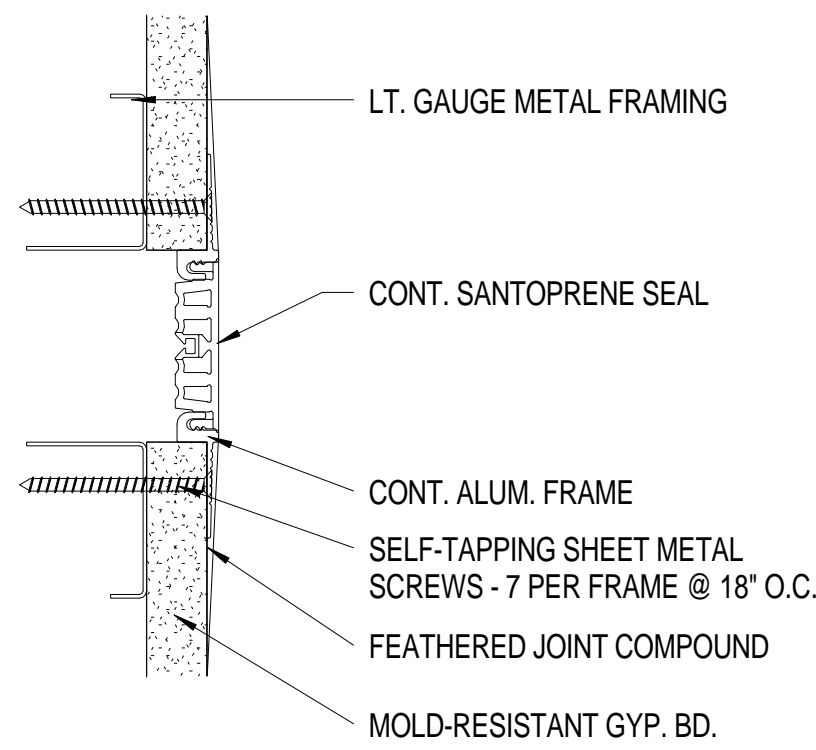
A
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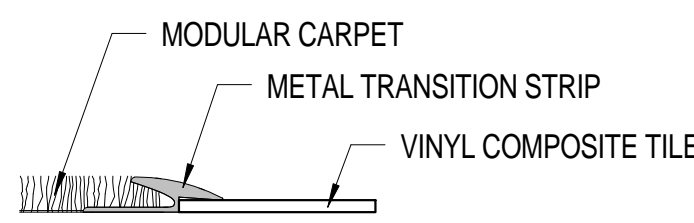
1 EXPANSION JOINT - ACT CEILING
6' = 1'-0"

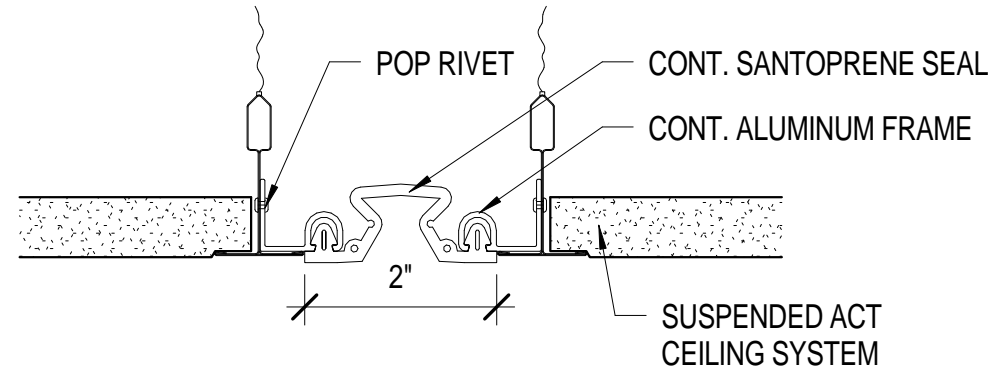


2 EXPANSION JOINT - FLOOR
6' = 1'-0"

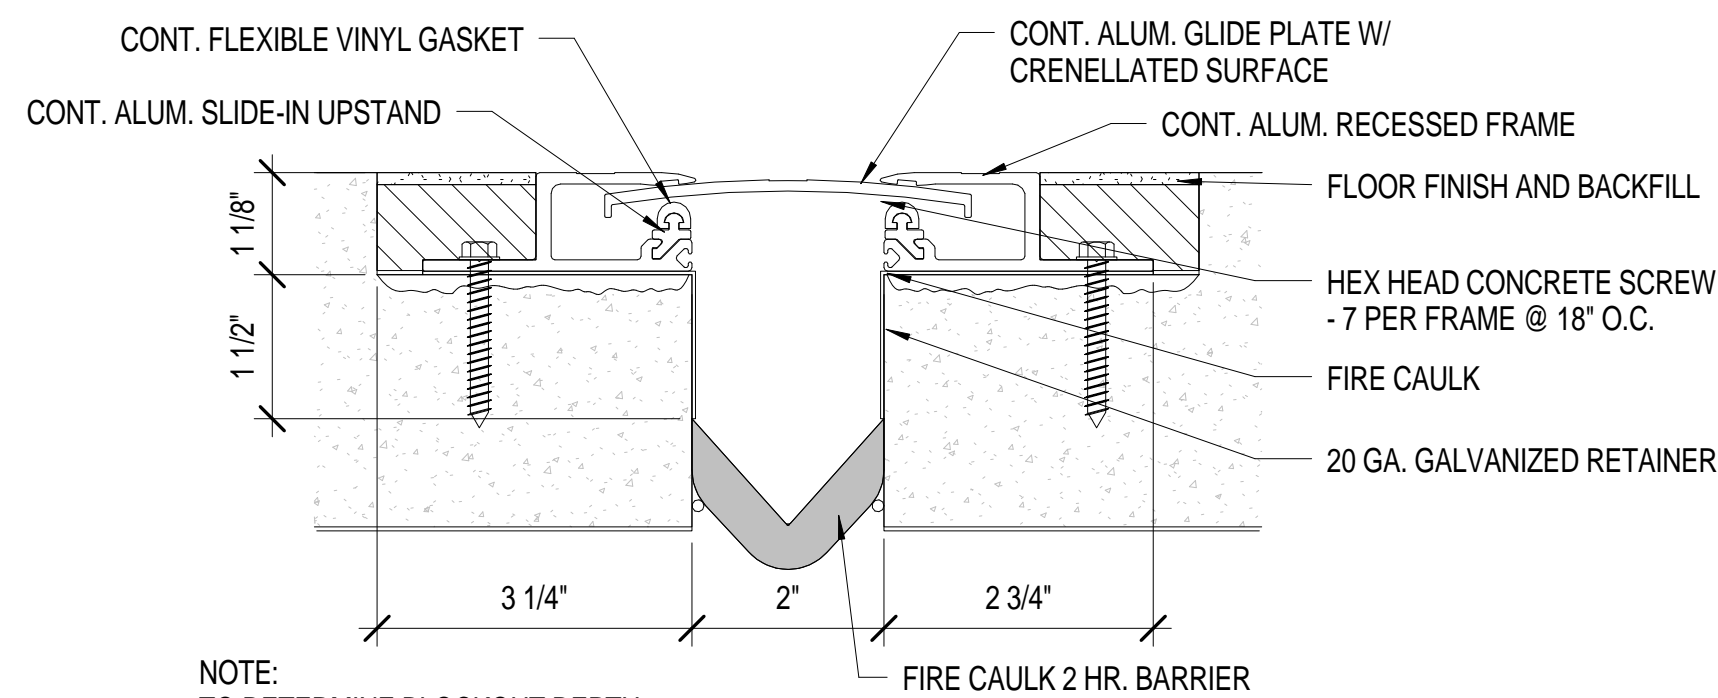


3 EXPANSION JOINT - GYP BOARD
6' = 1'-0"




4 FLOOR TRANSITION - CPT TO VCT
6' = 1'-0"

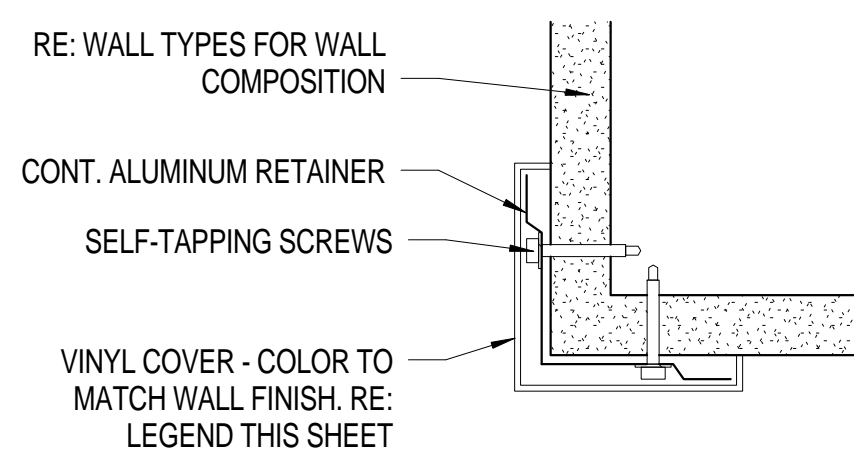



5 DETAIL - CORNER GUARD
6' = 1'-0"

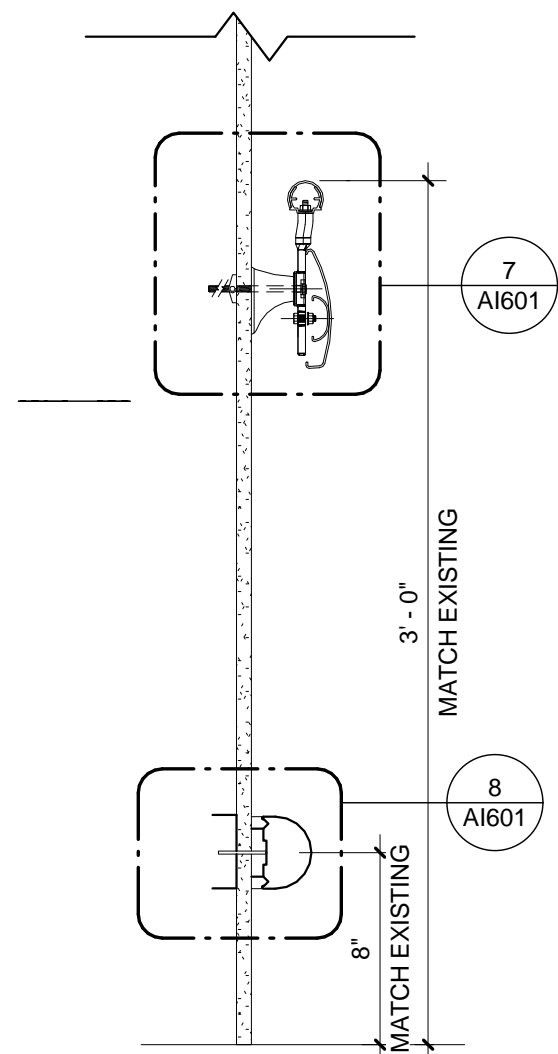


6 DETAIL - HANDRAIL/BUMPER GUARD MOUNTING HEIGHTS
1 1/2" = 1'-0"

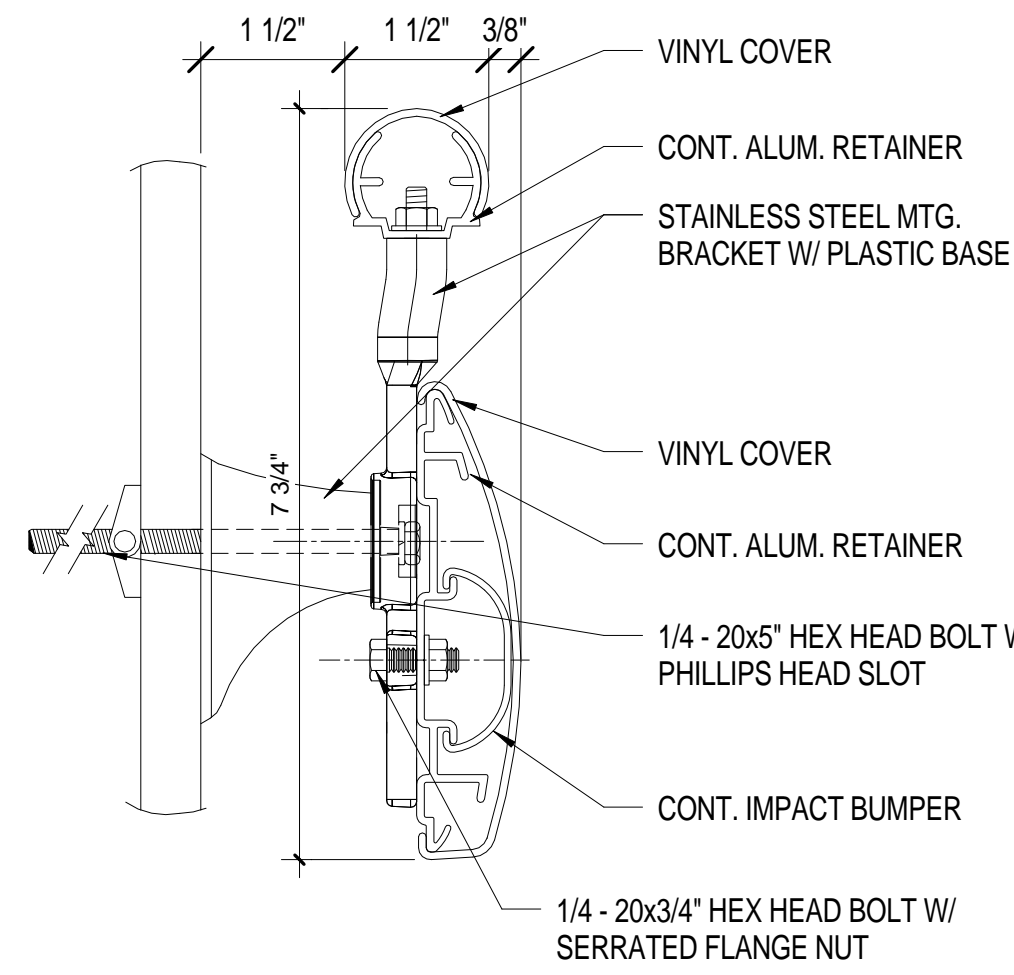


7 DETAIL - HANDRAIL
6' = 1'-0"

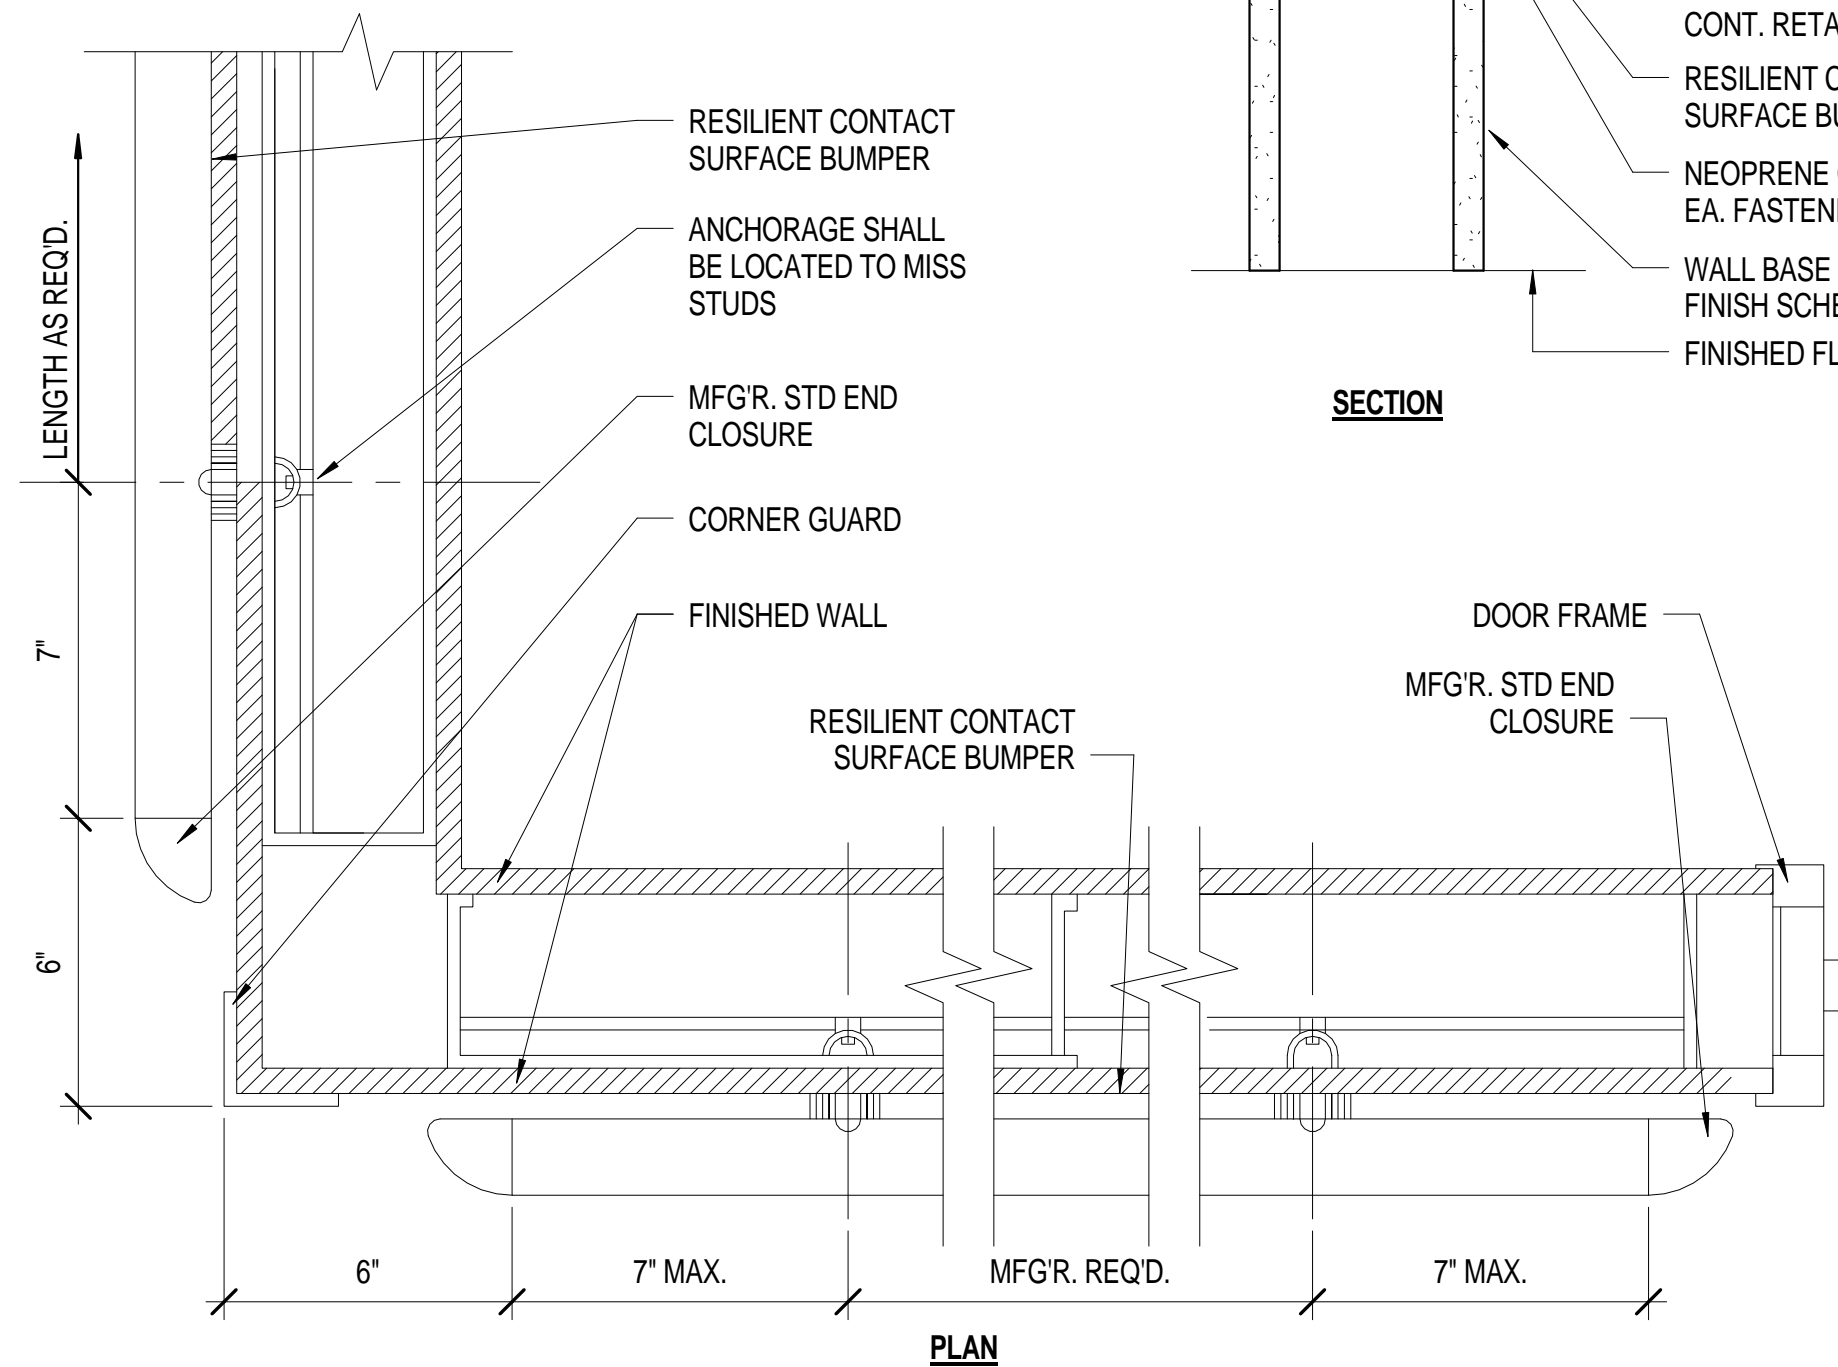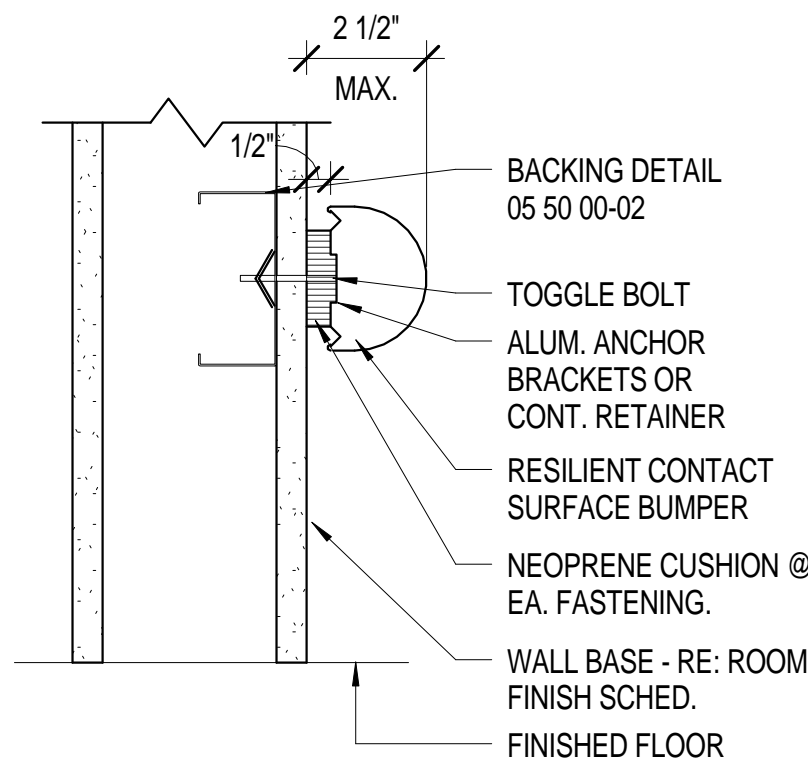


8 DETAIL - WALL GUARDS
3' = 1'-0"

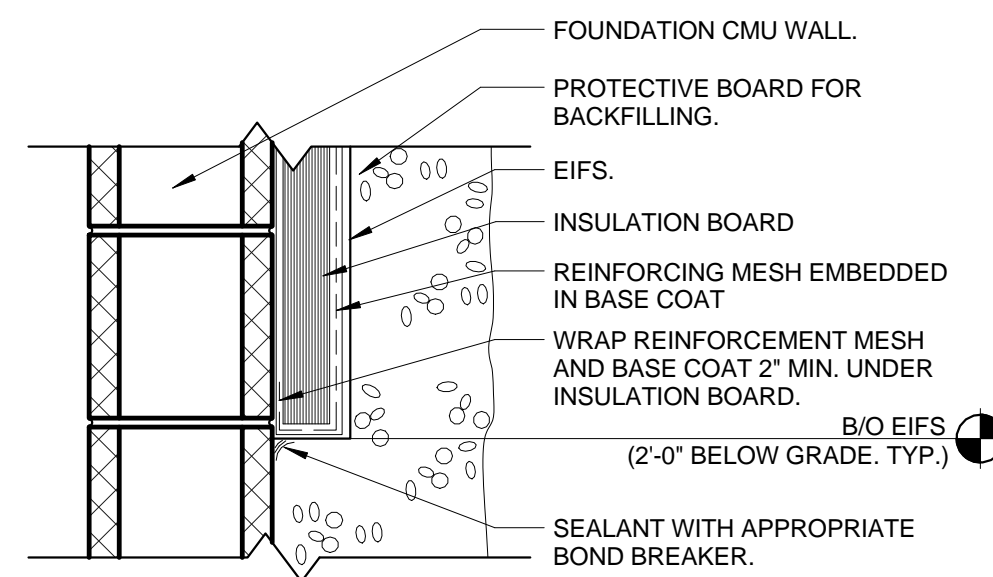


9 EIFS TERMINATION @ FOUNDATION
1 1/2" = 1'-0"

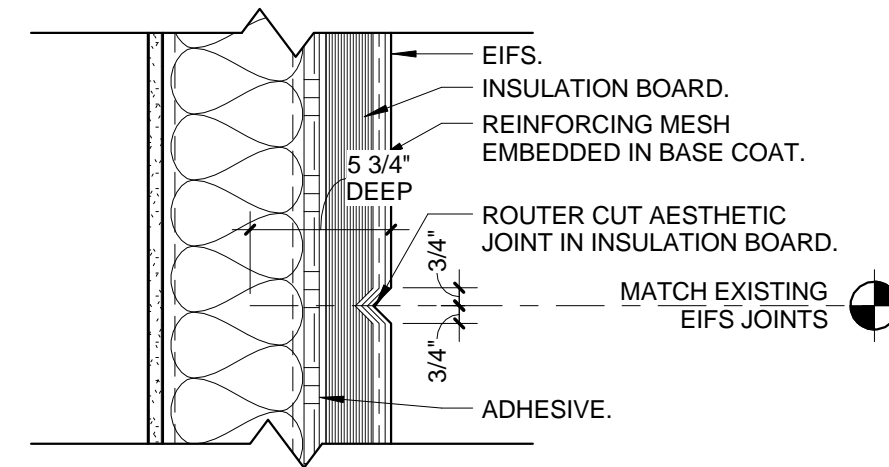

10 DETAIL AT EIFS REVEAL
1 1/2" = 1'-0"

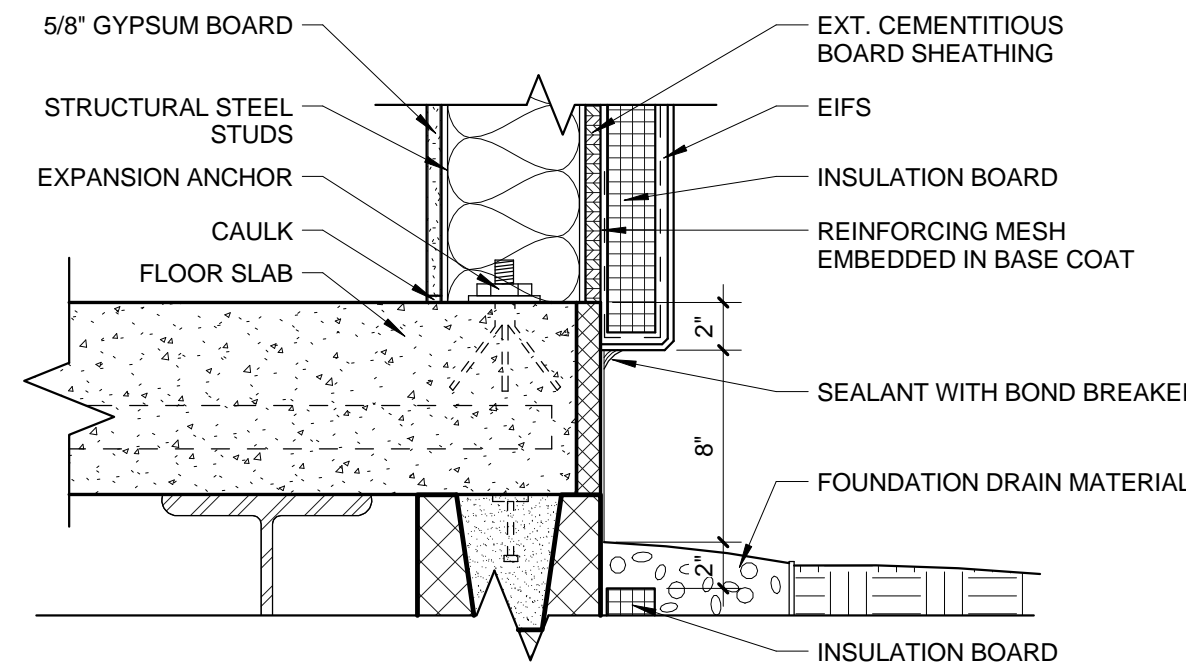

11 EIFS AT FLOOR LEVEL
1 1/2" = 1'-0"

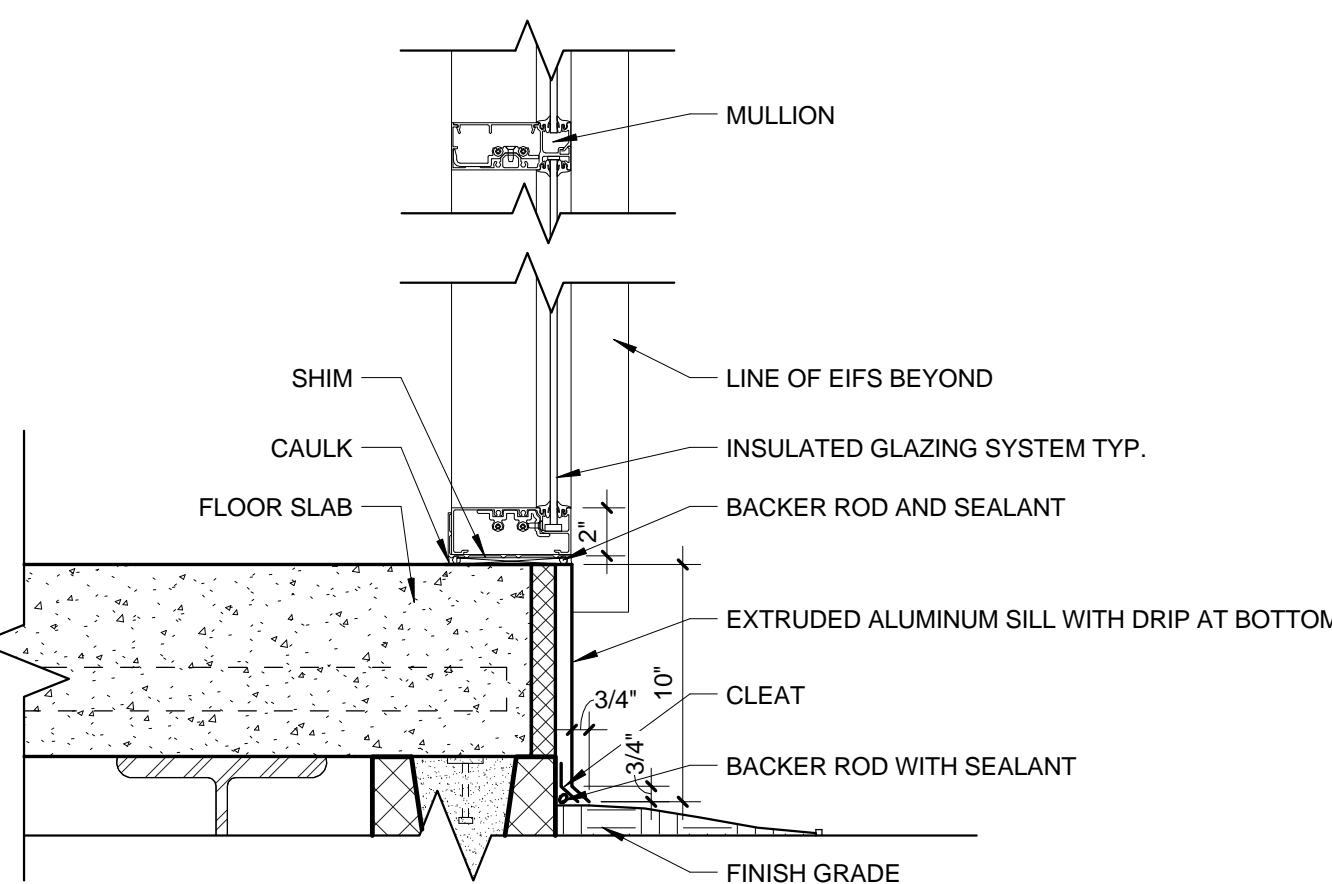

12 SILL @ WINDOW TYPE 'B'
1 1/2" = 1'-0"

100% BID DOCUMENTS

Revisions:		Date	CONSULTANTS:		PROJECT MANAGER:		Office of Construction and Facilities Management		Drawing Title: MISCELLANEOUS DETAILS		Project Title: ADD STRUCTURAL IMPROVEMENTS TO BUILDING		VA PROJECT NUMBER 657-343	
			Baysinger Design Group, Inc.		Raleigh, NC Indianapolis, IN Pittsburgh, PA Virginia Beach, VA Fort Collins, CO		U.S. Department of Veterans Affairs		MARION VAMC MARION, IL, 62959		Approved: Project Director		Building Number 42	
			AMERICAN STRUCTUREPOINT INC.		7260 Shadeland Station, Indianapolis, IN 46256 Tel: 317.543.5500 Fax: 317.543.8270 www.structurepoint.com						Date 09/06/17		Drawing Number AI601	
											Checked HKG		Dwg 54 of 81	
											Drawn MNH			