





**HAMPTON,
VIRGINIA**

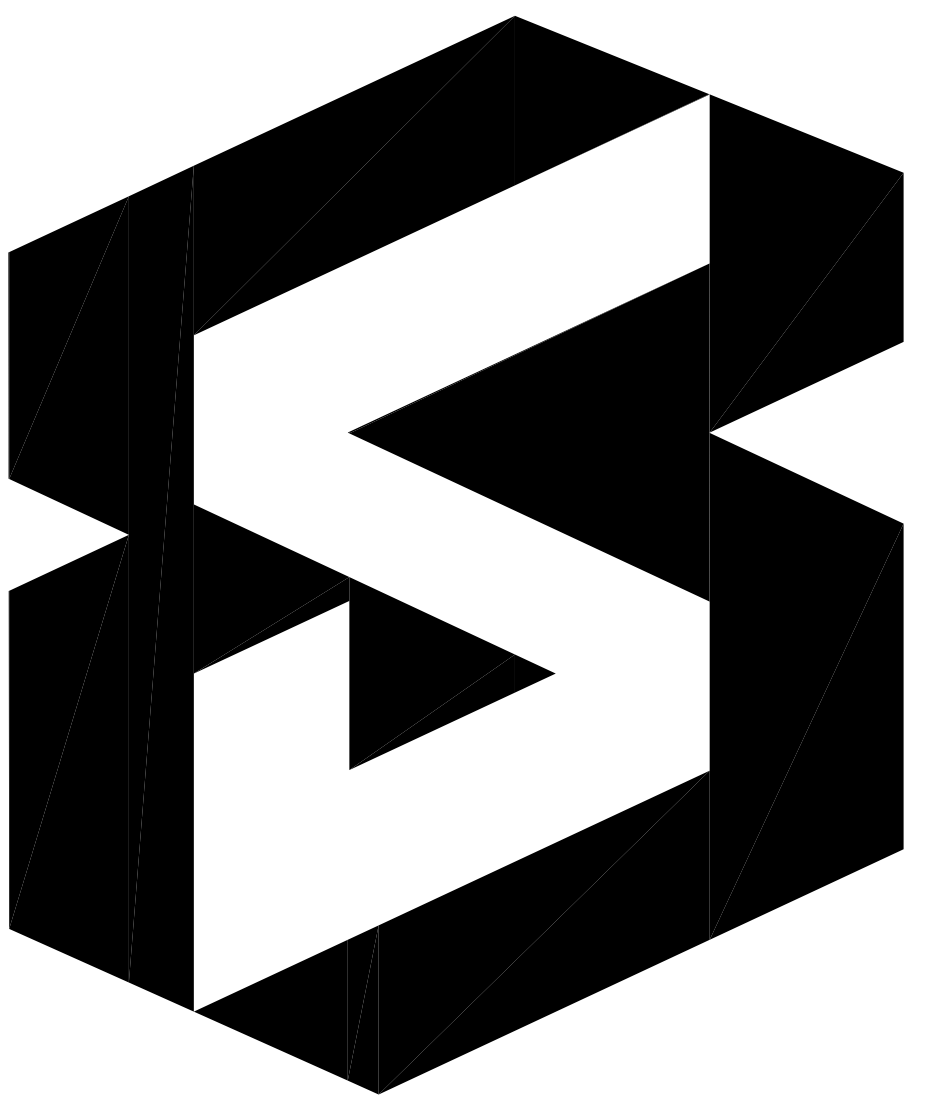

DISPATCH RENOVATION

PROJECT NO. 590-18-102
Department of Veterans Affairs
Hampton, Virginia

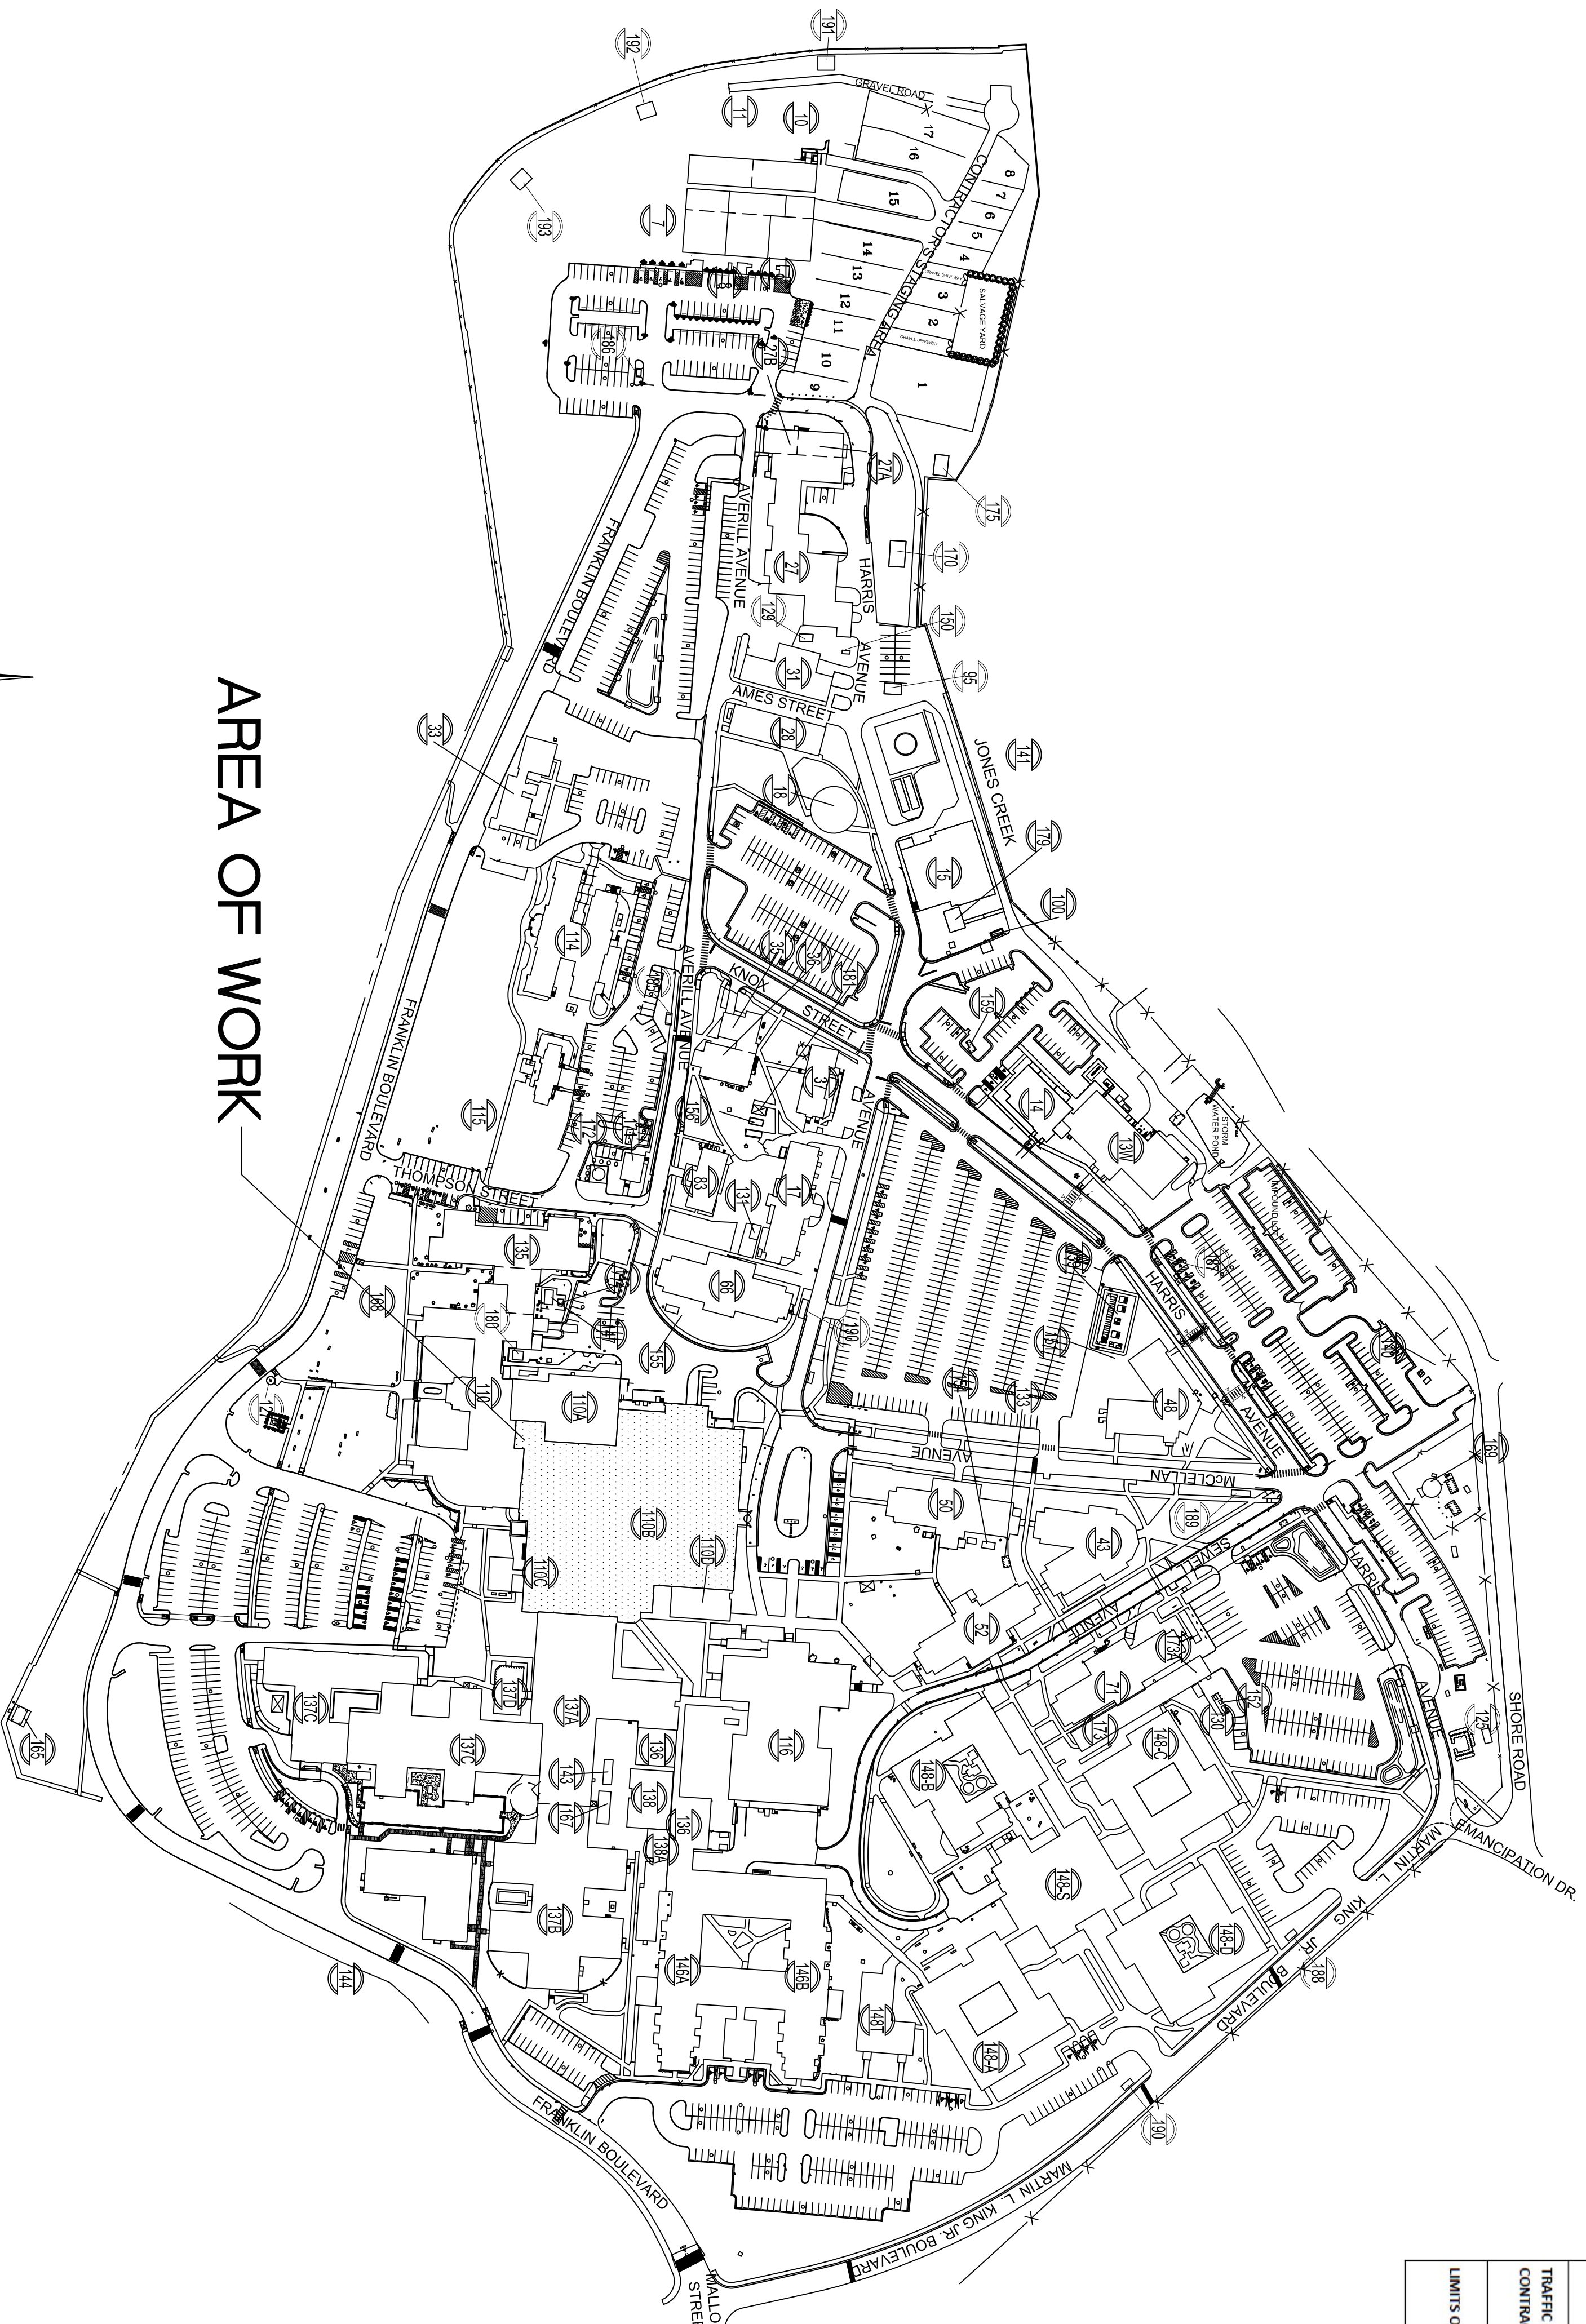



PRE CONSTRUCTION RISK ASSESSMENT/EVALUATION		PROJECT NUMBER: 590-18-102	
PROJECT NAME: DISPATCH RENOVATION - HAMPTON VA, VA		PLANNING/AGENCIES TO ADDRESS IMPACTS	
UTILITIES/ESSENTIAL SERVICES OUTAGES	Staff power outage to remove existing boxes and/or relocate non critical devices	Coordinate outage time & duration and make corrections as low as possible	
VIBRATIONS	Roof top equipment installation, drilling/ cutting for soil penetration	Coordinate with adjacent clinics and perform at off peak hours	
DUST (INJECTION CONTROL)/AIR QUALITY	Drywall installation & finishing dust, paint	negative air machine, use of sticky mats	
NOISE	Come engine from setting roof top unit, saw, drill, impact tool when shooting down stud track to floor	coordinate with adjacent occupied work areas and perform at off peak hours to minimize distraction	
EQUIPMENT	Saws, drills, crane (local), impact tool	Minimize crane for minimum time, off hours	
OBSTACLE OR SPREAD OF CONTAMINANTS	Prewall dust, lost traffic debris	Negative air machine, walk off sticky mats at construction barrier for entrance & exit	
TRAFFIC FLOW - PATIENTS, VISITORS, STAFF, CONTROL PERSONNEL	Staff will work around barriers, patients may lose some parking while crane installed on site, location of crane staging not determined	Signage for temporary closure of parking area and at construction barriers for construction personnel entry only	
LIMITS OF CONSTRUCTION, BARRETT LOCATION	Barrett shall be floor to stud, supported	coordinate stud location in field to maintain operational functionality of dispatch	

- COITR - ILSM & ICRM COMPLETED
- REVIEWED: AFGE
- REVIEWED: NAGE
- APPROVED: INJECTION CONTROL
- APPROVED: CONSTRUCTION SAFETY MANAGER
- APPROVED: SAFETY MANAGER
- APPROVED: CHIEF, POLICE SERVICE
- APPROVED: FACILITY CHIEF INFORMATION OFFICER
- APPROVED: PROJECT ENGINEER
- APPROVED: ENGINEERING DIVISION MANAGER
- APPROVED: CHIEF, FACILITIES MANAGEMENT SERVICE
- APPROVED: ASSOCIATE DIRECTOR FOR PATIENT CARE SERVICES
- APPROVED: CHIEF OF STAFF
- APPROVED: ASSOCIATE DIRECTOR FOR OPERATIONS
- APPROVED: DIRECTOR, HAMPTON VA MEDICAL CENTER

FULLY SPRINKLERED

Reference	Date	Project Title	Project Number	Building Number
		DISPATCH RENOVATION	590-18-102	1008
CONSULTANTS:		Approved Project Director	Location	Drawing Number
			VA MEDICAL CENTER, HAMPTON, VA	1008
		ARCHITECT/ENGINEERS:	Date	Checked
			2/28/2018	Drawn
				Dwg 1 of 6



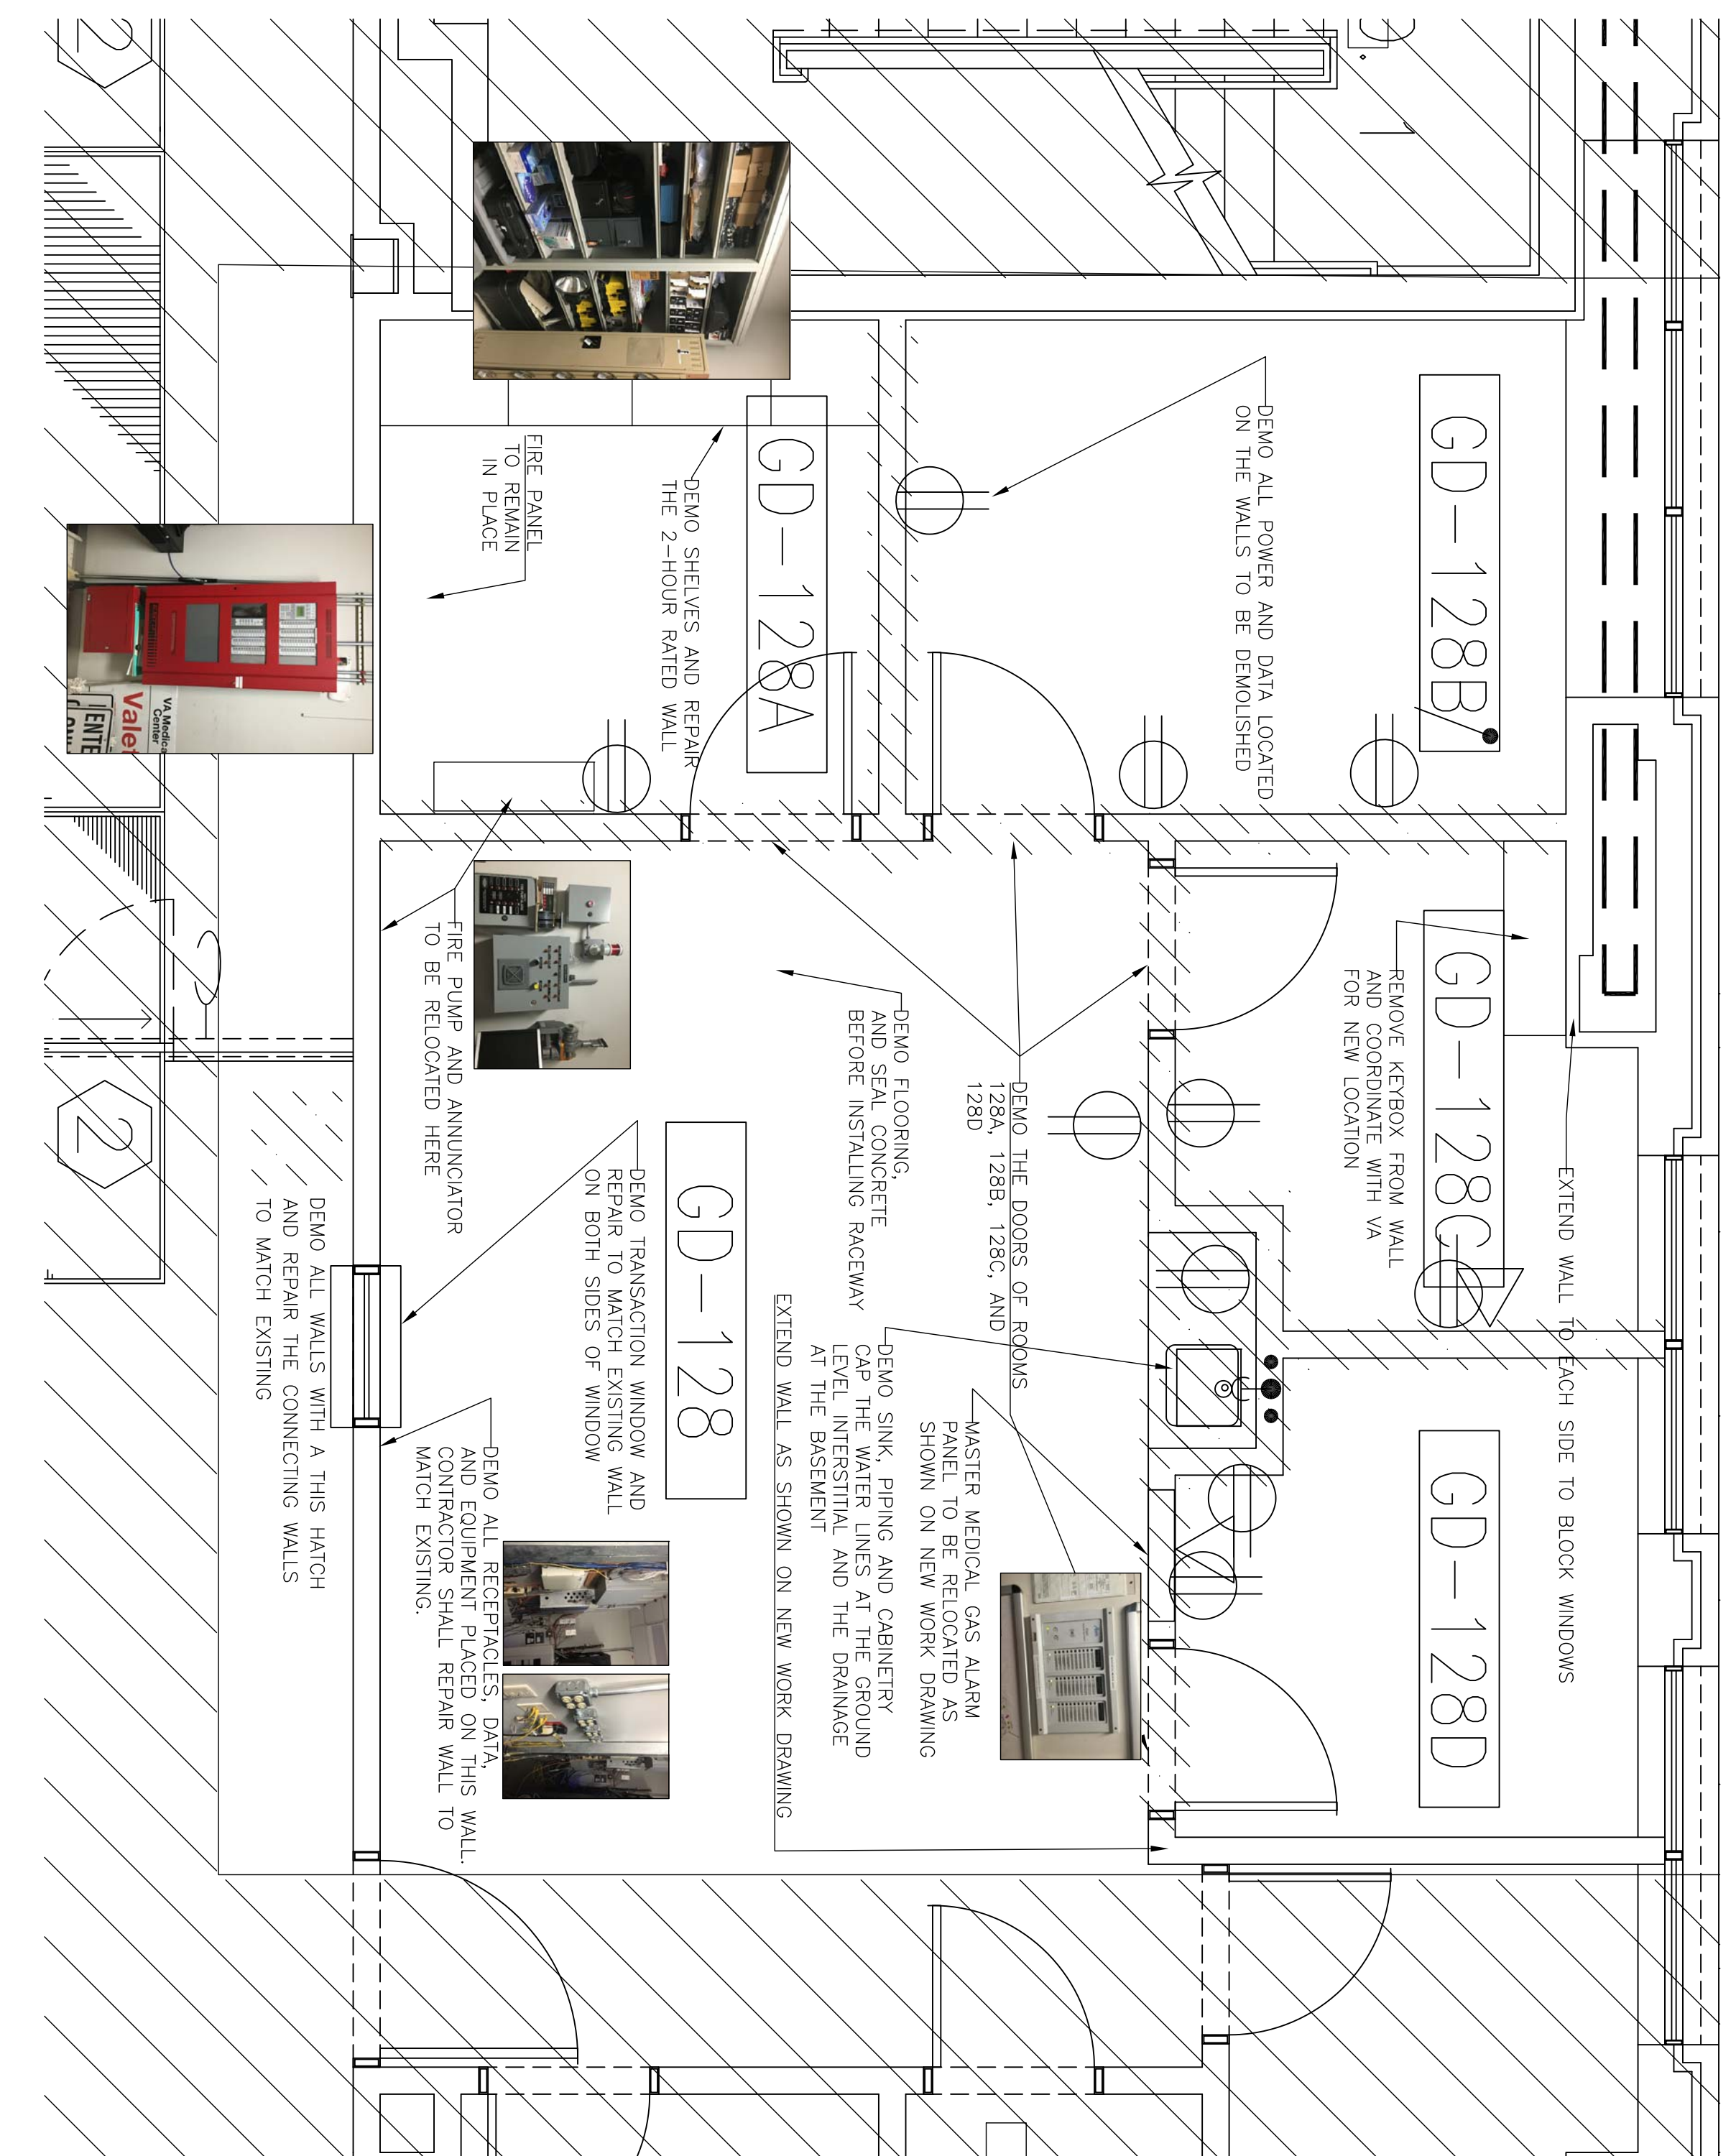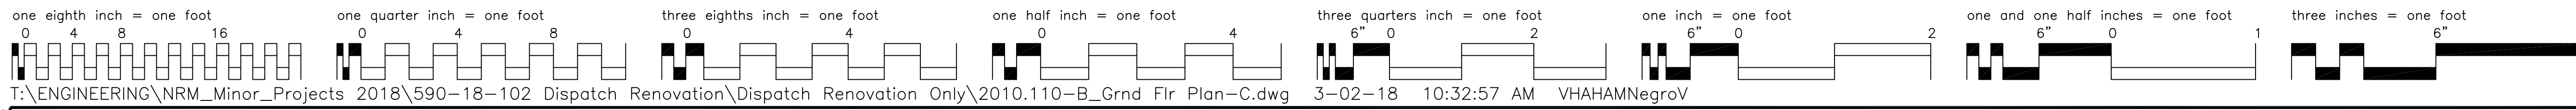


GROUND FLOOR DEMO PLAN
 NTS


- GENERAL NOTES**
1. THE CONTRACTOR SHALL VERIFY ALL FIELD CONDITIONS, HEIGHTS, LEVELS AND DIMENSIONS PRIOR TO BEGINNING CONSTRUCTION AND SHALL MAKE THE NECESSARY ADJUSTMENTS TO THE DRAWINGS BEFORE COMMENCING WORK. BEFORE BEGINNING WORK, THE CONTRACTOR SHALL BE RESPONSIBLE FOR VERIFYING ALL DIMENSIONS AND ADJUSTING ACCORDING TO THE COR'S WRITTEN INSTRUCTIONS.
 2. UNLESS OTHERWISE INDICATED, INTERIOR DIMENSIONS ARE TO FINISH FACE OF WALL.
 3. ALL INTERIOR FINISHED SURFACES WHICH ARE DAMAGED WHILE PERFORMING WORK UNDER THIS CONTRACT SHALL BE PATCHED AND/OR REPLACED AND FINISHED TO MATCH ADJACENT AREAS.
 4. THE CONTRACTOR SHALL FAMILIARIZE HIMSELF WITH THE EXISTING CONDITIONS AND VERIFY ALL CONDITIONS AND DIMENSIONS WHICH AFFECT THE CONTRACT.
 5. THE CONTRACTOR SHALL BE RESPONSIBLE FOR THE PROTECTION OF EXISTING UTILITIES AND SERVICES OF WORK NECESSARY FOR THE PROPER CONSTRUCTION OF AND ALIGNMENT OF THE NEW PORTIONS OF THE WORK. THE CONTRACTOR SHALL BE RESPONSIBLE FOR THE PROTECTION OF THE EXISTING UTILITIES, FABRICATION AND ERECTION OF ALL NEW WORK.
 6. THE CONTRACTOR SHALL CAREFULLY STUDY AND COMPARE THE DOCUMENTS WITH EACH OTHER, AND AT ONCE, REPORT TO THE COR ANY ERRORS AND INCONSISTENCIES OR OMISSIONS DISCOVERED. IN THE CONTRACT DOCUMENTS, THE CONTRACTOR SHALL BE RESPONSIBLE FOR VERIFYING THE COR'S DOCUMENTS WITHOUT SUCH NOTICE TO THE COR, THE CONTRACTOR SHALL BE RESPONSIBLE FOR THE COST OF THE CONSTRUCTION AND SHALL BEAR THE AMOUNT OF THE COST OF THE CONSTRUCTION.
 7. PROVIDE DOOR FRAME OFFSET OF 4" TYPICAL UNLESS OTHERWISE NOTED.

JOB CONDITIONS

1. THE EXISTING FACILITIES SHALL REMAIN OPEN FOR BUSINESS THROUGHOUT THE CONSTRUCTION PERIOD. THE CONTRACTOR SHALL CONDUCT HIS OPERATIONS IN SUCH A MANNER AS TO MINIMIZE DISRUPTION TO THE NORMAL OPERATIONS OF THE FACILITIES. EXACT SEQUENCE AND TIMING OF THE VARIOUS PORTIONS OF THE WORK SHALL BE THE CONTRACTOR'S RESPONSIBILITY. THE CONTRACTOR SHALL BE RESPONSIBLE FOR MAINTAINING APPROPRIATE AND SAFE MEANS OF ACCESS AND EGRESS AND TO MAINTAIN THE SECURITY OF THE FACILITY AT ALL TIME.
2. OPERATIONS INVOLVING EXCESSIVE NOISE, DUST OR ODORS WHICH WOULD TRANSMIT BEYOND THE AREA OF CONSTRUCTION SHALL BE PERFORMED OUTSIDE NORMAL BUSINESS HOURS. COORDINATE WITH VA.
3. THE CONTRACTOR SHALL HAVE ACCESS TO THE SITE DURING APPROVED HOURS. THE CONTRACTOR SHALL NOT INTERFERE WITH OR DISRUPT THE ONGOING OPERATION OF THE FACILITY. FOR STORMS AND INTERFERING CONDITIONS, THE CONTRACTOR SHALL STOP WORK IMMEDIATELY AND WITH THE EXCEPTION OF EMERGENCY REPAIRS, THE CONTRACTOR SHALL NOT OVERLOAD THE STRUCTURE.
4. THE CONTRACTOR SHALL ERECT TEMPORARY BARRETTACKS, PARTITIONS, AND DOORS OR OTHER MEANS OF PROTECTION AS REQUIRED TO PROTECT THE FACILITIES FROM CONSTRUCTION ACTIVITIES. THE CONTRACTOR SHALL BE RESPONSIBLE FOR MAINTAINING SECURITY. ALL BARRETTACKS, PARTITIONS AND DOORS WILL ALSO BE SUBJECT TO PREVENT THE PASSAGE OF DUST AND GERM FROM CONSTRUCTION AREAS TO THE FACILITIES. THE CONTRACTOR SHALL BE RESPONSIBLE FOR THE MEANS OF EGRESS AS REQUIRED BY CODE.
5. THE CONTRACTOR SHALL NOT INTERRUPT ANY UTILITY SERVICE TO ANY PORTION OF THE BUILDING NOT WITHIN THE AREA UNDER CONSTRUCTION AT ANY TIME. THE CONTRACTOR SHALL BE RESPONSIBLE FOR THE PROTECTION OF ALL UTILITY SERVICE TO THE BUILDING SHALL BE PERFORMED AT A TIME AGREED TO BY THE VA, AND WITH APPROPRIATE TRADES ON SITE TO RESUME ANY INDEPENDENT INTERVENTION.
6. THE CONTRACTOR SHALL CONFORM TO THE REQUIREMENTS OF THE VA THE PARKING AREAS AND NOISY OPERATIONS.

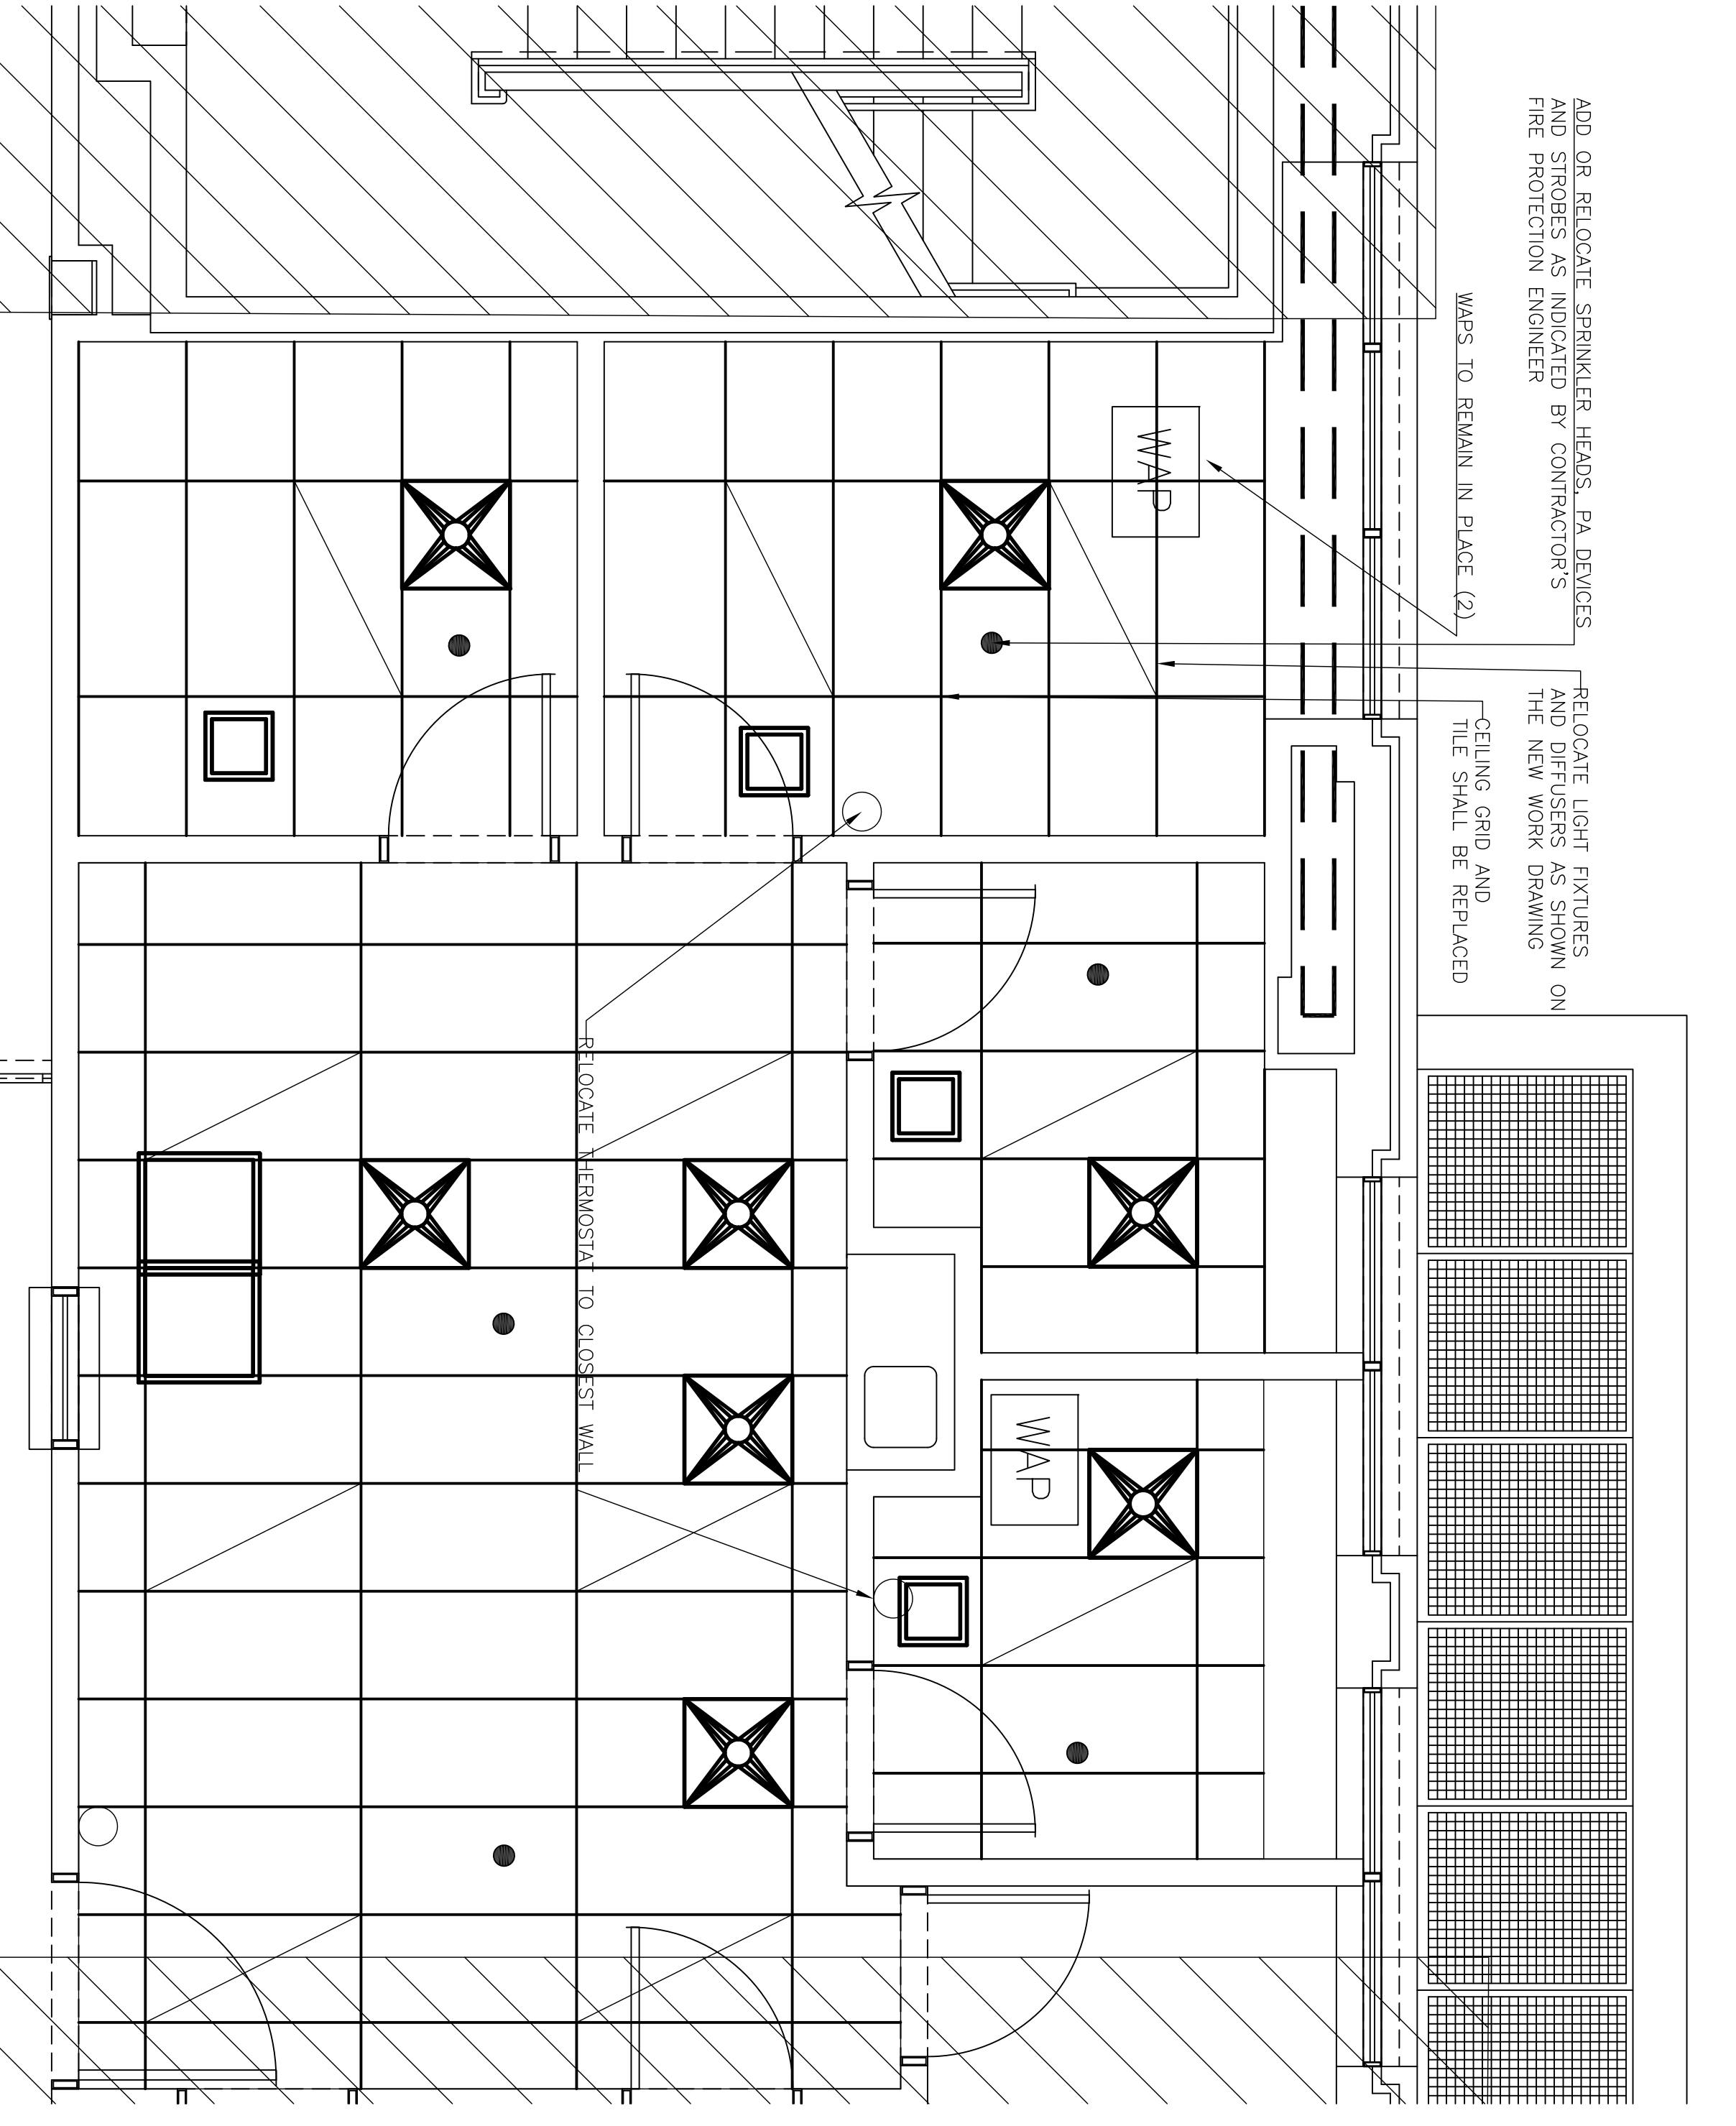

GROUND FLOOR EXISTING REFLECTED CEILING PLAN
 NTS

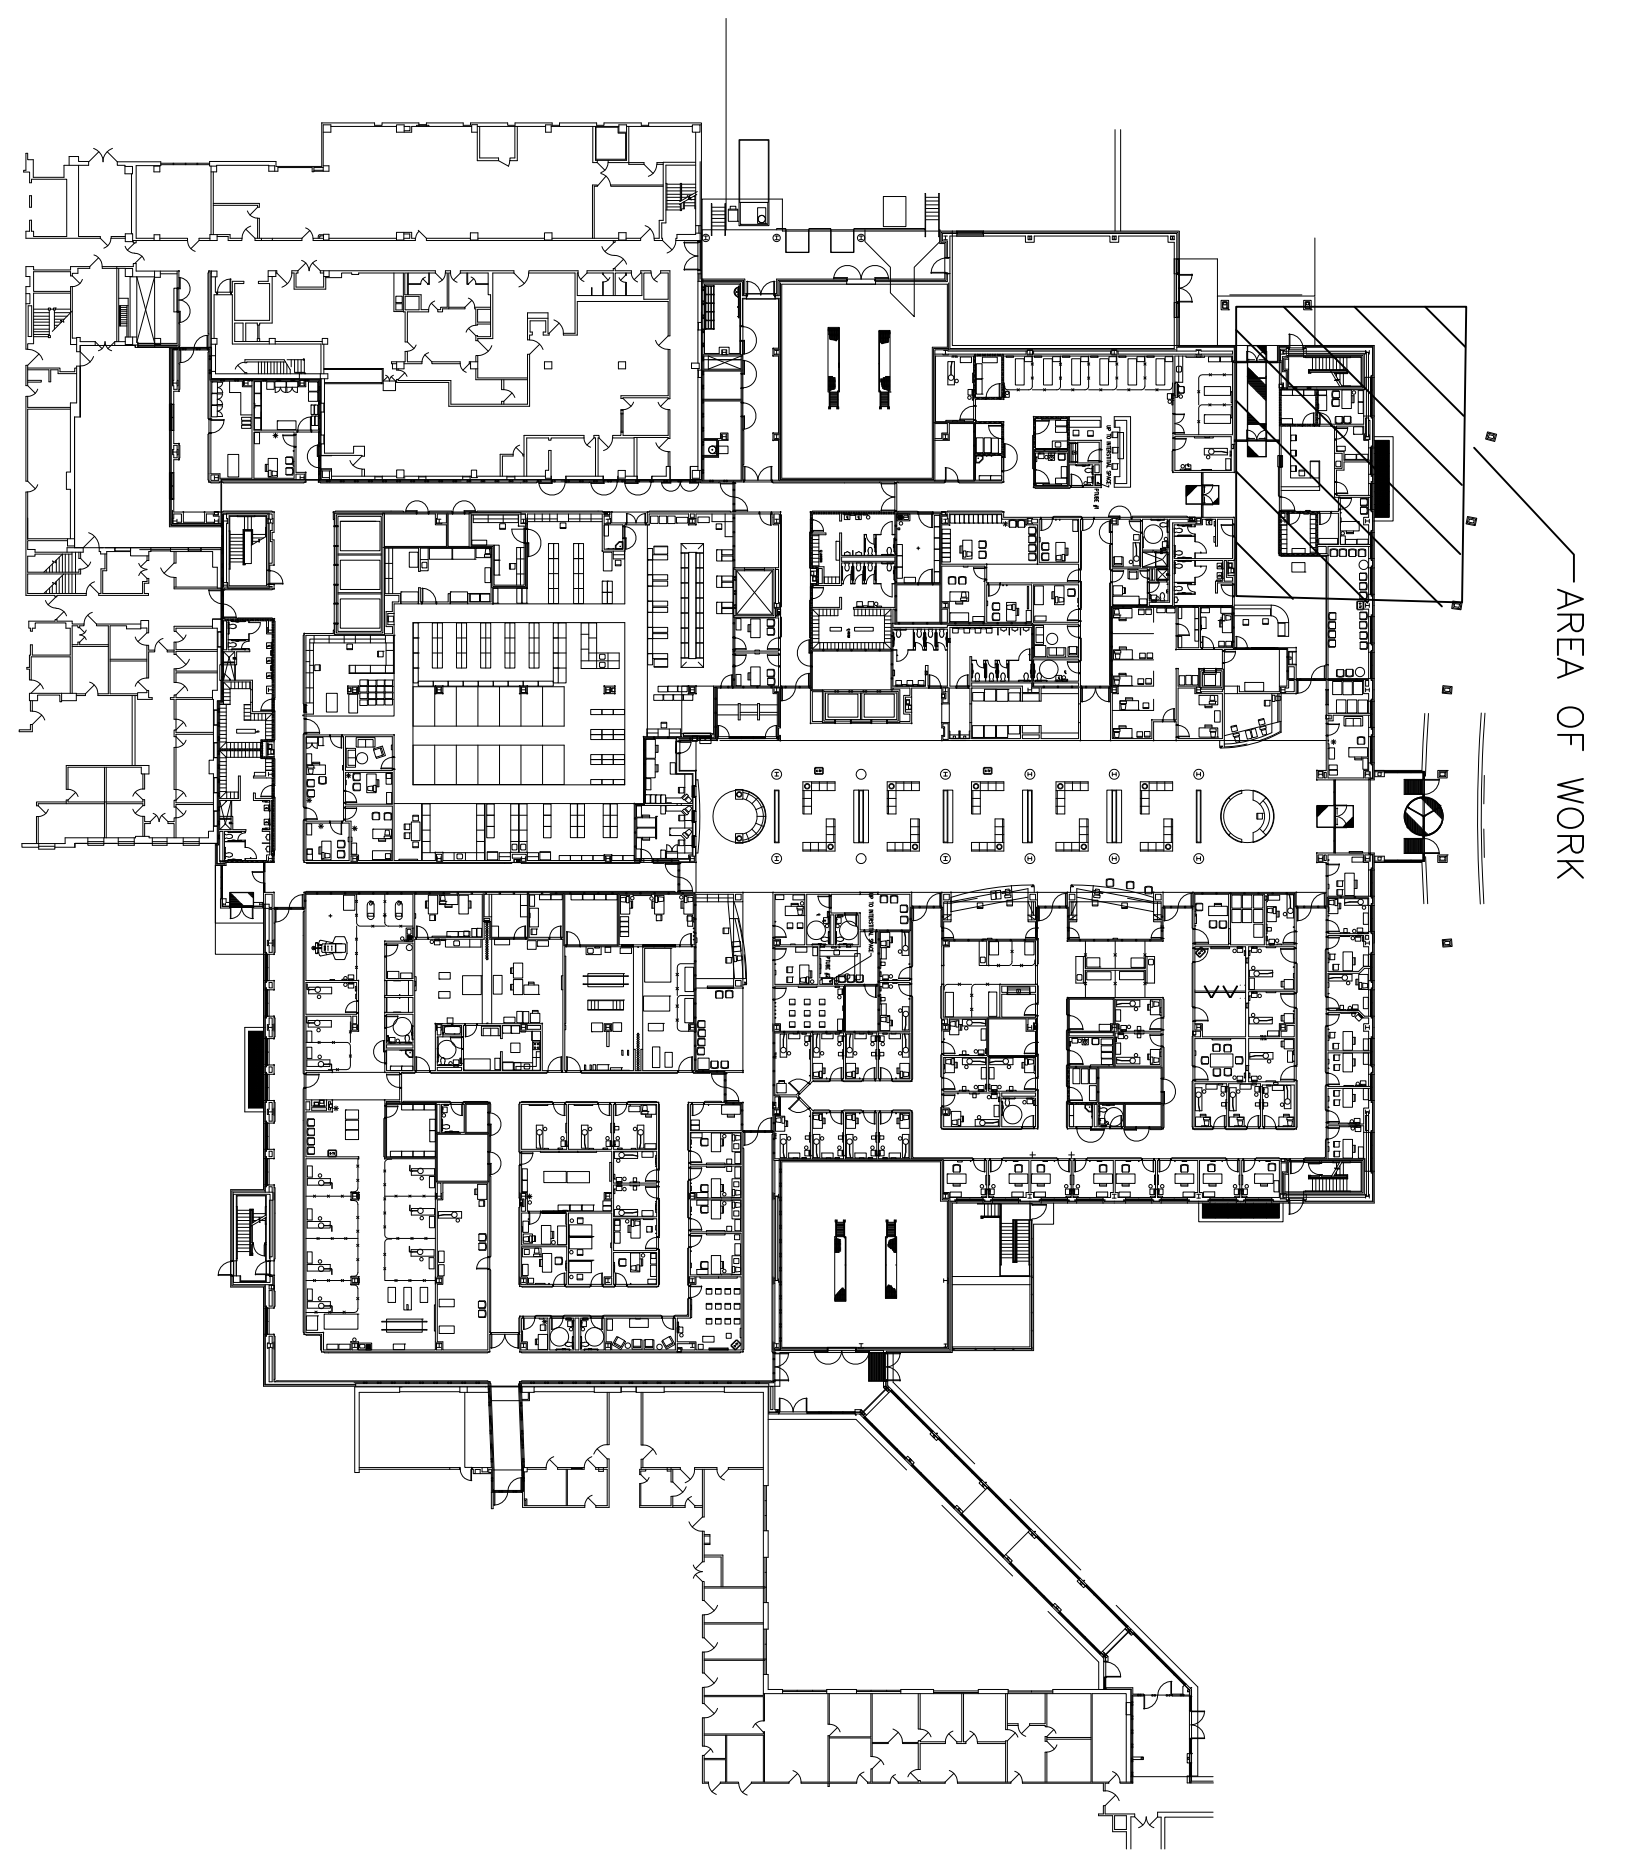


KEY PLAN
 NOT TO SCALE


FULLY SPRINKLERED

Revision	Date	Consultants	Architect/Engineers	Drawing Title EXISTING CONDITIONS AND DEMOLITION	Project Title DISPATCH RENOVATION	Project Number 590-18-102
				Approved Project Director	Location VA MEDICAL CENTER, HAMPTON, VA	Building Number 108
					Date	Drawing Number Dwg 2 of 6
					Checked	
					Drawn	




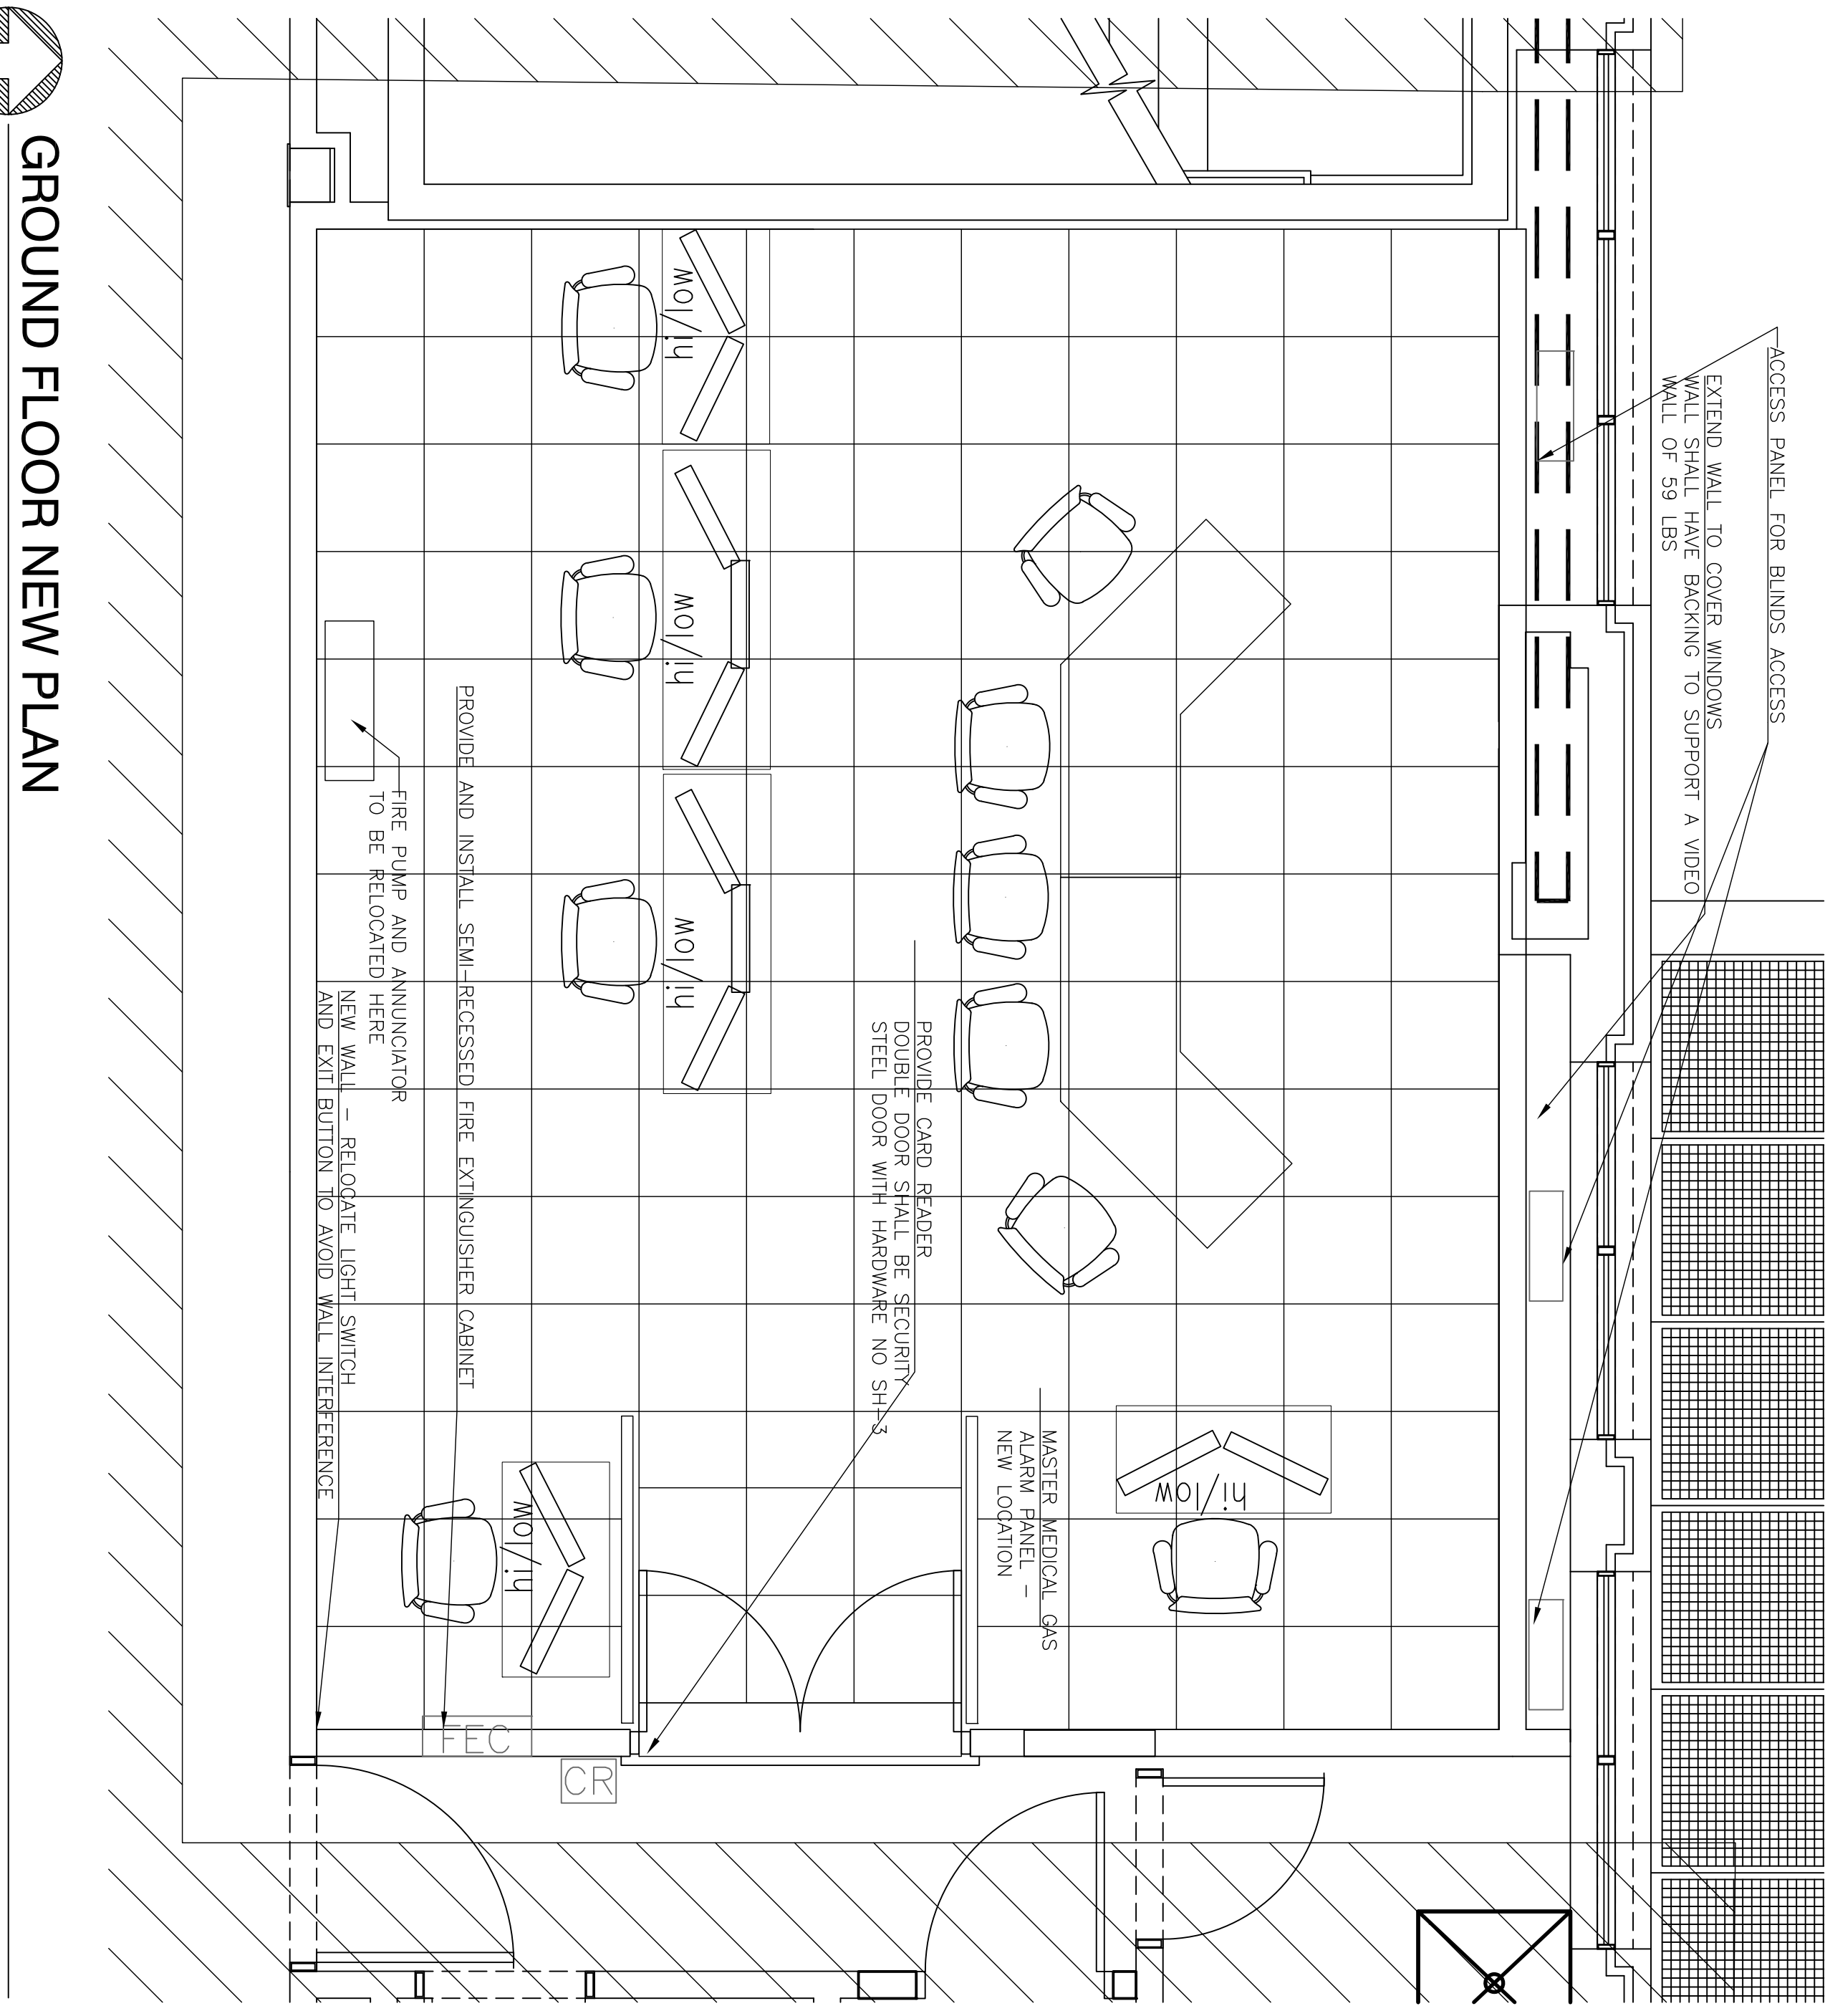


GROUND FLOOR NEW PLAN
NTS

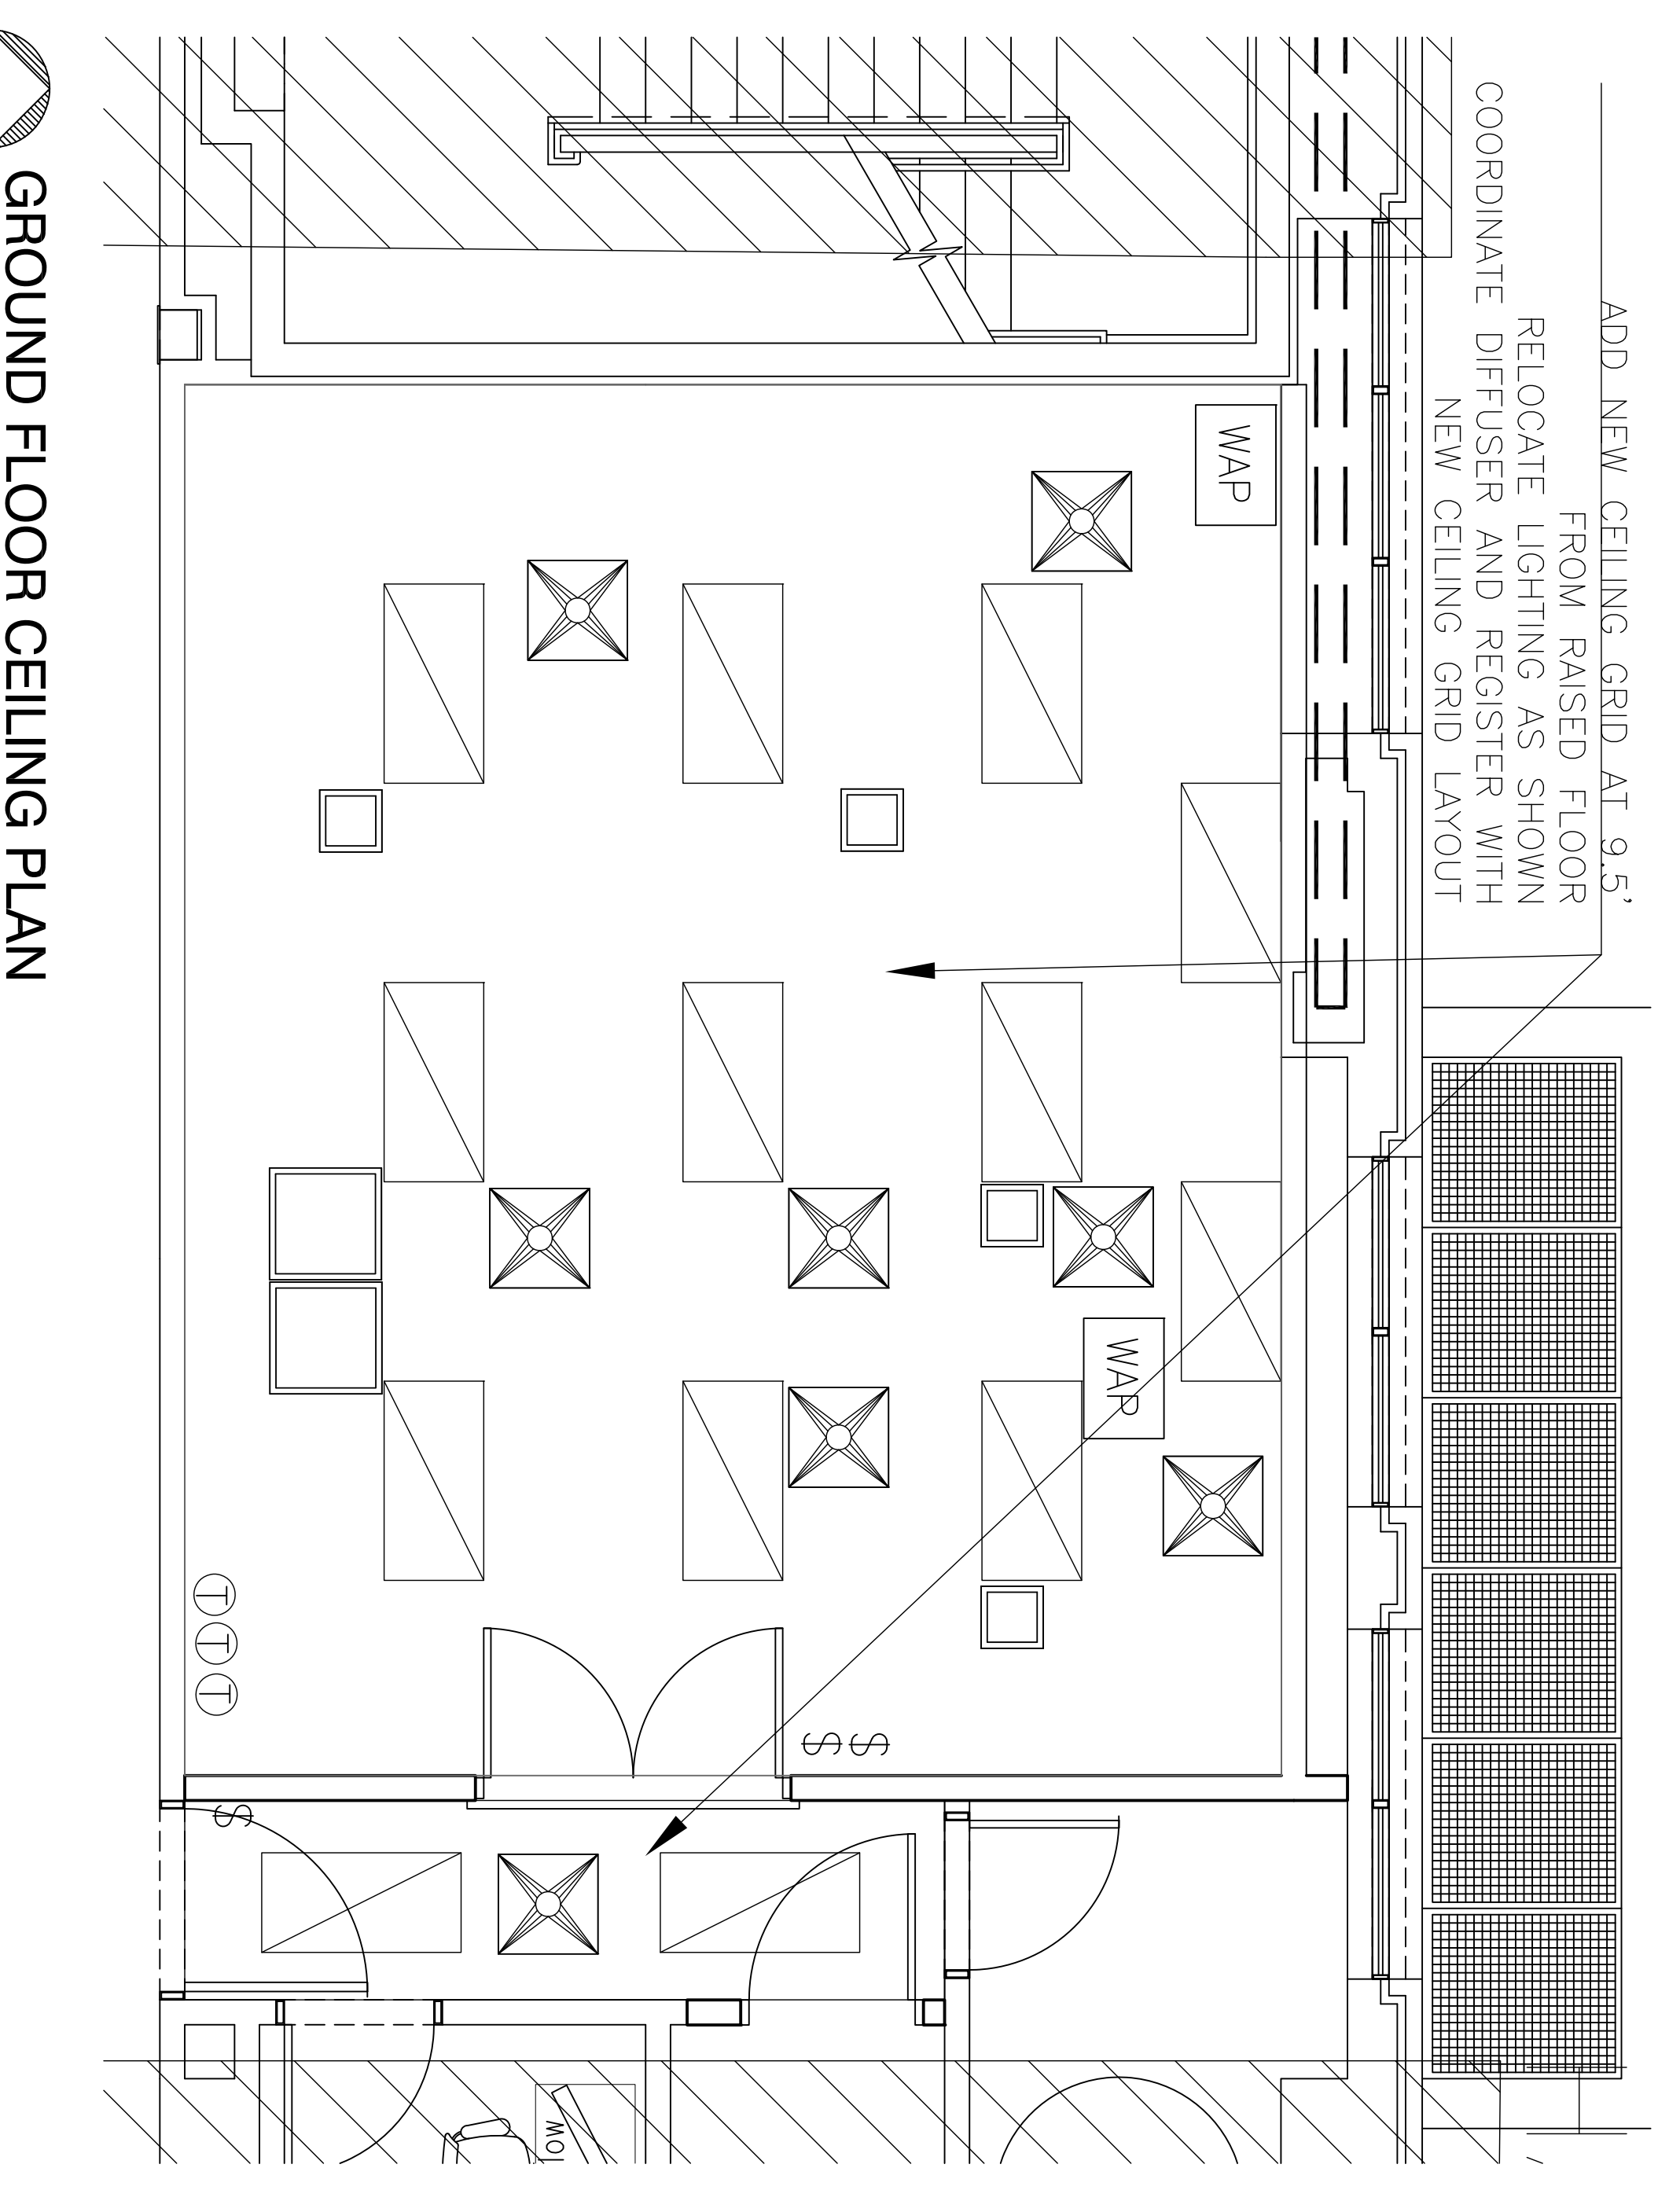

GROUND FLOOR CEILING PLAN
NTS

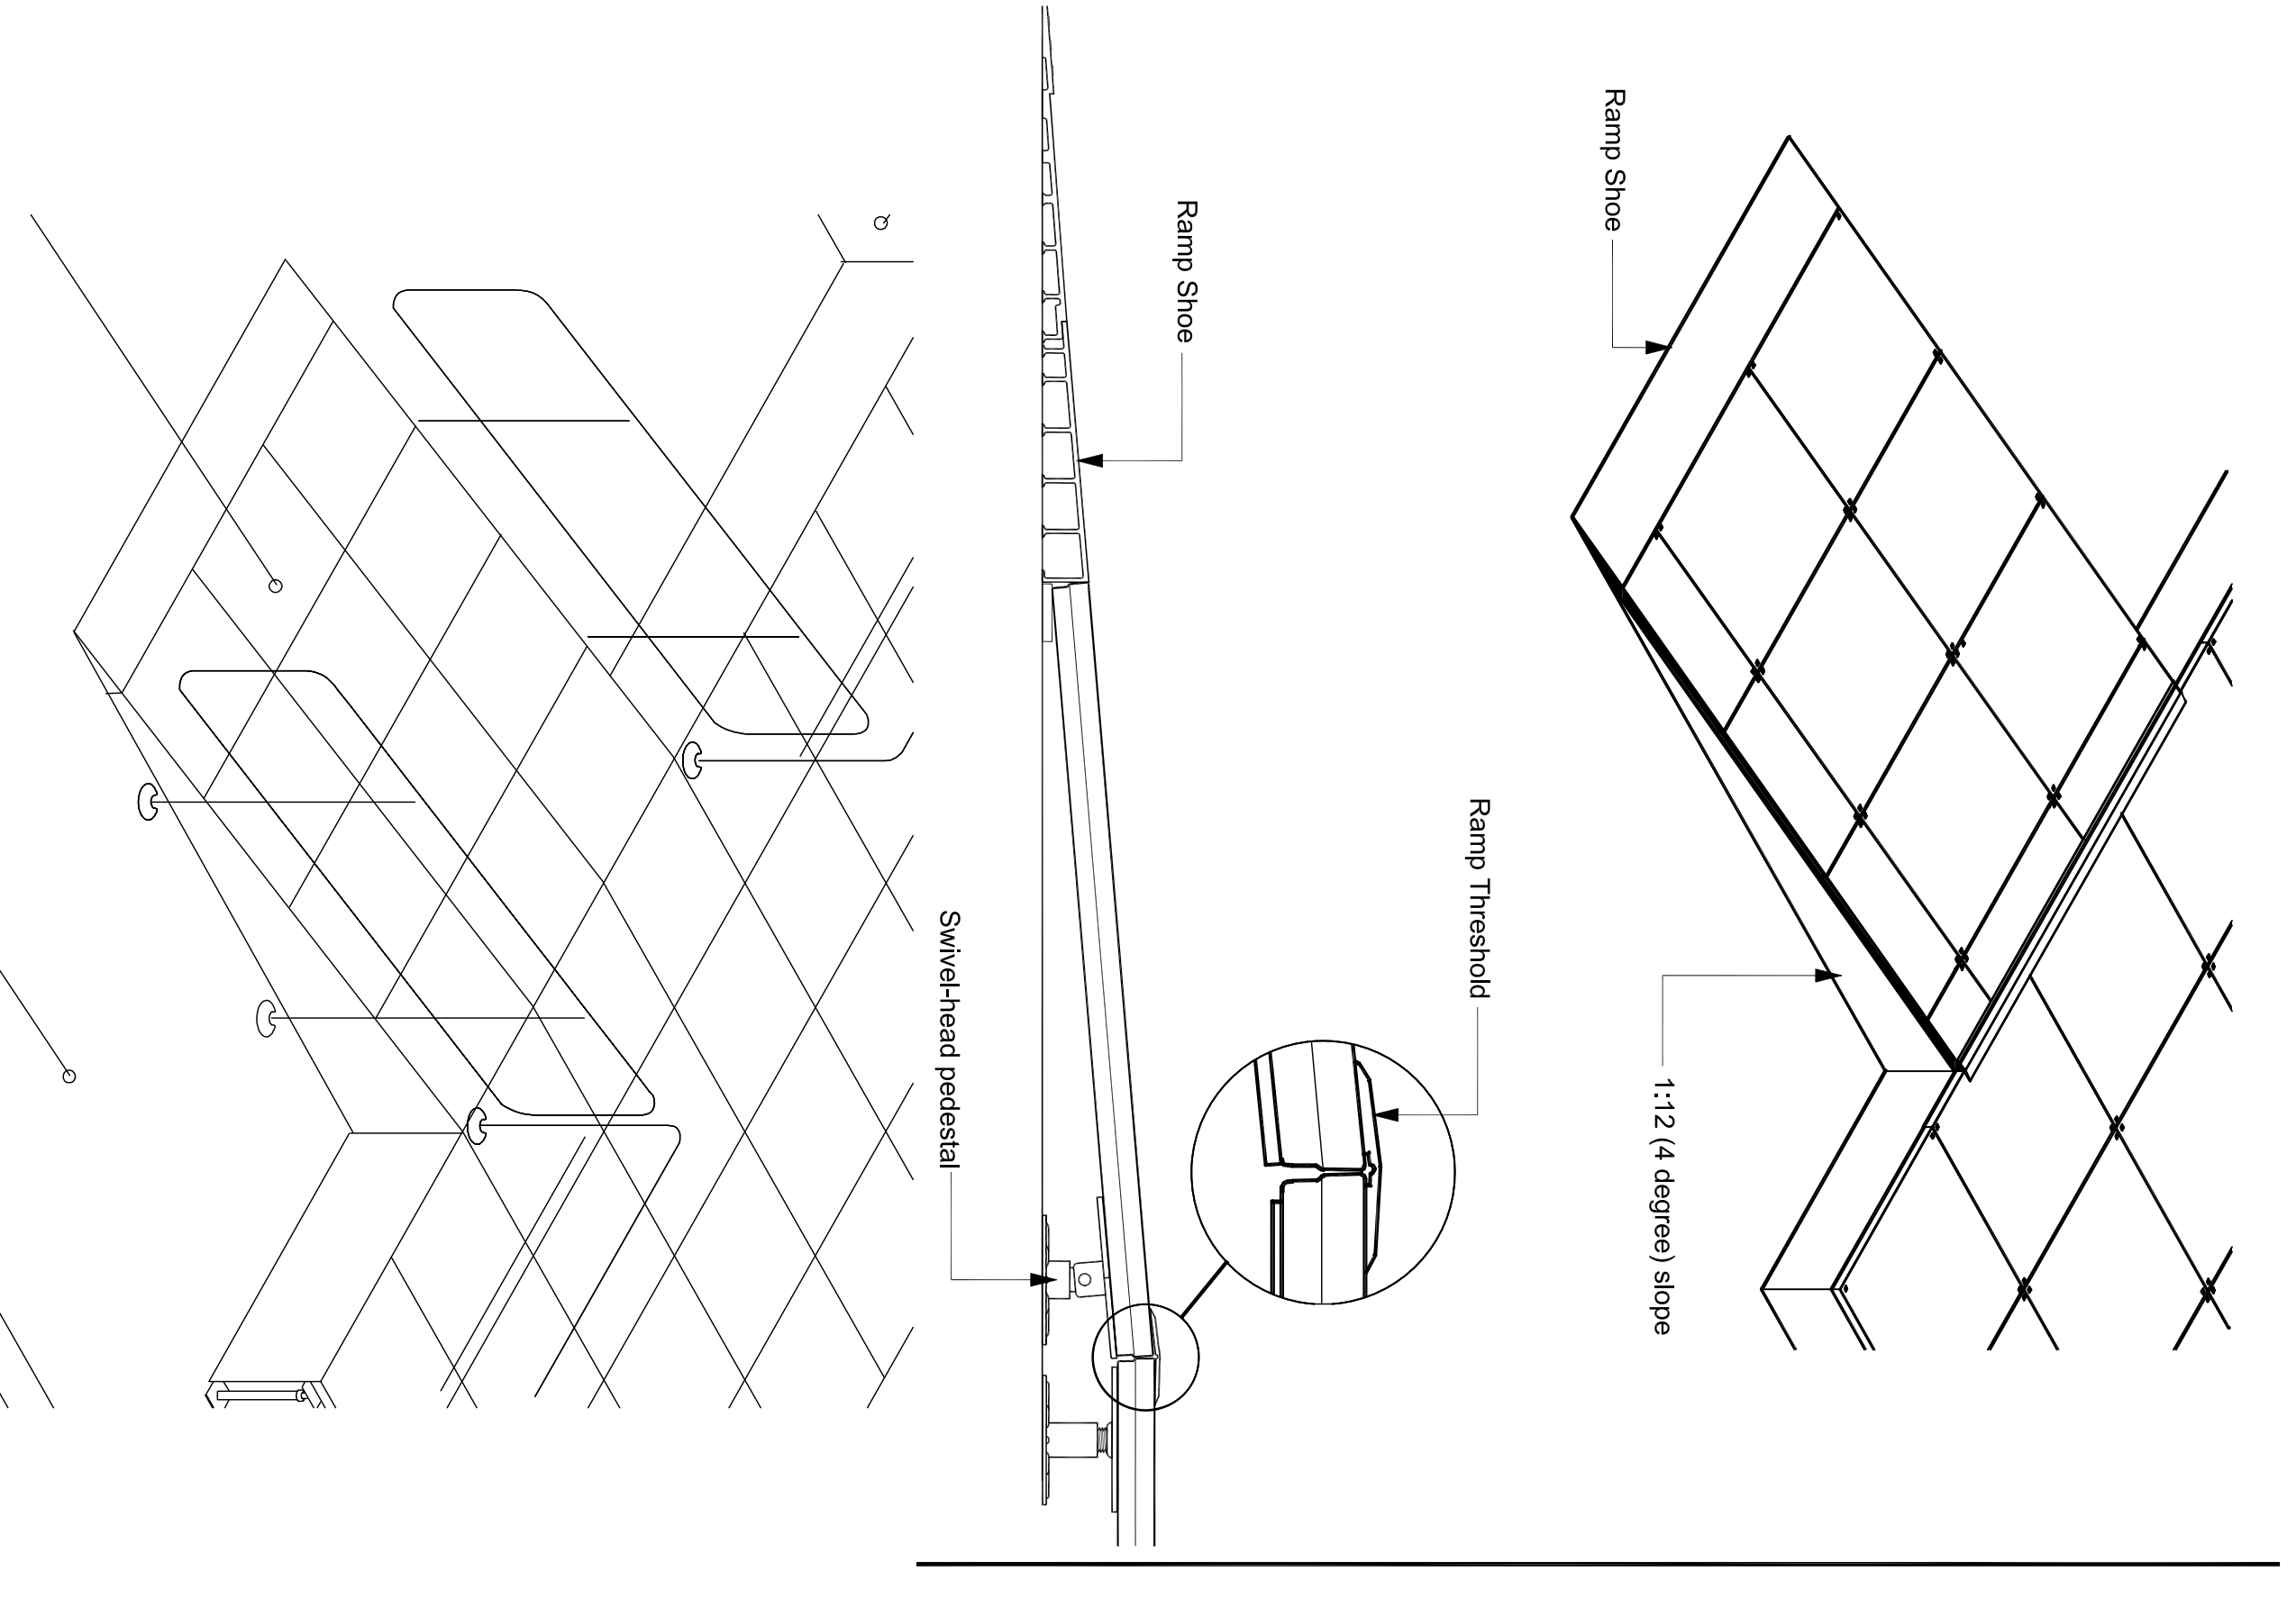


RAISED FLOOR DETAIL

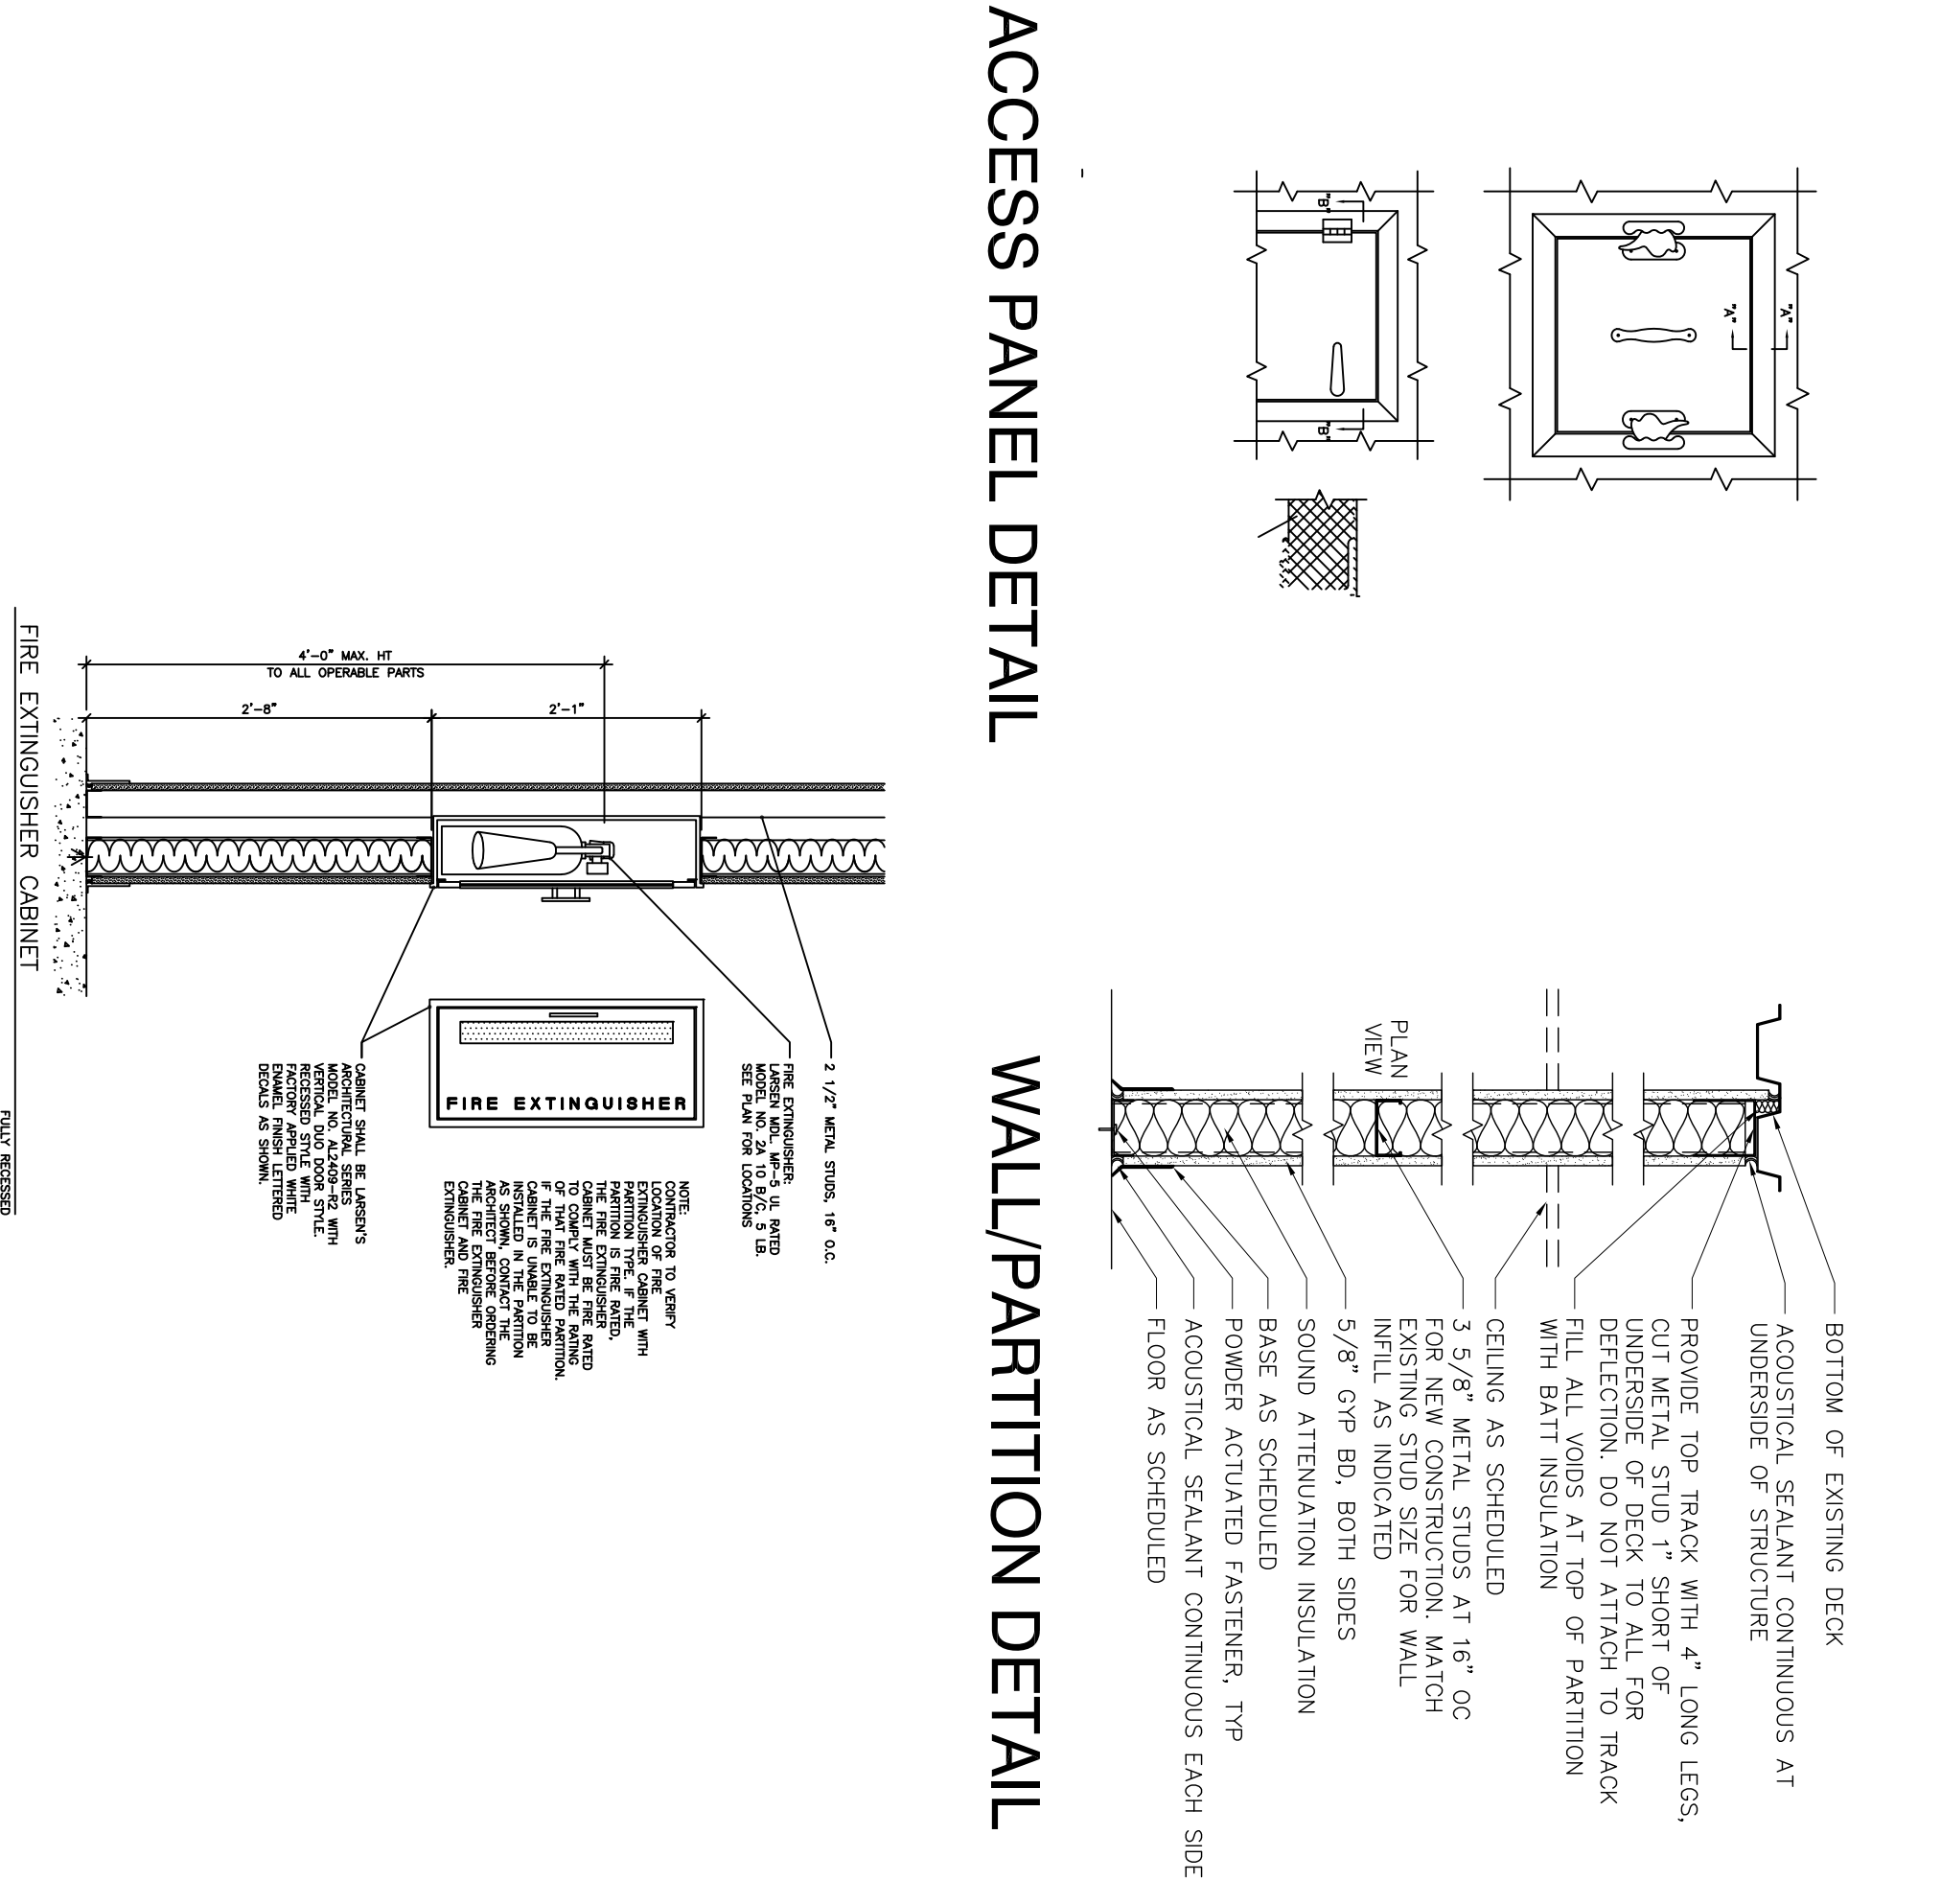


ACCESS PANEL DETAIL

WALL/PARTITION DETAIL

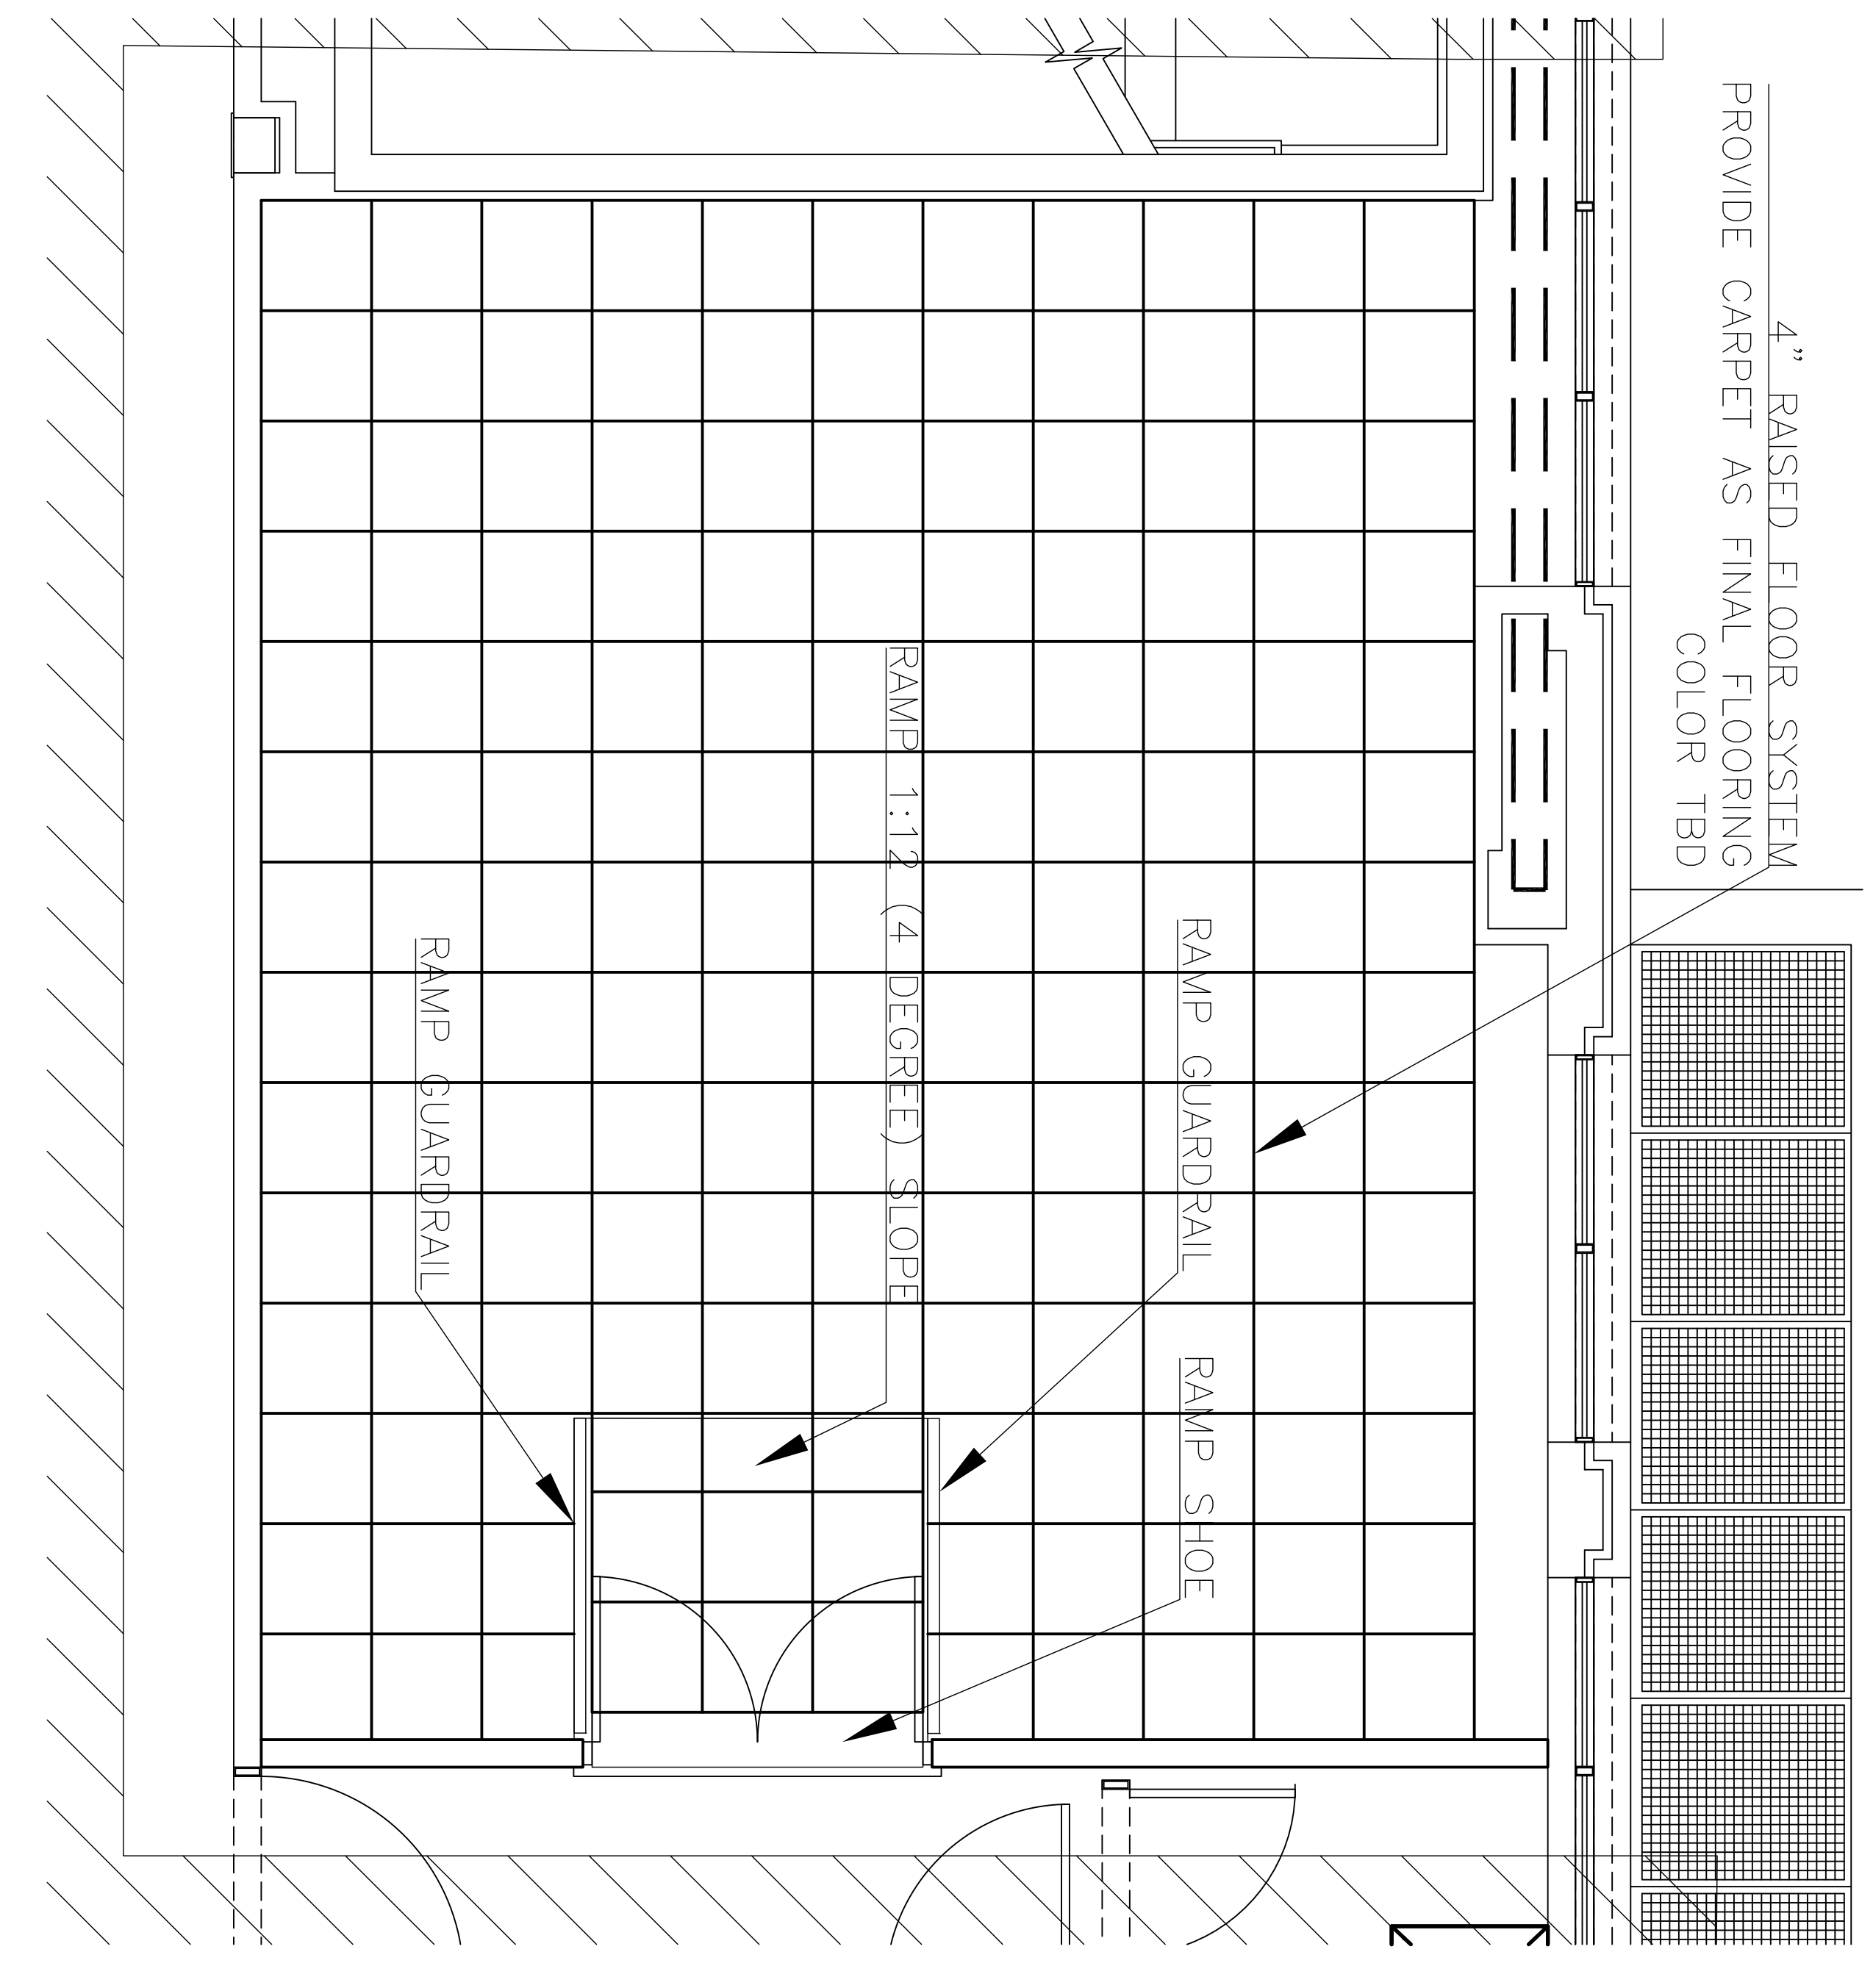

GROUND FLOOR NEW RAISED FLOOR
NTS

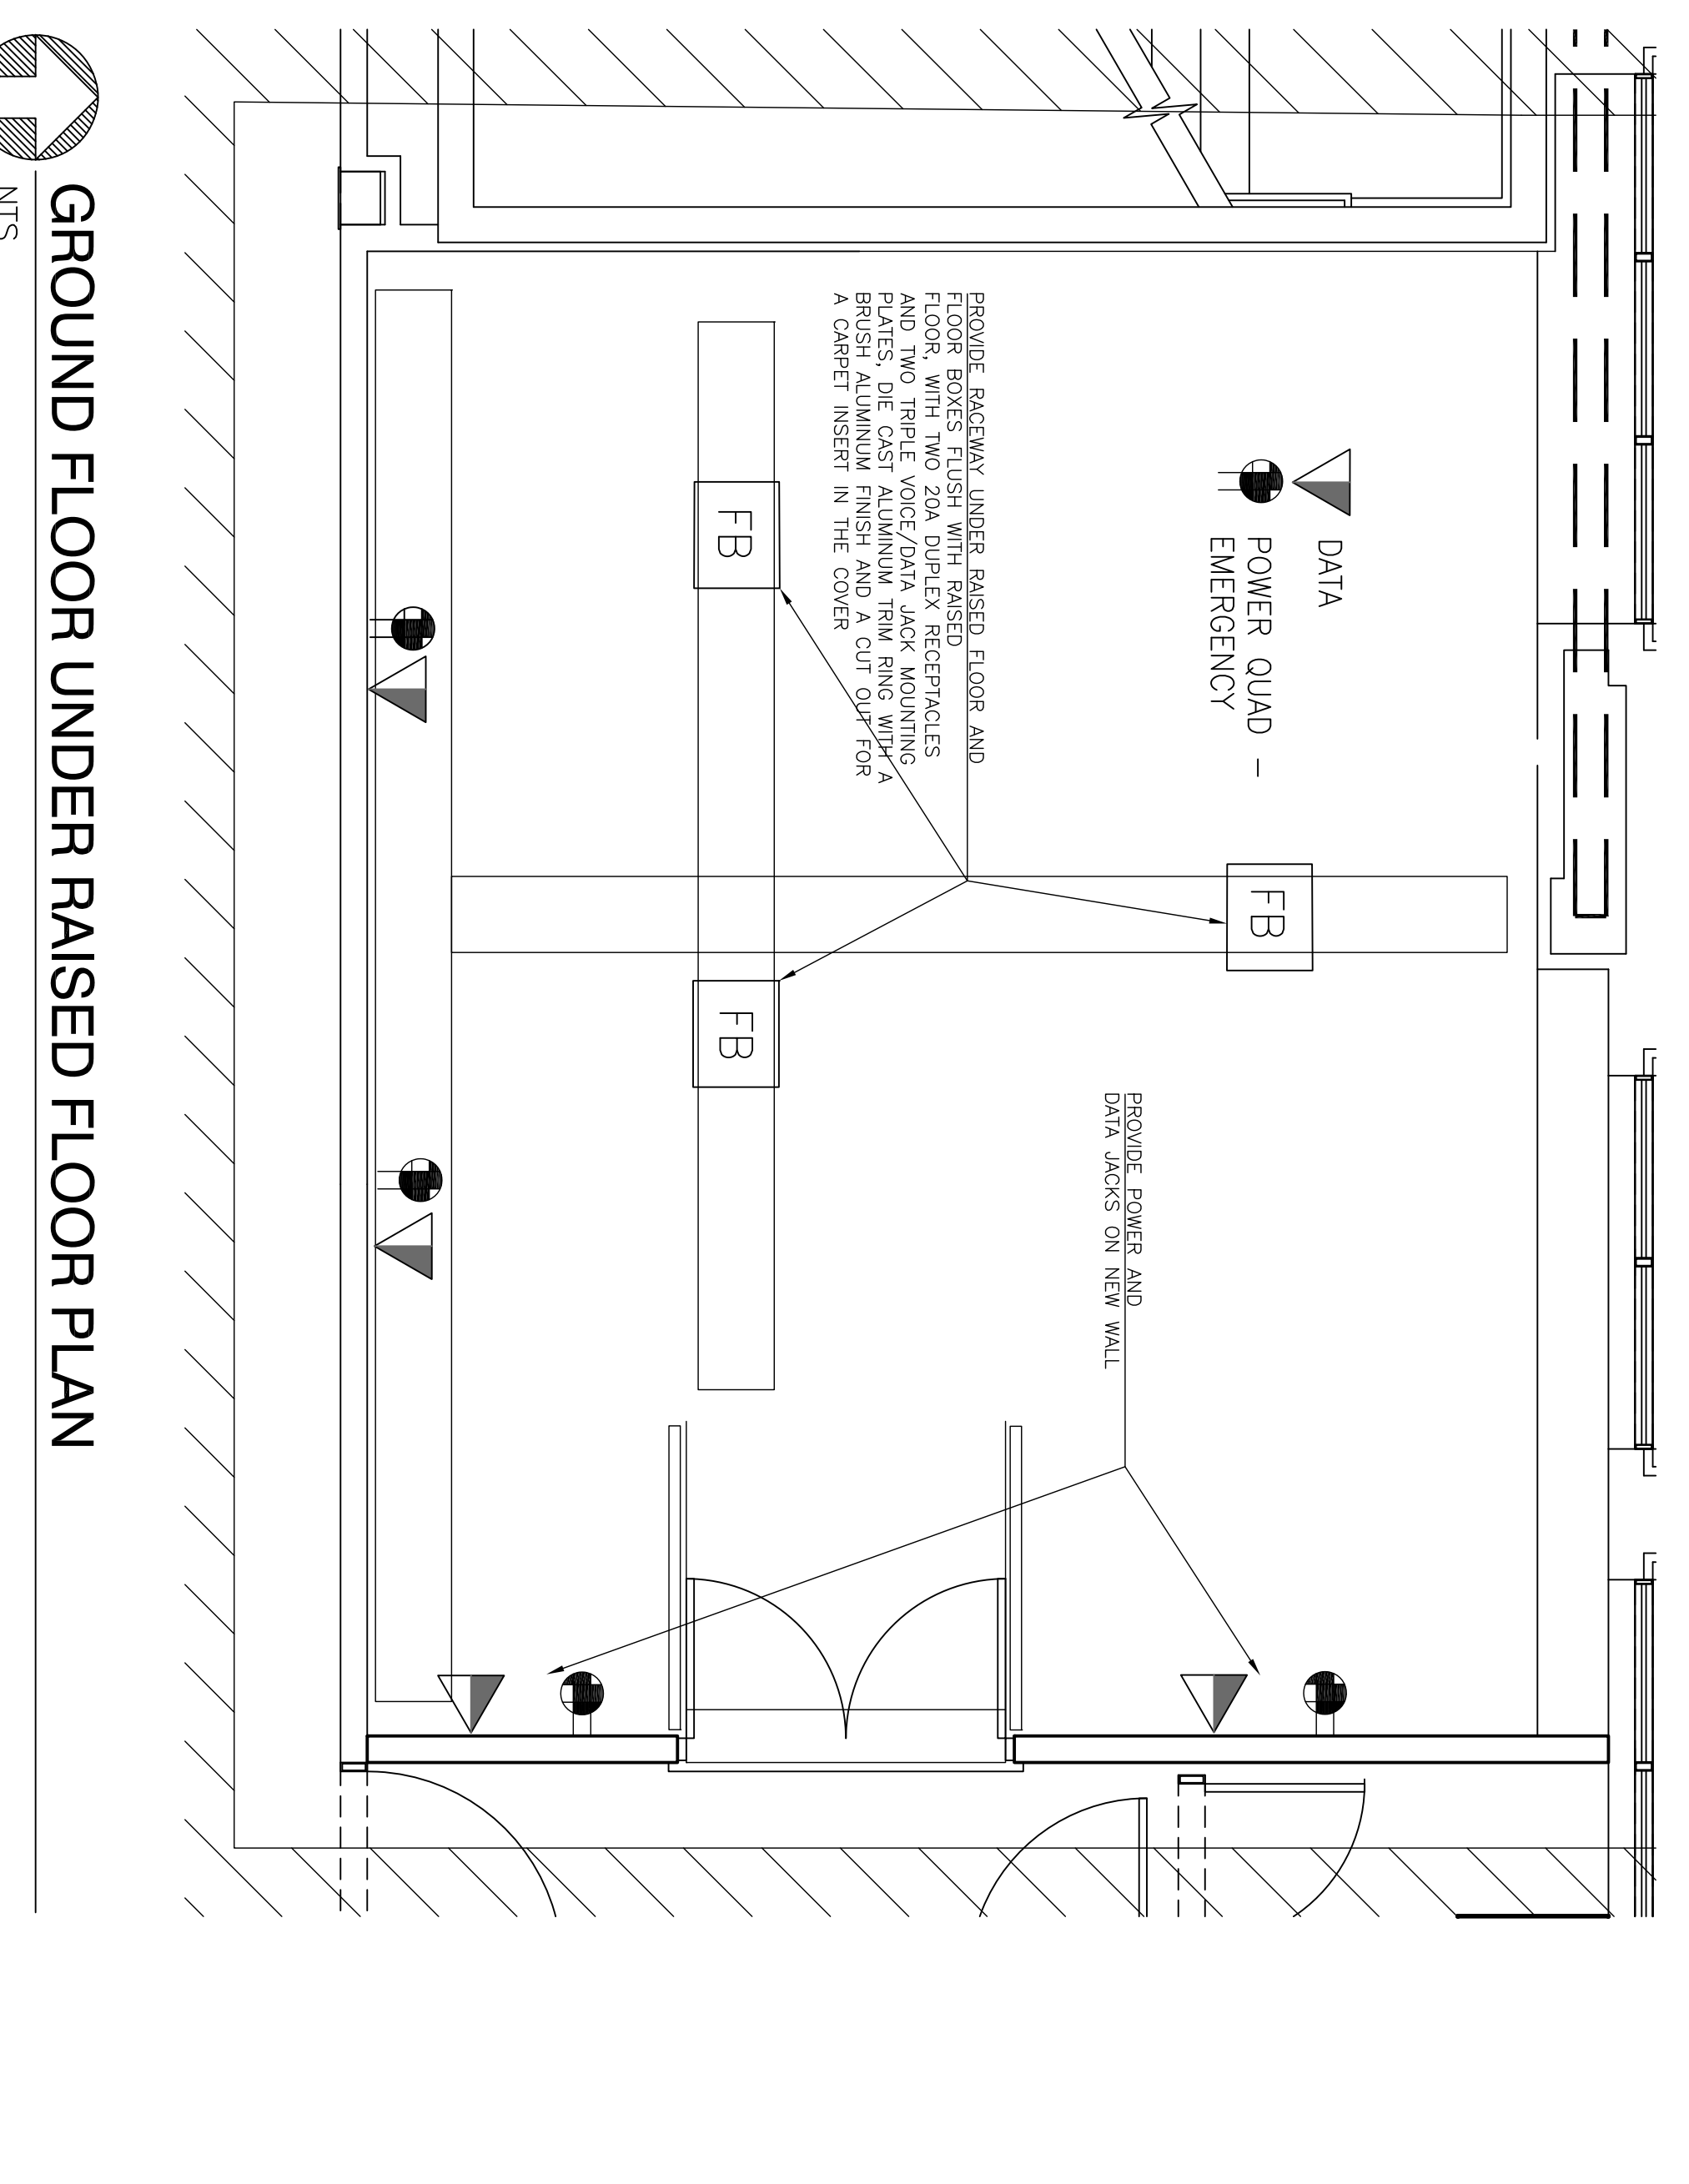



GROUND FLOOR UNDER RAISED FLOOR PLAN
NTS

<p>CONSULTANTS:</p>	<p>ARCHITECT/ENGINEERS:</p>	<p>Project Title NEW WORK ARCHITECTURAL/MEP</p>	<p>Project Title DISPATCH RENOVATION</p>
<p>DATE:</p>	<p>DATE:</p>	<p>Approved Project Director</p>	<p>Location VA MEDICAL CENTER HAMPTON, VA</p>
<p>DATE:</p>	<p>DATE:</p>	<p>Building Number 1008</p>	<p>Project Number 590-18-102</p>
<p>DATE:</p>	<p>DATE:</p>	<p>Dwg 3 of 6</p>	<p>FULLY SPRINKLERED</p>



Revision	Date

2ND FLOOR INTERSTITIAL NEW WORK

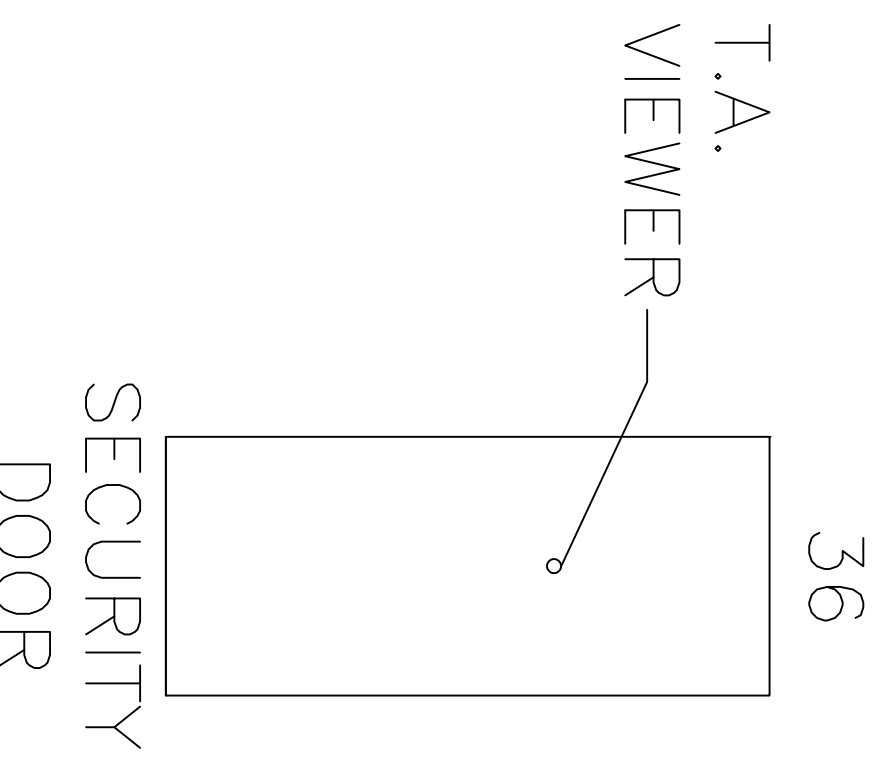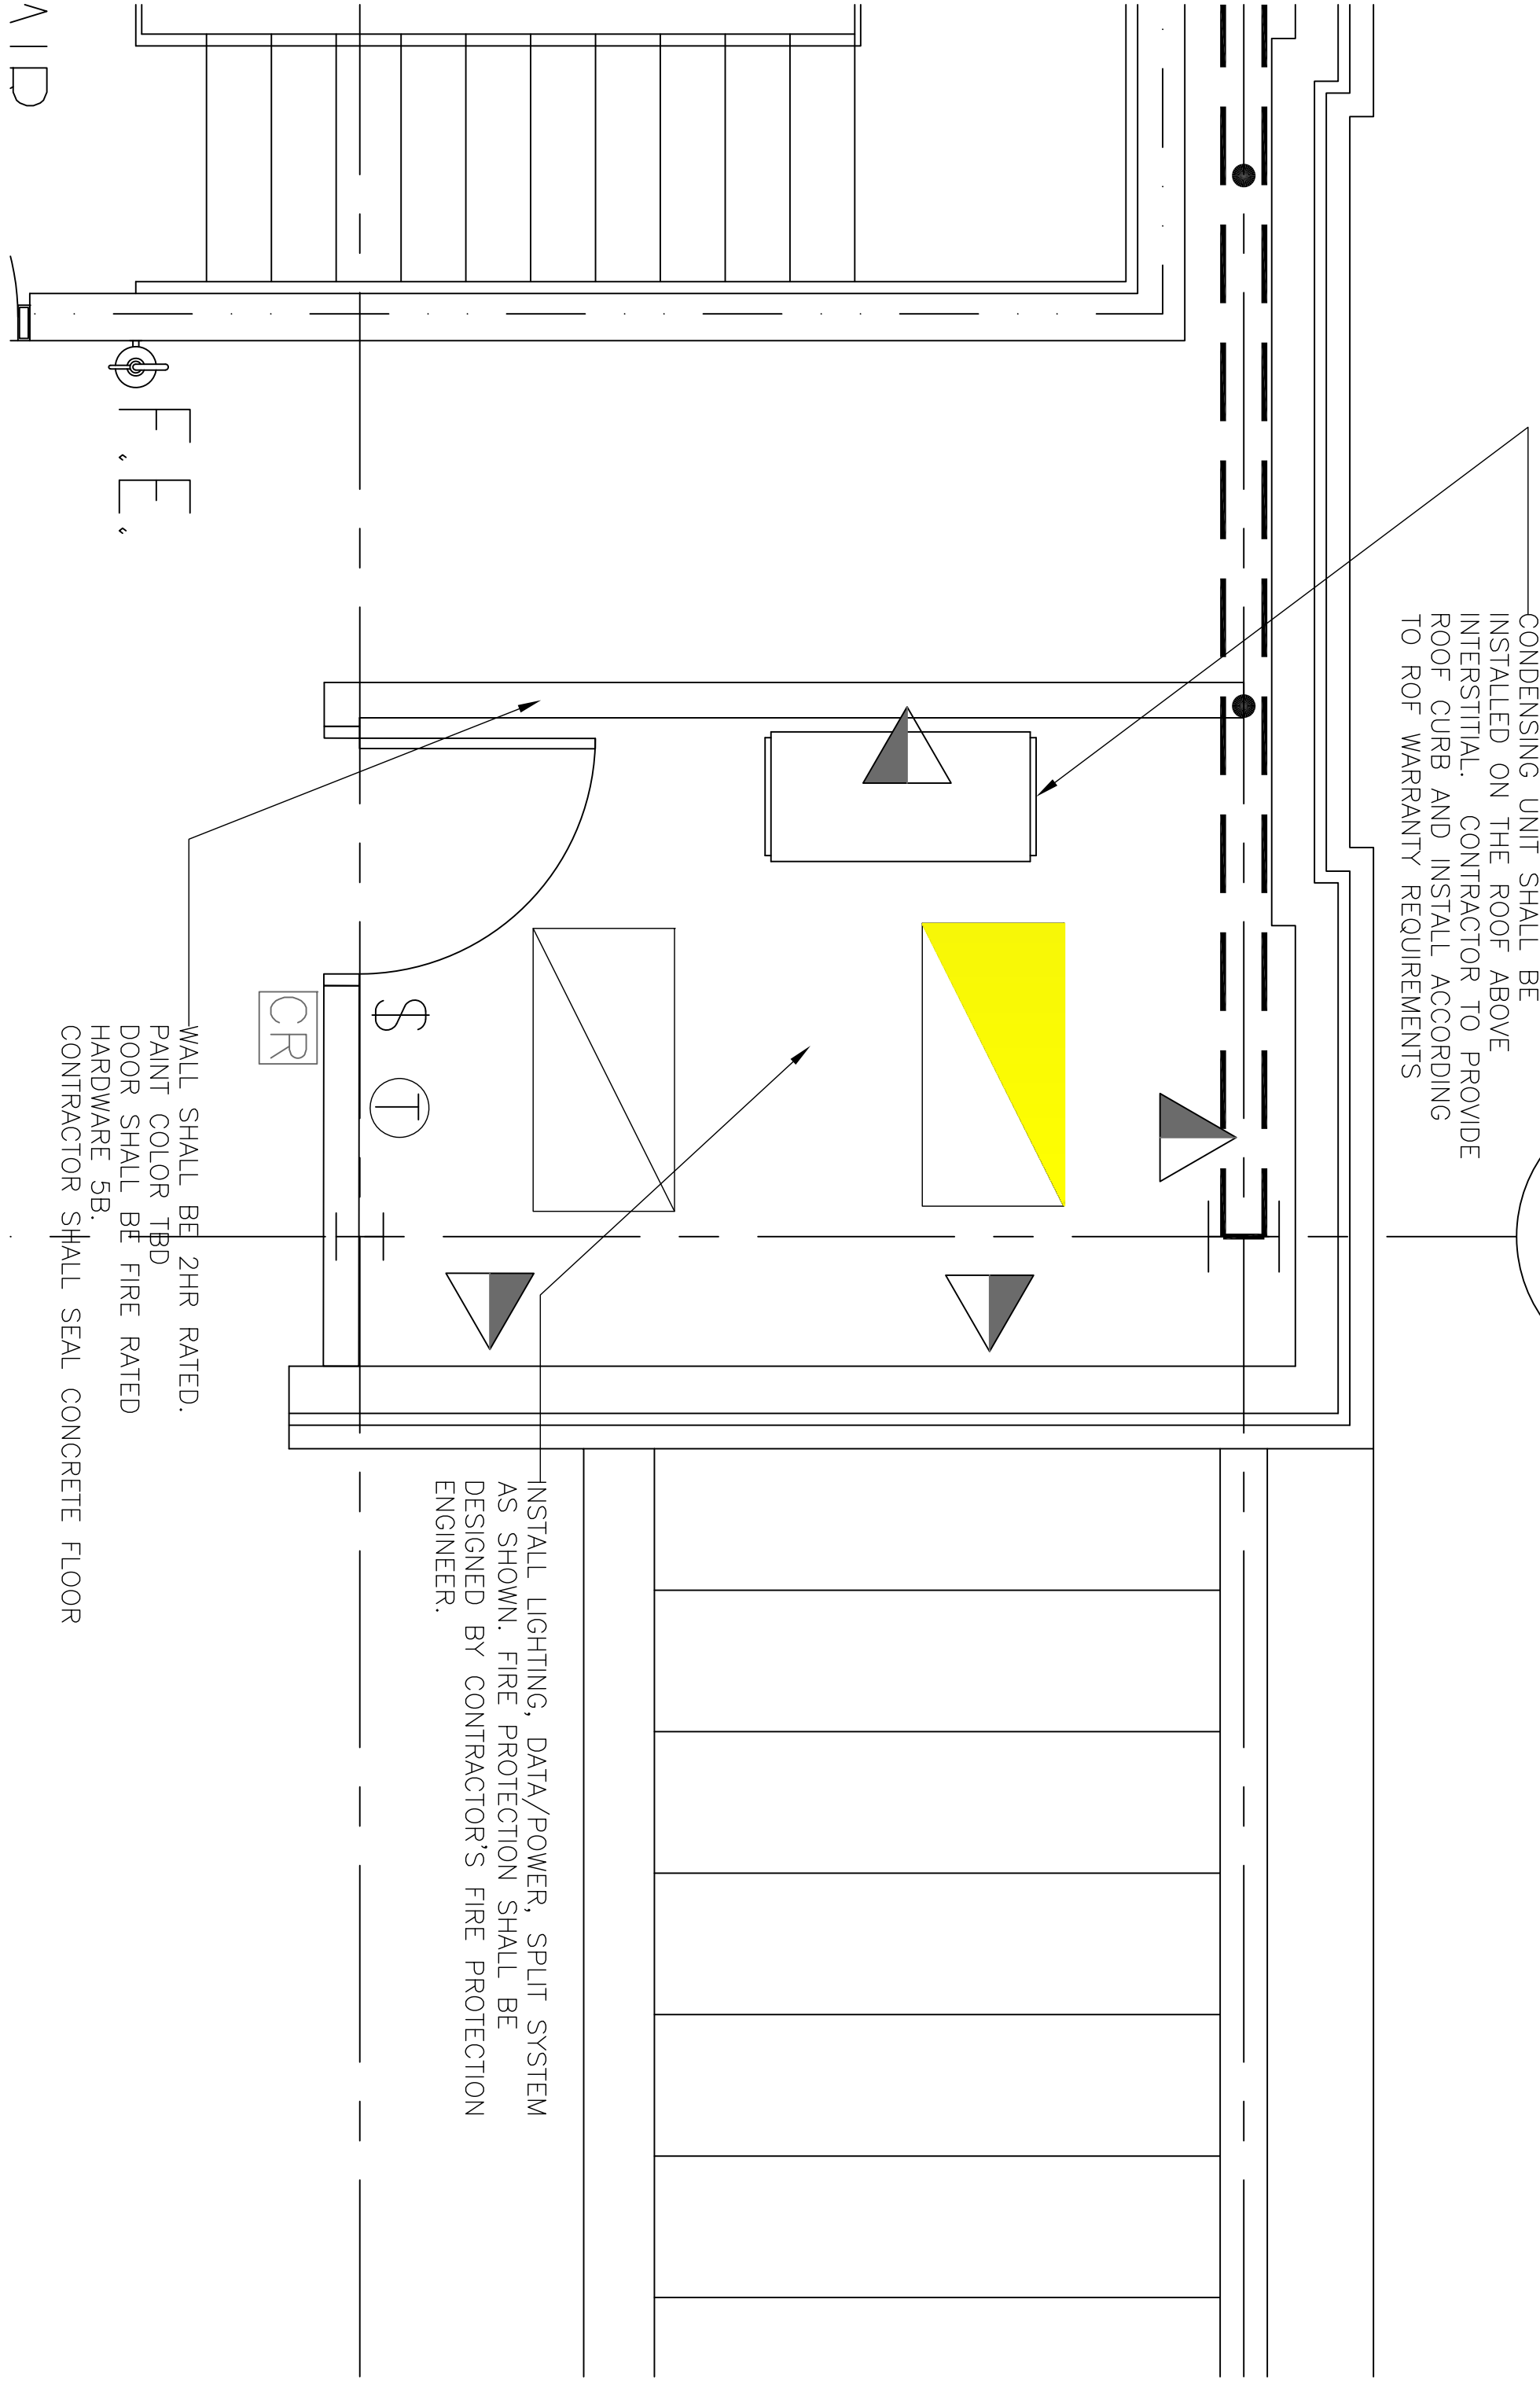

1.5


DUCTLESS SPLIT SYSTEM INDOOR UNIT

MARK	LOCATION	ESP *WC	SUPPLY AIR CFM	OA CFM	COOLING		REMARKS
					TOTAL MBH	SENSIBLE MBH	
EQUIPMENT ROOM	-	-	450	-	24	21.9	①②③


- NOTES:
- ① DUCTLESS SPLIT SYSTEM INDOOR UNITS POWERED VIA OUTDOOR UNIT.
 - ② WALL MOUNTED DUCTLESS SPLIT SYSTEM (COOLING ONLY).
 - ③ PERFORMANCE DATA BASED ON INDOOR DESIGN CONDITIONS OF 80 °FDB/ 67 °FWB AND OUTDOOR DESIGN CONDITIONS OF 95 °FDB/ 75 °FWB.

DUCTLESS SPLIT SYSTEM OUTDOOR UNIT

MARK	SERVES	COOLING CAPACITY	REFRIGERANT TYPE	MIN SEER	ELECTRICAL		
					MFS	VOLTS	PH
		24	R-410A	18.0	15.0	208	1

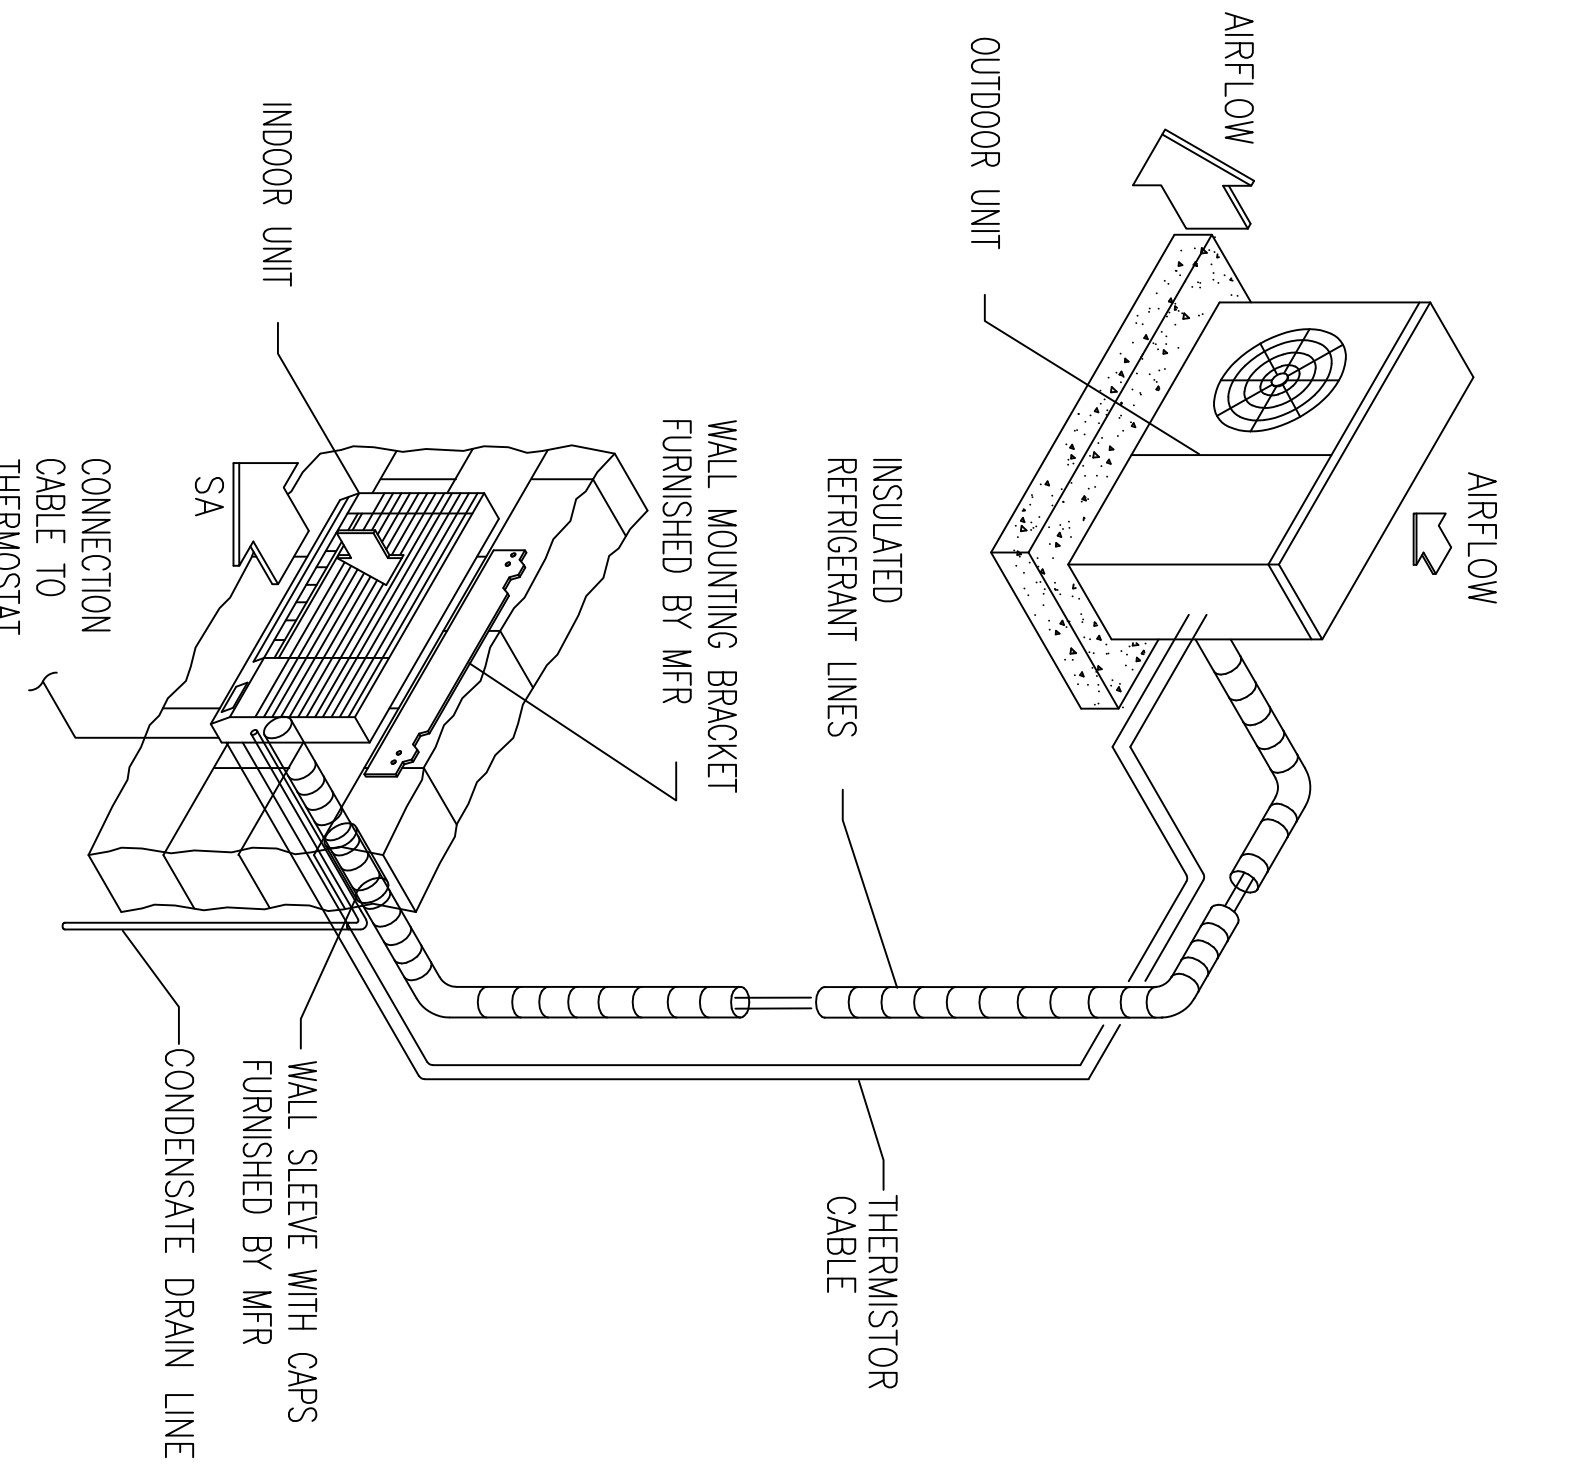

DUCTLESS AIR CONDITIONER UNIT DETAIL
NO SCALE

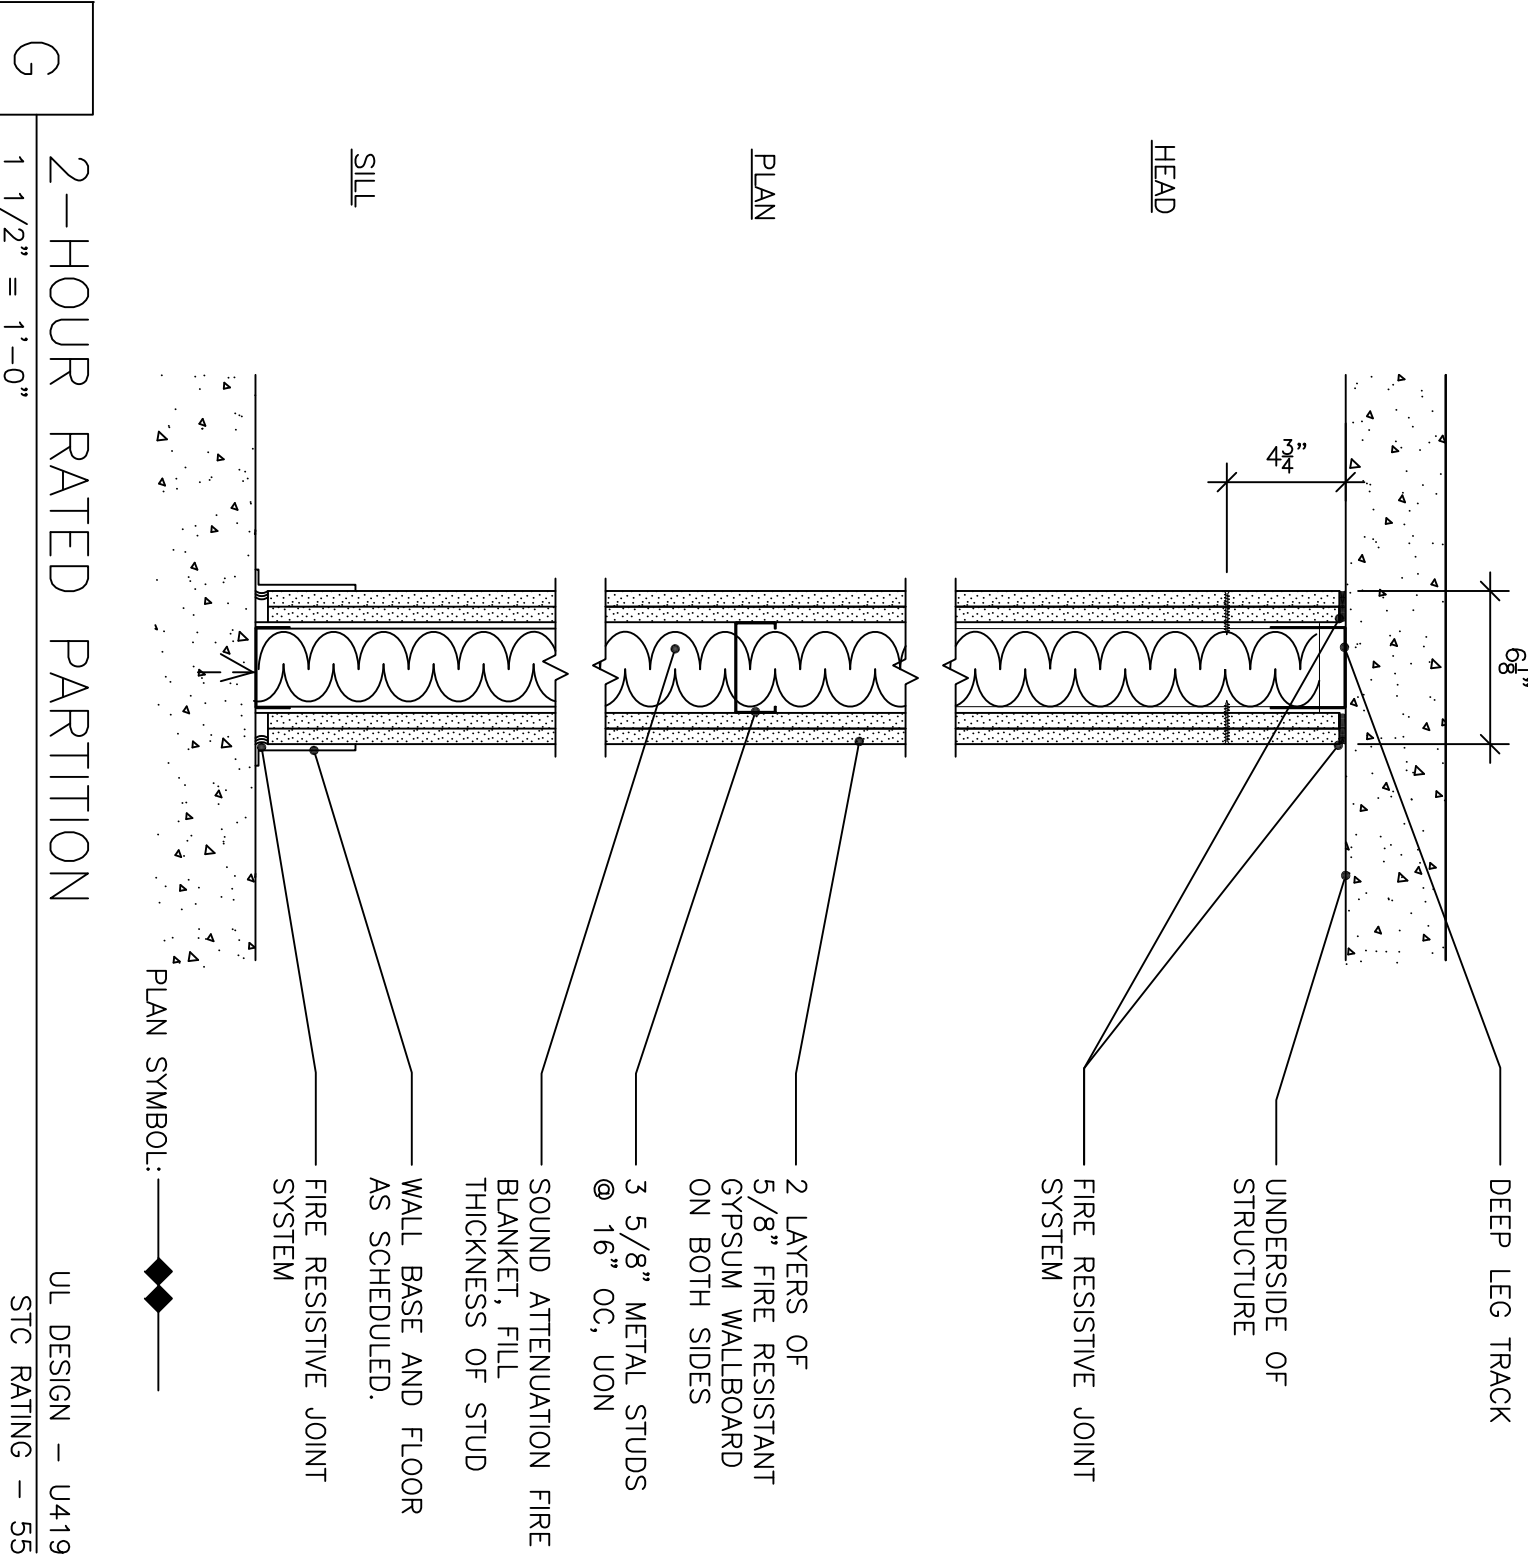

2-HOUR RATED PARTITION
1 1/2" = 1'-0"

CONSULTANTS:

ARCHITECT/ENGINEERS:

Drawing Title
2ND FLOOR INTERSTITIAL NEW WORK

Project Title
DISPATCH RENOVATION


FULLY SPRINKLERED

Project Number
590-18-102

Building Number
108

Dwg 5 of 6



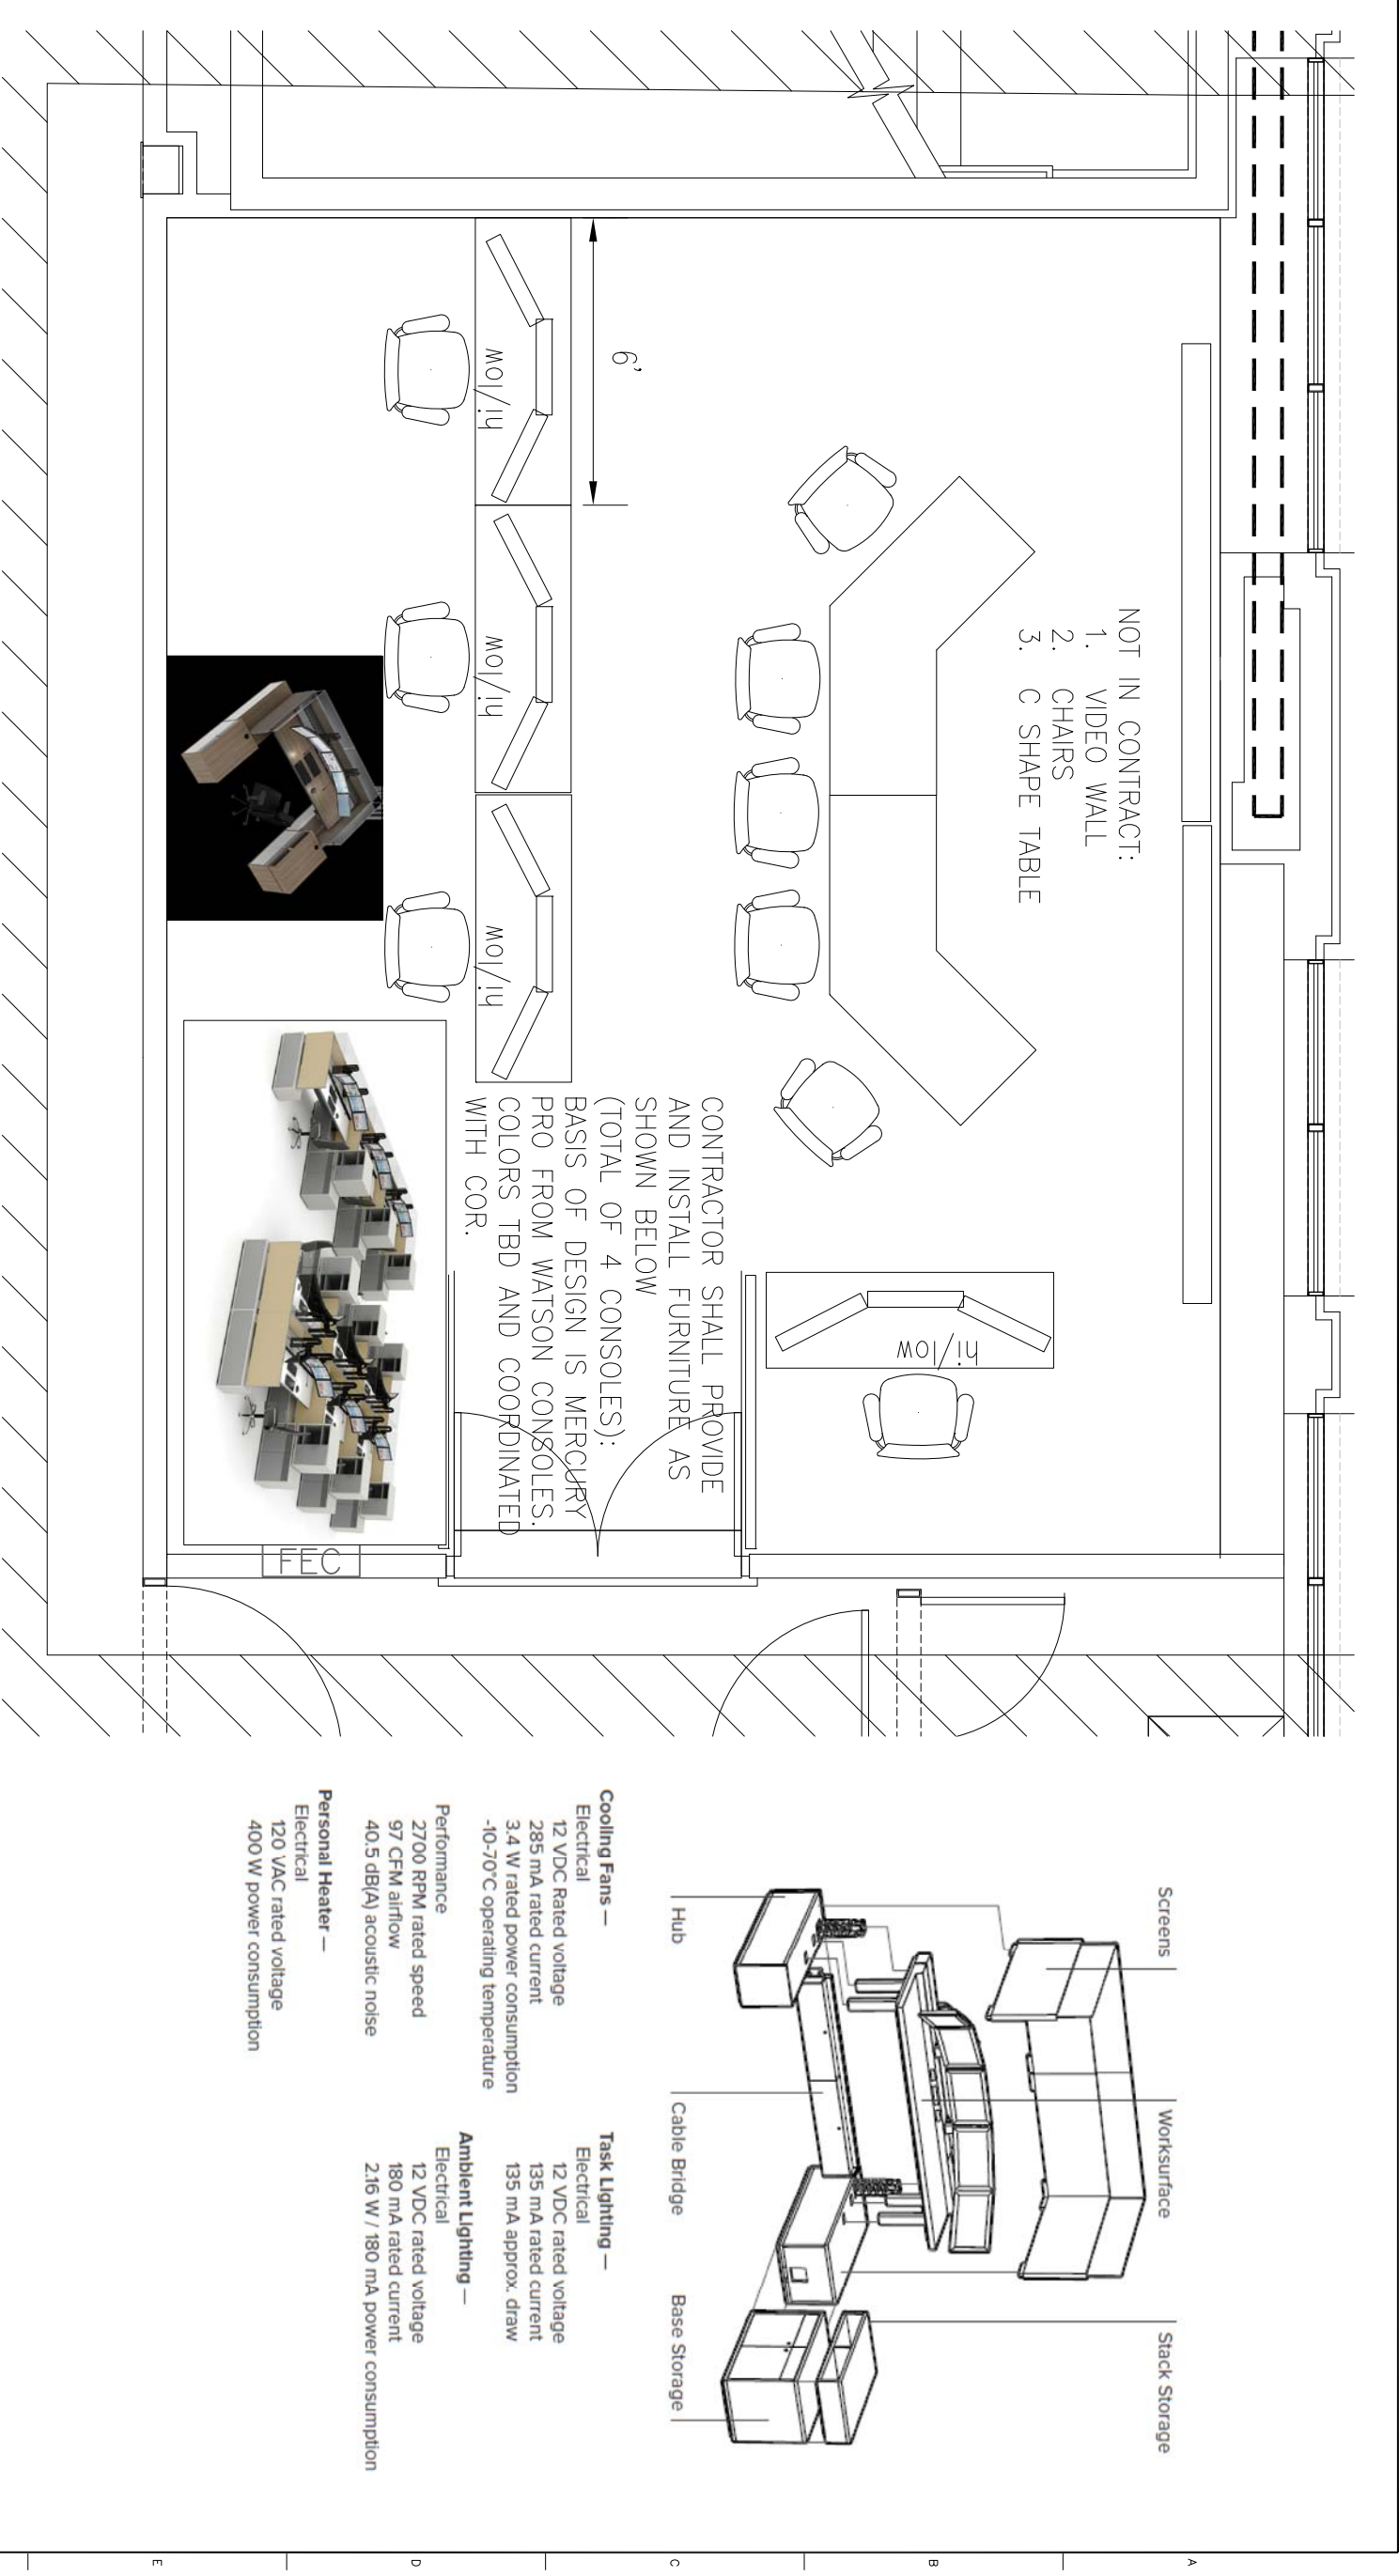

FURNITURE LAYOUT
 NTS

CONSULTANTS:

ARCHITECT/ENGINEERS:

FULLY SPRINKLERED

Project No.	DISPATCH RENOVATION	Project No.	590-B-102
Location	VA MEDICAL CENTER HANPTON VA	Sheet No.	108
Checked		Drawing Number	
Drawn		Scale	As Shown
Date		Sheet	8 of 8
Approved Project Director		Project Title	FURNITURE WORK
Project Title	FURNITURE WORK	Project No.	DISPATCH RENOVATION
Location	VA MEDICAL CENTER HANPTON VA	Sheet No.	108
Checked		Drawing Number	
Drawn		Scale	As Shown
Date		Sheet	8 of 8
Approved Project Director		Project Title	FURNITURE WORK
Project Title	FURNITURE WORK	Project No.	DISPATCH RENOVATION
Location	VA MEDICAL CENTER HANPTON VA	Sheet No.	108
Checked		Drawing Number	
Drawn		Scale	As Shown
Date		Sheet	8 of 8

