


NOTES:

SHEET NOTES:

- A. SEE SHEET G-011 FOR GENERAL ABBREVIATIONS AND ARCHITECTURAL SYMBOLS.
- B. REFER TO SHEETS H-LS SERIES FOR LIFE SAFETY PLANS
- C. ALL INTERIOR PARTITIONS ARE TYPE 27 U.O.N. SEE SHEET H-AE5.600 SERIES FOR PARTITION TYPES
- D. REFER TO EQUIPMENT PLAN SHEETS H-QH4.000 SERIES FOR ADDITIONAL DIMENSIONS AND INFORMATION.
- E. REFER TO SHEET H-QH6.101 FOR NON-MEDICAL EQUIPMENT LIST. REFER TO H-QH6.102 FOR TYPICAL MOUNTING HEIGHTS AND TOILET INFORMATION
- F. REFER TO SHEET H-AE5.000 SERIES FOR DOOR, FRAME AND BORROWED LITE SCHEDULES AND DETAILS
- G. DIMENSIONS ARE TO COLUMN GRID, FACE OF MASONRY OR CONCRETE OR FACE OF METAL STUD U.O.N. DIMENSIONS NOTED AS "CLEAR" ARE FINISH FACE TO FINISH FACE INCLUDING ALL FINISHES SUCH AS TILE, WALL PANELS, ETC.
- H. SEE H-AE6.4 SERIES FOR WINDOW AND LOUVER TYPES.
- I. REFER TO PLUMBING PANS, H-MP1 SERIES, FOR FLOOR DRAIN LOCATIONS
- J. REFER TO SHEET H-AE5.210 FOR TYPICAL EXPANSION JOINT DETAILS.
- K. REFER TO SHEET H-AE5.201 THRU H-AE5.302 FOR TYPICAL PLAN DETAILS.
- L. SEE SHEETS H-AE4.301 FOR ENLARGED PLANS - TYPICAL ROOMS.
- M. REFER TO 1/16" AREA PLANS FOR INTERSTITIAL SPACE PLANS AND LEVEL 6 OVERALL ROOF PLANS.

KEY NOTE LEGEND

- 1 PNEUMATIC TUBE STATION, SEE VERTICAL CIRCULATION SERIES DRAWINGS
- 2 DUMBWAITER, SEE VERTICAL CIRCULATION SERIES DRAWINGS
- 3 SLAB DEPRESSION, SEE STRUCTURAL & FOOD SERVICE DRAWINGS
- 4 1.58mm LEAD THICKNESS; SEE SHIELDING RECOMMENDATIONS REPORT, DIVISION 13 49 00
- 8 PARTITION TYPE 27 WITH WALL PANEL CLADDING, SEE SHEET H-A3.305
- 9 DOOR NUMBER REFERS TO COILING COUNTER DOOR
- 10 INTERIOR FLOOR DRAIN, TYPICAL. SEE PLUMBING DRAWINGS.
- 11 INTERIOR FLOOR SINK, TYPICAL. SEE PLUMBING DRAWINGS.
- 12 EXPANSION JOINT
- 13 MODULAR CASEWORK SHOWN FOR REFERENCE ONLY, REFER TO H-QH4 SERIES FOR MANUFACTURER INFORMATION.
- 14 PROVIDE 0.5MM LEAD & EQUIVALENCY AT CONTROL STATION & WINDOW B5D
- 15 FLUSH MOUNTED FLOOR RACEWAY WITH WATERTIGHT, REMOVABLE, RIGID COVER PLATE. SEE STRUCTURAL FOR TRENCH DIMENSIONS & 4/H-AE5.402 FOR COVER ASSEMBLY. FINAL COORDINATION OF THE TRENCH AND COVER TO BE COORDINATED WITH THE SELECTED MANUFACTURER
- 16 WING WALL, REFER TO ELEVATIONS FOR WALL PROFILE AND HEIGHT

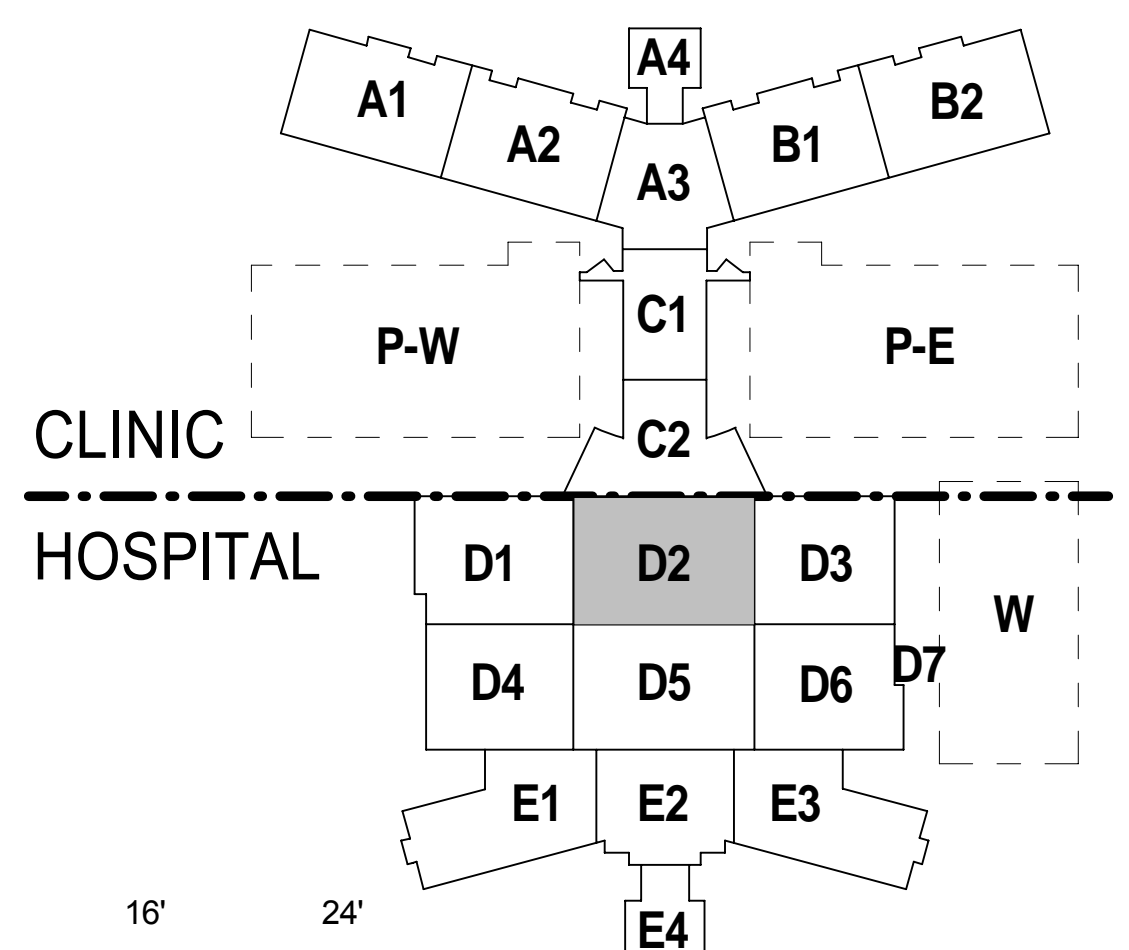

0 4' 8' 16' 24'

1/8" = 1'-0" GRAPHIC SCALE


KEY PLAN
AREA D, ZONE 2

BUILDING IS FULLY SPRINKLERED

No.	Description	Date
8	CPR 220	02/06/2012
9	CPR 236	03/09/2012
10	CPR 337	09/20/2012
11	CPR 340	09/27/2012
12	CPR 370	01/11/2013
13	CPR 380	03/01/2013
14	CPR 381	03/29/2013
15	CPR 420	06/30/2014

CONSULTANTS:

Professional Seals:

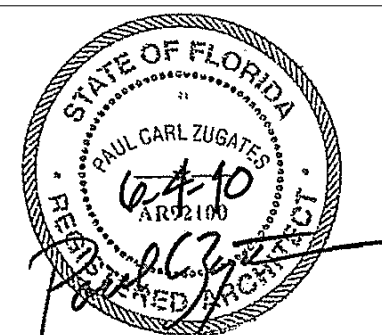

ARCHITECT/ENGINEERS:

RLF

A JOINT VENTURE

ELLERBE BECKET

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Drawing Title
HOSPITAL / CLINIC
LEVEL 1, AREA D, ZONE 3
BID ALTERNATE NO. 3

Approved: Project Director

Melan Arski

Project Title
A NEW HOSPITAL FOR
VAMC ORLANDO, FLORIDA

Location
Orlando, Florida

Date

04 JUNE, 2010

Checked

Checker

Drawn

EB / RLF

Project Number
673-950

Building Number
01 AND 02

Drawing Number
H-AE1.1FD2-A

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MANAGEMENT