



three inches = one foot
one and one half inches = one foot
one inch = one foot
three quarters inch = one foot
one half inch = one foot
three eighths inch = one foot
one quarter inch = one foot
one eighth inch = one foot
one sixteenth inch = one foot

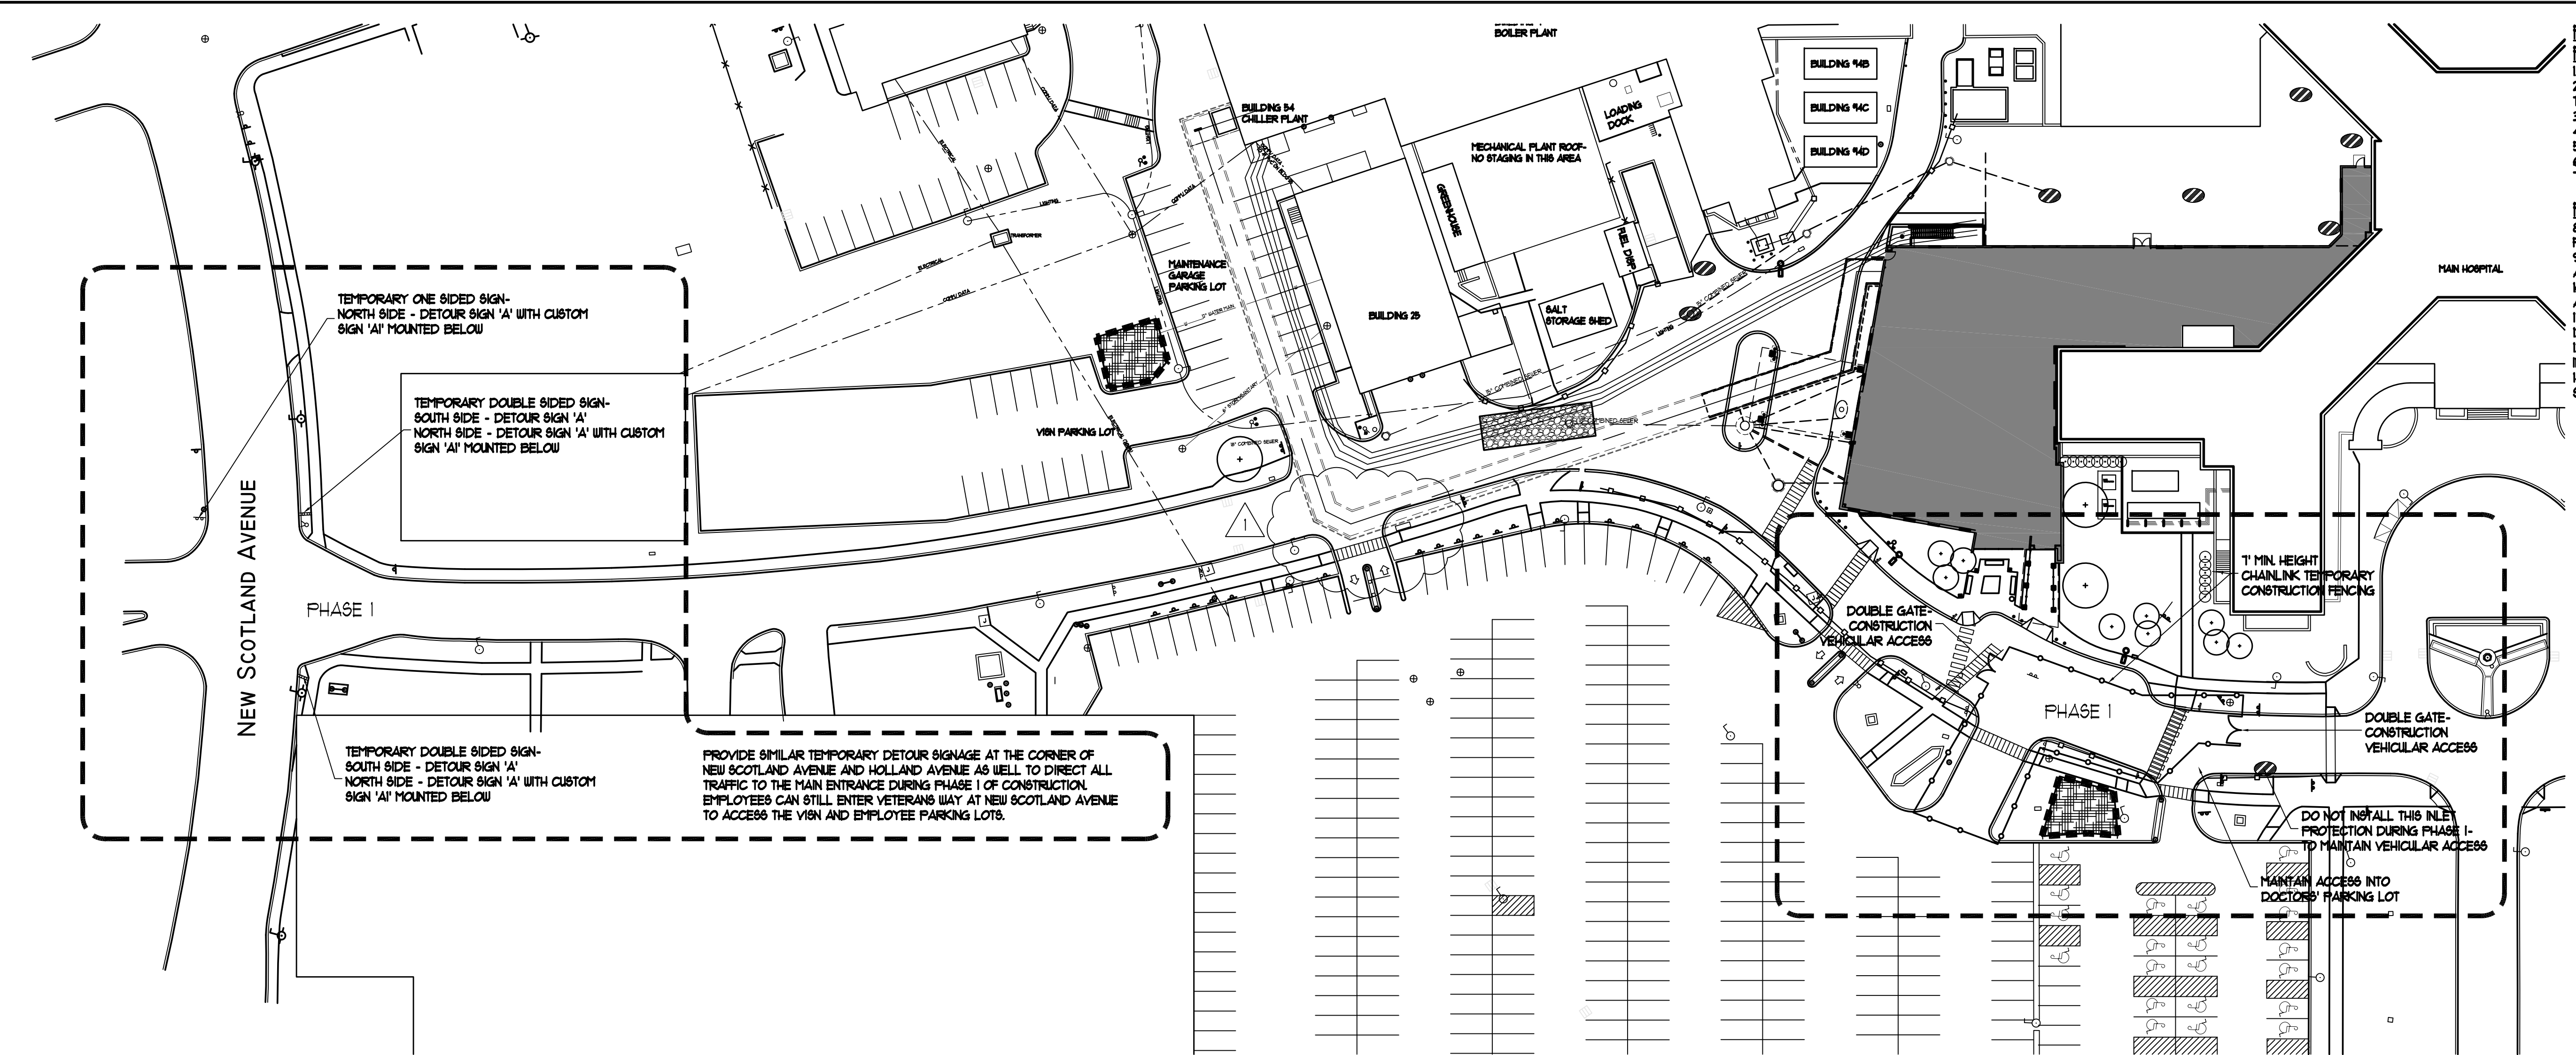


- PHASE 1**
PHASE 1A:
1. INSTALL PORTABLE TOILETS
2. IMPLEMENT SPILL PREVENTION AND CONTROL PROCEDURES INCLUDING TEMPORARY DETOURING TRAPS
3. INSTALL TEMPORARY GRAVEL CONSTRUCTION ENTRANCE/EXIT
4. INSTALL SILT FENCE AND HAYBALES WHERE INDICATED
5. INSTALL INLET PROTECTION DEVICES WHERE INDICATED
6. INSTALL TREE PROTECTION FENCING WHERE INDICATED
7. PREPARE STOCKPILING AREA AND CONSTRUCTION TRAILER AREA
- PHASE 1B: TO BE COMPLETED IN THREE (3) DAYS**
8. INSTALL PORTION OF TEMPORARY T HIGH CONSTRUCTION CHAINLINK FENCING AROUND AREA AS INDICATED AND AS APPROVED BY COTR
9. INSTALL TEMPORARY TRAFFIC SIGNAGE AS INDICATED AND AS APPROVED BY COTR REFER TO ALL TRAFFIC NOTES ON THIS PLAN
10. SAUCUT AND REMOVE EXISTING ASPHALT PAVEMENT COMPLETE IN AREA OF EMPLOYEE PARKING LOT ENTRANCE/EXIT AS INDICATED
11. ALL EXISTING CONCRETE CURBS TO REMAIN DURING THIS PHASE
12. PROVIDE ANY NECESSARY CONDUITS FOR UTILITY WORK
13. REGRADE AS REQUIRED TO MEET FINAL FINISHED GRADING AS INDICATED ON THE GRADING AND DRAINAGE PLAN
14. REPLACE ASPHALT PAVEMENTS (PREPARE SUBGRADE, INSTALL SUBBASE, INSTALL BINDER COURSE, INSTALL TOP COURSE)

- CONSTRUCTION PHASING:**
1. WORK INCLUDED IN THE PHASE DESCRIPTIONS SHALL BE IN ACCORDANCE WITH THE PLANS AND SPECIFICATIONS BUT SHALL NOT BE NECESSARILY LIMITED TO THE ITEMS LISTED.
2. ALL SITE WORK TO BE COORDINATED WITH ASSOCIATED SITE UTILITY AND STRUCTURAL WORK AS OUTLINED IN THE DRAWINGS AND SPECIFICATIONS.
3. ALL WORK TO BE PERFORMED IN ACCORDANCE WITH OSHA REQUIREMENTS.
4. ALL AREAS MUST BE RESTORED TO ORIGINAL CONDITIONS UPON APPROVED COMPLETION OF THE PROJECT.

1 SITE PHASING AND TRAFFIC REQUIREMENTS PLAN - PHASE 1
L16 SCALE: 1"=40'-0"

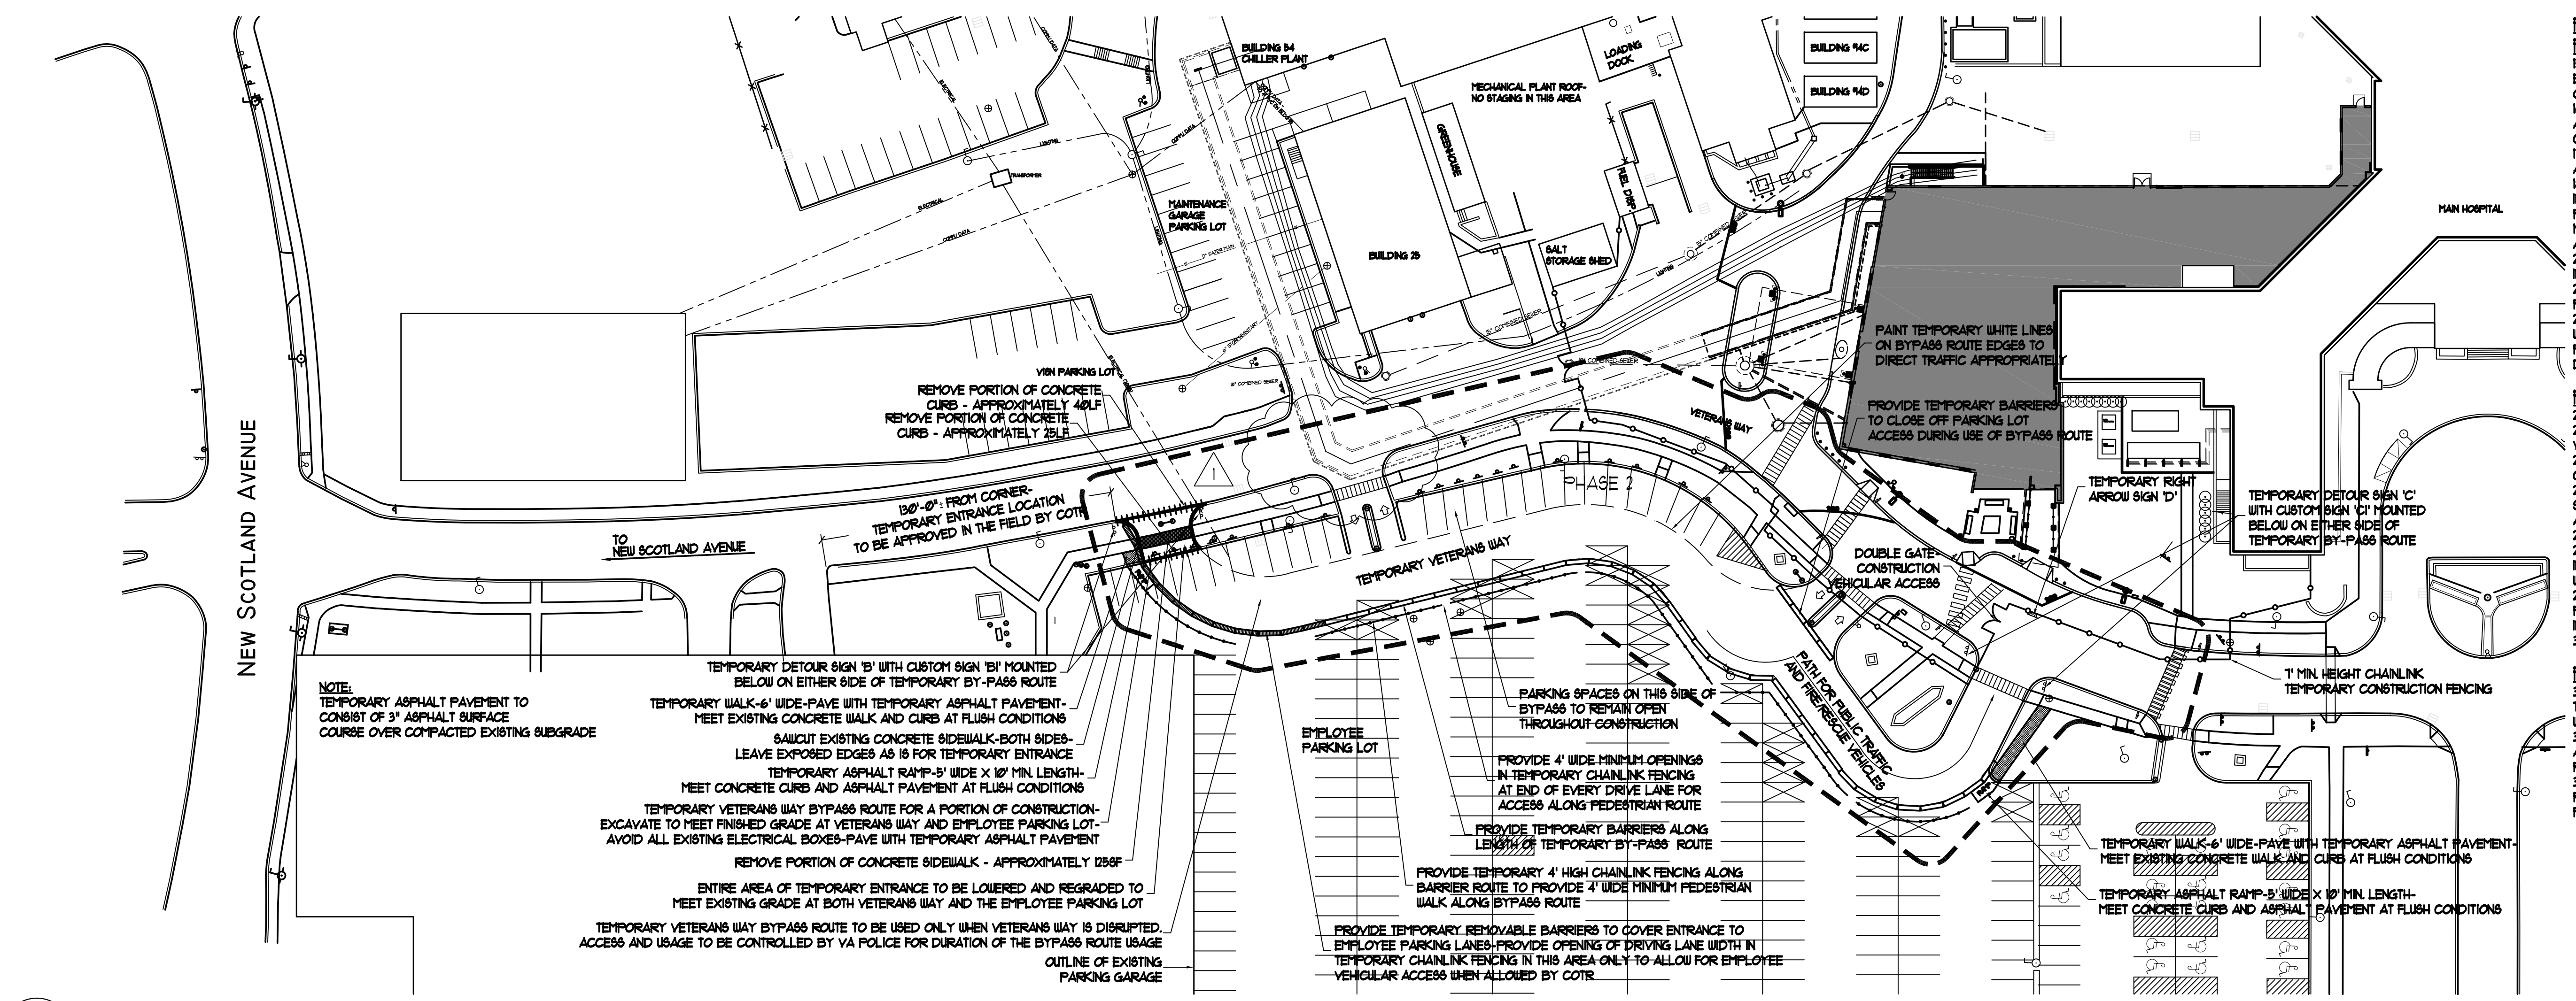

- PHASE 2**
PHASE 2A:
15. CREATE TEMPORARY BYPASS ROUTE OF VETERANS WAY THROUGH EMPLOYEES PARKING LOT AS INDICATED REFER TO ALL TRAFFIC NOTES ON THIS PLAN
16. INSTALL TEMPORARY T HIGH CONSTRUCTION CHAINLINK FENCING AROUND CONSTRUCTION ZONE AS INDICATED AND AS APPROVED BY COTR
17. INSTALL TEMPORARY TRAFFIC SIGNAGE AS INDICATED AND AS APPROVED BY COTR
18. REMOVE CONCRETE CURBS, CONCRETE PAVEMENTS AND FILL AS INDICATED TO ALLOW FOR TEMPORARY ENTRANCE TO THE EMPLOYEE PARKING LOT TO ALLOW FOR VETERANS WAY BYPASS ROUTE
19. PROVIDE TEMPORARY CURBS AND REPAVE AREA WITH TEMPORARY ASPHALT PAVEMENT
20. INSTALL TEMPORARY 4' HIGH CONSTRUCTION CHAINLINK FENCING TO PROVIDE PEDESTRIAN WALK ALONG BYPASS ROUTE
21. INSTALL TEMPORARY 18" LONG ASPHALT RUMPS AND 6" WIDE ASPHALT WALKS (3" ASPHALT TOP COURSE OVER COMPACTED SUBGRADE) FOR PEDESTRIAN WALK ALONG BYPASS ROUTE AS INDICATED ON THE DRAWINGS
- PHASE 2B:**
22. REMOVE EXISTING TREES AND SHRUBS COMPLETE AS INDICATED
23. SAUCUT AND REMOVE EXISTING ASPHALT PAVEMENT COMPLETE ALONG VETERANS WAY AS INDICATED
24. REMOVE EXISTING CONCRETE CURBS AND CONCRETE PAVEMENTS COMPLETE AS INDICATED
25. INSTALL NEW DRAINAGE MANHOLE (804-3) AND HYDRODYNAMIC SEPARATOR AND ASSOCIATED PIPING AS INDICATED ON THE GRADING AND DRAINAGE PLANS
26. PROVIDE ANY NECESSARY CONDUITS FOR UTILITY WORK
27. REGRADE AS REQUIRED TO MEET FINAL FINISHED GRADING AS INDICATED ON THE GRADING AND DRAINAGE PLAN ALONG VETERANS WAY
28. INSTALL CONCRETE CURBS, CONCRETE PAVEMENTS, AND ASPHALT PAVEMENTS (PREPARE SUBGRADE, INSTALL SUBBASE, CONCRETE CURBS, INSTALL BINDER COURSE, INSTALL TOP COURSE)
29. CONSTRUCT NEW BUILDING ADDITIONS FOUNDATIONS AND FOOTINGS
- PHASE 2C:**
30. REPOSITION T HIGH CONSTRUCTION CHAINLINK FENCING TO ALLOW FOR THE REOPENING OF VETERANS WAY FOR PUBLIC AND EMERGENCY TRAFFIC WHILE MAINTAINING A SAFE CONSTRUCTION ZONE. COORDINATE WITH COTR
31. REMOVE TEMPORARY BYPASS ROUTE OF VETERANS WAY INCLUDING ALL ASSOCIATED SIGNAGE, BARRIERS, FENCING, WALKS AND RUMPS WHEN APPROVED BY COTR
32. RESTORE TEMPORARY ENTRANCE TO BYPASS ROUTE WITH REPLACEMENT OF CONCRETE CURBS, CONCRETE WALKS, AND ASPHALT PAVEMENT TO RESTORE AREA TO ORIGINAL CONDITION

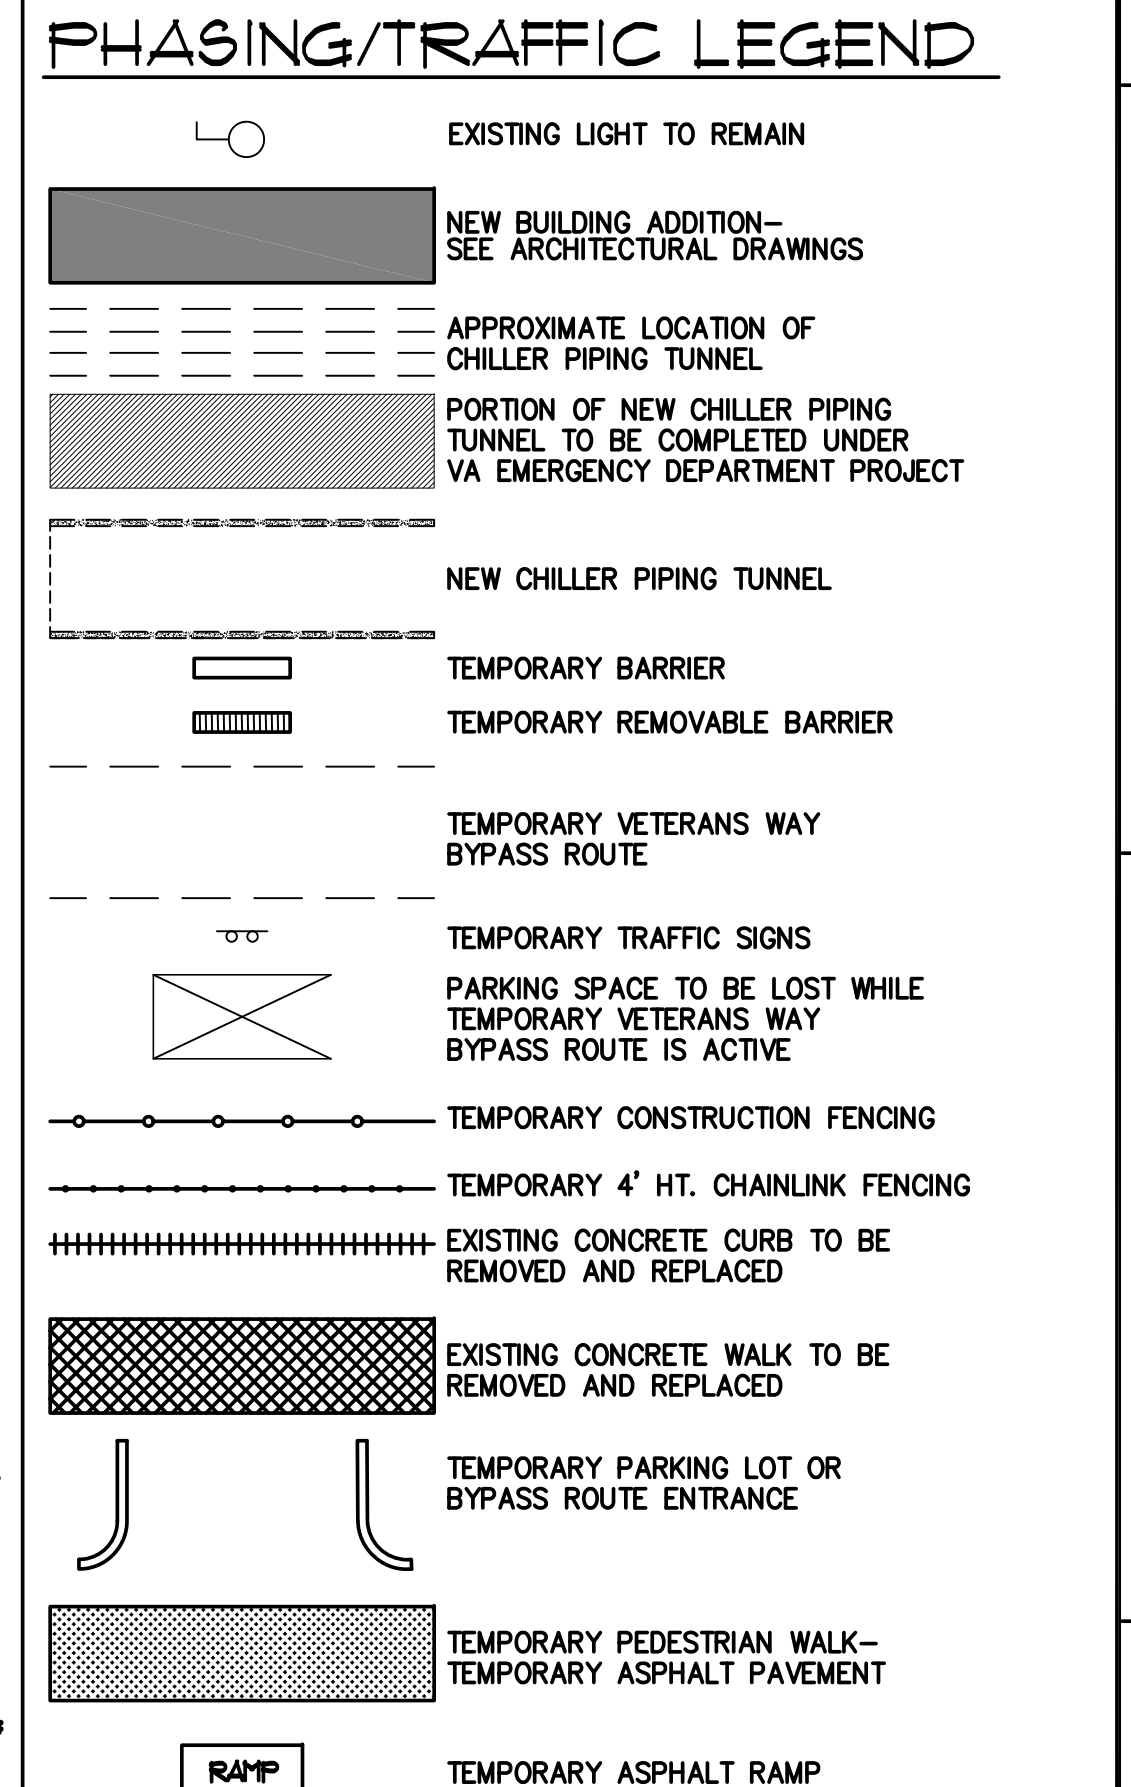

2 SITE PHASING AND TRAFFIC REQUIREMENTS PLAN - PHASE 2
L16 SCALE: 1"=40'-0"

FINAL DESIGN (100%)
FULLY SPRINKLERED

CONSULTANTS: Friedman Fishers Associates, P.C. 220 Livingston Road, Albany, New York 12205 TEL: (518) 458-7040 FAX: (518) 458-7048 mailto:info@friedmanfishers.com		 RYAN-BIGGS ASSOCIATES, P.C. 257 University Road, Albany, New York 12205 TEL: (518) 458-7040 FAX: (518) 458-7048 mailto:info@ryanbiggs.com		 OFFICE OF THE COMMISSIONER OF THE STATE OF NEW YORK		ARCHITECT/ENGINEERS: Hyman Haynes ASSOCIATES 6 WEMBLEY COURT, ALBANY, NEW YORK 12205 (518) 452-3470 HHA Proj. 10046		Drawing Title SITE PHASING AND TRAFFIC REQUIREMENTS PLAN-PHASES 1 AND 2		Project Title NEW EMERGENCY DEPARTMENT Stratton VA Medical Center		Project Number VA 528-809 Building Number 95		Office of Construction and Facilities Management 	
EBERLIN AND EBERLIN, P.C. 247 ROUTE 100 SUITE 1003 SOMERS NEW YORK 10589 CONSULTING ENGINEERS, PLANNERS, LANDSCAPE ARCHITECTS 914.332.8431 PHONE 914.332.8827 FAX								Approved Project Director		Location Albany, New York		Drawing Number L16 Dwg. 7 of 115			
ADDENDUM 1 Revisions: 1-24-12 Date										Date JUNE 13, 2012		Checked		Drawn	