



three inches = one foot  
one and one half inches = one foot  
one inch = one foot  
one half inch = one foot  
three quarters inch = one foot  
one half inch = one foot  
three eighths inch = one foot  
one quarter inch = one foot  
one eighth inch = one foot  
one eighth inch = one foot

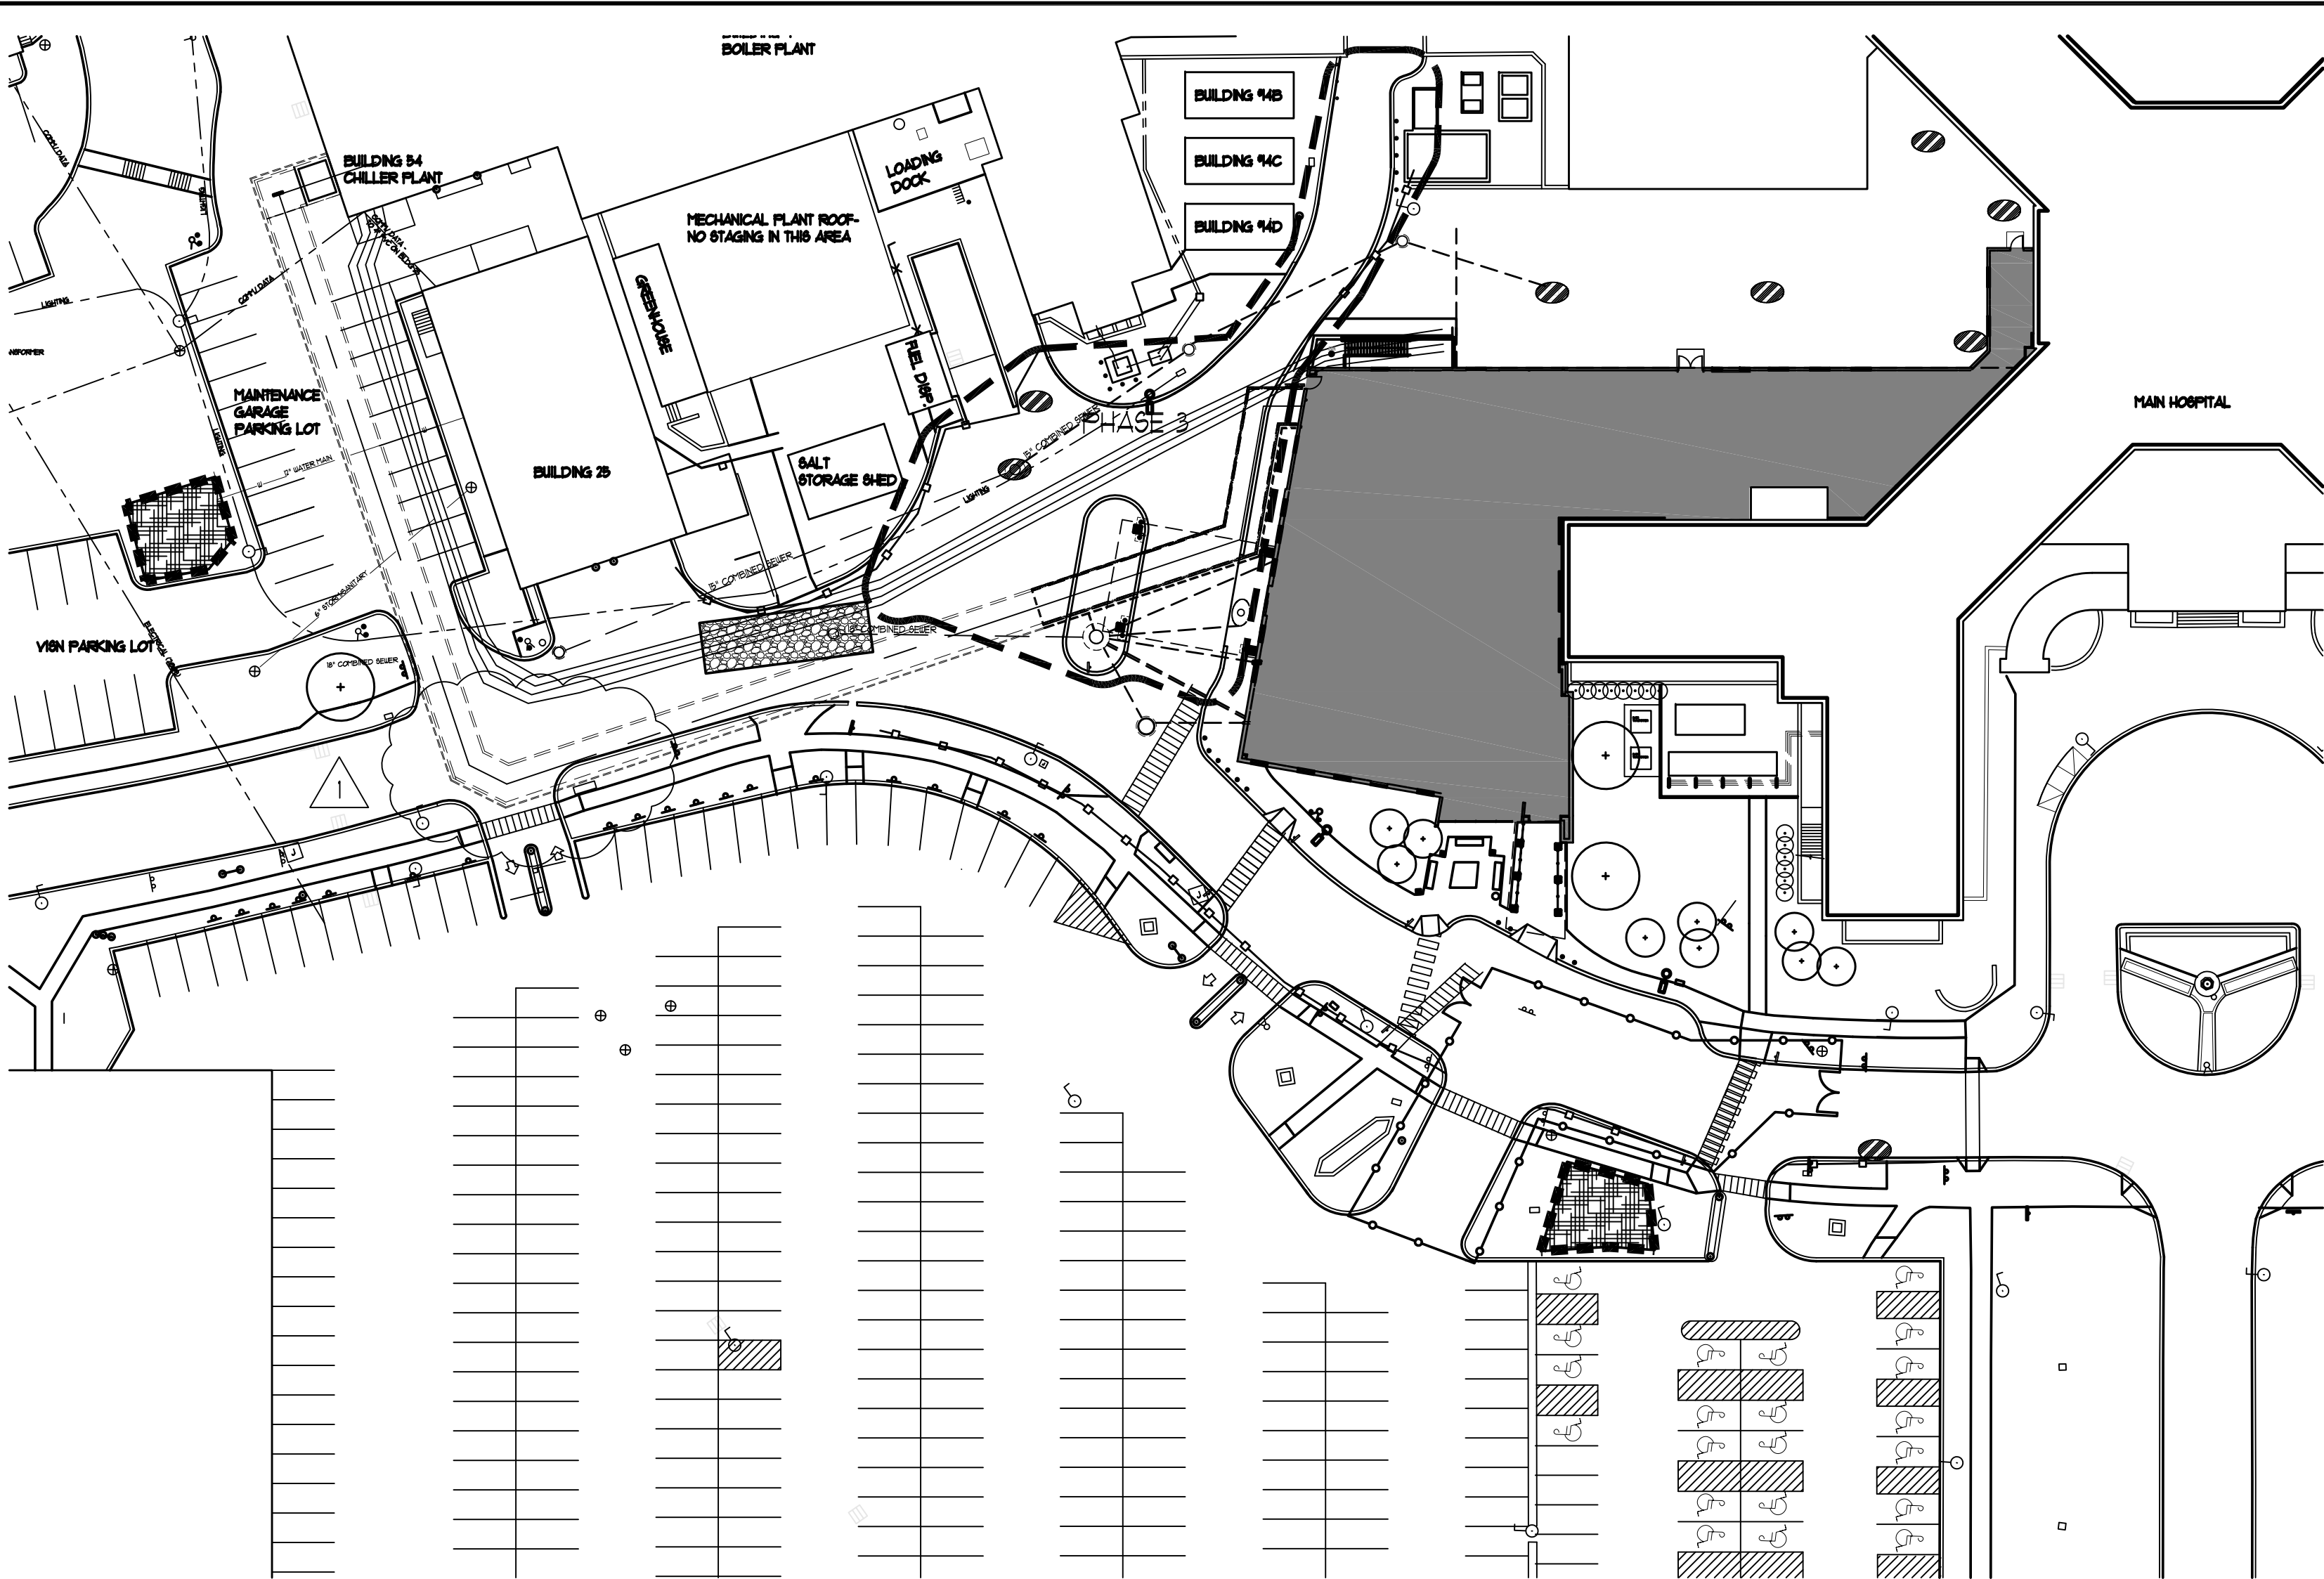


- PHASE 3**
34. REMOVE EXISTING TREES AND SHRUBS COMPLETE AS INDICATED
  35. SAUCUT AND REMOVE REMAINDER OF EXISTING ASPHALT PAVEMENT TO BE REMOVED COMPLETE AS INDICATED
  36. REMOVE REMAINDER OF EXISTING CONCRETE CURBS AND CONCRETE PAVEMENTS TO BE REMOVED COMPLETE AS INDICATED
  37. REMOVE FOR REUSE EXISTING FLAG
  38. REMOVE COMPLETE EXISTING FENCE AND WALL AS INDICATED
  39. INSTALL NEW DRAINAGE MANHOLE (8/14-12) AND HYDRODYNAMIC SEPARATOR AND ASSOCIATED PIPING AS INDICATED ON THE GRADING AND DRAINAGE PLANS
  40. PROVIDE NEW PIPE CONNECTIONS TO EXISTING MANHOLE STRUCTURE AS INDICATED
  41. CREATE TRENCH FOR NEW PIPING TUNNEL. PROVIDE SHEETING OR EXCAVATION PROTECTION AS REQUIRED TO PREVENT UNDERMINING
  42. INSTALL GRAVEL SUBBASE FOR NEW PIPING TUNNEL
  43. INSTALL SECTIONS OF NEW PIPING TUNNEL
  44. RELAY ANY LIGHTING/ELECTRICAL LINES ABOVE NEW PIPING TUNNEL AT 24" MINIMUM DEPTH AS REQUIRED
  45. PROVIDE ANY NECESSARY CONDUITS FOR UTILITY WORK
  46. BACKFILL ON TOP OF NEW PIPING TUNNEL AND PROVIDE REQUIRED COMPACTION
  47. REGRADE AS REQUIRED TO MEET FINAL FINISHED GRADING AS INDICATED ON THE GRADING AND DRAINAGE PLAN
  48. INSTALL CONCRETE CURBS, CURB RAMP, AND ASPHALT PAVEMENTS (PREPARE SUBGRADE, INSTALL SUBBASE, CONCRETE CURB, INSTALL BINDER COURSE, INSTALL TOP COURSE)
  49. PROVIDE ALL PAVEMENT MARKINGS AS INDICATED ON THE PLANS
  50. REPOSITION 1" HIGH CONSTRUCTION CHAINLINK FENCING TO ALLOW FOR ACCESS ALONG ALL ROADWAYS FOR ALL VEHICLES WHILE MAINTAINING A SAFE CONSTRUCTION ZONE. COORDINATE WITH COTR

1 SITE PHASING AND TRAFFIC REQUIREMENTS PLAN - PHASE 3  
L1.T SCALE: 1"=40'-0"

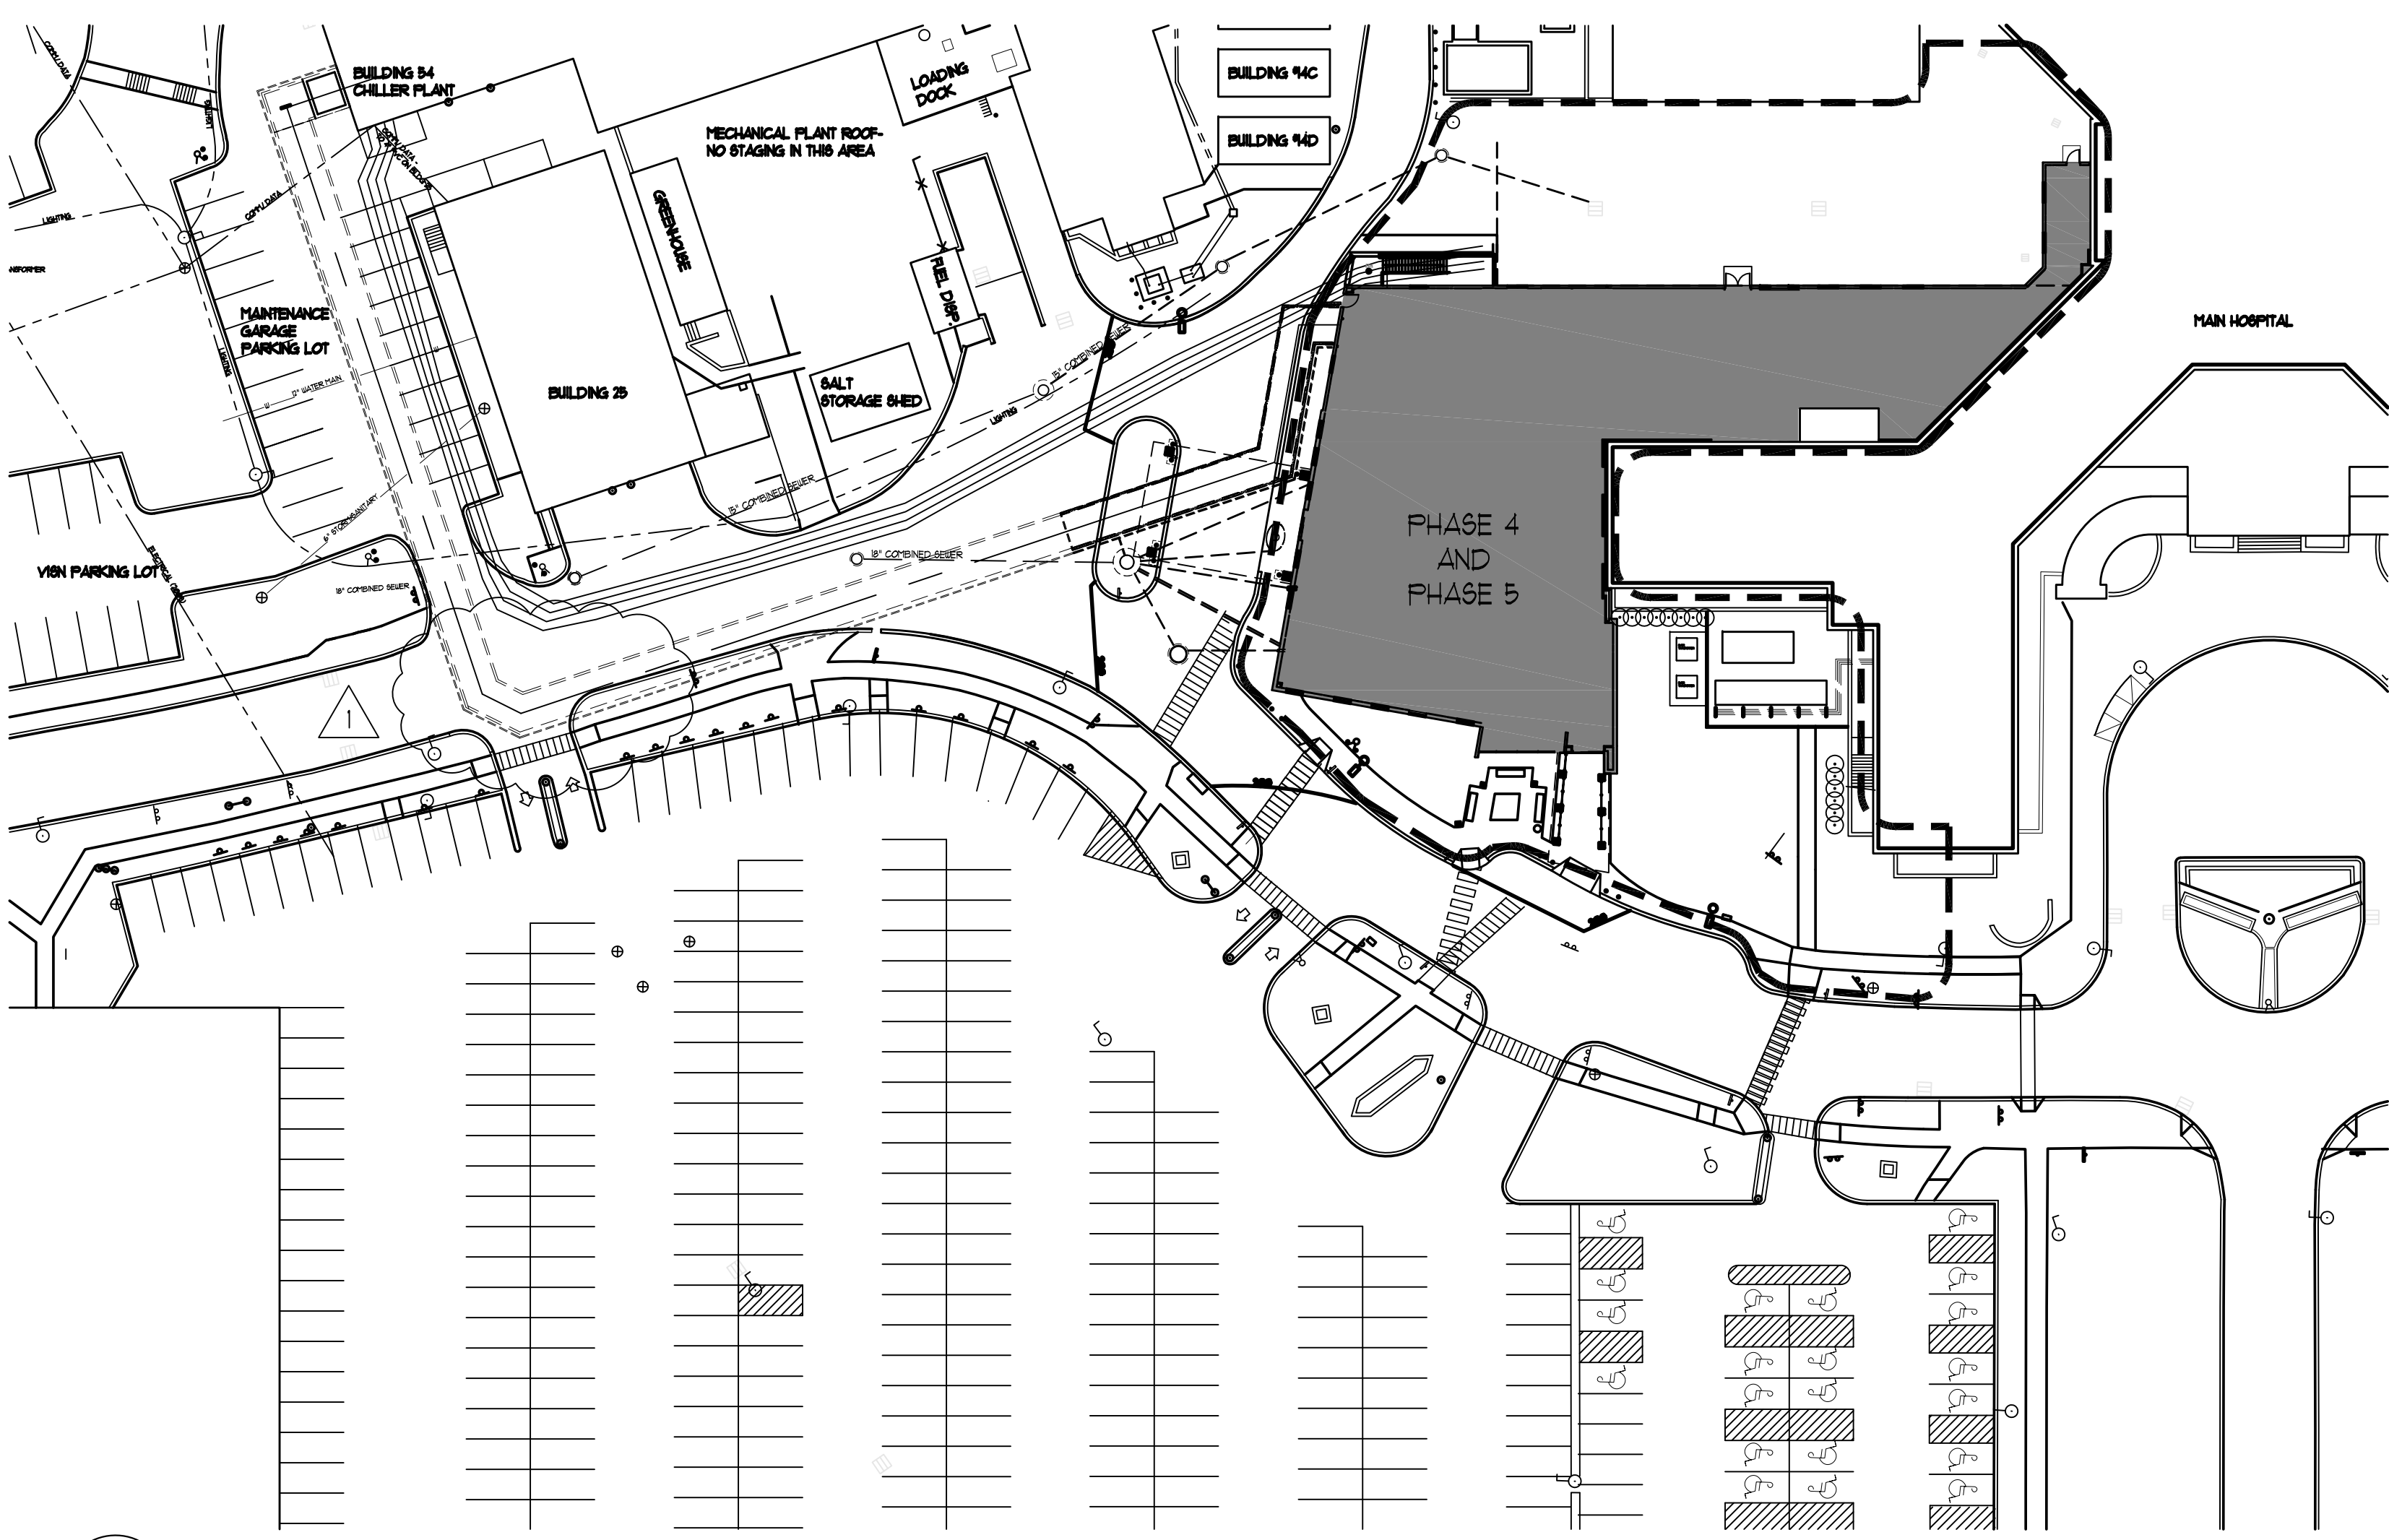

- PHASE 4**
51. COMPLETE ALL WORK ASSOCIATED WITH THE NEW BUILDING ADDITION
  52. INSTALL NEW LIGHTING FIXTURES AND FOOTINGS
  53. INSTALL NEW PROTECTIVE BOLLARDS AND FOOTINGS
  54. INSTALL CONCRETE PAVEMENTS AND ASPHALT ROOF PAVEMENTS (PREPARE SUBGRADE, INSTALL SUBBASE, INSTALL BINDER COURSE, INSTALL TOP COURSE)
  55. INSTALL NEW SITE FURNISHINGS INCLUDING BENCHES AND TRASH RECEPTACLE
  56. PREPARE PLANTING BEDS
- PHASE 5**
56. COMPLETE ALL LANDSCAPING. PLANT ALL TREES, SHRUBS, PERENNIALS, AND GROUNDCOVERS AS INDICATED ON THE PLANS
  57. APPLY TOPSOIL AND SEED AREA ALL DISTURBED AREAS

2 SITE PHASING AND TRAFFIC REQUIREMENTS PLAN - PHASE 4 AND 5  
L1.T SCALE: 1"=40'-0"

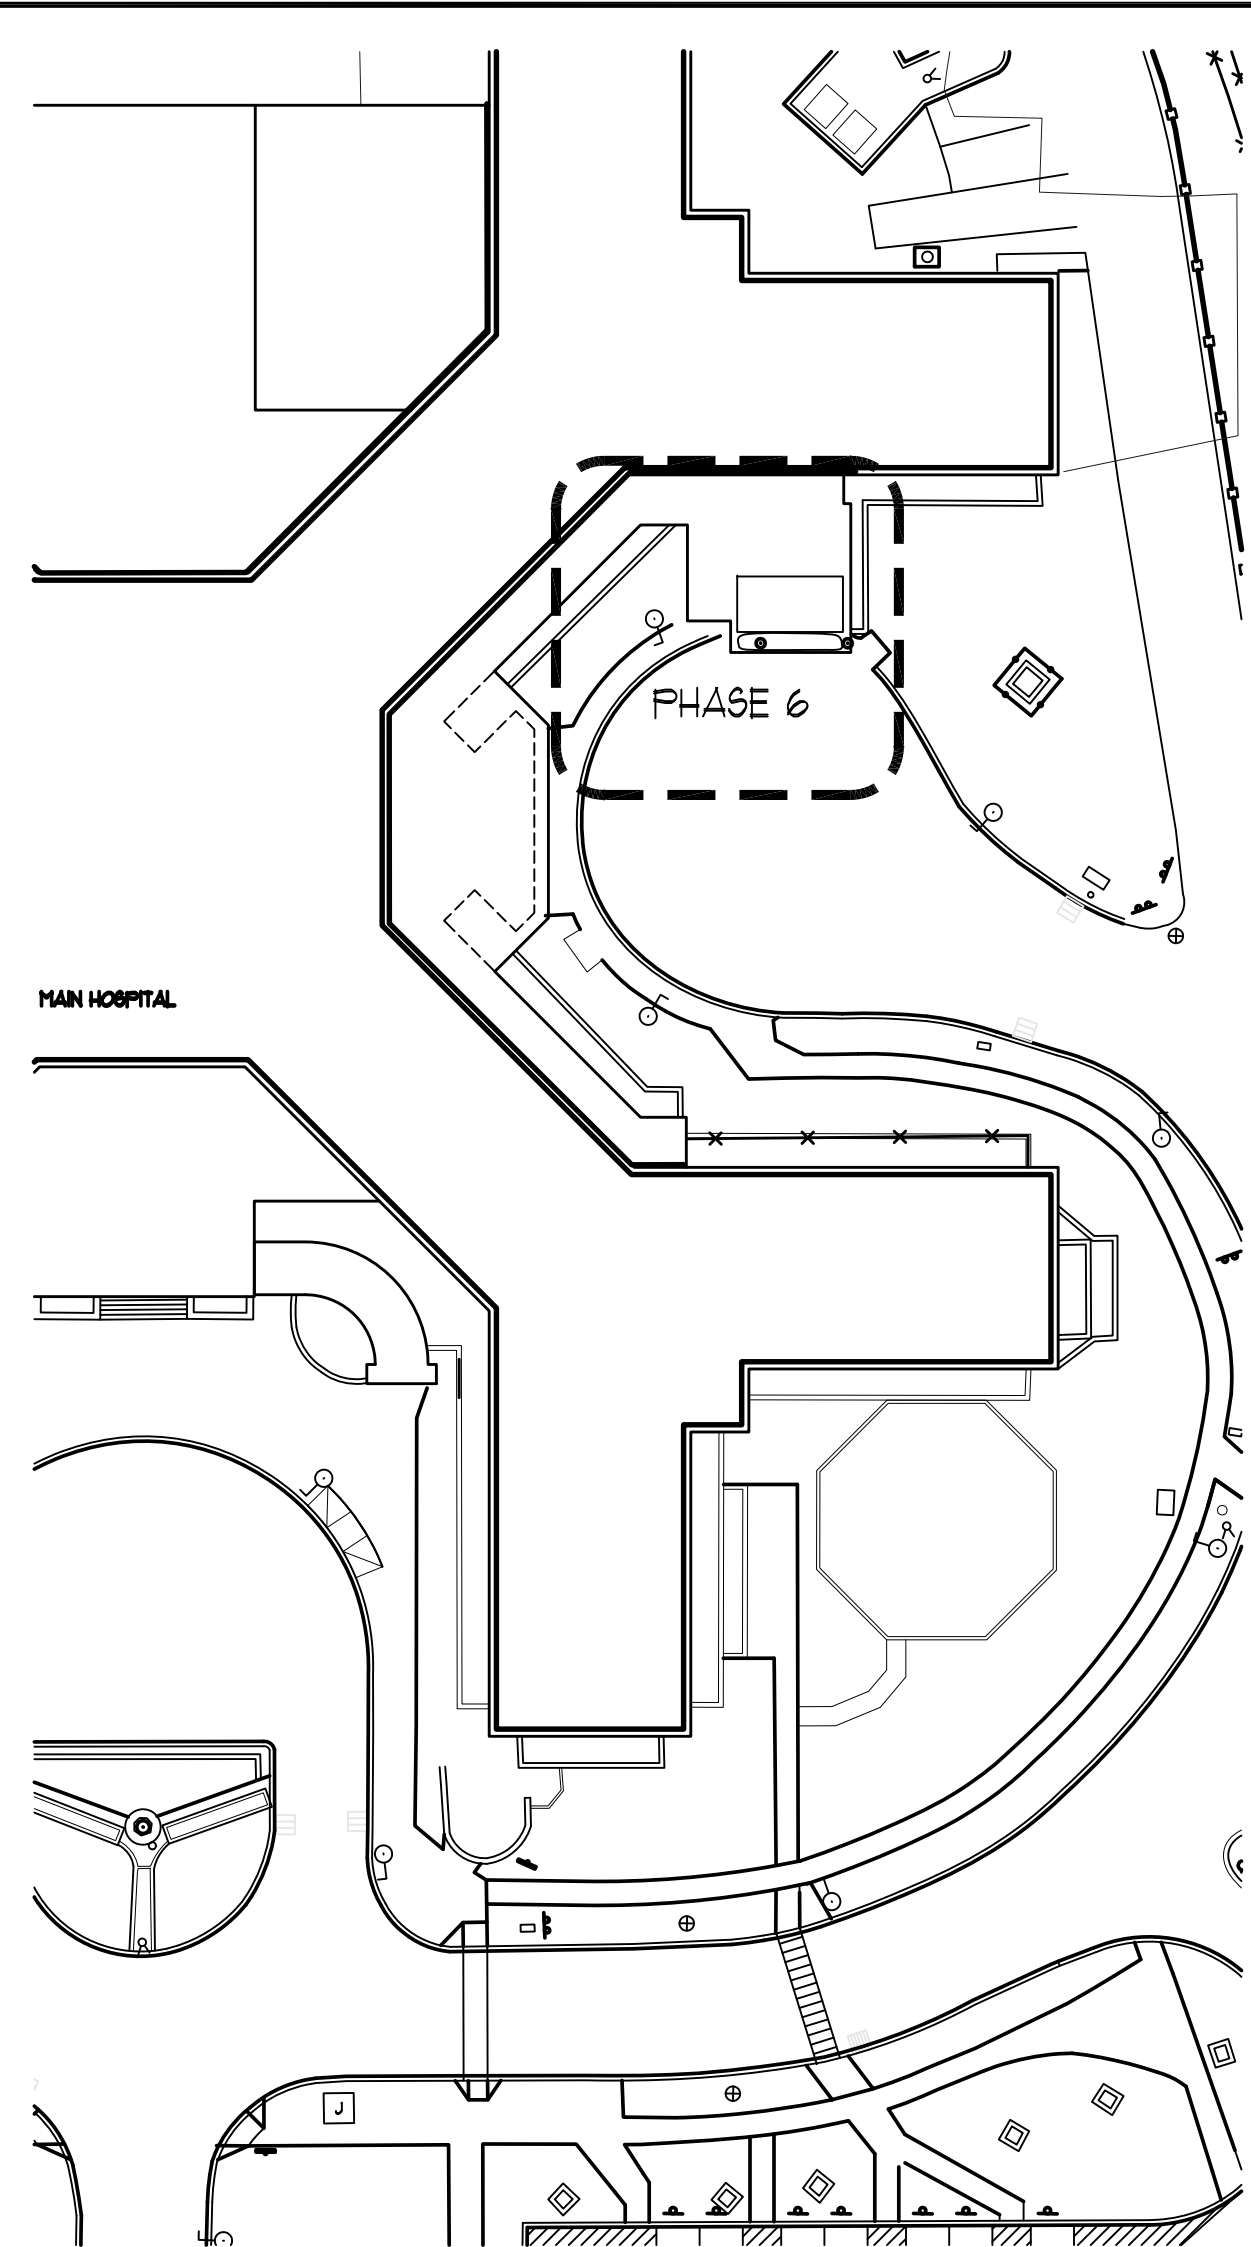


- PHASE 6**
58. IMPLEMENT SPILL PREVENTION AND CONTROL PROCEDURES IN THIS AREA AS REQUIRED
  59. INSTALL SILT FENCE AND HAYBALES IN THIS AREA AS REQUIRED
  60. INSTALL INLET PROTECTION DEVICES IN THIS AREA AS REQUIRED
  61. INSTALL TREE PROTECTION FENCING IN THIS AREA WHERE INDICATED
  62. PROVIDE ADJUSTMENTS TO EXISTING BUILDING TO ALLOW FOR RELOCATED SMOKING SHELTER
  63. INSTALL NEW GRAVEL
  64. PREPARE PLANTING BEDS AND PLANT NEW PERENNIALS
  65. APPLY TOPSOIL AND SEED AREA ALL DISTURBED AREAS
  66. REMOVE CONSTRUCTION TRAILER
  67. WHEN THE SITE IS FULLY STABILIZED REMOVE ALL EROSION CONTROL MEASURES

3 SITE PHASING AND TRAFFIC REQUIREMENTS PLAN - PHASE 6  
L1.T SCALE: 1"=40'-0"

PHASING/TRAFFIC LEGEND

- EXISTING LIGHT TO REMAIN
- NEW BUILDING ADDITION—SEE ARCHITECTURAL DRAWINGS
- APPROXIMATE LOCATION OF CHILLER PIPING TUNNEL
- PORTION OF NEW CHILLER PIPING TUNNEL TO BE COMPLETED UNDER VA EMERGENCY DEPARTMENT PROJECT
- NEW CHILLER PIPING TUNNEL
- TEMPORARY BARRIER
- TEMPORARY REMOVABLE BARRIER
- TEMPORARY VETERANS WAY BYPASS ROUTE
- TEMPORARY TRAFFIC SIGNS
- PARKING SPACE TO BE LOST WHILE TEMPORARY VETERANS WAY BYPASS ROUTE IS ACTIVE
- TEMPORARY CONSTRUCTION FENCING
- TEMPORARY 4' HT. CHAINLINK FENCING
- EXISTING CONCRETE CURB TO BE REMOVED AND REPLACED
- EXISTING CONCRETE WALK TO BE REMOVED AND REPLACED
- TEMPORARY PARKING LOT OR BYPASS ROUTE ENTRANCE
- TEMPORARY PEDESTRIAN WALK—TEMPORARY ASPHALT PAVEMENT
- TEMPORARY ASPHALT RAMP

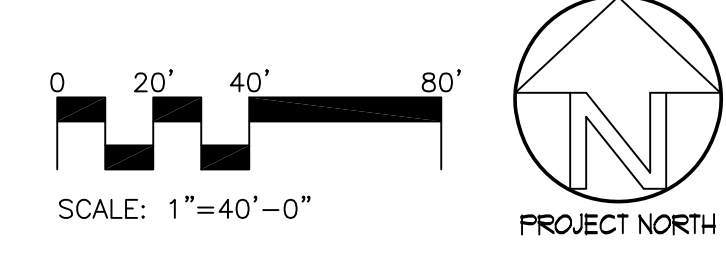

FINAL DESIGN (100%)  
FULLY SPRINKLERED

<b>CONSULTANTS:</b>  Quality Service Since 1964 FRIEDMAN FISHER ASSOCIATES, P.C. CONSULTING ENGINEERS, PLANNERS, LANDSCAPE ARCHITECTS 29 Stratton Road, Albany, New York 12208 TEL: (518) 458-7040 FAX: (518) 458-7043 mail@friedmanfisher.com		 RYAN-BIGGS ASSOCIATES, P.C. 257 University Road, Albany, New York 12208 TEL: (518) 458-7040 FAX: (518) 458-7043 mail@ryanbiggs.com		 OFFICE OF THE COMMISSIONER OF THE STATE OF NEW YORK DEPARTMENT OF VETERANS AFFAIRS		<b>ARCHITECT/ENGINEERS:</b>  Hyman Hayes ASSOCIATES 6 WEMBLEY COURT, ALBANY, NEW YORK 12205 (518) 452-3470 HHA Proj. 10046		<b>Drawing Title</b> SITE PHASING AND TRAFFIC REQUIREMENTS PLAN - PHASES 3, 4, 5, AND 6		<b>Project Title</b> NEW EMERGENCY DEPARTMENT Stratton VA Medical Center		<b>Project Number</b> VA 528-809 <b>Building Number</b> 95		<b>Office of Construction and Facilities Management</b> 	
<b>EBERLIN AND EBERLIN, P.C.</b> 247 ROUTE 100 SUITE 1003 SOMERS NEW YORK 10589 CONSULTING ENGINEERS, PLANNERS, LANDSCAPE ARCHITECTS 914.332.9431 PHONE 914.332.6857 FAX								<b>Approved Project Director</b>		<b>Location</b> Albany, New York		<b>Drawing Number</b> L1.7 Dwg. 8 of 115			
<b>Revisions:</b> 1-24-12 Date										<b>Date</b> JUNE 13, 2012		<b>Checked</b>		<b>Drawn</b>	