



three inches = one foot
one and one half inches = one foot
one inch = one foot
three quarters inch = one foot
one half inch = one foot
three eighths inch = one foot
one quarter inch = one foot
one eighth inch = one foot
one eighth inch = one foot

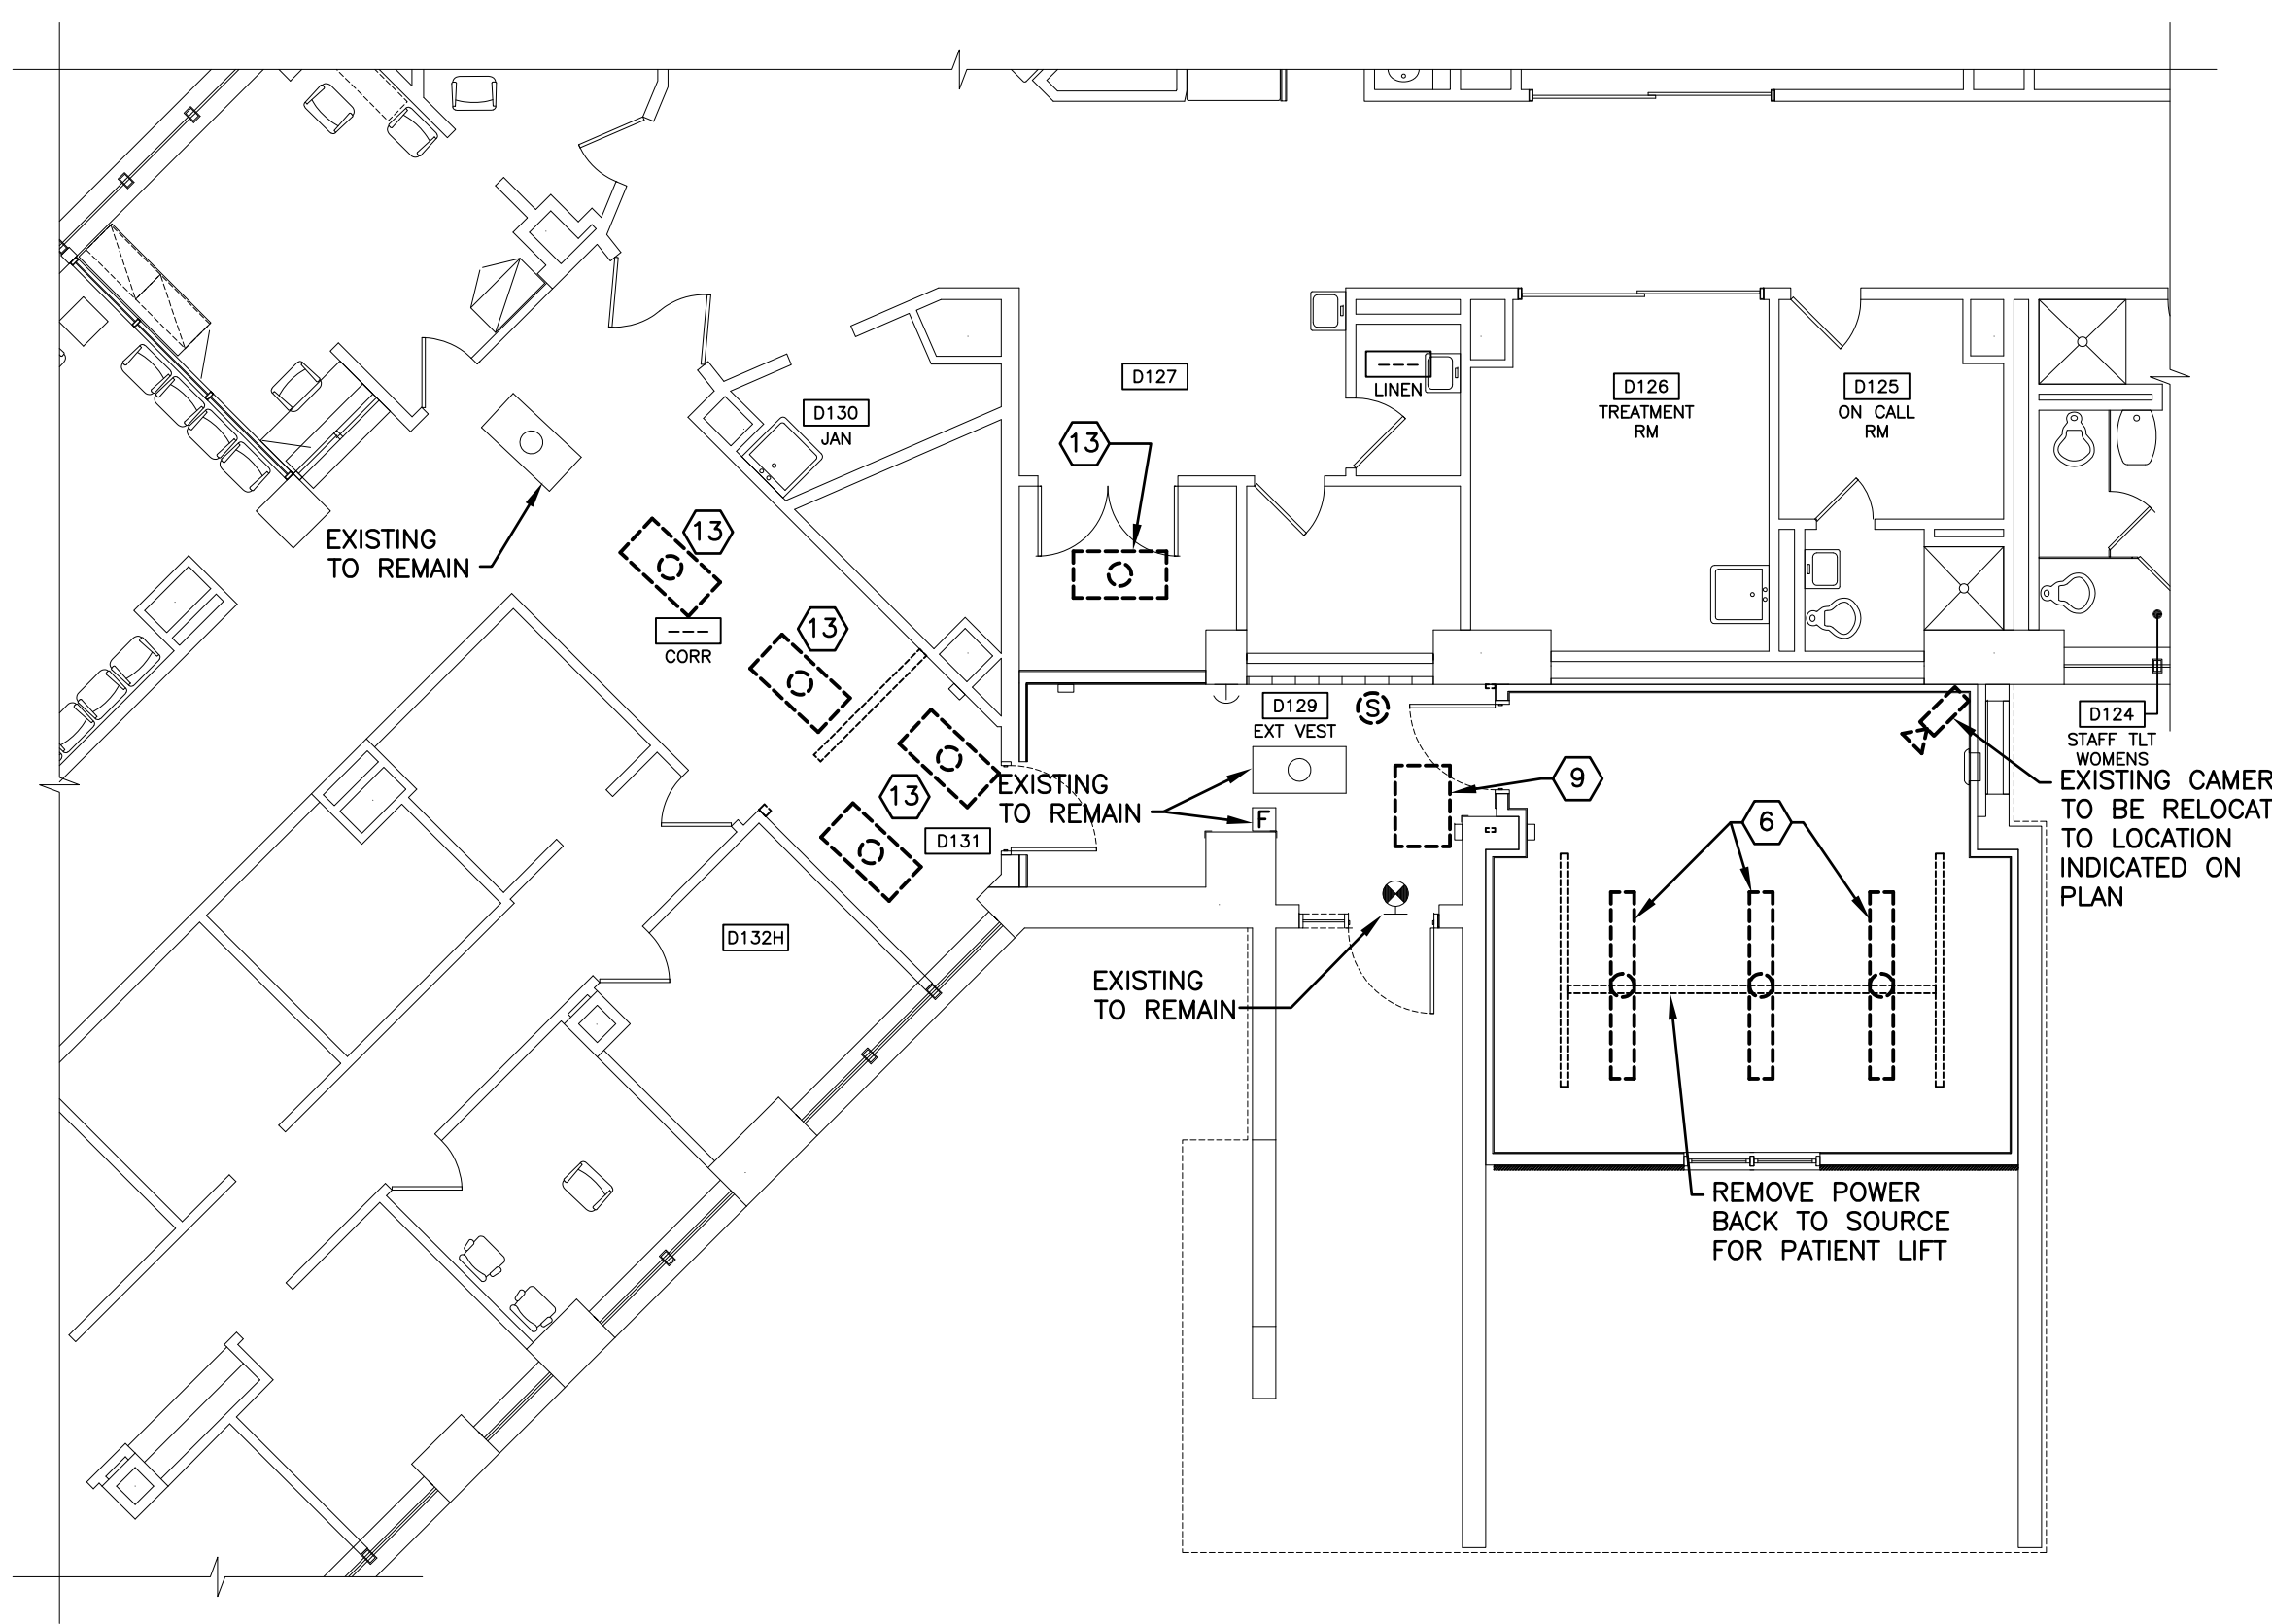


FIRST FLOOR SMOKING SHELTER-ELECTRICAL DEMO PLAN - WING D
SCALE: 1/8" = 1'-0"

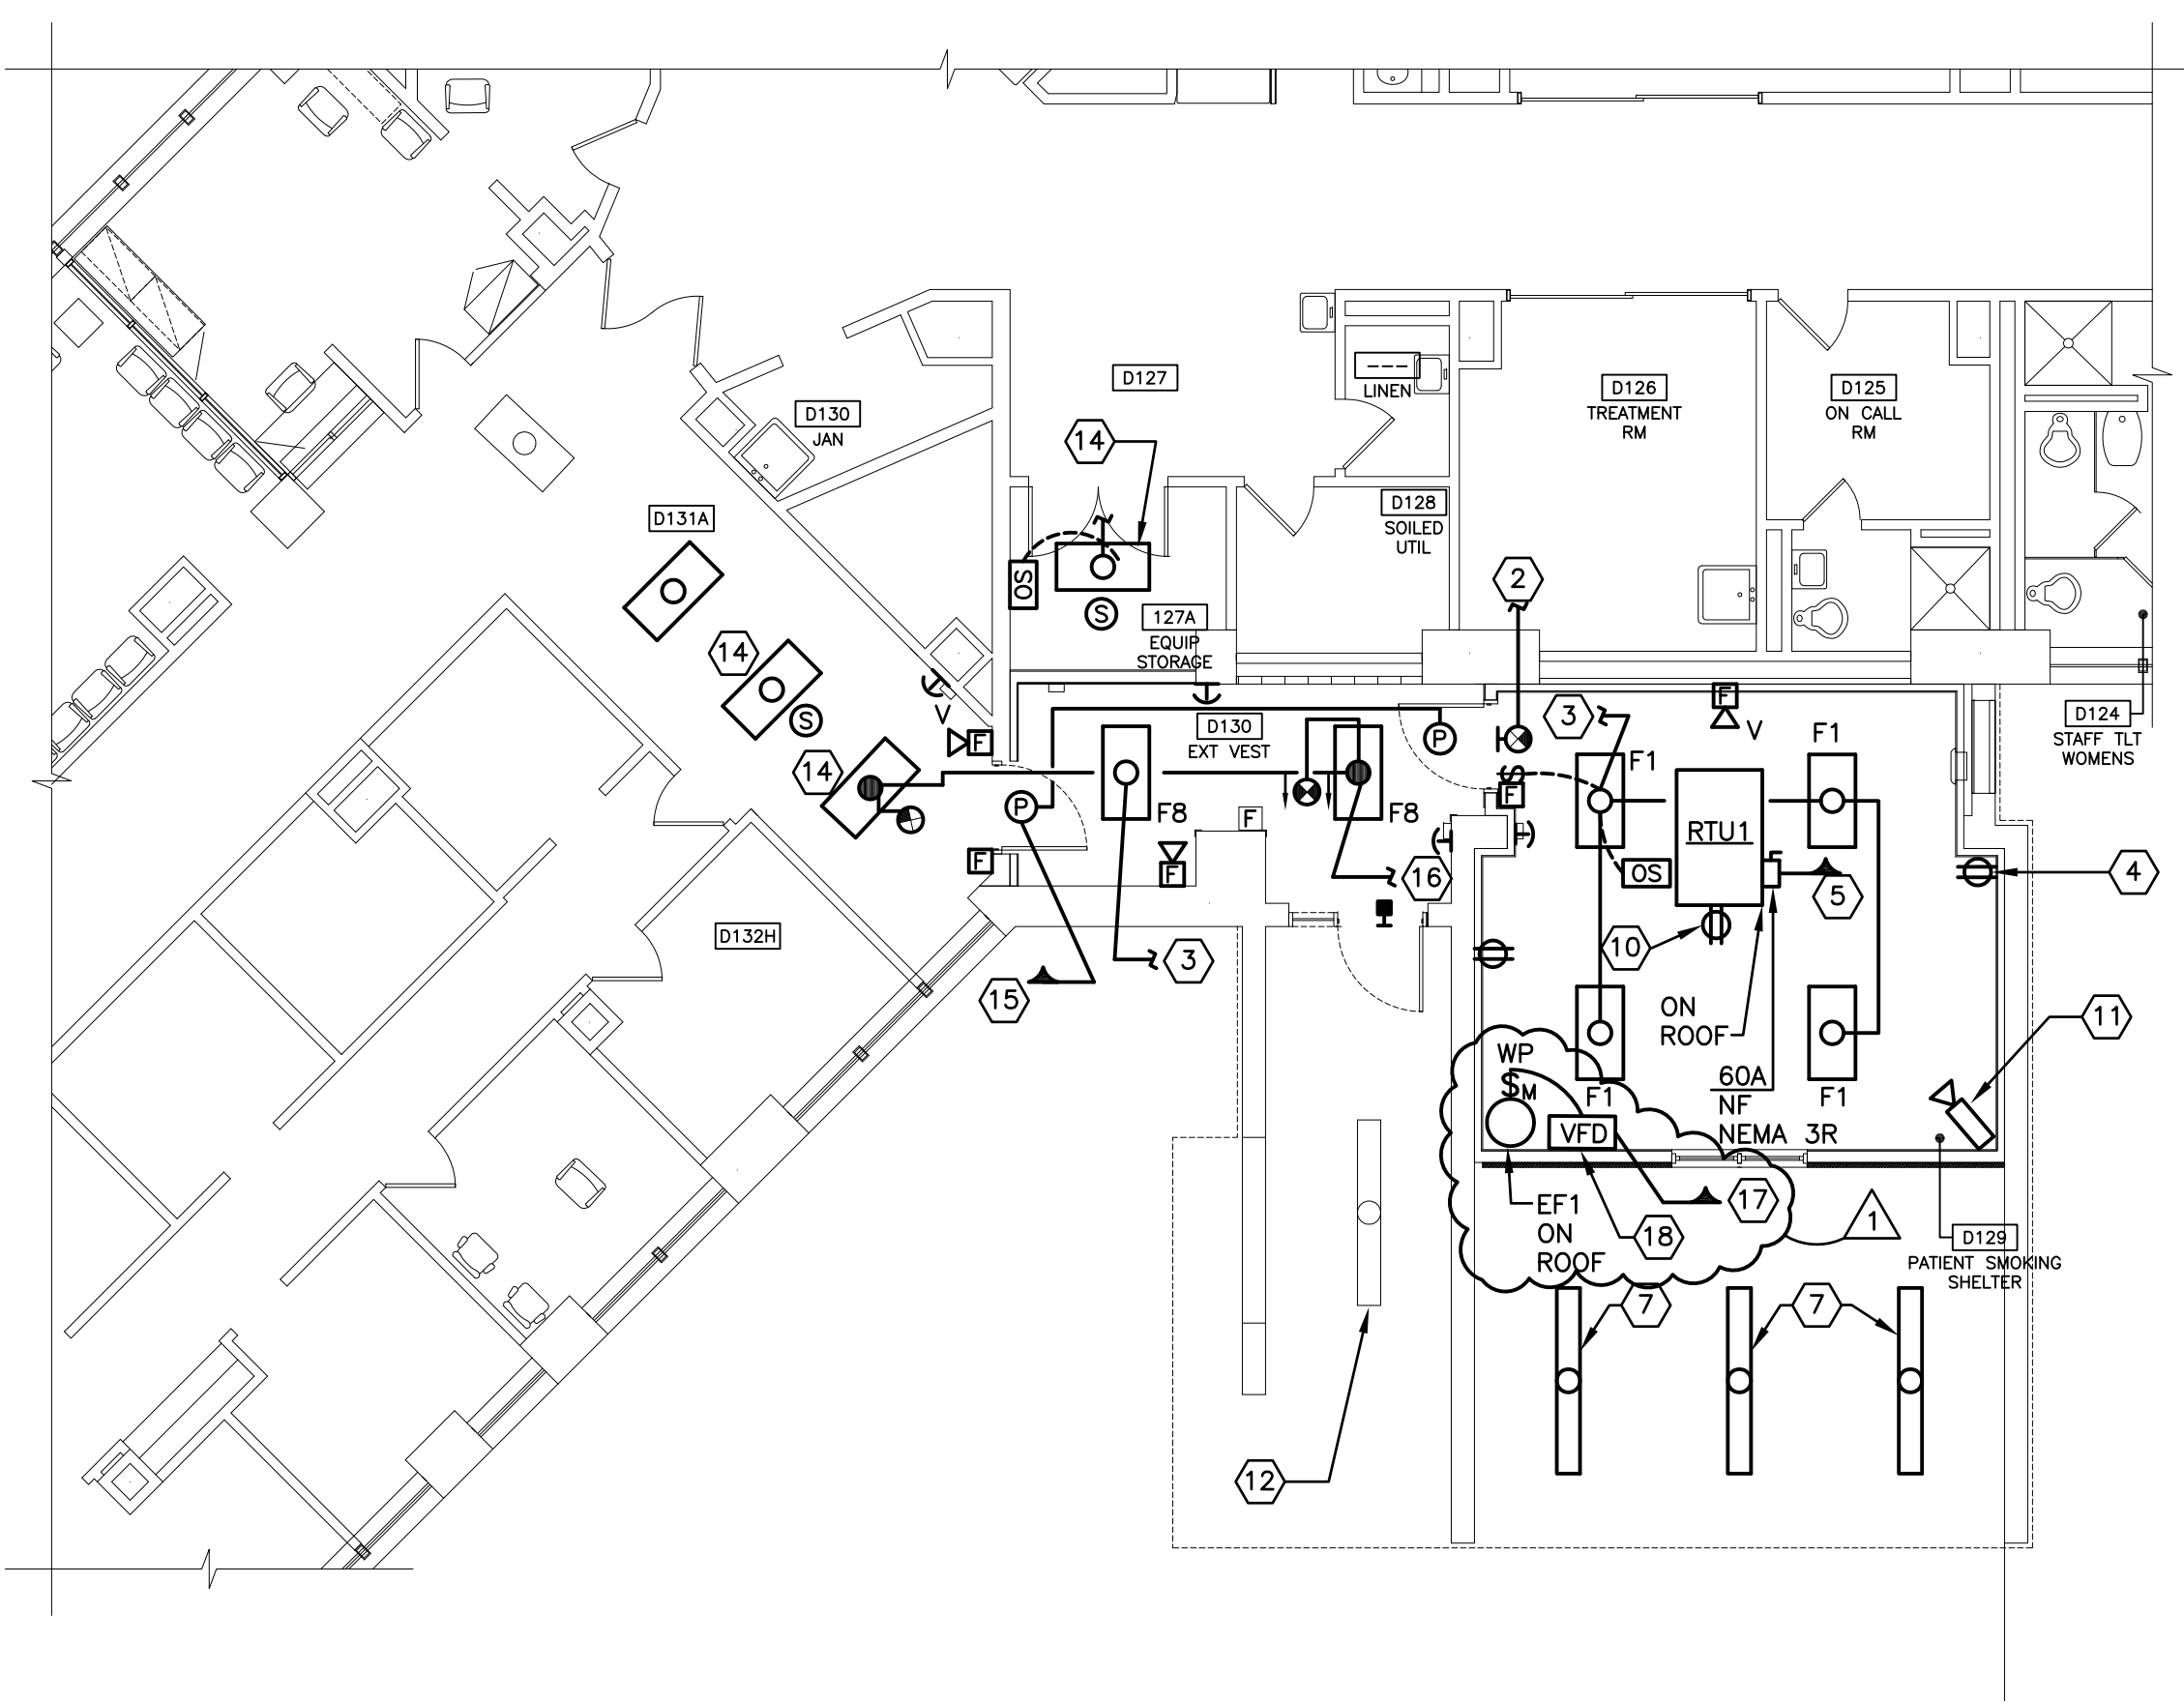


FIRST FLOOR SMOKING SHELTER-NEW ELECTRICAL PLAN - WING D
SCALE: 1/8" = 1'-0"

- GENERAL NOTES:**
- EXISTING ELECTRICAL DEVICES BEING REMOVED SHALL BE TURNED OVER TO THE VA FOR THEIR USE. COORDINATE WITH VA REPRESENTATIVE.
 - WHERE DEVICES AND OUTLETS ARE REMOVED FROM SERVICE BUT JUNCTION BOX/OUTLET BOX IS TO REMAIN, PROVIDE BLANK COVER PLATE.
 - NEW FIRE ALARM DEVICES SHOWN SHALL BE CONNECTED TO EXISTING NOTIFIER FIRE ALARM SYSTEM. TYPICAL FOR ALL FIRE ALARM DEVICES SHOWN. COORDINATE EXACT TIE-IN POINT TO EXISTING SYSTEM WITH NOTIFIER REPRESENTATIVE. NEW DEVICES SHALL MATCH EXISTING NOTIFIER DEVICES.

- KEYED NOTES:**
- UNLESS OTHERWISE NOTED REMOVE ALL EQUIPMENT AND DEVICES INCLUDING ALL ASSOCIATED WIRING BACK TO SOURCE IN THIS AREA.
 - CONNECT TO EXISTING EXIT SIGN CIRCUIT IN THE AREA.
 - CONNECT NEW LIGHTING FIXTURES TO EXISTING AREA LIGHTING BRANCH CIRCUIT.
 - CONNECT RECEPTACLES TO EXISTING RECEPTACLE CIRCUIT IN ROOM.
 - CONNECT RTU-1 LOCATED ON ROOF TO NEAREST 208/120V PANEL WITH SPARE CAPACITY. PROVIDE A NEW 20A 1-POLE CIRCUIT BREAKER IN EXISTING PANEL AS REQUIRED.
 - REMOVE EXISTING RECESSED LIGHTS AND MAINTAIN FOR RE-INSTALLATION IN NEW LOCATION.
 - CLEAN RELAMP AND RE-INSTALL EXISTING RECESSED STRIP FIXTURES IN NEW LOCATION. CONNECT TO EXISTING LIGHTING CIRCUIT.
 - DISCONNECT AND REMOVE POWER AND ALL ASSOCIATED WIRING AND CONDUIT FROM AUTOMATIC DOOR BACK TO SOURCE.
 - DISCONNECT AND REMOVE POWER AND ALL ASSOCIATED WIRING AND CONDUIT FROM CABINET HEATER BACK TO SOURCE.
 - CIRCUIT RECEPTACLE ON ROOF TO EXISTING CORRIDOR RECEPTACLE CIRCUIT.
 - RELOCATE EXISTING CAMERA TO WATCH DOOR. EXTEND WIRING AS REQUIRED FOR AN OPERATIONAL CAMERA.
 - PROVIDE A NEW LENS FOR EXISTING FIXTURE TO REMAIN. NEW LENS SHALL BE FROM EXISTING FIXTURES MANUFACTURER.
 - REMOVE EXISTING LIGHTING FIXTURE AND RETAIN FOR RE-INSTALLATION IN NEW LOCATION.
 - CONNECT EXISTING LIGHTING FIXTURE, IN NEW LOCATION, TO EXISTING AREA LIGHTING BRANCH CIRCUIT. EXTEND EXISTING CIRCUIT AS REQUIRED. CLEAN LENS AND RE-LAMP PRIOR TO INSTALLATION IN NEW LOCATION.
 - PROVIDE POWER FOR AUTOMATIC DOOR OPERATOR. ROUTE CIRCUIT TO NEAREST 120V PANEL WITH SPARE CAPACITY.
 - CONNECT TO NEAREST EMERGENCY AREA LIGHTING CIRCUIT.
 - CONNECT EF1 LOCATED ON ROOF TO NEAREST 208/120V PANEL WITH SPARE CAPACITY. PROVIDE A NEW 20A 1-POLE CIRCUIT BREAKER IN EXISTING PANEL.
 - VFD SHALL BE MOUNTED ABOVE THE ACCESSIBLE CEILING. COORDINATE EXACT REQUIREMENTS WITH MECHANICAL CONTRACTOR.

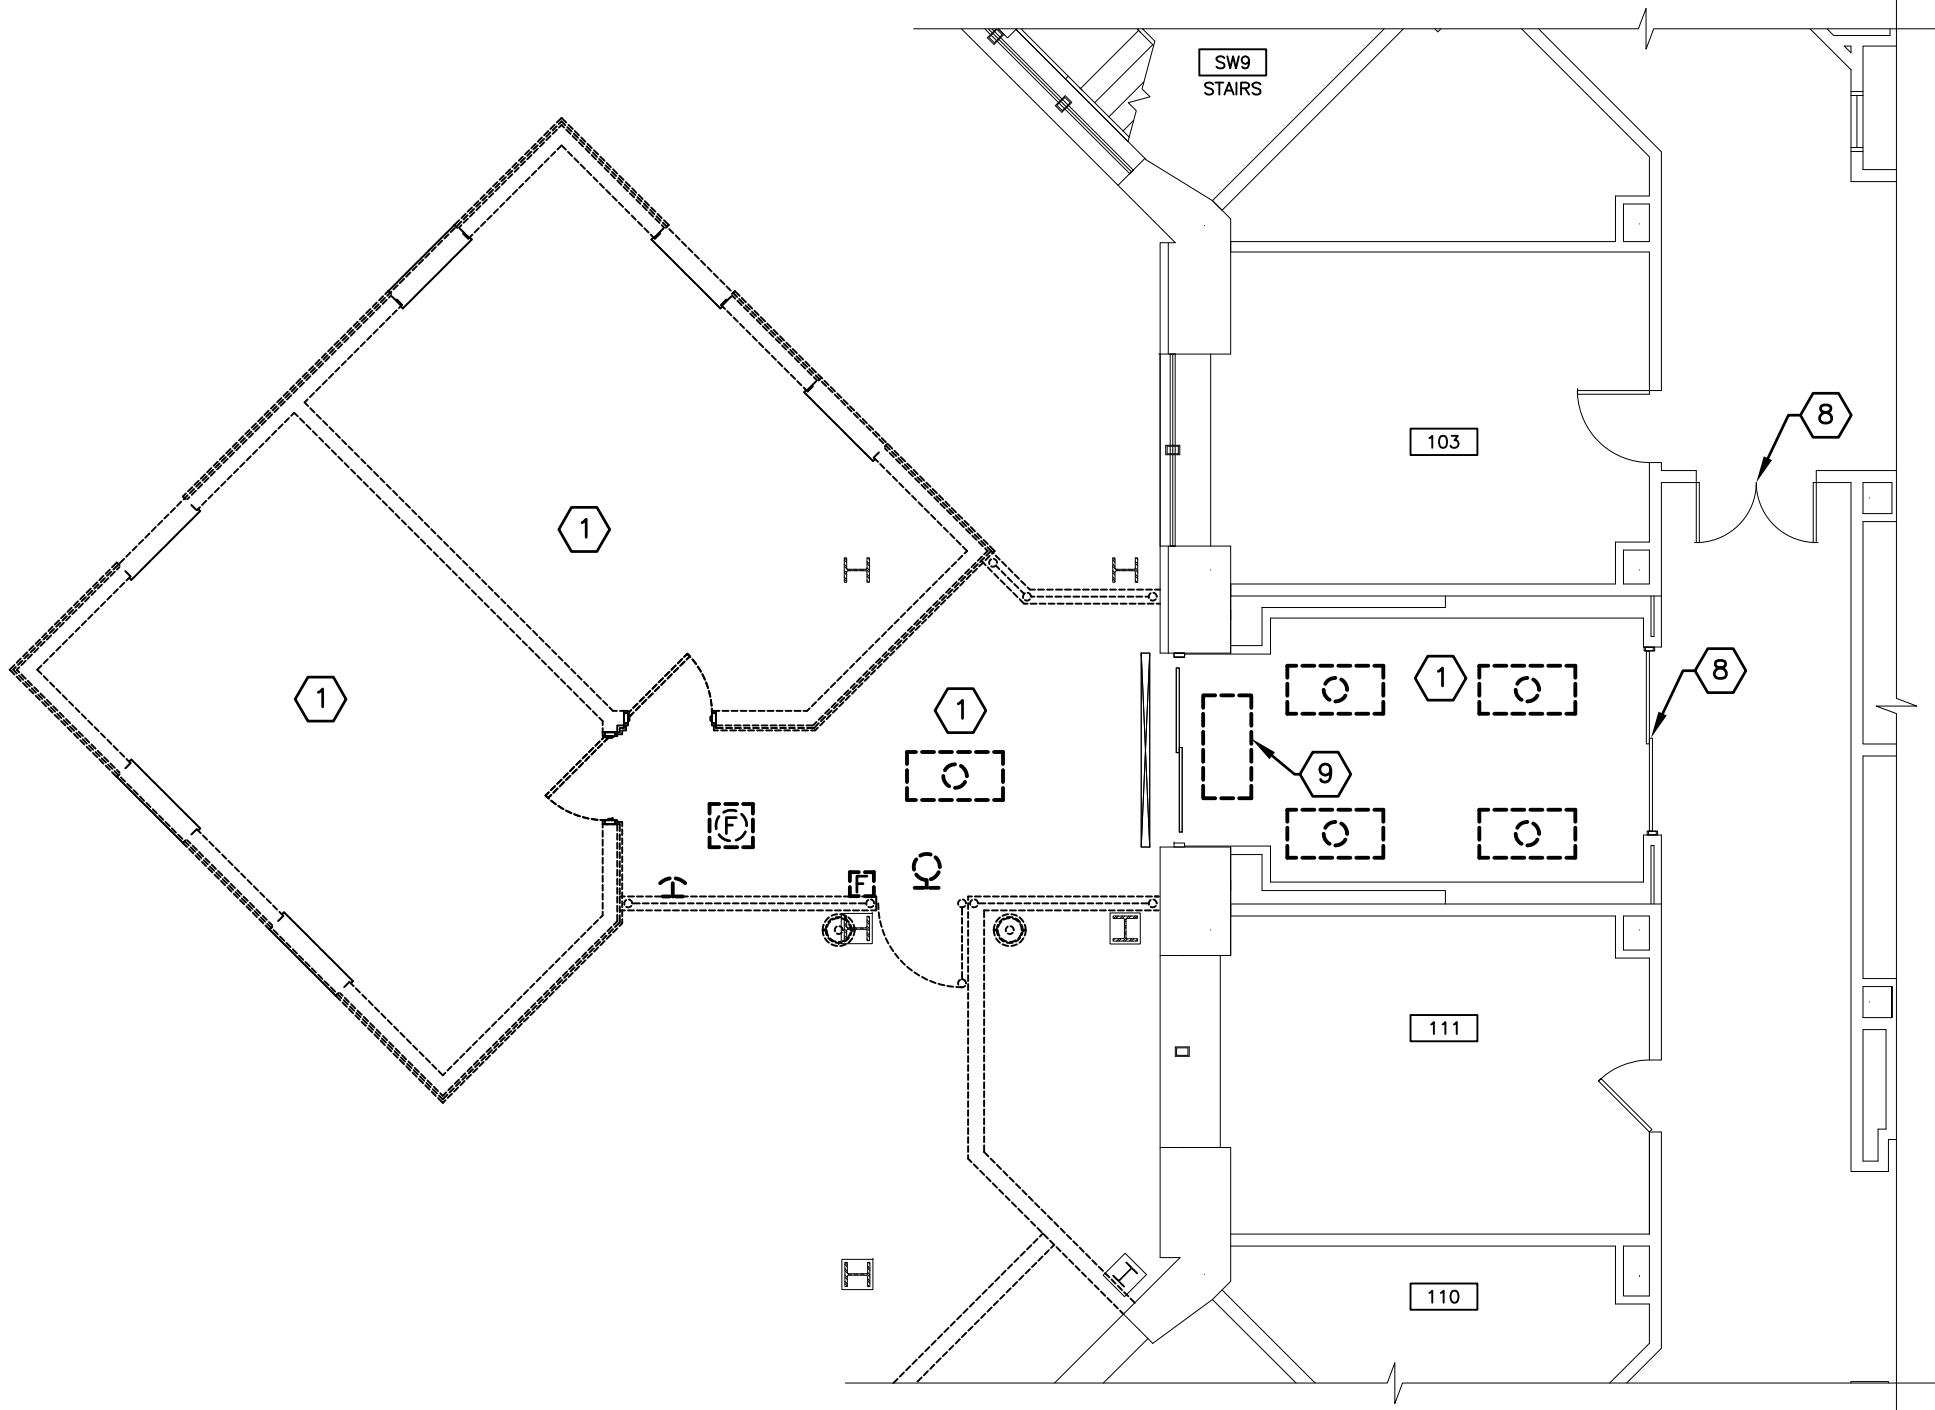



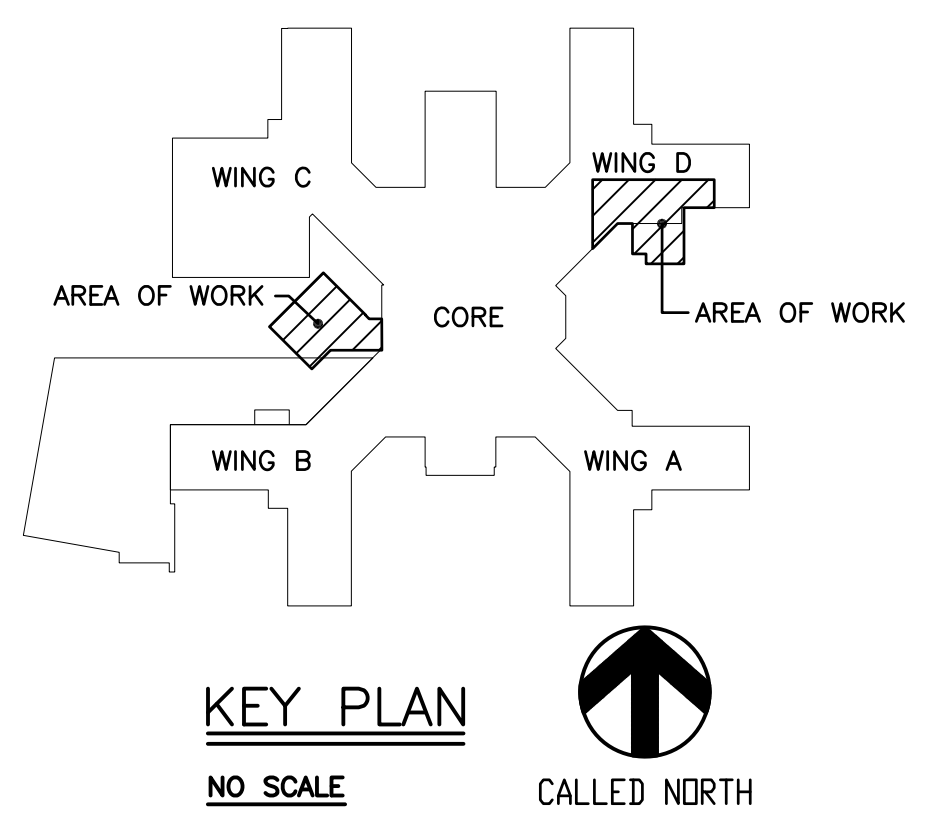



EXISTING FIRST FLOOR SMOKING SHELTER-ELECTRICAL DEMO PLAN
SCALE: 1/8" = 1'-0"



FINAL DESIGN (100%)
FULLY SPRINKLERED

FFA #7451

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| CONSULTANTS:  FRIEDMAN FISHER ASSOCIATES, P.C. Quality Service Since 1944 22 Aviation Road, Albany, New York 12206 TEL (518) 458-7040 FAX (518) 458-7043 info@friedmanfisher.com  EBERLIN AND EBERLIN, P.C. 247 ROUTE 100 SUITE 1003 SOMERS NEW YORK 10589 CONSULTING ENGINEERS, PLANNERS, LANDSCAPE ARCHITECTS 914.232.9431 PHONE 914.232.6827 FAX | |  RYAN-BIGGS ASSOCIATES, P.C. 291 River Street p 518 272.6266 Troy, NY 12180 f 518 272.4467 www.ryanbiggs.com | |  ARCHITECT/ENGINEERS:  Hyman Hayes ASSOCIATES 6 WENDLEY COURT, ALBANY, NEW YORK 12205 (518) 452-3470 (518) 452-3783 Fax HHA Proj. 10046 | | Drawing Title ELECTRICAL: FIRST FLOOR-EXISTING & NEW SMOKING SHELTER ELECTRICAL PLANS - WING D (DEDUCT ALTERNATE NO. 1) Approved Project Director | | Project Title NEW EMERGENCY DEPARTMENT Stratton VA Medical Center Location Albany, New York Date JULY 24, 2012 Checked JLM Drawn MLS | | Project Number VA 528-809 Building Number 95 Drawing Number E15.1 Dwg. 115 of 115 | | Office of Construction and Facilities Management  Department of Veterans Affairs | |
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