

Drawing Index

These sheets are a document set and should not be separated. Electrical information and references are contained on all sheets.

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These drawings indicate the placement and interconnection of the listed equipment components. These drawings are not construction or site preparation drawings. Customer remains ultimately responsible for preparing the site to accommodate the operation of such equipment in compliance with GE Healthcare's written specifications and all applicable federal, state, and/or local requirements.

*** REQUIRED REFERENCE ***
 Precision 500d w/Saturn PC
 w/KM Detector
 Pre Installation Manual
 5436429-1EN, KMMI-137

A mandatory component of this drawing set is the GE Healthcare Pre Installation manual. Failure to reference the Pre Installation manual will result in incomplete documentation required for site design and preparation.

Pre Installation documents for GE Healthcare products can be accessed on the web at:

www.gehealthcare.com/siteplanning

GE Healthcare



R/F Site Planning



imagination at work

Customer Site Readiness Requirements

- Any deviation from these drawings must be communicated in writing to and reviewed by your local GE Healthcare Installation Project Manager prior to making changes.
- Make arrangements for any rigging, special handling, or facility modifications that must be made to deliver the equipment to the installation site. If desired, your local GE Healthcare Installation Project Manager can supply a reference list of rigging contractors.
- New construction requires the following; 1. Secure area for equipment, 2. Power for drills and other test equipment, 3. Capability for image analysis, 4. Restrooms.
- Provide for refuse removal and disposal (e.g. crates, cartons, packing)
- Contact a radiation physicist or consultant to specify radiation containment requirements.

GE Equipment Delivery Requirements

The items on the GE Healthcare Site Readiness Checklist are REQUIRED to facilitate equipment delivery to the IS site. Equipment will not be delivered if these requirements are not satisfied.

Before using this document ensure you have the latest Rev from MyWorkshop on DOC1809666

 Global Site Readiness Checklist (DI)	
Customer Name:	PMI Name:
GON Number:	Field Service Name:
Equipment:	Country / City or City/State:
1) Check site before Delivery/Storage	
2) Check site before installation start	
Place an "X" in either Y or N column	
Site Ready Checks at Installation	Y
Room dimensions, including ceiling height, for all Exam, Equipment/Technical & Control rooms meets GE specifications.	mandatory if no or blank
Ceiling support structure, if indicated on the GE drawing, is in the correct location, at the correct height, levelness and spacing has been measured.	mandatory if no or blank
Rooms that will contain equipment, including staging areas if applicable, are construction debris free. Precautions must be taken to prevent debris from entering rooms containing equipment.	mandatory if no or blank
Finished ceiling is installed. If applicable ceiling tiles installed per PMI discretion.	mandatory if no or blank
Adequate delivery route from truck to final place of installation has been reviewed with all stakeholders, all communications/notifications have occurred, arrangements have been made for special handling (rigging, elevator, fork lift, etc.). All floors along delivery route will support weight of the equipment, temporary reinforcements arranged if needed.	mandatory if no or blank
System power & grounding (PDB/MDPI) is available as per GE specifications, installed at point of final connection and ready to use. Lock Out Tag Out is available.	mandatory if no or blank
System power and grounded audit has been scheduled to be completed during installation of equipment. (If Required) GEHC PM to confirm if needed.	mandatory if no or blank
Adequate room illumination installed and working.	mandatory if no or blank
Cable ways (floor/wall/ceiling/Access Flooring) are available for installation of GE cables and are of correct length and diameter. Cable ways routes per GE Final drawings and cable access openings areas installed at a time determined by GEHC PM. Surface floor duct can be installed at time of system installation.	mandatory if no or blank
HVAC systems installed, and the site meets minimum environmental operational system requirements.	mandatory if no or blank
Network outlets installed and computer network available and working.	mandatory if no or blank
Hospital IT/connectivity contacts have been engaged and information has been added to Project management tool. (If Required)	mandatory if no or blank
Floor levelness/firmness is measured and within tolerance, and there are no visible defects per GEHC specifications. Floor Strength and thickness have been discussed with customer/contractor and they will confirm GE requirements are met. Customer supplied countertops where GE equipment will be installed are in place.	mandatory if no or blank
Doors and windows complete or scheduled to be installed. If applicable, radiation protection (shielding) finished & radioprotection regulatory approval for installation obtained.	mandatory if no or blank
STATUS OF WORK	
GENERAL COMMENTS	
SYSTEM CAN BE DELIVERED	PMI Signature:
SITE READY FOR INSTALLATION	FS Signature:

This drawing is based on Sketch No.: s16-1037

GE Healthcare

Healthcare Project Implementation – Design Center
 Milwaukee, Wisconsin
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SHEET TITLE: SITE READINESS
 MODALITY TYPE: PRECISION 500D

THIS PLAN IS SUBMITTED TO SUGGEST LOCATION OF GE HEALTHCARE EQUIPMENT AND ASSOCIATED APPARATUS, ELECTRICAL WIRING DETAILS AND ROOM ARRANGEMENTS. IT IS NOT TO BE USED FOR CONSTRUCTION PURPOSES, NOR TO BE INSTALLED. IT IS NOT TO BE USED FOR ACTUAL CONSTRUCTION PURPOSES, HOWEVER, AND THE COMPANY CANNOT ACCEPT RESPONSIBILITY FOR ANY DAMAGES RESULTING THEREFROM.

PROJECT TITLE:
**Cheyenne V A
 Medical Center**
 Cheyenne, WY

PROJECT	REVISION
M032678	00A
DATE:	18.Dec.17
DRAWN BY:	GSP
CHECKED BY:	GSP
GON NO:	4562866
GON DT:	18.Sep.17

REVISION HISTORY:

SHEET
C1

GE EQUIPMENT LISTING

EQUIPMENT ON ORDER FROM GE HEALTHCARE, INSTALLED BY GE HEALTHCARE, PER CON 4562866 DATED 18.Sep.17

NOTE: LOCAL CONDITIONS MAY DICTATE THAT ITEMS IDENTIFIED IN THIS CATEGORY BE INSTALLED BY OTHERS.

EQUIPMENT CROSS REFERENCE CHART
 P = PREAPPROVAL
 C = CALCULATIONS/PENDING APPROVAL
 S = SPECIFICATIONS ONLY

ITEM NO.	QUANTITY ORDERED	REFER TO SHEET "D"	ITEM DESCRIPTION (* = EXISTING/REINSTALL)	WEIGHT	HEAT OUTPUT (PER HOUR)	DETAIL NO.	STRC PLAN	ELEC PLAN
1			AERO DR INTERFACE UNIT	24 lbs	112 btu	B-KMOD3	-	I/F
2			AERO DR GENERATOR INTERFACE UNIT	15 lbs		B-KMOD4	-	G1B
3			AERO DR DOCKING STATION/BATTERY CHARGER (14x17 & 17x17 DETECTORS)	15 lbs	85 btu	B-KMOD2	-	BC
4			AERO DR CONTROLLER CS-7	37 lbs	1774 btu		-	CS7
5			AERO DR ACCESS POINT (LOCATION TO BE DETERMINED BY FIELD AT INSTALL)	2 lbs	112 btu	B-KMOD1	-	AP
6			SYSTEMS CABINET	881 lbs	2457 btu	B0558A	---	SKL
7			CABLE DRAPE RAIL	108 lbs		C7506 C7507	B20 091	-
8			XT RADIOGRAPHIC SUSPENSION WITH INBOARD MOUNTING	623 lbs	501 btu	B2004 C7506 C7507	B20 041	XTS1
9			LONGITUDINAL STATIONARY RAIL FOR XT SUSPENSION	110 lbs				-
10			SG-80 CHEST UNIT WITH KNEE EXTENSION	427 lbs		B3503B	---	K
11			ONE LCD MONITOR SUSPENSION ON XT INBOARD BRIDGE	282 lbs	68 btu	B2011A	-	WB1
12			PRECISION R/F TABLE WITH INTELLIGENT DIGITAL DEVICE	3443 lbs	426 btu	B0114 B0114A	B01 14B	RFP3
13			POSITIONER CABINET	685 lbs	3412 btu	A8008	S02	RFP1
14			TIMMS 2000 COMPUTER & MONITOR	26 lbs	402 btu	C7510	-	TPC
15			SATURN OPERATORS CONSOLE	85 lbs	781 btu	C7504 C7511	-	WB2
16			IUI ACCESSORY ASSEMBLY	15 lbs		B0114K	---	S

THE FOLLOWING ITEMS, WHICH HAVE BEEN ORDERED FROM GE HEALTHCARE, ARE TO BE INSTALLED BY THE CUSTOMER OR HIS CONTRACTOR.


60	1		MAIN DISCONNECT PANEL	79 lbs			-	A
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SCALE: 1/4" = 1'-0"

EQUIPMENT LAYOUT

EXISTING CEILING HEIGHT = 9'-6"

This equipment layout indicates the placement and interconnection of the indicated equipment components. There may be federal, state, and/or local requirements that could impact the placement of these components. It remains the Customer's responsibility for ensuring the site and final equipment placement complies with all applicable federal, state, and/or local requirements.

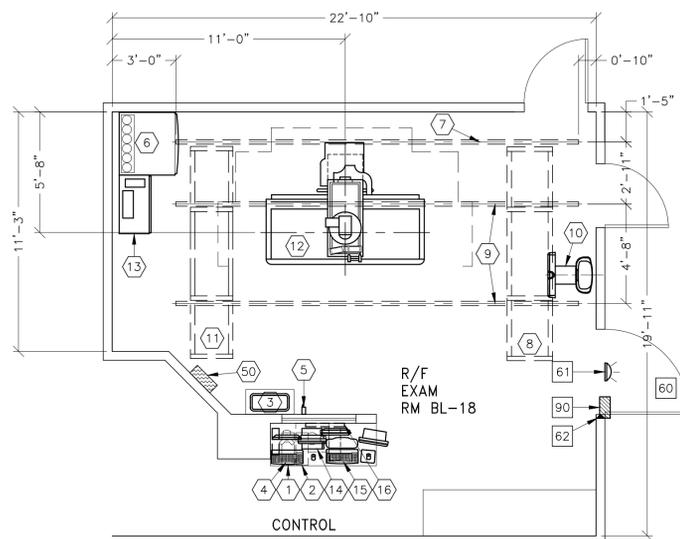

GE Project Manager: JACOB BRAVO
 Telephone: 303-229-3519
 THE GE I&H TECHNICAL SUPPORT GROUP IS AN ADDITIONAL RESOURCE THAT CAN PROVIDE ANSWERS FOR GENERAL GE PRODUCT SITING QUESTIONS AND CAN BE REACHED AT (877)-305-9677 OR MAILTO:HPTECHS01@ge.com

ANCILLARY ITEMS

CUSTOMER/CONTRACTOR SUPPLIED AND INSTALLED ITEMS

ITEM NO.	ITEM DESCRIPTION (* INDICATES EXISTING)
60	MINIMUM DOOR OPENING FOR EQUIPMENT DELIVERY IS 44 IN. W X 83 IN. H (1118mm X 2108mm), CONTINGENT ON A 96 IN. (2438mm) CORRIDOR WIDTH
61	X-RAY ON WARNING LIGHT - AVAILABLE FROM GEPRO CALL: 800-200-9760 GE CAT. NO. WX1ABVV-DF-XIU
62	DOOR LIMIT SWITCH (NEEDED ONLY IF REQUIRED BY STATE/LOCAL CODES)

THE FOLLOWING ITEMS ARE AVAILABLE FROM GE HEALTHCARE TECHNOLOGIES. CONTACT YOUR LOCAL GE HEALTHCARE SERVICE REPRESENTATIVE FOR PRICING AND AVAILABILITY.

90	X-RAY ROOM WARNING LIGHT/ROOM LIGHTING CONTROL PANEL REFERENCE JUNCTION POINT "XRLC" ON SHEET "E1" FOR DETAILED DESCRIPTION -CAT. NO. E4302SS FOR WARNING LIGHT & ROOM LIGHT CONTROL.
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GENERAL SPECIFICATIONS

- THE REQUIRED CEILING HEIGHT INDICATED ON THESE PLANS IS TO ENSURE EQUIPMENT FUNCTION IS NOT IMPAIRED. CONSULT WITH YOUR LOCAL GEHC SPECIALIST REGARDING ACCEPTABILITY OF OTHER CEILING HEIGHTS.
- CHECK ALL DOOR OPENINGS AND HALLWAYS FROM DELIVERY LOCATION TO WHERE EQUIPMENT IS TO BE INSTALLED TO ENSURE THE ROUTE PHYSICALLY AND STRUCTURALLY WILL ACCOMMODATE THE EQUIPMENT AS SHIPPED.
- RADIATION PROTECTION REQUIREMENTS ARE NOT INDICATED ON THIS PLAN. WHERE NEEDED PER NATIONAL OR LOCAL CODE THEY SHALL BE SPECIFIED BY A QUALIFIED RADIOLOGICAL PHYSICIST.
- THE DEVELOPMENT OF THE EQUIPMENT LAYOUT, ROOM DIMENSIONS, MECHANICAL AND ELECTRICAL SUGGESTIONS IS PREDICATED UPON THE BEST INFORMATION OBTAINABLE FROM THE SITE, COUPLED WITH THE CUSTOMER'S KNOWN DESIRES. ARCHITECTURAL OR ELECTRICAL CHANGES INCLUDING RELOCATION OF EQUIPMENT ILLUSTRATED ON THIS DRAWING IS ALLOWED ONLY WITH NOTIFICATION, IN WRITING, AND REVIEW BY GEHC SERVICE DEPARTMENT. EQUIPMENT OPERATION, SERVICEABILITY, AND RESTRICTING CABLE LENGTHS, ETC., MAKE THIS ESSENTIAL FOR A PROPER IS. GEHC RESERVES THE RIGHT TO MAKE ON THE JOB CHANGES BECAUSE OF CUSTOMER REQUIREMENTS AND/OR OBSTACLES IN CONSTRUCTION, ETC..
- ALL WORK TO BE IN COMPLIANCE WITH NATIONAL AND LOCAL BUILDING SAFETY CODES.
- DIMENSIONS ARE TO FINISHED SURFACES OF ROOM

SITE ENVIRONMENT SPECIFICATIONS

- AMBIENT OPERATING TEMPERATURE: 59 TO 75 DEGREES (F), MAXIMUM ALLOWABLE TEMPERATURE CHANGE OF 15 DEGREES (F)/HOUR.
- HUMIDITY: REFER TO PREINSTALLATION MANUAL FOR THE EQUIPMENT ILLUSTRATED ON THIS DRAWING.
- ALTITUDE: NOT TO EXCEED 8,000 FT. ABOVE SEA LEVEL.
- THE ENVIRONMENT FOR THE ELECTRONICS CABINET MUST BE CONTROLLED SO THE ABOVE RESTRICTIONS ARE NOT EXCEEDED.
- DO NOT RESTRICT THE AIR INTAKE AT THE LOWER FRONT OR AIR EXHAUST AT THE TOP OF THE ELECTRONICS CABINETS.

MAGNETIC INTERFERENCE SPECIFICATIONS

- DIGITAL FLAT PANEL MUST BE LOCATED IN AMBIENT STATIC MAGNETIC FIELDS OF LESS THAN 1 GAUSS TO GUARANTEE SPECIFIED IMAGING PERFORMANCE.
- X-RAY TUBES MUST BE LOCATED IN AMBIENT STATIC MAGNETIC FIELDS OF LESS THAN 10 GAUSS TO GUARANTEE SPECIFIED PERFORMANCE.
- SYSTEM ELECTRONICS MUST BE LOCATED IN AMBIENT STATIC MAGNETIC FIELDS OF LESS THAN 10 GAUSS TO GUARANTEE DATA INTEGRITY.
- OPERATORS CONSOLE EQUIPMENT MUST BE LOCATED IN AMBIENT STATIC MAGNETIC FIELDS OF LESS THAN 10 GAUSS TO OBTAIN SPECIFIED GEOMETRIC LINEARITY.

GE Healthcare
 Healthcare Project Implementation - Design Center
 Milwaukee, WI

SHEET TITLE: **EQUIPMENT LAYOUT**
 MODALITY TYPE: **PRECISION 500D**
THIS PLAN IS SUBMITTED TO SUGGEST LOCATION OF GE HEALTHCARE EQUIPMENT AND ASSOCIATED APPARATUS. ELECTRICAL WIRING DETAILS AND ROOM ARRANGEMENTS ARE NOT TO BE CONSIDERED FINAL. THE CUSTOMER IS RESPONSIBLE FOR VERIFYING THAT ALL EQUIPMENT EXPECTED TO BE INSTALLED IN THIS ROOM CAN BE USED FOR ACTUAL CONSTRUCTION PURPOSES. HOWEVER, AND THE COMPANY CANNOT ACCEPT RESPONSIBILITY FOR ANY DAMAGES RESULTING THEREFROM.

PROJECT TITLE:
**Cheyenne V A
 Medical Center**
 Cheyenne, WY

PROJECT: **M032678** REVISION: **00A**
 DATE: **18.Dec.17**
 DRAWN BY: **GSP**
 CHECKED BY: **GSP**
 CON NO: **4562866**
 CON DT: **18.Sep.17**

REVISION HISTORY:


SHEET
A1

This drawing is based on Sketch No.: s16-1037
 PIM R3, RA
 RQ - DC-38938


TYPICAL WALL SUPPORT ELEVATIONS

S116

S02

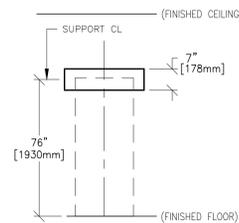

SUPPORT FOR ATLAS/SYSTEMS CABINET (NOT TO SCALE)

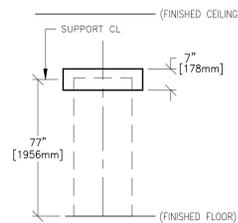


SUPPORT FOR ADVANTX ELECTRONICS CABINETS (NOT TO SCALE)

SCALE: 1/4" = 1'-0"

STRUCTURAL LAYOUT

EXISTING CEILING HEIGHT = 9'-6"

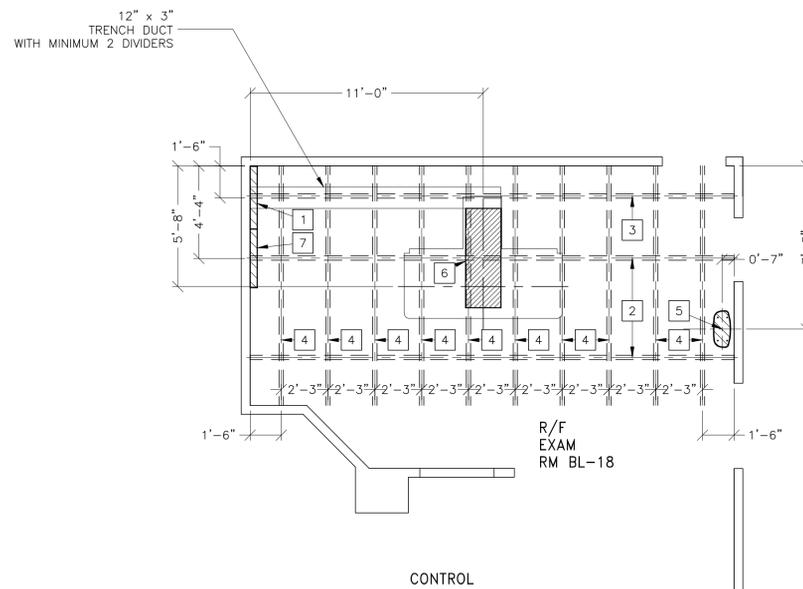

STRUCTURAL SUPPORT METHODS

CUSTOMER/CONTRACTOR SUPPLIED AND INSTALLED ITEMS

ITEM NO.	ITEM DESCRIPTION (* INDICATES EXISTING)
1	SUPPORT BACKING, LOCATE AS SHOWN, REFER TO ELEVATION DETAIL S116, FOR ATLAS CABINET.
2	PIODOT UNISTRUT OR EQUIVALENT SUPPORTS FOR FASTENING CEILING SUPPORTED EQUIPMENT. SUPPORTS TO BE LOCATED AS SHOWN, PERPENDICULAR AND BELOW GRIDDED UNISTRUT SYSTEM. SUPPORT SHOULD RUN CONTINUOUS WITH NO FITTINGS EXTENDING BELOW FACE OF UNISTRUT CHANNEL. BE PARALLEL, SQUARE, AND IN THE SAME HORIZONTAL PLANE. TOP OF UNISTRUT TO BE FLUSH WITH FINISHED CEILING. EQUIPMENT IS MOUNTED TO THESE SUPPORTS EVERY 2'-2" AND REQUIRES 350 LBS. (597 LBS. IN SEISMIC REGIONS) PER BOLT SUPPORTS.
3	PIODOT UNISTRUT OR EQUIVALENT SUPPORTS FOR FASTENING CEILING SUPPORTED EQUIPMENT. SUPPORTS TO BE LOCATED AS SHOWN, PERPENDICULAR AND BELOW GRIDDED UNISTRUT SYSTEM. SUPPORT SHOULD RUN CONTINUOUS WITH NO FITTINGS EXTENDING BELOW FACE OF UNISTRUT CHANNEL. BE PARALLEL, SQUARE, AND IN THE SAME HORIZONTAL PLANE. TOP OF UNISTRUT TO BE FLUSH WITH FINISHED CEILING. EQUIPMENT IS MOUNTED TO THESE SUPPORTS EVERY 2'-2" AND REQUIRES 30 LBS. PER BOLT SUPPORTS.
4	UNISTRUT OR EQUIVALENT SUPPORT IN CEILING FOR FASTENING CEILING SUPPORTED EQUIPMENT. SUPPORTS TO RUN CONTINUOUS WITH NO FITTINGS EXTENDING BELOW FACE OF UNISTRUT CHANNEL. RUN WALL TO WALL, BE PARALLEL, SQUARE, AND IN THE SAME HORIZONTAL PLANE. FLUSH WITH THE FINISHED CEILING. LOCATE AS DIMENSIONED ON SITE SPECIFIC STRUCTURAL PLAN. METHODS OF SUPPORT THAT PERMIT ATTACHMENT TO STRUCTURAL STEEL OR THROUGH BOLTS IN CONCRETE SHOULD BE FAVORED.
5	FLOOR CONTACT AREA FOR CHEST UNIT.
6	FLOOR CONTACT AREA FOR TABLE (PROVIDED BY GEHC) PRECISION 500D Seismic Zone ANCHORING HARDWARE (WHERE APPLICABLE) (POSITIONER CAB) ANCHORS = Hilti KB3 - 3/8 x 3.75 in. (2 ea.) (POSITIONER CAB) SCREWS = No. 12 TEK Screws (4 ea.) (BUCKY, SG-80/120) ANCHORS = Hilti KB3 - 1/2 x 5.5 in. (4 ea.) (R/F TABLE) ANCHORS = Hilti KB3 - 5/8 x 6 in. (8 ea.) (SYSTEM CABINET) ANCHORS = Hilti KB3 - 3/8 x 3.75 in. (2 ea.) (SYSTEM CABINET) SCREWS = No. 12 TEK Screws (4 ea.) (WALL MOUNT FP MONITOR) SCREWS = No. 12 TEK Screws (4 ea.) (TABLE ACCY. RACK) SCREWS = No. 12 TEK Screws (4 ea.) ALL ANCHORS TO INCLUDE 1 FLATWASHER, 1 LOCKWASHER AND 1 NUT ALL BRACKETS ARE SHIPPED WITH GE EQUIPMENT.
7	SUPPORT BACKING, LOCATE AS SHOWN, REFER TO ELEVATION DETAIL S02, FOR ELECTRONICS CABINETS.

STRUCTURAL NOTES

- ALL STEEL WORK AND PARTS NECESSARY TO SUPPORT CEILING MOUNTED TUBE HANGER OR OTHER EQUIPMENT ARE TO BE SUPPLIED BY THE CUSTOMER OR HIS CONTRACTORS. THE UNISTRUT OR EQUIVALENT STRUCTURE SHOULD RUN CONTINUOUS WITH NO FITTINGS EXTENDING BELOW FACE OF UNISTRUT CHANNEL, RUN WALL TO WALL, BE PARALLEL, SQUARE AND IN THE SAME HORIZONTAL PLANE FLUSH WITH FINISHED CEILING. THE SYSTEM IS TO BE CROSS BRACED VERTICALLY, HORIZONTALLY AND DIAGONALLY TO ALLOW NO MOVEMENT AND A MAXIMUM OF 1,58mm(1/16") DEFLECTION. CLOSURE STRIPS SHALL BE PROVIDED FOR AREAS OF UNISTRUT EXPOSED AND WITHOUT MOUNTING UNITS.
- METHODS OF SUPPORT FOR THE STEELWORK THAT WILL PERMIT ATTACHMENT TO STRUCTURAL STEEL OR THROUGH BOLTS IN CONCRETE CONSTRUCTION SHOULD BE FAVORED. DO NOT USE CONCRETE OR MASONRY ANCHORS IN DIRECT TENSION.
- ALL UNITS THAT ARE WALL MOUNTED OR WALL SUPPORTED ARE TO BE PROVIDED WITH SUPPORTS WHERE NECESSARY. WALL SUPPORTS ARE TO BE SUPPLIED AND INSTALLED BY THE CUSTOMER OR HIS CONTRACTORS. SEE PLAN AND DETAIL SHEETS FOR SUGGESTED LOCATIONS AND MOUNTING HOLE LOCATIONS.
- ALL CEILING MOUNTED FIXTURES, AIR VENTS, SPRINKLERS, ETC. TO BE FLUSH MOUNTED, OR SHALL NOT EXTEND MORE THAN 6.35mm (1/4") BELOW THE FINISHED CEILING.
- CONTROL WALLS WITH TUBE HANGER PASSAGE ABOVE SHALL BE CONSTRUCTED TO 2130mm (7'-0") HIGH.
- FLOOR SLABS ON WHICH EQUIPMENT IS TO BE INSTALLED MUST BE LEVEL TO 3,17mm (1/8") IN 3050mm (10'-0")
- DIMENSIONS ARE TO FINISHED SURFACES OF ROOM.
- CUSTOMERS CONTRACTOR MUST PROVIDE ALL PENETRATIONS IN POST TENSION FLOORS.
- CUSTOMERS CONTRACTOR MUST PROVIDE AND INSTALL ANY NON-STANDARD ANCHORING. DOCUMENTS FOR STANDARD ANCHORING METHODS ARE INCLUDED WITH GE EQUIPMENT DRAWINGS FOR GEOGRAPHIC AREAS THAT REQUIRE SUCH DOCUMENTATION.
- CUSTOMERS CONTRACTOR MUST PROVIDE AND INSTALL HARDWARE FOR "THROUGH THE FLOOR" ANCHORING AND/OR ANY BRACING UNDER ACCESS FLOORS. THE CONTRACTOR MUST ALSO PROVIDE FLOOR DRILLING THAT CANNOT BE COMPLETED BECAUSE OF AN OBSTRUCTION ENCOUNTERED WHILE DRILLING BY THE GE INSTALLER SUCH AS REBAR ETC.
- IT IS THE CUSTOMER'S RESPONSIBILITY TO PERFORM ANY FLOOR OR WALL PENETRATIONS THAT MAY BE REQUIRED. THE CUSTOMER IS ALSO RESPONSIBLE FOR ENSURING THAT NO SUBSURFACE UTILITIES (E.G., ELECTRICAL OR ANY OTHER FORM OF WIRING, CONDUITS, PIPING, DUCT WORK OR STRUCTURAL SUPPORTS (I.E. POST TENSION CABLES OR REBAR)) WILL INTERFERE OR COME IN CONTACT WITH SUBSURFACE PENETRATION OPERATIONS (E.G. DRILLING AND INSTALLATION OF ANCHORS/SCREWS) PERFORMED DURING THE INSTALLATION PROCESS. TO ENSURE WORKER SAFETY, GE INSTALLERS WILL PERFORM SURFACE PENETRATION OPERATIONS ONLY AFTER THE CUSTOMER'S VALIDATION AND COMPLETION OF THE "GE SURFACE PENETRATION PERMIT"

GE Healthcare
 Healthcare Project Implementation - Design Center
 Milwaukee, WI

SHEET TITLE: STRUCTURAL LAYOUT
 MODALITY TYPE: PRECISION 500D
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PROJECT TITLE:
Cheyenne V A
Medical Center
 Cheyenne, WY



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DRAWN BY:	GSP
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GON DT:	18.Sep.17

REVISION HISTORY:

SHEET
S1


GE Project Manager: JACOB BRAVO
 Telephone: 303-229-3519
 THE GE IPI TECHNICAL SUPPORT GROUP IS AN ADDITIONAL RESOURCE THAT CAN PROVIDE ANSWERS FOR GENERAL GE PRODUCT SIZING QUESTIONS AND CAN BE REACHED AT (877)-305-9677 OR MAILTO:IPITechnical@ge.com

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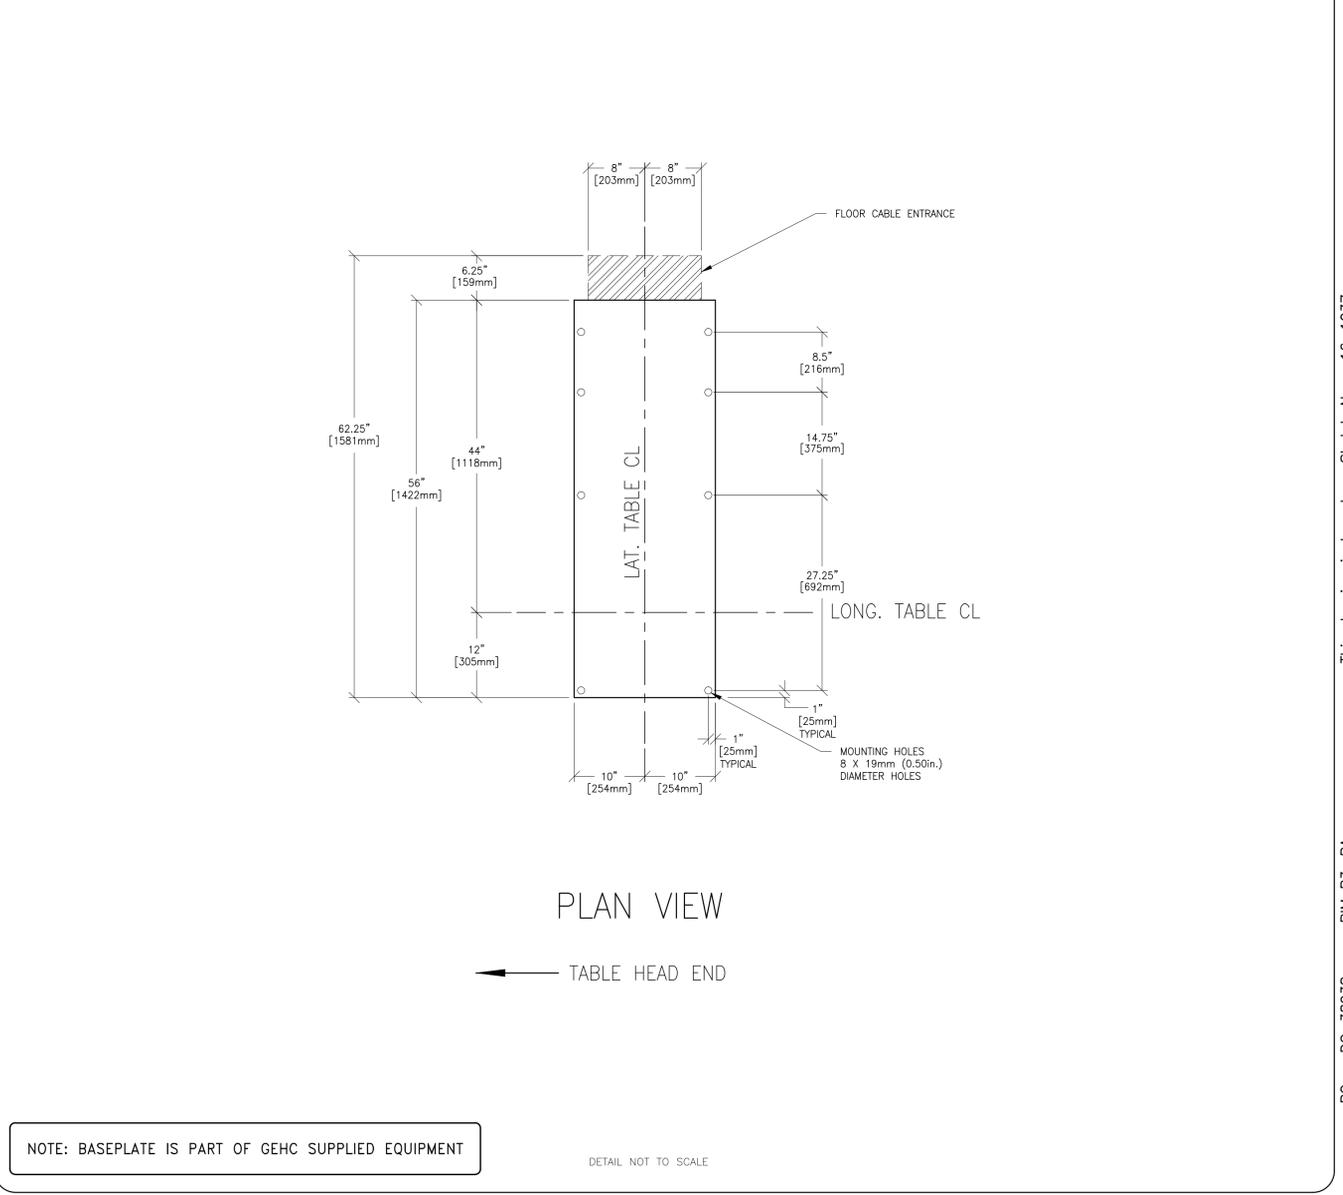
FLOOR MOUNTING DETAIL: SG-80 and SG-120 CHEST UNIT

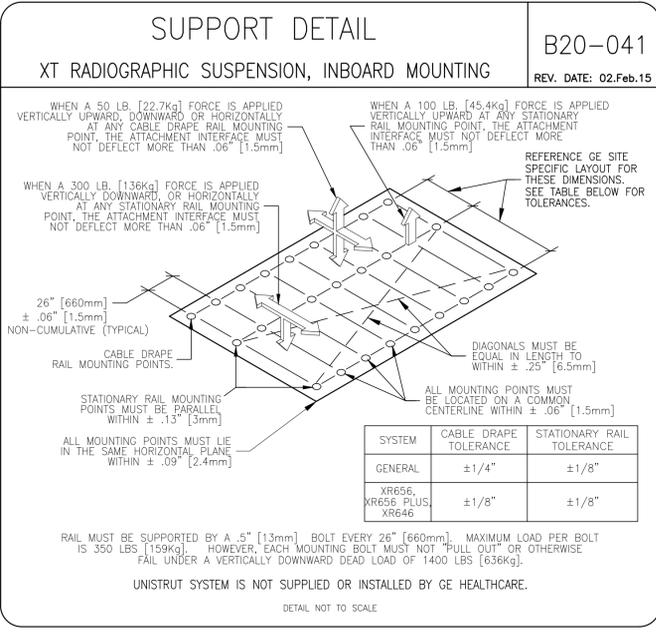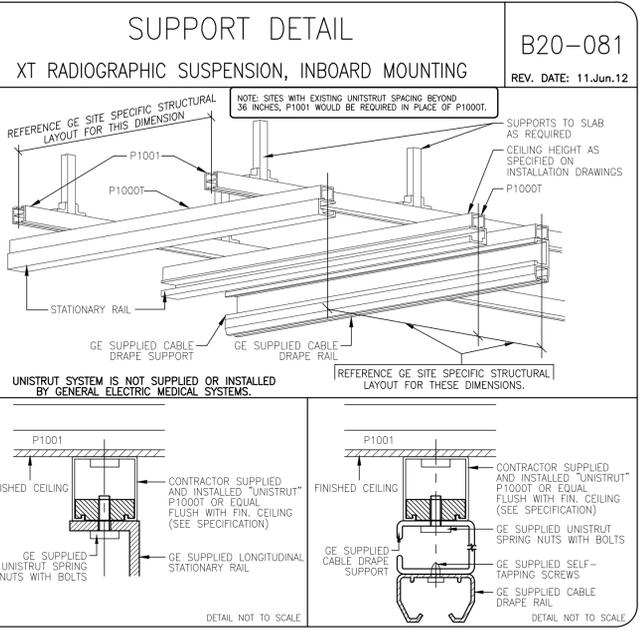B3503C
REV. DATE: 12/08/04



FLOOR MOUNTING DETAIL: PRECISION RF TABLE

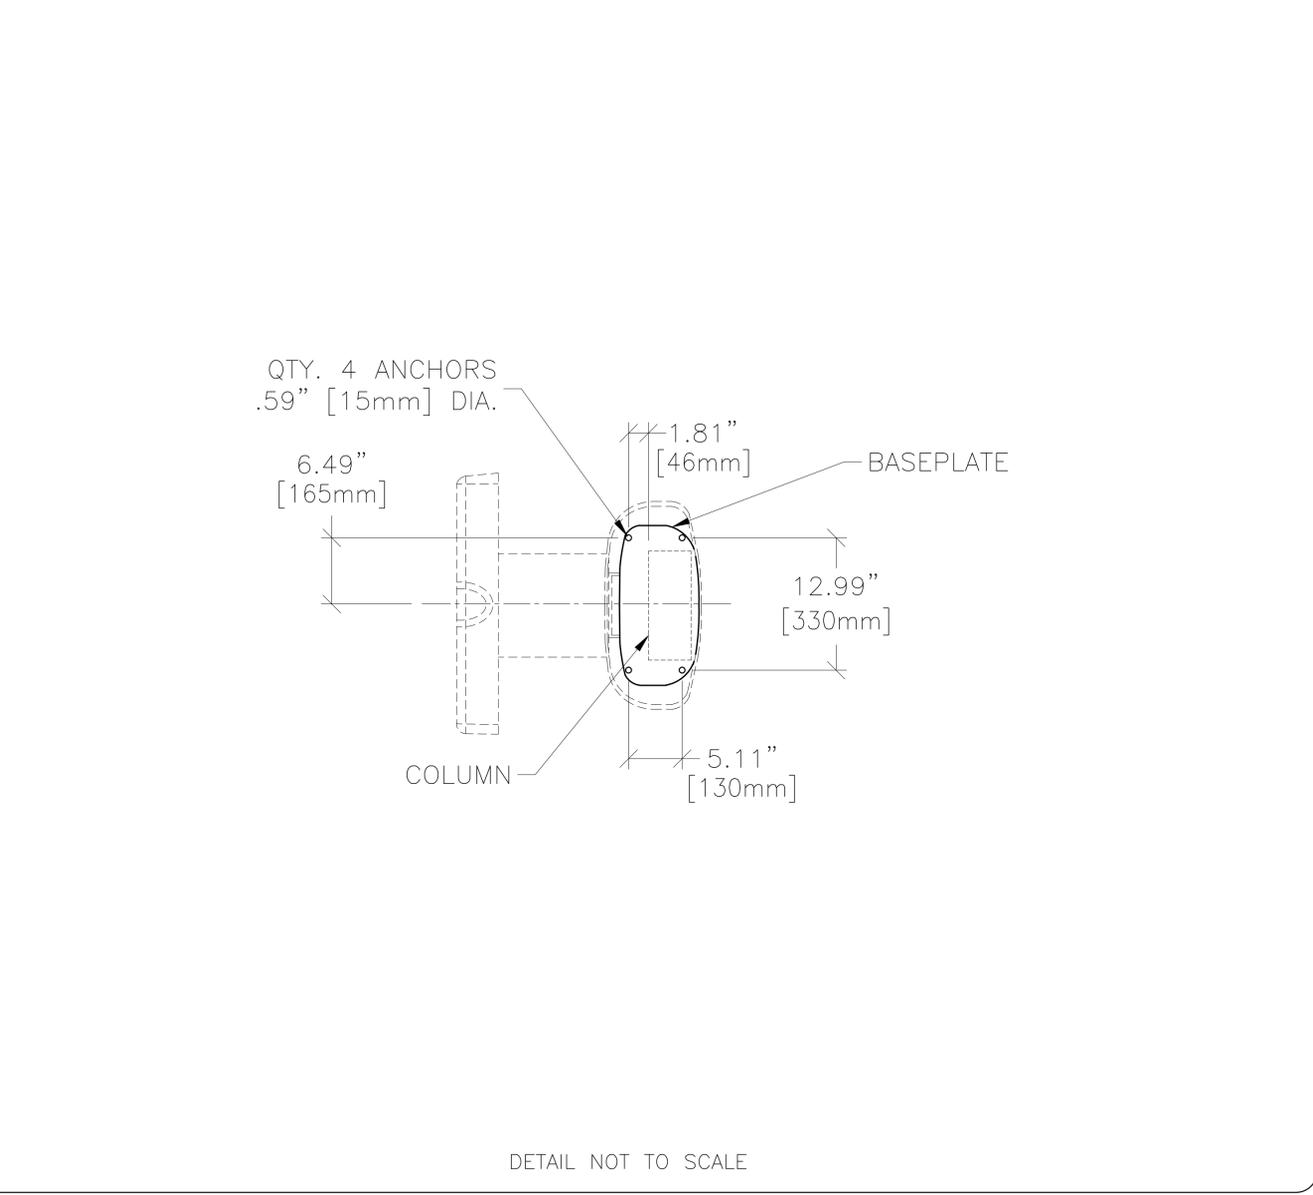B0114B
REV. DATE: 24.SEP.15



GE Healthcare

Healthcare Project Implementation - Design Center
Milwaukee, Wisconsin

SHEET TITLE: STRUCTURAL DETAILS
MODALITY TYPE: PRECISION 500D

THIS PLAN IS SUBMITTED TO SUGGEST LOCATION OF GE HEALTHCARE EQUIPMENT AND ASSOCIATED APPARATUS, ELECTRICAL WIRING DETAILS AND ROOM ARRANGEMENTS. THE USER SHALL BE RESPONSIBLE FOR VERIFYING THE ACCURACY OF THE INFORMATION TO ACTUAL EQUIPMENT EXPECTED TO BE INSTALLED. IT IS NOT TO BE USED FOR ACTUAL CONSTRUCTION PURPOSES, HOWEVER, AND THE COMPANY CANNOT ACCEPT RESPONSIBILITY FOR ANY DAMAGES RESULTING THEREFROM.

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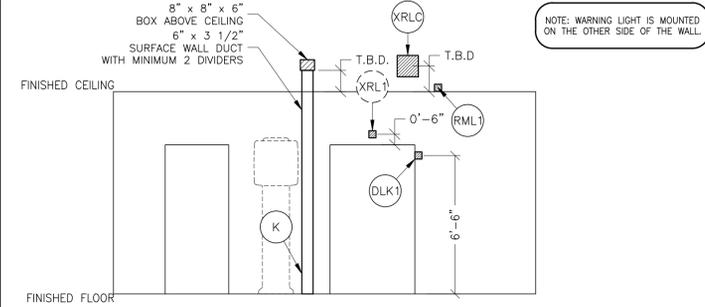
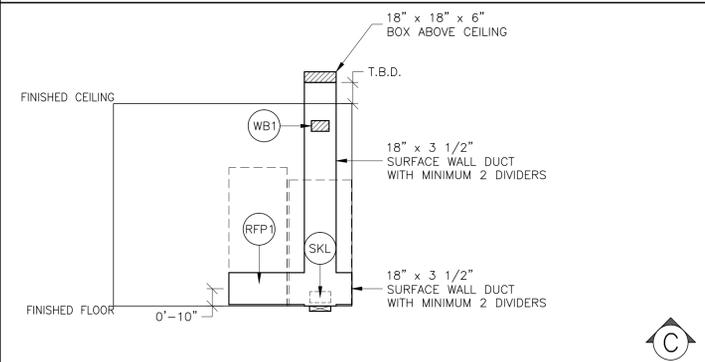
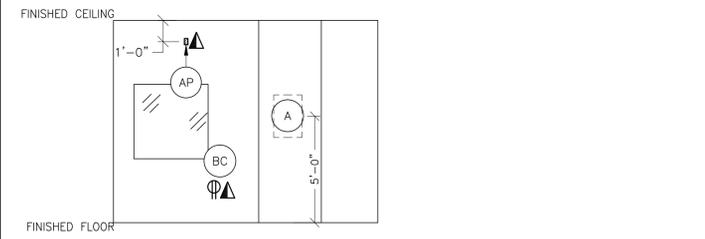
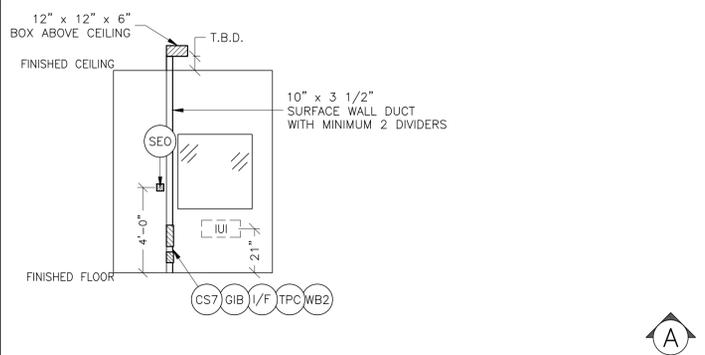
SHEET
S2

This drawing is based on Sketch No.: s16-1037
PIM R3, RA
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SCALE: 1/4" = 1'-0"


ELECTRICAL PLAN

EXISTING CEILING HEIGHT = 9'-6"



NOTE: WARNING LIGHT IS MOUNTED ON THE OTHER SIDE OF THE WALL.

- ### JUNCTION POINT NOTES
- ALL JUNCTION BOXES, CONDUIT, DUCT, DUCT DIVIDERS, SWITCHES, CIRCUIT BREAKERS, CABLE TRAY, ETC., ARE TO BE SUPPLIED AND INSTALLED BY CUSTOMER'S ELECTRICAL CONTRACTOR.
 - CONDUIT AND DUCT RUNS SHALL HAVE SWEEP RADIUS BENDS.
 - CONDUITS AND DUCT ABOVE CEILING OR BELOW FINISHED FLOOR MUST BE INSTALLED AS NEAR TO CEILING OR FLOOR AS POSSIBLE TO REDUCE RUN LENGTH.
 - CEILING MOUNTED JUNCTION BOXES ILLUSTRATED ON THIS PLAN MUST BE INSTALLED FLUSH WITH FINISHED CEILING.
 - ALL DUCTWORK MUST MEET THE FOLLOWING REQUIREMENTS:
 - DUCTWORK SHALL BE METAL WITH DIVIDERS AND HAVE REMOVABLE, ACCESSIBLE COVERS.
 - DUCTWORK SHALL BE CERTIFIED/RATED FOR ELECTRICAL POWER PURPOSES.
 - DUCTWORK SHALL BE ELECTRICALLY AND MECHANICALLY BONDED TOGETHER IN AN APPROVED MANNER.
 - PVC AS A SUBSTITUTE MUST BE USED IN ACCORDANCE WITH ALL LOCAL AND NATIONAL CODES.
 - ALL OPENINGS IN ACCESS FLOORING ARE TO BE CUT OUT AND FINISHED OFF WITH GROMMET MATERIAL BY THE CUSTOMER'S CONTRACTOR.
 - GENERAL CONTRACTOR TO INSERT PULL CORDS FOR ALL CABLE RUN CONDUITS BETWEEN THE EQUIPMENT ROOM AND THE OPERATORS CONTROL ROOM.
 - 10 FOOT PIGTAILS AT ALL JUNCTION POINTS.
 - ALL WIRING MUST BE THHN OR TFFN STRANDED COPPER THERMOPLASTIC 600 VOLT OR EQUIVALENT INSULATION. **ALUMINUM OR SOLID WIRES ARE NOT ALLOWED.**
 - GROUNDING IS CRITICAL TO EQUIPMENT FUNCTION AND PATIENT SAFETY. SITE MUST CONFORM TO WIRING SPECIFICATIONS SHOWN ON THIS PLAN.

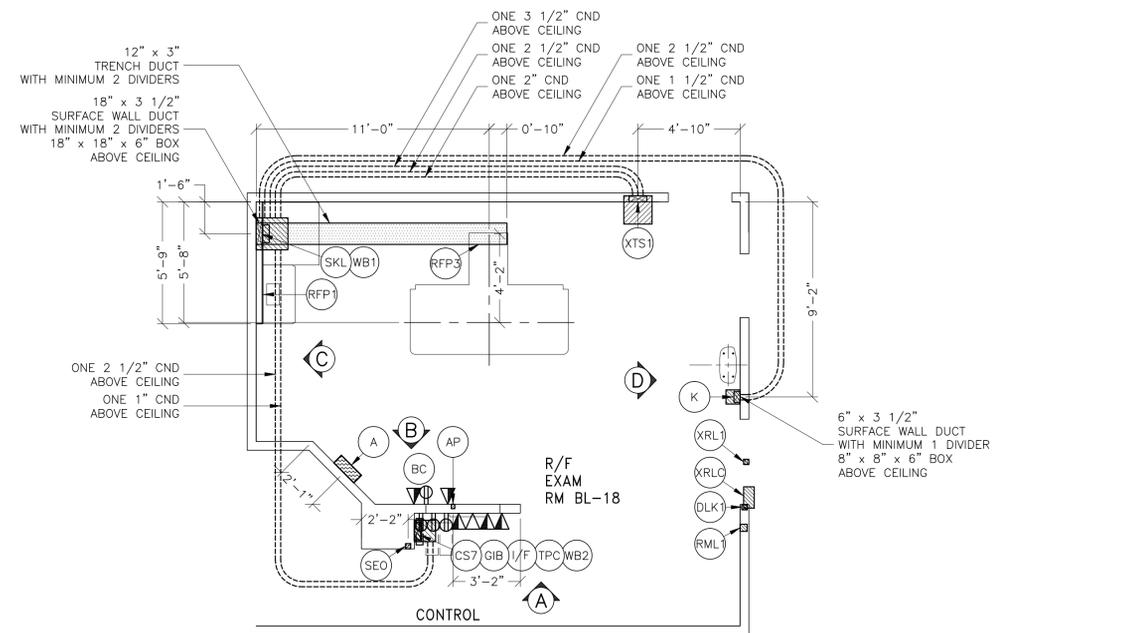

JUNCTION POINT DESCRIPTIONS

POINT	DESCRIPTION	QTY.	HARDWARE	DETAIL NO., SHT. E3
A	MAIN DISCONNECT	1	PANEL INCLUDED IN ORDER ONE REMOTE EMERGENCY OFF (SEO) PUSHBUTTON AND STAINLESS STEEL WALL PLATE STATION ARE WITH EACH MAIN DISCONNECT	ELEC-15
AP	AERO DR ACCESS POINT	1	SINGLE GANG BOX COVERPLATE 1 1/2 IN. DIA. CHASE NIPPLE	ELEC-8
BC	AERO DR DOCKING STATION/BATTERY CHARGER	1	REFER TO INTERCONNECT DIAGRAM ON E2 PAGE	
CS7	AERO DR CONTROLLER CS-7	1	REFER TO INTERCONNECT DIAGRAM ON E2 PAGE	
DLK1	DOOR SWITCH (NEEDED ONLY IF REQUIRED BY STATE/LOCAL CODES)	1	ROOM DOOR INTERLOCK LIMIT SWITCH IN FRAME NORMALLY OPEN (24V) 1 SINGLE GANG BOX	ELEC-5
GIB	AERO DR GENERATOR INTERFACE UNIT	1	REFER TO INTERCONNECT DIAGRAM ON E2 PAGE	
I/F	AERO DR INTERFACE UNIT	1	18 IN. OF GROMMET MATERIAL FOR A 3 X 3 IN. OPENING IN DUCT COVER	ELEC-5
K	CHEST UNIT	1	12 IN. OF GROMMET MATERIAL FOR A 3 X 3 IN. OPENING IN DUCT COVER	ELEC-5
RFP3	POSITIONER CABINET	1	32 IN. OF GROMMET MATERIAL FOR COVER AN 8 X 8 IN. OPENING IN DUCT COVER	ELEC-5
RFP3	X-RAY TABLE	3	3 1/2 IN. NIPPLES, 1 1/2 IN. LONG	ELEC-25
RML1	ROOM LIGHTS	1	COVERPLATE SINGLE GANG BOX UTILIZES E4502SS, SEE 'XRLC' DESCRIPTION	ELEC-17
SEO	EMERGENCY OFF	1	PROVIDE A SINGLE GANG, 2 1/2 IN. DEEP, FLUSH MTD. WALL BOX.	ELEC-16
SKL	SYSTEMS CABINET	1	32 IN. OF GROMMET MATERIAL FOR AN 8 X 8 IN. OPENING IN DUCT COVER	ELEC-5
TPC	TIMMS 2000 COMPUTER & MONITOR	1	10 X 6 X 4 IN. WALL BOX	ELEC-111
WB1	IN-ROOM MONITOR WALLBOX	1	WALL BOX FOR TVS 10 X 6 X 4 IN. WALL BOX	ELEC-28
WB2	OPERATORS CONSOLE	1	SPLIT COVERPLATE 12 X 12 X 4 IN. WALL BOX	ELEC-7
XRL1	WARNING LIGHT	1	X-RAY ON INCANDESCENT LIGHT FIXTURE DO NOT USE FLUORESCENT FIXTURES GE CAT. NO. X184WV-DF-X1U	ELEC-28
XRLC	WARNING LIGHT CONTROLLER AVAILABLE FROM GEHC, CALL 800-275-7925 OR LOCAL GE INSTALLATION PROJECT MGR	1	E4502SS WARNING LIGHT & ROOM LIGHT CONTROL MAX 24V CONTROLLER	ELEC-17
XTS1	X-RAY TUBE HANGER	1	32 IN. OF GROMMET MATERIAL FOR AN 8 X 8 IN. OPENING IN DUCT COVER	ELEC-5

JEDI BOX SYSTEMS CABINET

REV. DATE: 04/24/07

• CALCULATIONS BASED UPON NOMINAL VOLTAGE, WIRE SIZE IN AWG.
 • RECOMMENDED FEEDER SIZES FROM DISTRIBUTION TRANSFORMER TO THE POWER CABINET
 • NEUTRAL MUST BE TERMINATED INSIDE THE MAIN DISCONNECT PANEL AND NOT AT ANY GE CABINET
 • THE GROUNDING CONDUCTOR WILL BE OF SAME SIZE AS THE FEEDER WITH A 1/0 MINIMUM. THIS GROUND WILL RUN FROM THE EQUIPMENT BACK TO THE FACILITY POWER SOURCE/MAIN GROUNDING POINT AND ALWAYS TRAVEL IN THE SAME CONDUIT WITH THE FEEDERS AND NEUTRAL.
 • * MINIMUM WIRE SIZE FOR CIRCUIT BREAKER, BASED ON RECOMMENDED OVERCURRENT PROTECTION.
 • FOR A FULL SYSTEM UPS, REFER TO ELECTRICAL DETAILS FOR UPS FEEDER WIRES.

RUN LENGTH IN FEET	POWER SUPPLY VOLTAGE					
	342-418	360-440	373-456	396-484	414-506	432-528
	380	400	420	440	460	480
	SIZE OF FEEDERS AND GROUND WIRES (AWG)					
	FEEDER	GROUND	FEEDER	GROUND	FEEDER	GROUND
50	• 2 (1/0)	• 2 (1/0)	• 2 (1/0)	• 2 (1/0)	• 2 (1/0)	• 2 (1/0)
100	• 2 (1/0)	• 2 (1/0)	• 2 (1/0)	• 2 (1/0)	• 2 (1/0)	• 2 (1/0)
150	1/0 (1/0)	1 (1/0)	1 (1/0)	• 2 (1/0)	• 2 (1/0)	• 2 (1/0)
200	2/0 (2/0)	2/0 (2/0)	1/0 (1/0)	1/0 (1/0)	1 (1/0)	1 (1/0)
250	3/0 (3/0)	3/0 (3/0)	2/0 (2/0)	2/0 (2/0)	1/0 (1/0)	1/0 (1/0)
300	4/0 (4/0)	4/0 (4/0)	3/0 (3/0)	3/0 (3/0)	2/0 (2/0)	2/0 (2/0)
350	300M (300M)	250M (250M)	4/0 (4/0)	4/0 (4/0)	3/0 (3/0)	3/0 (3/0)
400	350M (350M)	300M (300M)	250M (250M)	250M (250M)	4/0 (4/0)	4/0 (4/0)
450	400M (400M)	350M (350M)	300M (300M)	250M (250M)	250M (250M)	4/0 (4/0)

ADDITIONAL CONDUIT RUNS FOR PRECISION 5000 (BY CONTRACTOR)

CONDUITS REQUIRED FOR BASE SYSTEM (CONDUITS ARE LOCATED ABOVE CEILING)

REV. DATE: 02 SEP 14

XRLC	TO	RML1	ONE 1/2" CND.
XRLC	TO	XRL1	ONE 1/2" CND.
XRLC	TO	SKL	ONE 1/2" CND.
XRLC	TO	SKL	ONE 1/2" CND. AS REQ'D
DLK1	TO	SKL	ONE 1/2" CND.
A	TO	SKL	ONE CND. AS REQ'D
A	TO	FEEDER	ONE CND. AS REQ'D
A	TO	SEO	ONE 1/2" CND.
SEO	TO	SKL	ONE 1/2" CND.
SKL	TO	WB2	ONE 2" CND. (FLORIDA ONLY) (additional cnd. (total of 3 cnd) - 2 shown on plan)

NOTE: SEE EQUIPMENT LIST FOR CALL OUTS

CONDUITS BY CONTRACTOR REQUIRED FOR KM AERODR WIRELESS DIGITAL DETECTOR SYSTEM (CONDUITS ARE LOCATED ABOVE CEILING)

REV. DATE: 08 JUN 15

I/F	TO	AP	ONE 1/2" CND.
GIB	TO	I/F	ONE 1/2" CND., OR EXTERNALLY CONNECT

NOTE: SEE E2 PAGE FOR MAXIMUM RUN LENGTHS

- ### ELECTRICAL OUTLET LEGEND
- CUSTOMER/CONTRACTOR SUPPLIED AND INSTALLED ITEMS. HEIGHT ABOVE FLOOR DETERMINED BY LOCAL CODES UNLESS OTHERWISE SPECIFIED.
- ⊕ DUPLEX HOSPITAL GRADE, DEDICATED OUTLET 120-V, SINGLE PHASE POWER
 - △ DEDICATED TELEPHONE LINE(S) (SEE ELECTRICAL DETAIL ELEC-1 OR ELEC-67)
 - ▲ NETWORK OUTLET (SEE ELECTRICAL DETAILS ELEC-83 AND ELEC-84 OR ELEC-87)

CONTRACTOR SUPPLIED AND INSTALLED WIRING

ELECTRICAL CONTRACTOR SHALL RING OUT, TAG AND TERMINATE ALL WIRES AT BOTH ENDS.

WIRE RUN, FROM - TO	QUANTITY, WIRE SIZE/COLOR
XRLC > I PHASE	1-NO. 14 BLACK, 1-NO. 14 WHITE, 1-NO. 14 GREEN
A > SEO	1-NO. 14 BLACK, 1-NO. 14 WHITE, 1-NO. 14 GREEN
SKL > XRLC	2-NO. 14 BLACK, 1-NO. 14 RED, 1-NO. 14 WHITE
XRLC > RML1	1-NO. 14 BLACK, 1-NO. 14 WHITE, 1-NO. 14 GREEN
XRL1 > XRLC	1-NO. 14 BLACK, 1-NO. 14 WHITE, 1-NO. 14 GREEN
A > SKL	REFER TO FEEDER TABLE
480-V > A	3-BLACK, 1 GREEN - REFER TO FEEDER TABLE

GE Project Manager: JACOB BRAVO
 Telephone: 303-229-3519
 THE GE WITH TECHNICAL SUPPORT GROUP IS AN ADDITIONAL RESOURCE THAT CAN PROVIDE ANSWERS FOR GENERAL USE PRODUCT SIZING QUESTIONS AND CAN BE REACHED AT (877)-305-9677 OR MAILTO:HTTech@GE.com

This drawing is based on Sketch No.: s16-1037

PIM R3, RA RQ - DC-38938

GE Healthcare
 Healthcare Project Implementation - Design Center
 Milwaukee, WI

SHEET TITLE: ELECTRICAL LAYOUT
 MODALITY TYPE: PRECISION 5000
 THIS PLAN IS SUBMITTED TO SUGGEST LOCATION OF GE HEALTHCARE EQUIPMENT AND ASSOCIATED ELECTRICAL WIRING DETAILS AND ROOM ARRANGEMENTS. THE CONTRACTOR SHALL VERIFY THE LOCATION OF ALL EQUIPMENT AND WIRING TO ACTUAL CONSTRUCTION PURPOSES. HOWEVER, AND THE COMPANY CANNOT ACCEPT RESPONSIBILITY FOR ANY DAMAGES RESULTING THEREFROM.

PROJECT TITLE: Cheyenne V A Medical Center
 Cheyenne, WY

PROJECT	REVISION
M032678	00A
DATE:	18.Dec.17
DRAWN BY:	GSP
CHECKED BY:	GSP
GON NO:	4562866
GON DT:	18.Sep.17


REVISION HISTORY:

SHEET
E1

**ELECTRICAL DETAIL
HORIZONTAL WALL DUCT (TYPICAL)**

ELEC-5

REV. DATE: 03/19/04

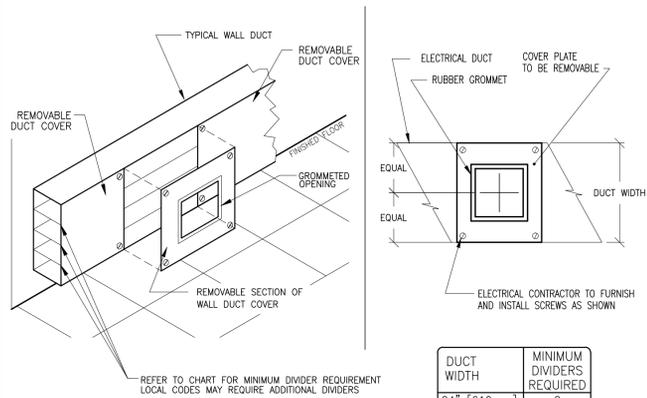


DUCT WIDTH	MINIMUM DIVIDERS REQUIRED
24" [610mm]	2
18" [457mm]	2
10" [254mm]	2
6" [152mm]	1
4" [102mm]	1

DETAIL NOT TO SCALE

**ELECTRICAL DETAIL
VERTICAL WALL DUCT (TYPICAL)**

ELEC-6

REV. DATE: 03/19/04

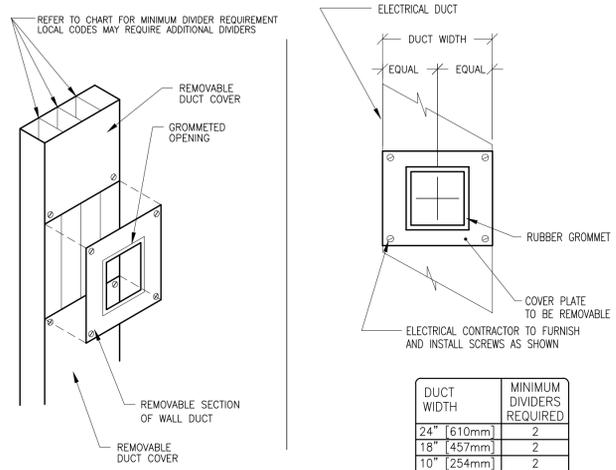


DUCT WIDTH	MINIMUM DIVIDERS REQUIRED
24" [610mm]	2
18" [457mm]	2
10" [254mm]	2
6" [152mm]	1
4" [102mm]	1

DETAIL NOT TO SCALE

**ELECTRICAL DETAIL
BOX WITH COVERPLATE AND NETWORK JACK**

ELEC-83

REV. DATE: 10/06/98

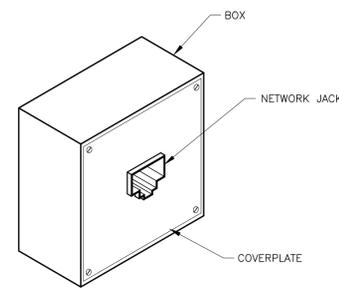


DETAIL NOT TO SCALE

**ELECTRICAL DETAIL
NETWORK CONNECTION (TYPICAL)**

ELEC-84

REV. DATE: 17Jun.16

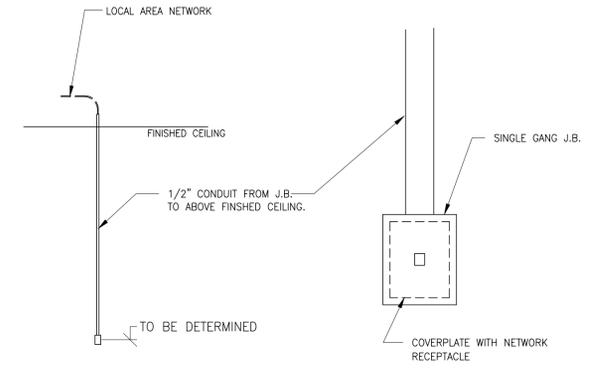


DETAIL NOT TO SCALE

**ELECTRICAL DETAIL
BOX WITH COVERPLATE (TYPICAL)**

ELEC-8

REV. DATE: 09/30/94

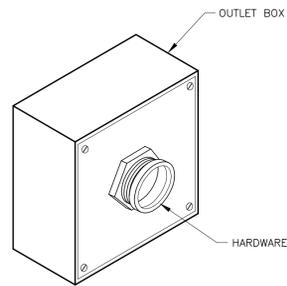


DETAIL NOT TO SCALE

**ELECTRICAL DETAIL
J.B. / WALL DUCT DETAIL (TYPICAL)**

ELEC-2

REV. DATE: 02Jan.15

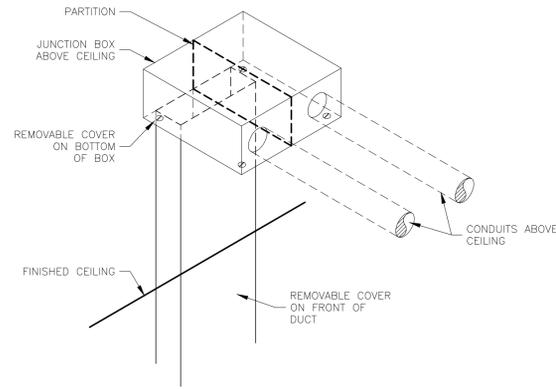


DETAIL NOT TO SCALE

**ELECTRICAL DETAIL
BOX ON DUCT (TYPICAL)**

ELEC-28

REV. DATE: 04/09/98

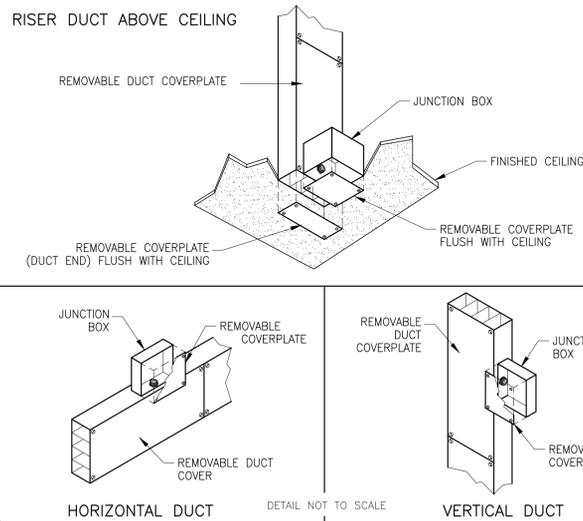


DETAIL NOT TO SCALE

**ELECTRICAL DETAIL
MONITOR WALL PLATE**

ELEC-110

REV. DATE: 01/18/07

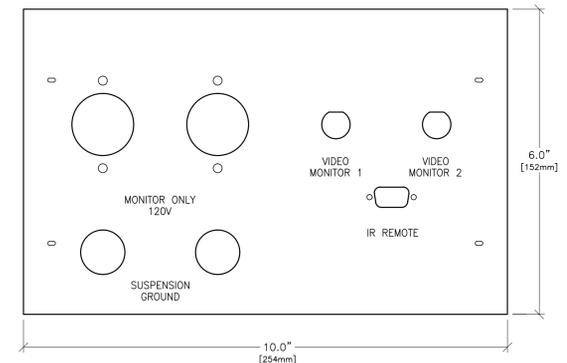


DETAIL NOT TO SCALE

**ELECTRICAL DETAIL
FLUSH FLOOR DUCT (TYPICAL)**

ELEC-25

REV. DATE: 4/01/04

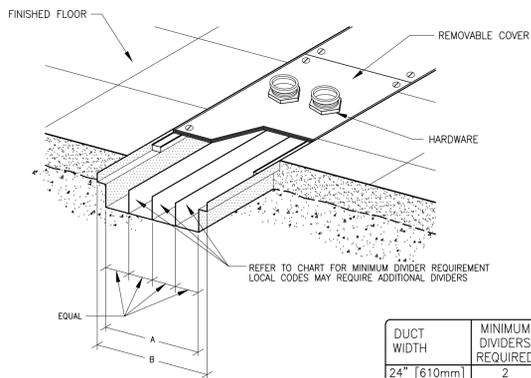

DUCT WIDTH	MINIMUM DIVIDERS REQUIRED
24" [610mm]	2
18" [457mm]	2
10" [254mm]	2
6" [152mm]	1
4" [102mm]	1



DETAIL NOT TO SCALE

12" TRENCH DUCT: A = 10", B = 12"
18" TRENCH DUCT: A = 18", B = 20"

**ELECTRICAL DETAIL
X-RAY WARNING LIGHT & ROOM LIGHT CONTROL PANEL**

ELEC-17

REV. DATE: 10.APR.13

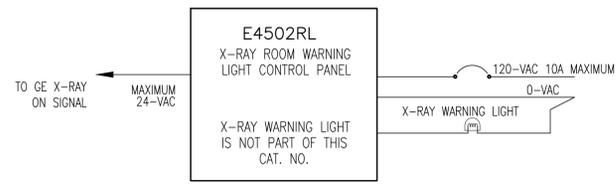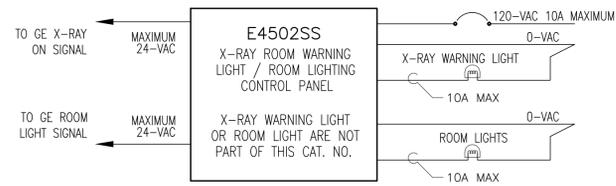


CONTROL PANEL CAN BE LOCATED ABOVE THE CEILING NEAR THE WARNING LIGHT
UNLESS SPECIFIED ON SHEET A1 AS BEING INCLUDED ON EQUIPMENT ORDER,
ALL ITEMS ILLUSTRATED ARE TO BE FURNISHED AND INSTALLED BY CUSTOMER'S CONTRACTOR

**ELECTRICAL DETAIL
EMERGENCY OFF BUTTON**

ELEC-16

REV. DATE: 05/14/09

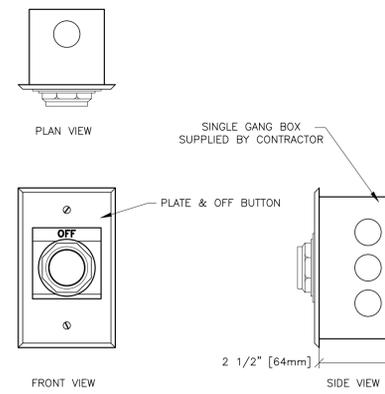


DETAIL NOT TO SCALE

**ELECTRICAL DETAIL
ROOM POWER SUPPLY**

ELEC-116

REV. DATE: 10/27/08

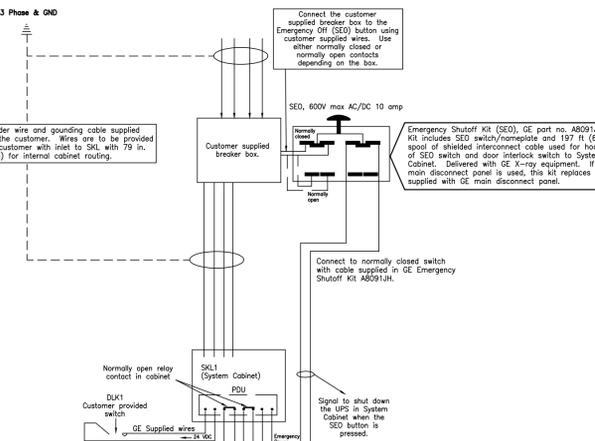

DETAIL NOT TO SCALE

This drawing is based on Sketch No.: s16-1037
PIM R3, RA
RQ - DC-38938

SHEET TITLE: ELECTRICAL DETAILS
MODALITY TYPE: PRECISION 5000

THIS PLAN IS SUBMITTED TO SUGGEST LOCATION OF GE HEALTHCARE EQUIPMENT AND ASSOCIATED ELECTRICAL WIRING DETAILS AND ROOM ARRANGEMENTS. THE CONTRACTOR SHALL VERIFY ALL DIMENSIONS AND CONDITIONS FOR THE ACTUAL EQUIPMENT EXPECTED TO BE INSTALLED. THIS IS NOT TO BE USED FOR ACTUAL CONSTRUCTION PURPOSES, HOWEVER, AND THE COMPANY CANNOT ACCEPT RESPONSIBILITY FOR ANY DAMAGES RESULTING THEREFROM.


GE Healthcare
 Healthcare Project Implementation - Design Center
 Milwaukee, Wisconsin

PROJECT TITLE:
**Cheyenne V A
 Medical Center**
 Cheyenne, WY

PROJECT	REVISION
M032678	00A
DATE:	18.Dec.17
DRAWN BY:	GSP
CHECKED BY:	GSP
GON NO:	4562866
GON DT:	18.Sep.17


REVISION HISTORY:

SHEET
E3

ELECTRICAL DETAIL
X-RAY MAIN DISCONNECT PANEL

ELEC-15


REV. DATE: 09.MAR.15

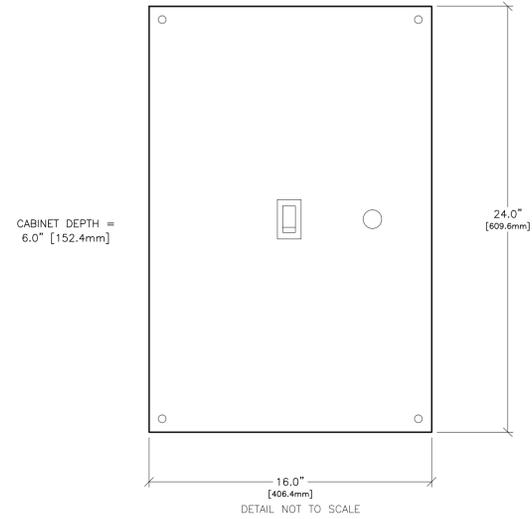

ELECTRICAL DETAIL
DVD/TIMS WALL PLATE

ELEC-111


REV. DATE: 29.OCT.12

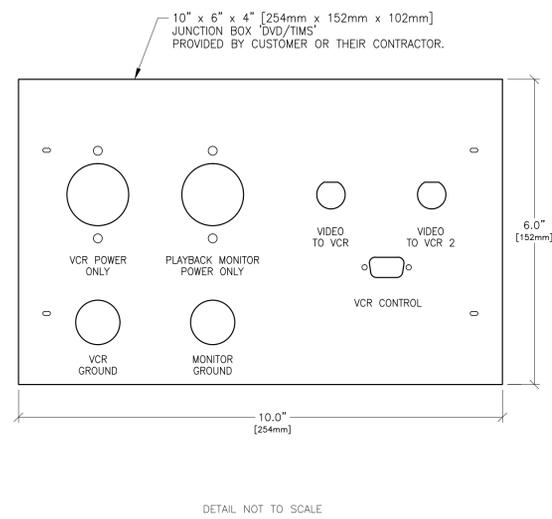

ELECTRICAL DETAIL
BOX WITH SPLIT COVERPLATE (TYPICAL)

ELEC-7

REV. DATE: 09/30/94

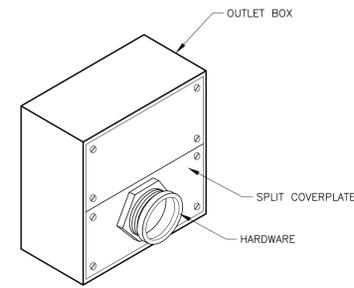


DETAIL NOT TO SCALE

EQUIPMENT DETAIL
MAGIC OPERATORS CONSOLE WALL PLATE

ELEC-144

REV. DATE: 02.SEP.14

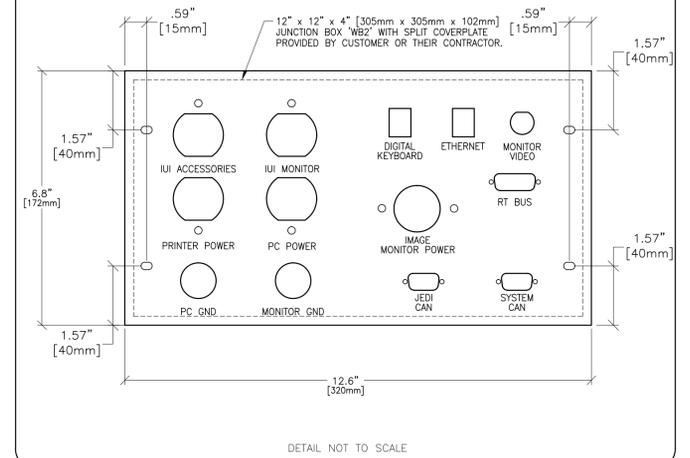

DETAIL NOT TO SCALE


ELECTRICAL DETAIL
INSITE CONNECTION (TYPICAL)

ELEC-1

REV. DATE: 04/24/02

ONE OF THE FOLLOWING TWO SELECTIONS MUST BE INSTALLED AT THE LOCATION SHOWN ON THE ELECTRICAL PLAN (SHEET E1) FOR GE INSITE CONNECTION BASED UPON SYSTEM CONFIGURATION.

- A) ONE INTERNET ACCESSIBLE VIRTUAL PRIVATE NETWORK (VPN) CONNECTION WITH A STATIC IP ADDRESS, AND ONE TELEPHONE LINE - DEDICATED-DIRECT-DIALING, VOICE GRADE.
- OR
- B) TWO TELEPHONE LINES - ONE DEDICATED DIRECT-DISTANCE-DIALING, VOICE GRADE AND ONE A DEDICATED DATA LINE.

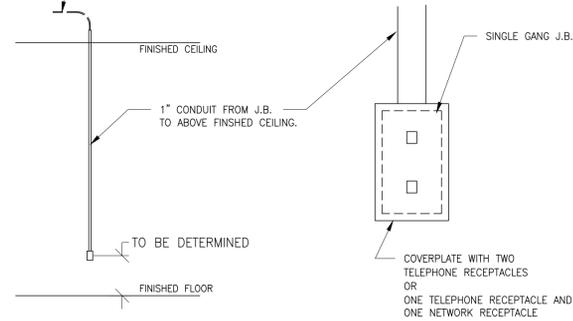

ALL ITEMS ILLUSTRATED ARE TO BE FURNISHED AND INSTALLED BY CUSTOMER OR THEIR CONTRACTOR.

DETAIL NOT TO SCALE

GE Healthcare

Healthcare Project Implementation - Design Center
Milwaukee, Wisconsin

SHEET TITLE: ELECTRICAL DETAILS

MODALITY TYPE: PRECISION 500D

THIS PLAN IS SUBMITTED TO SUGGEST LOCATION OF GE HEALTHCARE EQUIPMENT AND ASSOCIATED APPARATUS. ELECTRICAL WIRING DETAILS AND ROOM ARRANGEMENTS ARE FOR INFORMATION ONLY. GE HEALTHCARE DOES NOT GUARANTEE THE ACCURACY OF THIS INFORMATION. THE USER SHALL BE RESPONSIBLE FOR VERIFYING THE LOCATION OF ALL EQUIPMENT TO BE INSTALLED. IT IS NOT TO BE USED FOR ACTUAL CONSTRUCTION PURPOSES, HOWEVER, AND THE COMPANY CANNOT ACCEPT RESPONSIBILITY FOR ANY DAMAGES RESULTING THEREFROM.













This drawing is based on Sketch No.: s16-1037

PROJECT TITLE:
Cheyenne V A
Medical Center
Cheyenne, WY

PROJECT	REVISION
M032678	00A
DATE:	18.Dec.17
DRAWN BY:	GSP
CHECKED BY:	GSP
GON NO:	4562866
GON DT:	18.Sep.17

REVISION HISTORY:

SHEET
E4

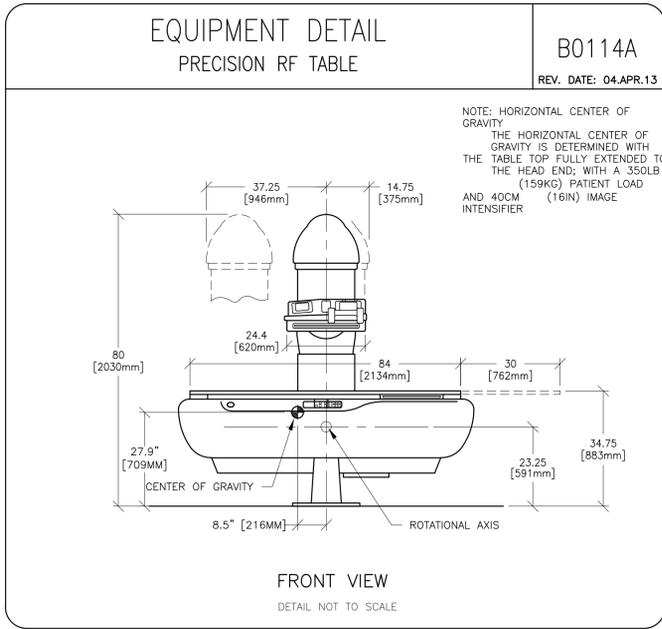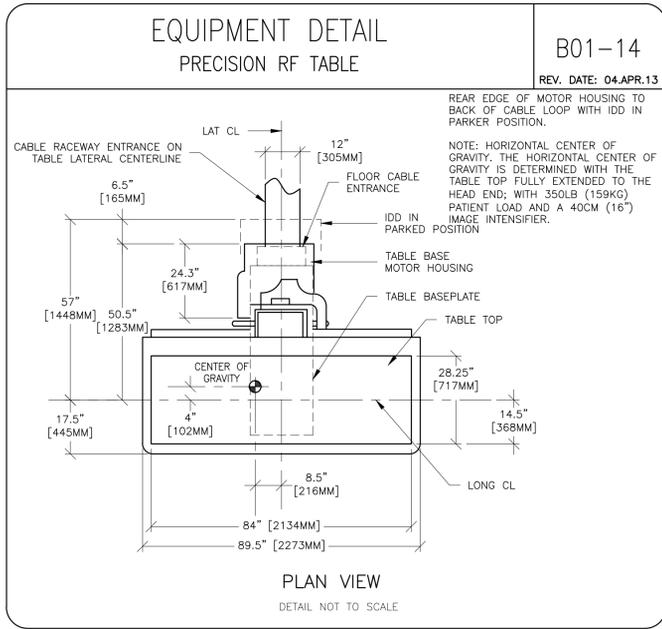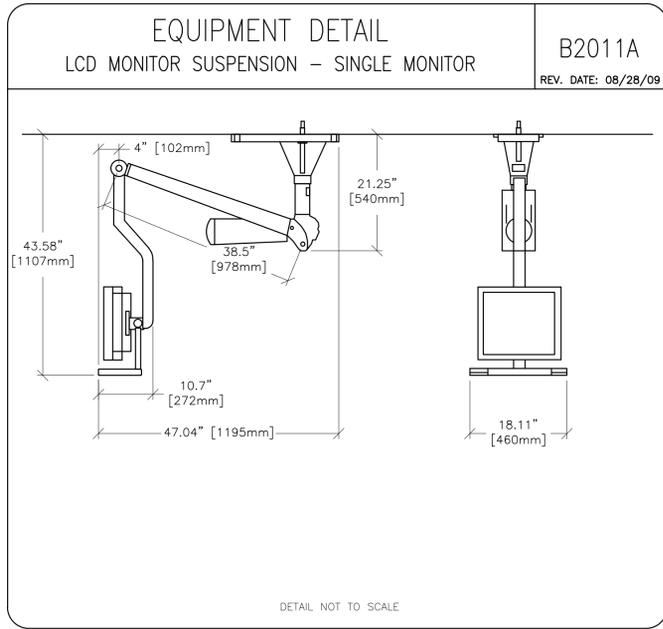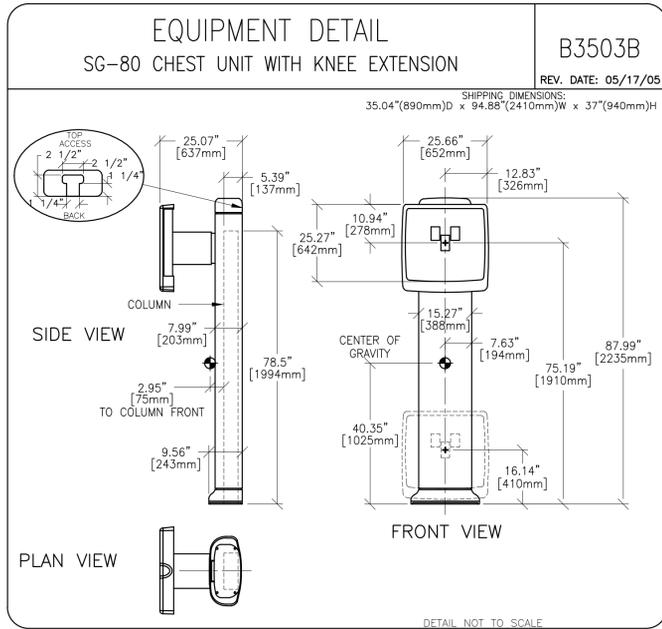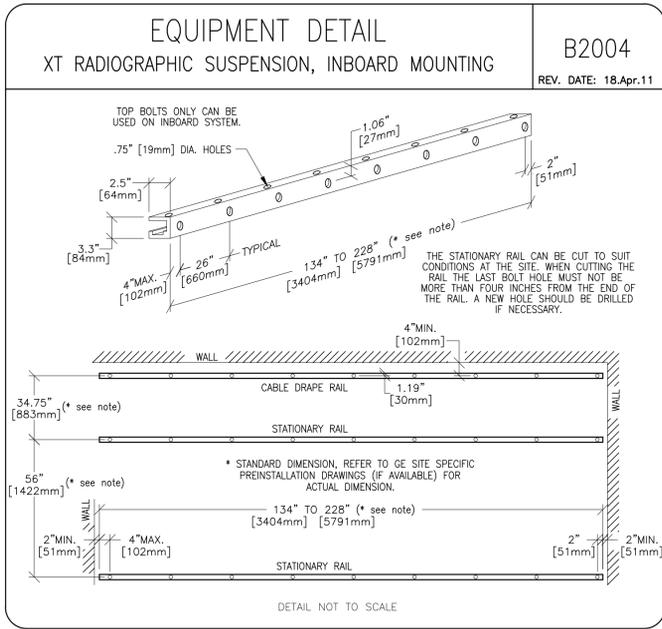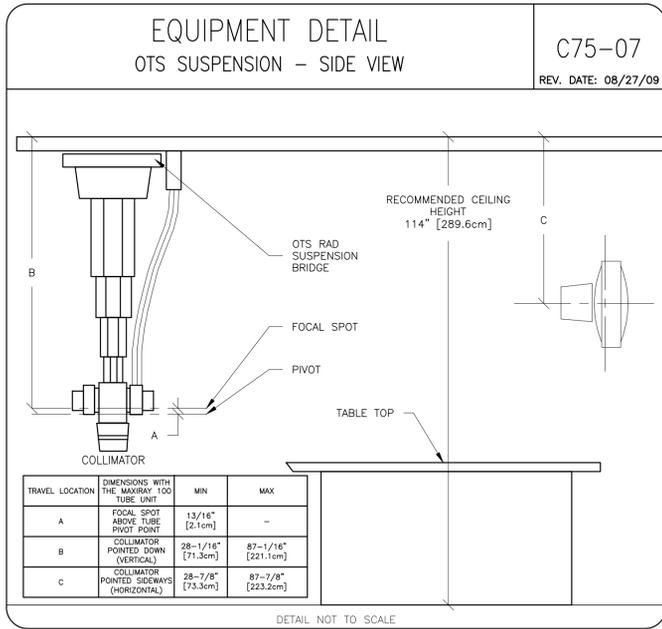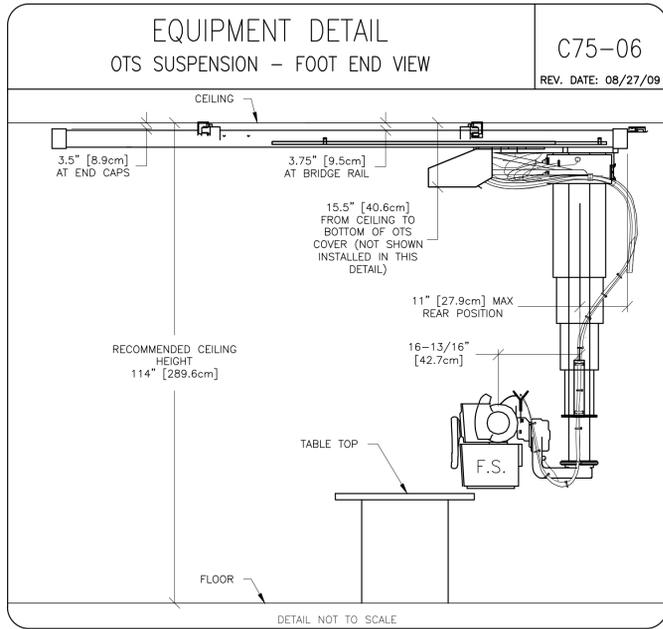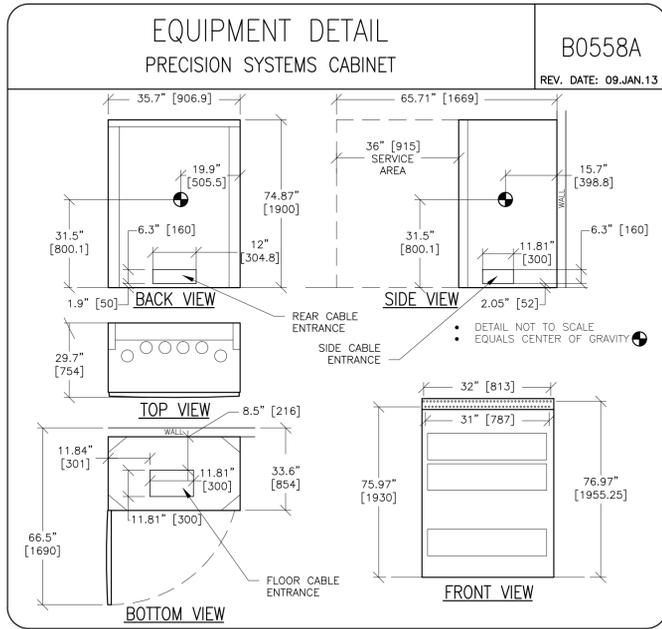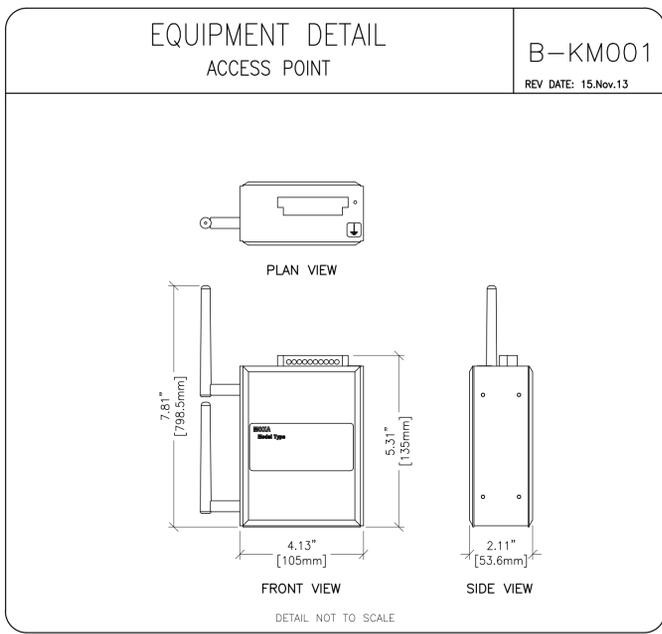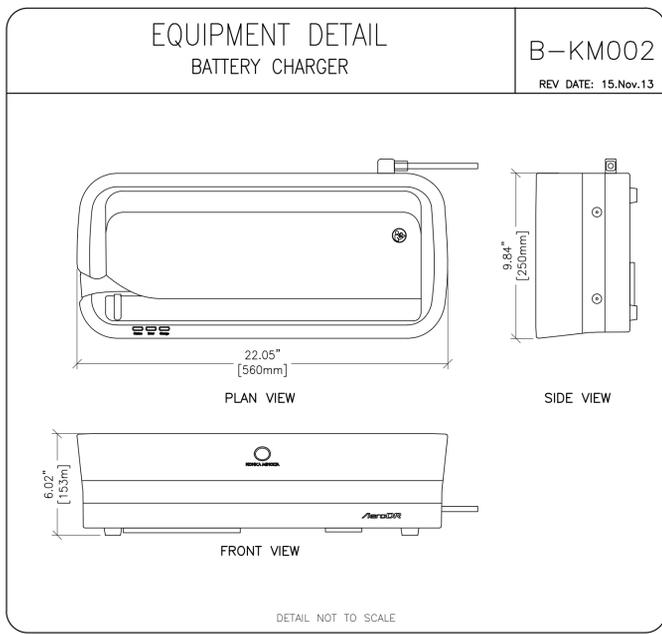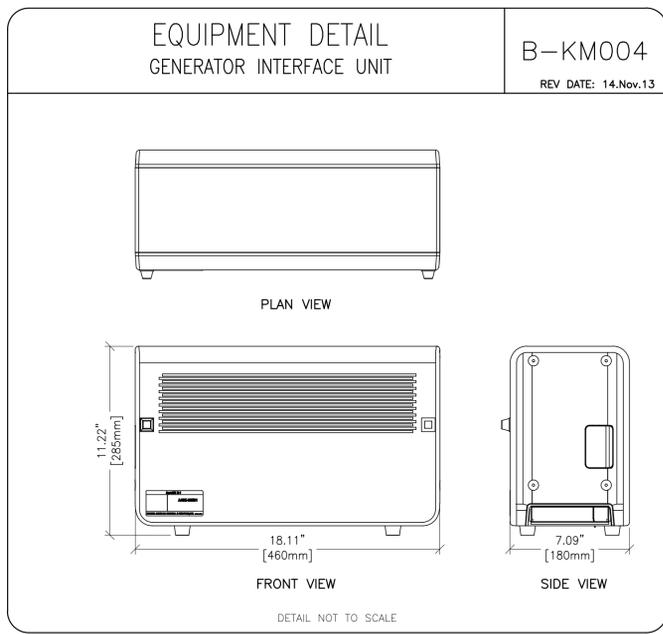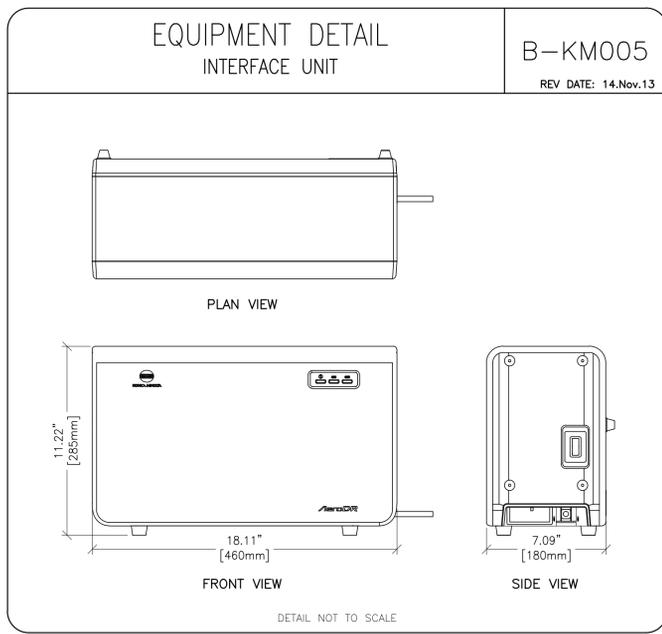

GE Healthcare

Healthcare Project Implementation - Design Center
Milwaukee, WI

SHEET TITLE: EQUIPMENT DETAILS

MODALITY TYPE: PRECISION 5000

THIS PLAN IS SUBMITTED TO SUGGEST LOCATION OF GE HEALTHCARE EQUIPMENT AND ASSOCIATED APPARATUS, ELECTRICAL WIRING DETAILS AND ROOM ARRANGEMENTS. THE USER SHALL BE RESPONSIBLE FOR VERIFYING THE LOCATION OF ALL EQUIPMENT TO BE INSTALLED. THIS PLAN IS NOT TO BE USED FOR ACTUAL CONSTRUCTION PURPOSES, HOWEVER, AND THE COMPANY CANNOT ACCEPT RESPONSIBILITY FOR ANY DAMAGES RESULTING THEREFROM.

PROJECT TITLE: Cheyenne V A Medical Center
Cheyenne, WY

This drawing is based on Sketch No.: s16-1037






PROJECT	REVISION
M032678	00A

DATE: 18.Dec.17
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D1

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GE Healthcare
Healthcare Project Implementation - Design Center
Milwaukee, Wisconsin

SHEET TITLE: EQUIPMENT DETAILS
MODALITY TYPE: PRECISION 500D

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PROJECT TITLE:
**Cheyenne V A
Medical Center**
Cheyenne, WY

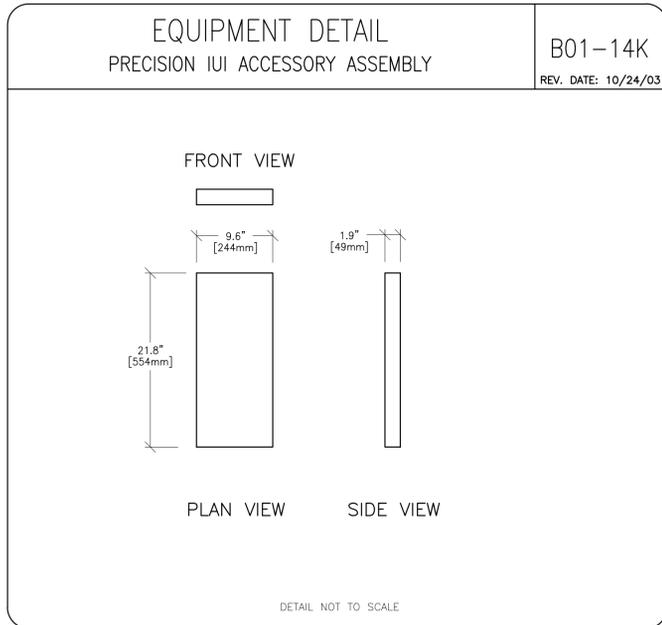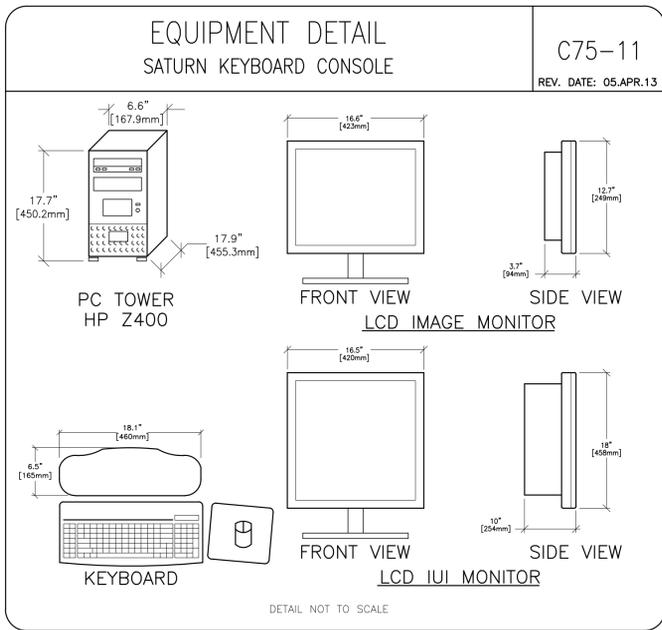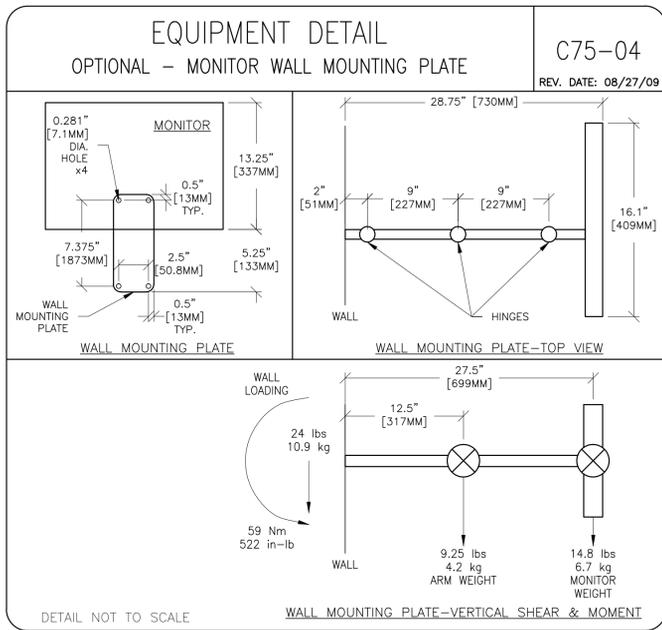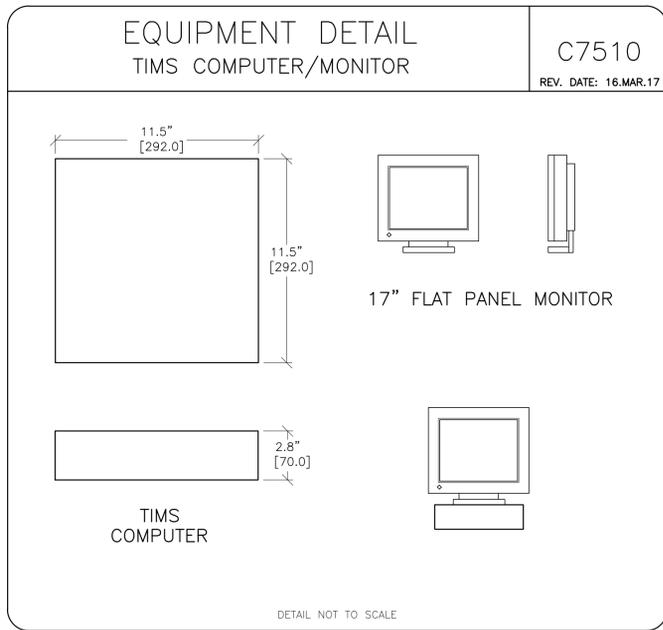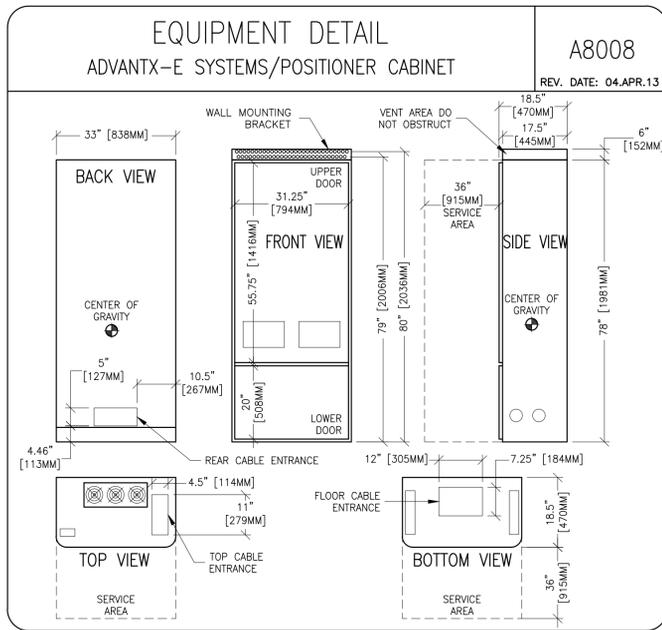PROJECT	REVISION
M032678	00A
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