



**SHEET NOTES**

- 1 PROVIDE MANUAL BALANCING DAMPERS FOR EACH INLET AND OUTLET SHOWN ON PLANS. ENSURE FULL ACCESSIBILITY TO DAMPER HANDLE.
  - 2 REFER TO DETAILS FOR DUCT WORK PRESSURE CLASS REQUIREMENTS.
- SHEET KEYNOTES**
- 1 SUPPLY DUCT FOR FUTURE CONNECTION. CAP AND SEAL DUCT END AND ENSURE FULL ACCESSIBILITY.
  - 2 SIZE SHEETMETAL DUCTWORK TO MATCH CONNECTION SIZE OF AIR TERMINAL UNIT OUTLET.

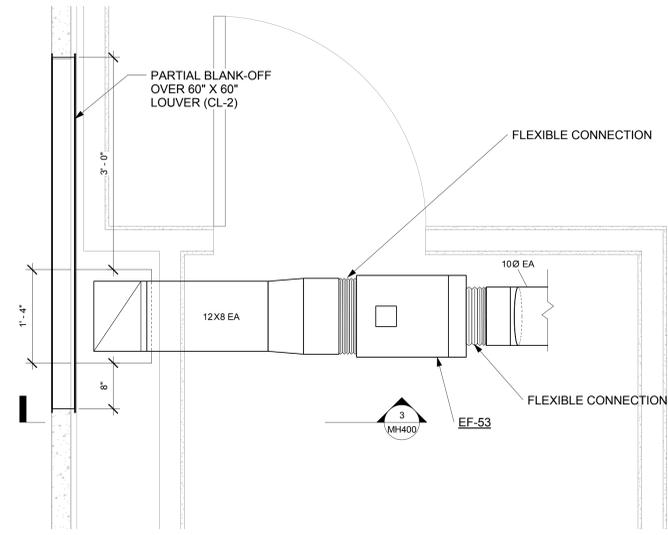


**3 ENLARGED PARTIAL PLAN - EXHAUST FAN EF-53**

1" = 1'-0"

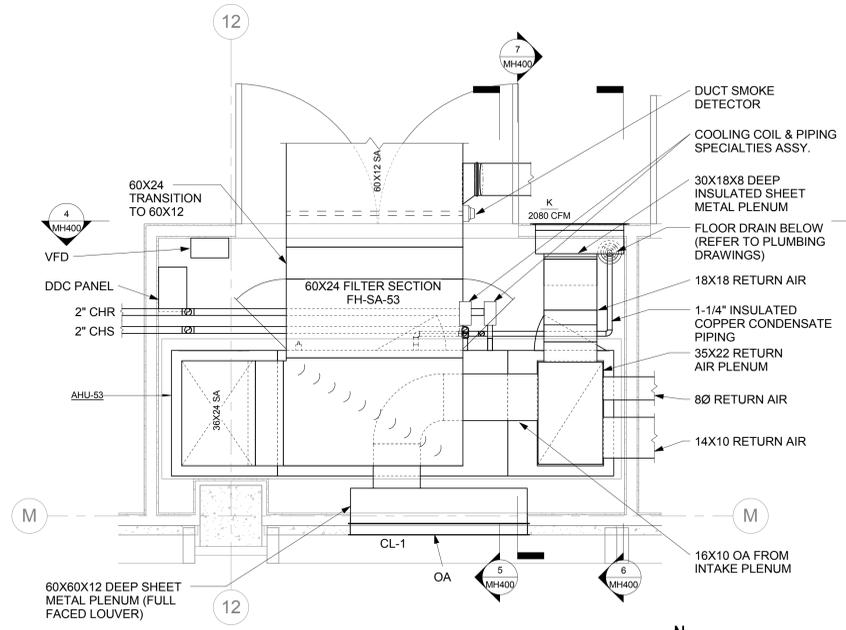


**2 ENLARGED PARTIAL PLAN - MECH. RM. C306L-1**

1/2" = 1'-0"

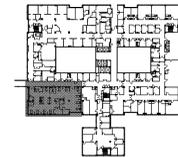

FINAL DESIGN  
APPROVED FOR CONSTRUCTION

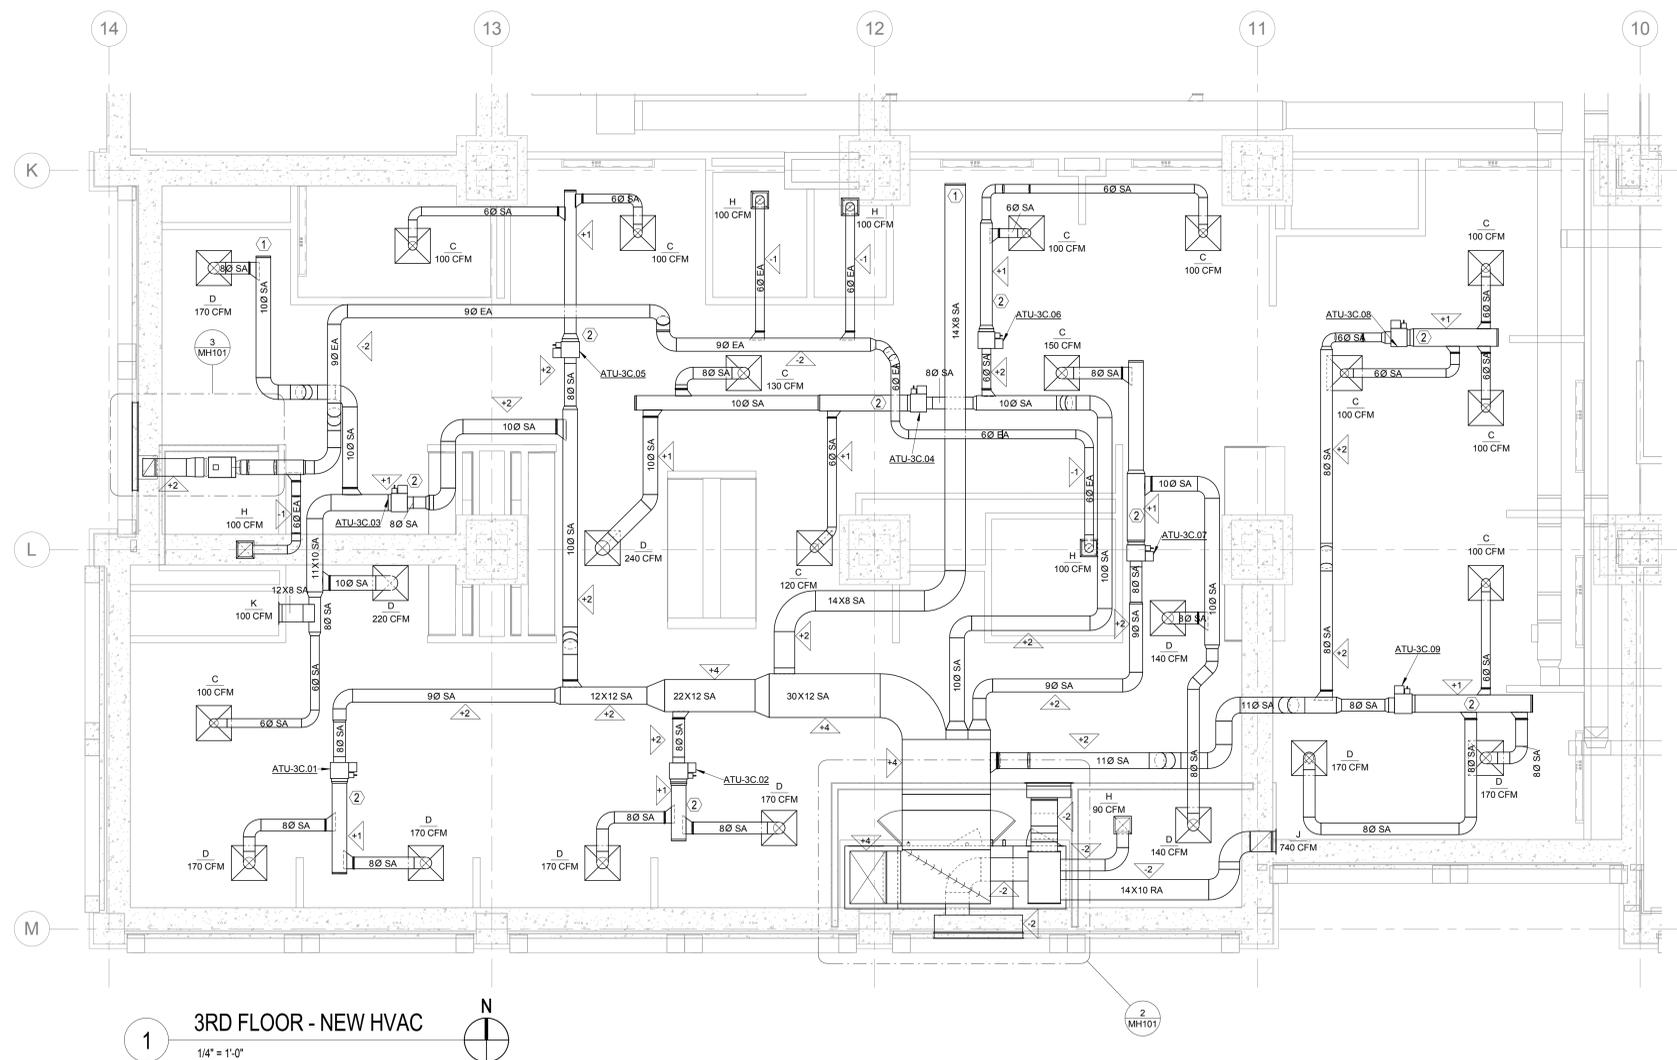

**1 3RD FLOOR - NEW HVAC**

1/4" = 1'-0"

- three inches = one foot
- one and one half inches = one foot
- one inch = one foot
- three quarters inch = one foot
- one half inch = one foot
- three eighths inch = one foot
- one quarter inch = one foot
- one eighth inch = one foot

<b>CONSULTANTS:</b> 		<b>ARCHITECT/ENGINEERS:</b> <b>AKEA</b> INC. 3603 NW 98th Street, Suite B Gainesville, FL 32606 Phone: (352) 474-6124 Fax: (352) 474-6324 COA: FL #26693 AKEA Project No. 094-14		Drawing Title <b>THIRD FLOOR HVAC PLAN - NEW WORK</b>		Project Title <b>RENOVATE WARD 3C FOR CARDIOLOGY EQUIPMENT INSTALLATION</b>		Project Number 573-CSI-102		Office of Construction and Facilities Management Department of Veterans Affairs
Approved: Project Director		Location <b>GAINESVILLE, FLORIDA</b>		Building Number 1		Drawing Number <b>MH101</b>		17 OF 62		
Date MARCH 9, 2018		Checked MGH		Drawn TJM						