
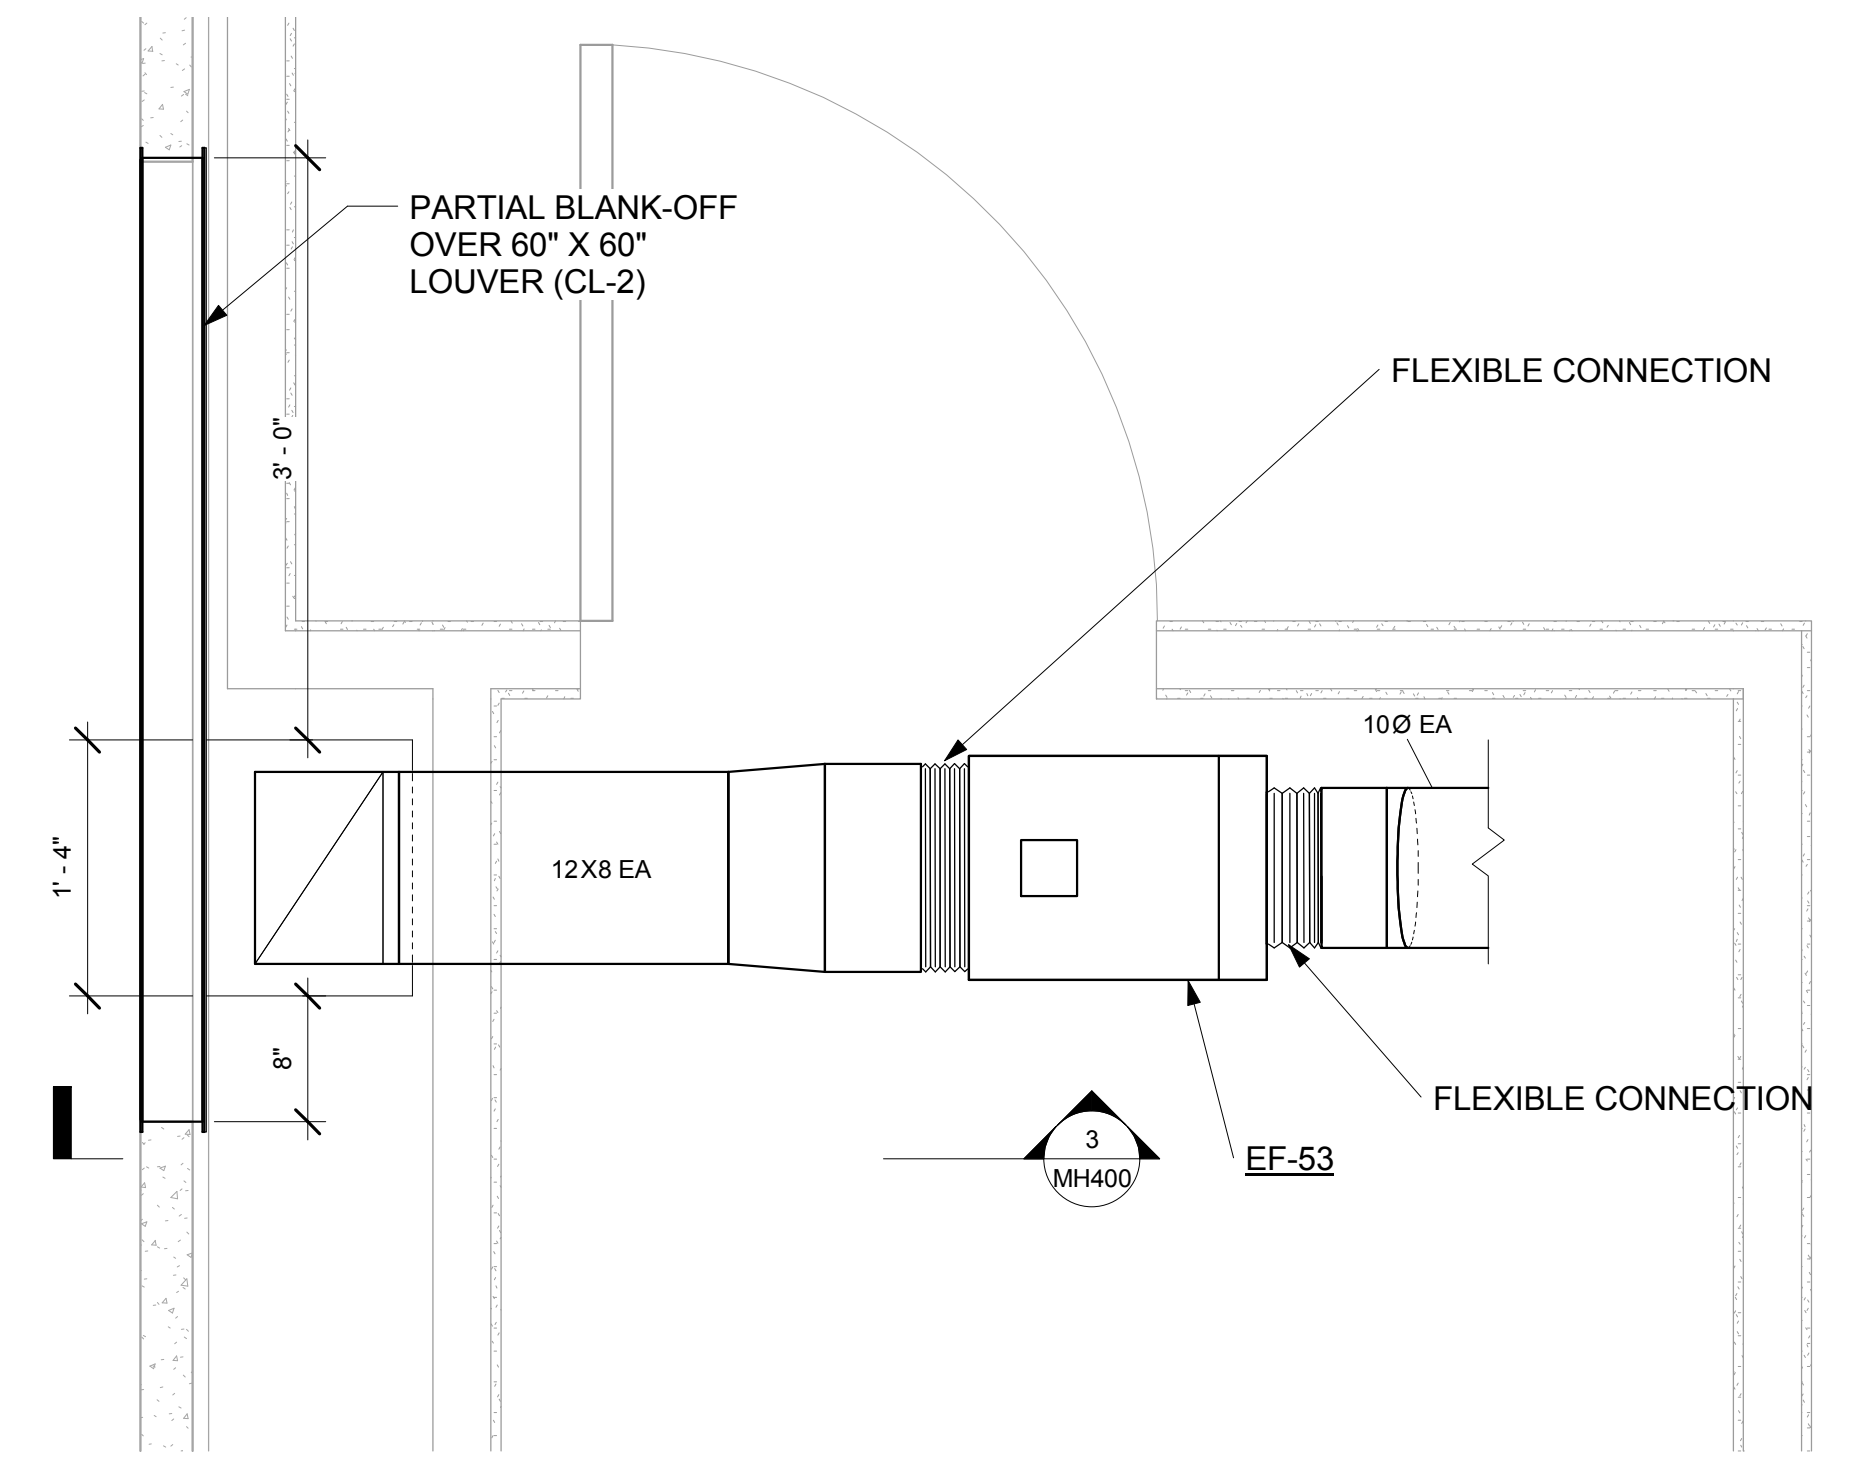


three inches = one foot
one and one half inches = one foot
one inch = one foot
three quarters inch = one foot
one half inch = one foot
three eighths inch = one foot
one quarter inch = one foot
one eighth inch = one foot


- SHEET NOTES
- 1 PROVIDE MANUAL BALANCING DAMPERS FOR EACH INLET AND OUTLET SHOWN ON PLANS. ENSURE FULL ACCESSIBILITY TO DAMPER HANDLE.

2 REFER TO DETAILS FOR DUCT WORK PRESSURE CLASS REQUIREMENTS.
- SHEET KEYNOTES
- 1 SUPPLY DUCT FOR FUTURE CONNECTION. CAP AND SEAL DUCT END AND ENSURE FULL ACCESSIBILITY.


2 SIZE SHEETMETAL DUCTWORK TO MATCH CONNECTION SIZE OF AIR TERMINAL UNIT OUTLET.

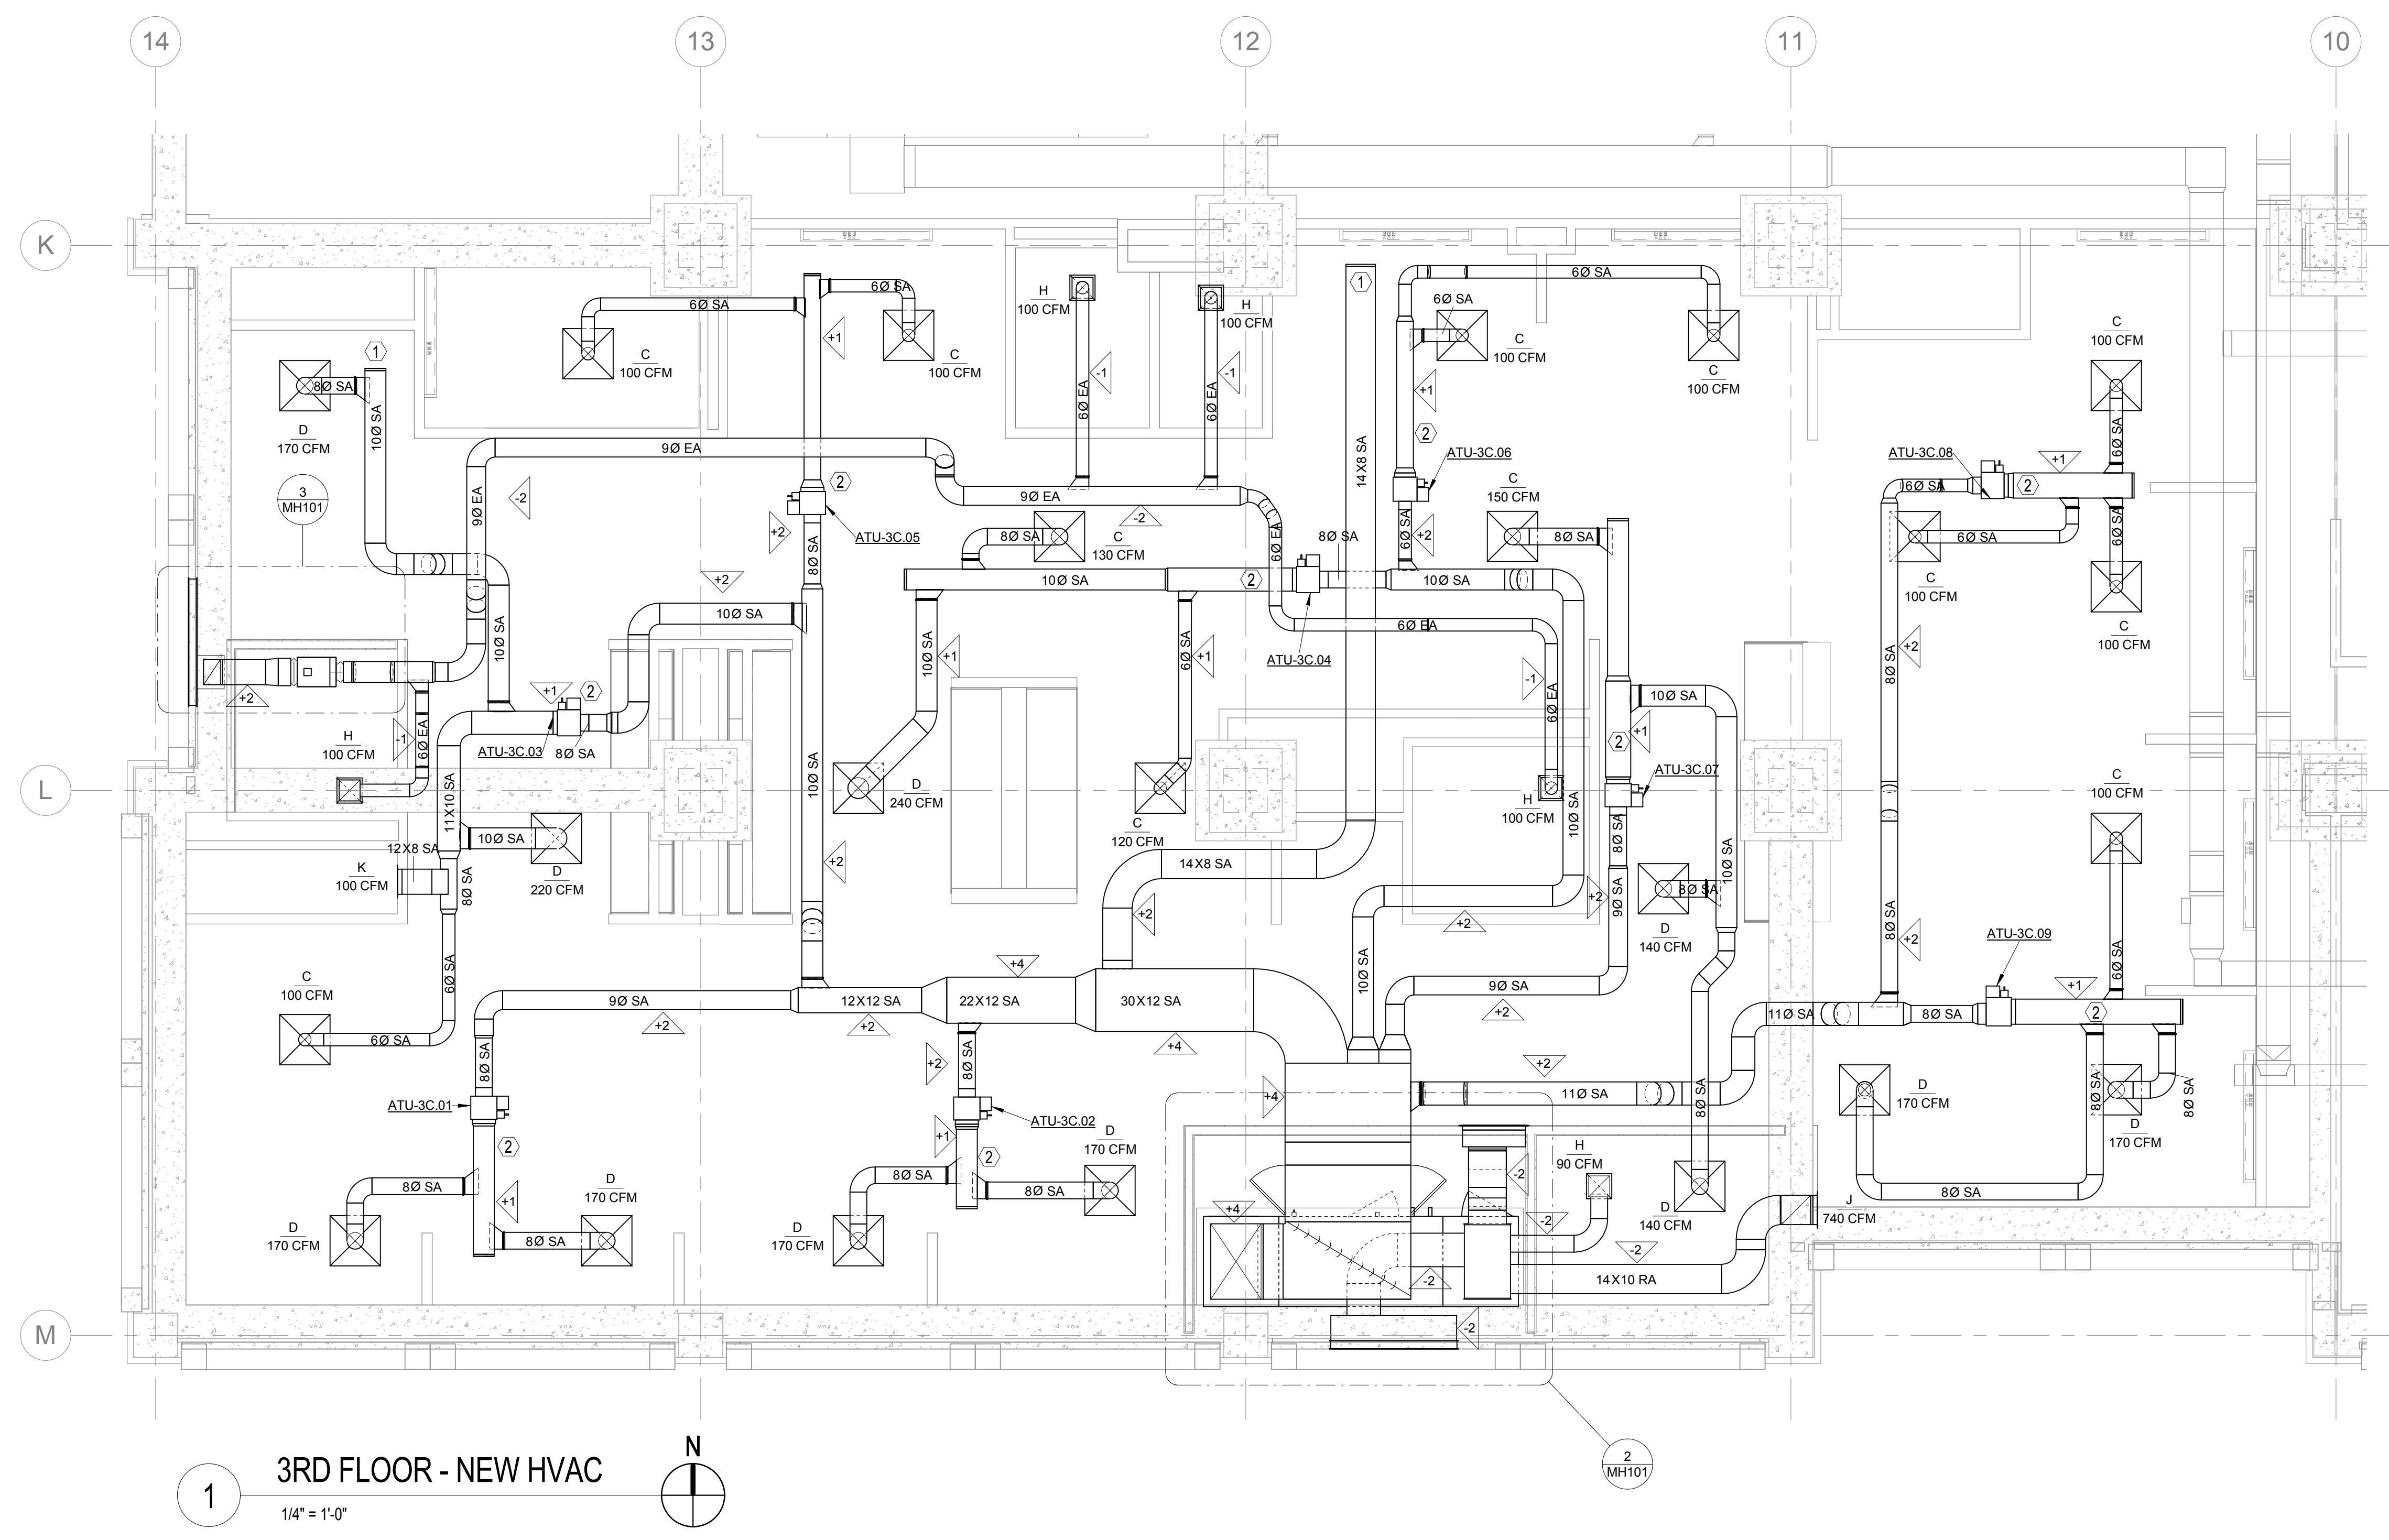

3 ENLARGED PARTIAL PLAN - EXHAUST FAN EF-53
1" = 1'-0"

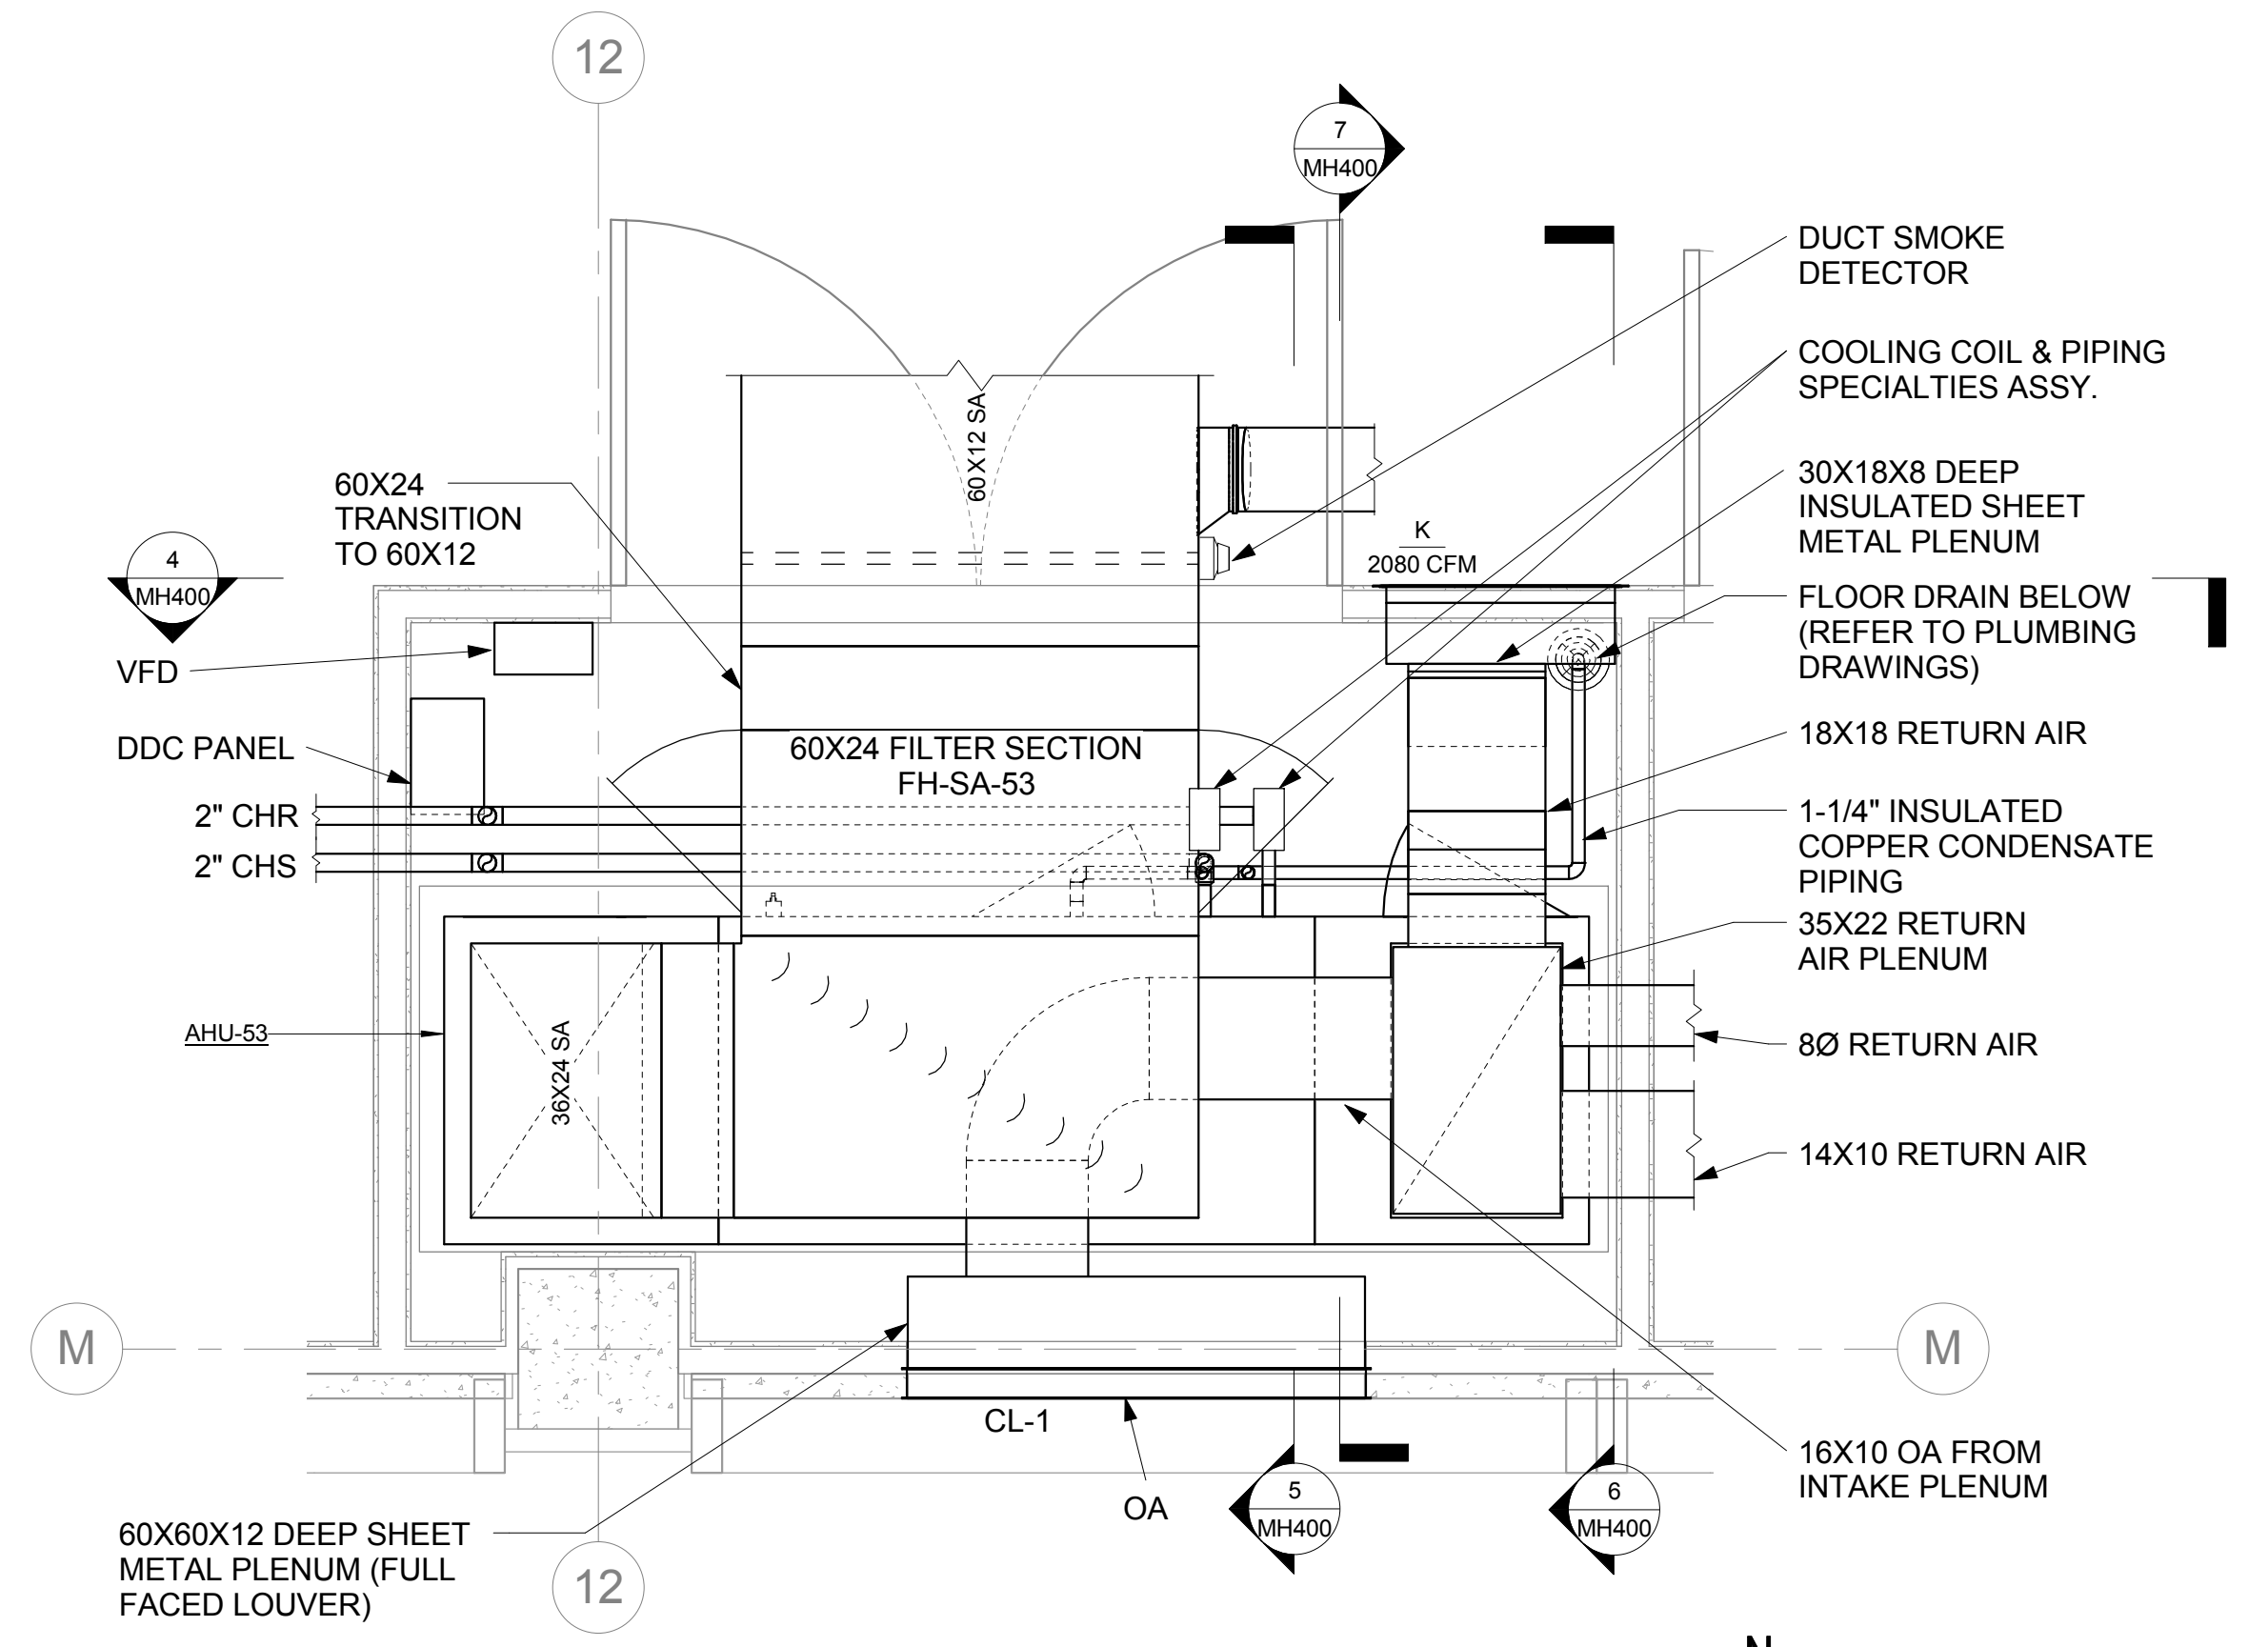

2 ENLARGED PARTIAL PLAN - MECH. RM. C306L-1
1/2" = 1'-0"

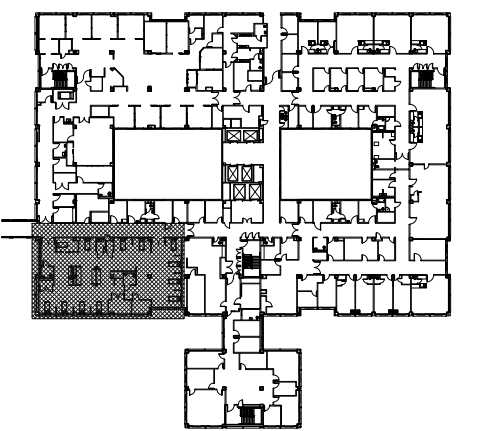

FINAL DESIGN
APPROVED FOR CONSTRUCTION

		CONSULTANTS:		ENGINEER - OF - RECORD MARK G. HERTZ	FL P.E. NO. 53279	ARCHITECT/ENGINEERS: <div>AKEA INC. 3603 NW 98th Street, Suite B Gainesville, FL 32606 Phone: (352) 474-6124 Fax: (352) 474-6324 C.O.A: FL #26693 AKEA Project No. 094-14</div>	Drawing Title	Project Title	Project Number	Office of Construction and Facilities Management Department of Veterans Affairs		
							THIRD FLOOR HVAC PLAN - NEW WORK	RENOVATE WARD 3C FOR CARDIOLOGY EQUIPMENT INSTALLATION	573-CSI-102			
									Building Number 1			
							Approved: Project Director	Location GAINESVILLE, FLORIDA	Drawing Number			
								Date MARCH 9, 2018	Checked MGH		Drawn TJM	MH101
Revisions:	Date											17 OF 62