


- NOTES:**
1. REFER TO DRAWING C1 FOR DEFINITION OF BID ITEMS AND ALTERNATE BID ITEMS.
 2. REFER TO DRAWING E1 FOR NOTES, SYMBOLS AND ABBREVIATIONS.
 3. CONDUCTOR AND CONDUIT SIZE INDICATED ON HOME RUN SHALL BE UTILIZED THROUGHOUT CIRCUIT.
 4. HOME RUNS INDICATED CIRCUIT TO BE ROUTED UNDERGROUND BACK TO RELAY PANEL.
 5. REFER TO CDM DRAWINGS FOR POLE LOCATIONS, CROSSING DETAILS, AND UTILITY COORDINATION.

KEY NOTES:


- 1 UTILIZE EXISTING CIRCUIT AT THIS LOCATION. PROVIDE NEW POLE BASE. CONTRACTOR SHALL TRACE EXISTING CIRCUITS AND VERIFY THAT EXISTING LIGHTING CONTROL IS OPERATIONAL, INCLUDING PHOTOCELL OPERATION FOR PROPER SECURITY LIGHTING FUNCTION.
- 2 ROUTE CIRCUITS OUT OF BUILDING AT GROUND LEVEL. GRASS AREA HAND HOLE HH-1.
- 3 INSTALL FLAG LIGHTING FIXTURES AT LOCATION OF EXISTING FIXTURES.
- 4 PROVIDE WALL SCONCE AT THIS LOCATION. CONNECT TO EXISTING 20A, 1P CIRCUIT WITHIN BUILDING. IN NEAREST LIFE SAFETY PANELBOARD WHERE POSSIBLE. UTILIZE 24/2, 1/2 IN. 3/4 CONDUIT. REFER TO DETAIL 3 ON DRAWING E-7 FOR ADDITIONAL INFORMATION.
- 5 REPLACE EXISTING WALL MOUNTED FIXTURE AT THIS LOCATION WITH FIXTURE INDICATED. CONNECT TO UNSWITCHED CONDUCTOR OF EXISTING CIRCUIT.
- 6 EXTEND EXISTING CIRCUIT. UTILIZE 24/10 AND 1/2 IN. 1" CONDUIT.
- 7 FOR A9 #2 AND #3, PROVIDE HOME RUN FOR CIRCUIT HL1/5 AT THIS FIXTURE.

NURSING HOME
AREA (NH)

LOOP # 1

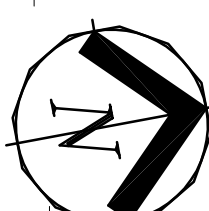

- NOTE:**
1. RELOCATE EXISTING THERMOSTAT.

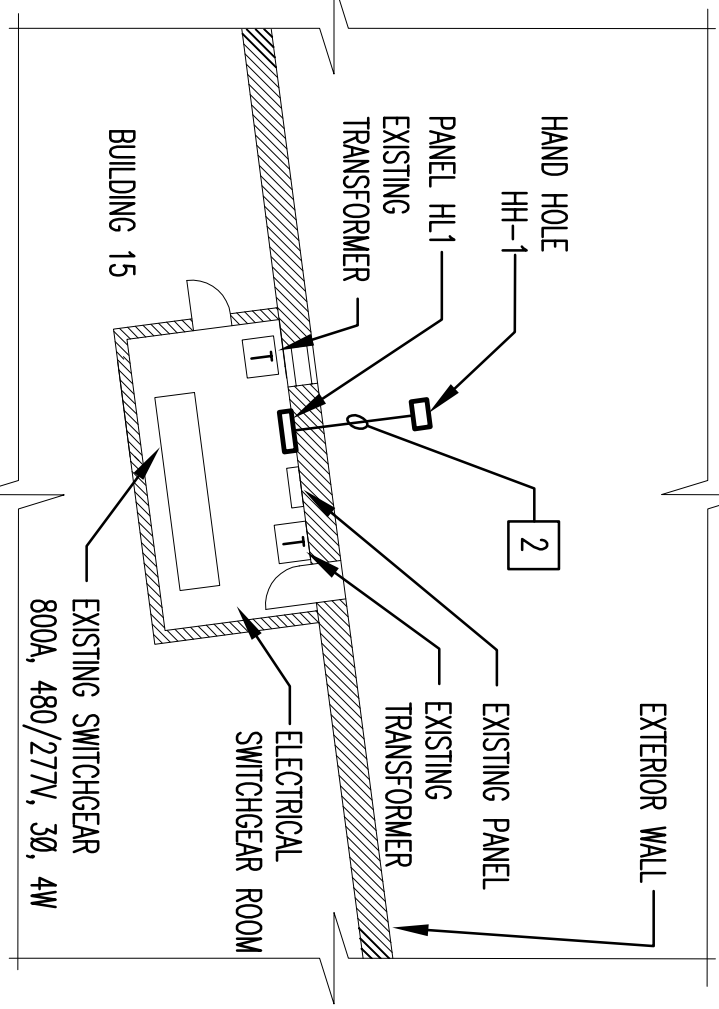

LIGHTING PLAN-WEST

SCALE: 1" = 100'-0"

1

LIGHTING PLAN-WEST

SCALE: 1" = 100'-0"

2

**ELECTRICAL ROOM
BUILDING 15 LOOP #1**


SCALE: 1/8" = 1'-0"

3




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Revisions	Date	By	App'd

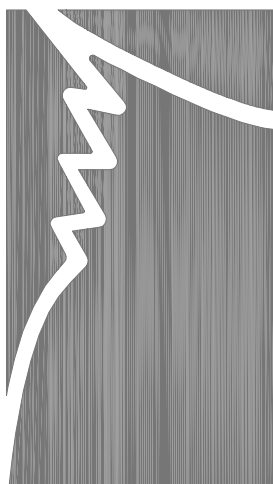

STAUNTON CHOW
A DIVISION OF
HATCH MOTT MACDONALD
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Key Plan

Drawing Title	Project Title
ELECTRICAL LIGHTING PLANS - WEST	REPLACE SITE LIGHTING AT VA LYONS CAMPUS
Approved: Division Chief	Building Number
Approved: Service Director	Checked: IB Drawn: CDG
	Location: VA LYONS CAMPUS, NJHCS, LYONS, NJ

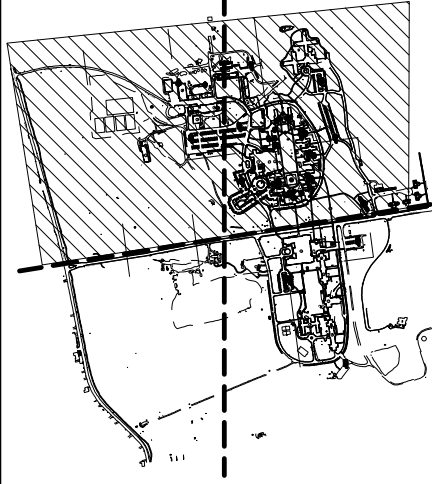Date	Project No.
23 MARCH, 2010	65144-08-103

Drawing No.	Sheet No.
E4	29

