


SYMBOLS LEGEND

DRAWING TITLE		DRAWING TITLE
DRAWING NUMBER		
DRAWING SCALE		
GRID LETTER OR NUMBER		REFERENCE GRID INDICATOR
SECTION No.		
SHEET No.		
SECTION No.		
SHEET No.		
DETAIL No.		
SHEET No.		
DETAIL No.		
SHEET No.		
SHEET No.		
DETAIL No.		
ROOM NAME		ROOM TAG
REFERENCE KEYNOTE No.		REFERENCE KEYNOTE INDICATOR
KEYNOTE No.		SHEET KEYNOTE INDICATOR
WINDOW OR LOUVER No.		WINDOW AND LOUVER TYPE IDENTIFIER
DOOR No.		DOOR OPENING IDENTIFIER
REVISION No.		REVISION INDICATOR
WALL No.		WALL TYPE INDICATOR
ELEVATION		ELEVATION INDICATOR
TRUE NORTH DIRECTION		NORTH INDICATOR

NOTE: THIS IS A GENERAL SYMBOLS LEGEND. ALL SYMBOLS DO NOT APPLY TO EVERY JOB.

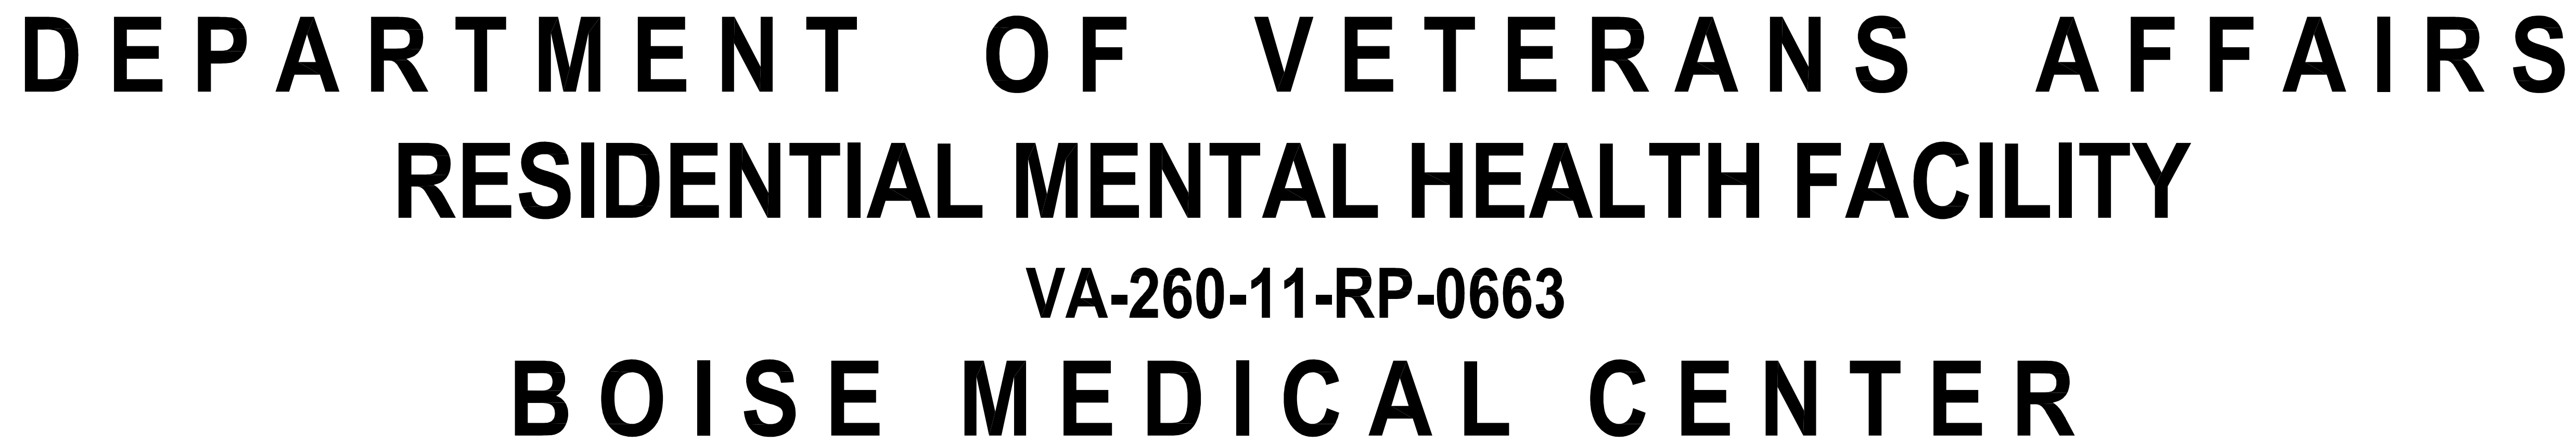

GENERAL NOTES

- WORK IN BUILDING 23 MUST BE VERY CAREFULLY COORDINATED WITH THE VA. SOME AREAS REQUIRE THAT ABATEMENT OF FLOOR TILE AND INSTALLATION OF NEW FLOORS WILL BE ACCOMPLISHED OVER WEEKENDS. WHERE ABATEMENT WORK IS REQUIRED TO TAKE PLACE OVER A WEEKEND, THE AREA CANNOT BE SHUT DOWN BEFORE 2:00 PM ON FRIDAY AND MUST BE OPEN FOR USE BY 6:00 AM MONDAY. INSTALLATION OF NEW FLOORING, INCLUDING PREP WORK, IN THESE AREAS MUST COMPLY WITH THE SAME SCHEDULE.
- CONSTRUCTION FOR THIS PROJECT WILL TAKE PLACE IN BUILDINGS THAT REMAIN OCCUPIED BY STAFF AND PATIENTS. DURING CONSTRUCTION, NOISE, AND VIBRATION ARE AREAS OF MAJOR CONCERN. THE CONTRACTOR SHALL PROVIDE ALL NECESSARY DUST BARRIERS AND EXHAUST FANS DURING THE DURATION OF DUST PRODUCING WORK AS SPECIFIED AND DIRECTED BY THE RESIDENT ENGINEER. WORK THAT CREATES EXCESSIVE NOISE AND/OR VIBRATIONS MUST BE CAREFULLY SCHEDULED AND COORDINATED WITH THE VA. THERE WILL BE TIMES WHEN NOISE OR VIBRATION MAY BE UNAVOIDABLE. IT WILL NOT BE ALLOWED AND IT WILL HAVE TO BE SCHEDULED FOR OTHER NON-CRITICAL TIMES.
- THE CONTRACTOR IS RESPONSIBLE FOR CONSTRUCTING AND MAINTAINING ALL REQUIRED BARRIERS. TEMPORARY FIRE BARRIERS MUST BE CONSTRUCTED FOR ALL OCCUPANCIES ADJACENT TO CONSTRUCTION. TEMPORARY PROTECTION MUST BE MAINTAINED UNTIL REMODELED (IE. FIRE SPRINKLERS OR FIRE ALARM SYSTEMS ARE IMPAIRED OR REMOVED). TEMPORARY FIRE WALLS ARE ALSO REQUIRED TO SEPARATE NEW CONSTRUCTION FROM EXISTING BUILDINGS. TEMPORARY SEPARATE RENOVATION PROJECTS FROM OCCUPIED AREAS MUST BE OF 1-HOUR CONSTRUCTION WITH 1-HOUR RATED DOORS.
- THE VA REQUIRES THAT ALL PENETRATIONS THROUGH FIRE RATED BARRIERS BE ACCOMPLISHED BY A QUALIFIED FIRESTOP CONTRACTOR IN ACCORDANCE WITH SECTION 079400. WHEN WORK TAKES PLACE WITHIN EXISTING BUILDING THAT ARE NOT SEPARATED BY A 2-HOUR BARRIER FROM OCCUPIED AREAS, AND WHERE IT IS NOT FEASIBLE TO HAVE A QUALIFIED FIRESTOP CONTRACTOR PROVIDING FIRE SEALING ON A DAILY BASIS, IT SHALL BE THE RESPONSIBILITY OF THE TRADE PENETRATING THE FIRE RATED BARRIER TO PROVIDE TEMPORARY FIRE PROTECTION OF ALL PENETRATIONS AT THE END OF EACH WORK DAY. TEMPORARY PROTECTION MUST MEET ALL NFPA CODES RELATED TO FIRE BARRIER PENETRATIONS. THE TEMPORARY PROTECTION MUST BE MAINTAINED IN PROPER ORDER UNTIL THE PERMANENT FIRE STOPPING MATERIAL IS INSTALLED. FIREBRICKS OR FIRE PLUGS MUST BE USED TO SEAL PENETRATIONS IN TEMPORARY OR PERMANENT FIRE BARRIERS UNTIL THE PERMANENT FIRE STOPPING MATERIAL IS INSTALLED.
- THE CONTRACTOR SHALL SEPARATE ALL CONSTRUCTION AREAS FROM THE REST OF THE BUILDING'S NORMAL OPERATION. THIS SHALL INCLUDE THE ERECTION OF CLEARLY MARKED BARRIERS TO LIMIT ACCESS BY UNAUTHORIZED PERSONNEL, AND TO PREVENT CONTAMINATION FROM PARTICULATE MATTER. FIRE RESISTANT PLASTIC SHEETING (LIMITED COMBUSTIBILITY) MAY BE USED IF A PLASTIC BARRIER IS USED. IT MUST BE INSPECTED DAILY TO ASSURE ITS INTEGRITY. THE BARRIER MUST PREVENT THE TRANSMISSION OF DUST BY SEALING THE WALL TO THE FLOOR AND CEILING AND SEALING ALL JOINTS OR CRACKS BY SOME OTHER METHOD. THE TEMPORARY SIGNAGE WILL BE IN ACCORDANCE WITH FEDERAL REGULATION 29CFR 1926.200.
- THE CEILING SPACE FROM THE BOTTOM OF THE CEILING GRID TO A MINIMUM OF 6" ABOVE THE BOTTOM OF THE CEILING GRID IS RESERVED FOR INSTALLATION OF CEILING MOUNTED ITEMS (IE. LIGHT FIXTURES, SPEAKERS, DIFFUSERS), NO PIPING, DUCTWORK, OR ELECTRICAL, ETC., EXCEPT AS APPROVED BY THE RESIDENT ENGINEER. IT MUST BE INSTALLED IN THIS SPACE, UNLESS OTHERWISE APPROVED BY THE RESIDENT ENGINEER.
- CONTRACTOR IS REQUIRED TO FOLLOW ALL OSHA REGULATIONS CONCERNING CONSTRUCTION. THE SUPERINTENDENT IS REQUIRED TO HAVE COMPLETED, AS A MINIMUM, OSHA'S 10-HOUR TRAINING AND BE KNOWLEDGEABLE OF GENERAL SAFETY REQUIREMENTS FOR CONFINED SPACES, FALL PROTECTION, PERSONAL PROTECTIVE EQUIPMENT, TRENCHING, SCAFFOLDING, CRANES, ELECTRICAL, ETC.. APPLICABLE SUBCONTRACTORS ARE TO HAVE A COMPETENT PERSON ON SITE AT ALL TIMES. PERSONNEL ENTERING ANY UNDESIGNATED CONFINED SPACE, THE CONTRACTOR IS REQUIRED HAVE THEIR OWN CONFINED SPACE AIR MONITOR AND TO TEST THE AIR PRIOR TO ENTERING ANY CONFINED SPACE. IF THE CONTRACTOR MUST ENTER A SANITARY SEWER MANHOLE, IN ADDITION TO A CONFINED SPACE AIR MONITOR, THEY MUST HAVE PROPER RESCUE EQUIPMENT FOR ANY EMERGENCY REQUIRED CONFINED SPACE. WHERE IT IS NOT POSSIBLE FOR THE VA TO SHUT DOWN AN ELECTRICAL PANEL OR CIRCUIT, THE CONTRACTOR MUST PROVIDE AND USE THE APPROPRIATE SAFETY GEAR AND PROCEDURES TO ENSURE THAT THE VA WILL BE MONITORING THE CONTRACTOR'S COMPLIANCE WITH OSHA REGULATIONS. FAILURE TO COMPLY IS GROUNDS FOR STOPPING WORK.

VICINITY MAP

1 CONTRACTORS' PARKING AREA NO. 1 AND STAGING AREA.
 2 CONTRACTORS' PARKING AREA NO. 2.
 3 STAGING AREA (EXISTING SLOPED LAWN). PROTECT EXISTING IRRIGATION FROM DAMAGE. AT COMPLETION OF PROJECT RETURN LAWN TO PRE-CONSTRUCTION CONDITION.
 4 OPTIONAL ADDITIONAL STAGING AREA. EXCAVATE INTO HILLSIDE A MAXIMUM OF 12' FROM EXISTING EDGE OF PAVEMENT FOR A DISTANCE OF 80'. STABILIZE CUT AS REQUIRED AND CONTROL DRAINAGE ONTO PAVEMENT. LAY 2" MIN. OF 3/4" GRAVEL, TO REMAIN AS PART OF COMPLETED WORK.

PROJECT LOCATION
 BUILDING 123
 RESIDENTIAL MENTAL
 HEALTH FACILITY

HAYS STREET
 FIFTH STREET
 FORT STREET
 NORTH VA LOOP
 SOUTH VA LOOP
 ACCESS ROAD
 OFFICE ROW
 (OFFICE ROW)
 IDAHO STATE VETERANS HOME
 ROLLING ROAD
 IDAHO STATE VETERANS HOME
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STAGING PLAN

SEE NOTES UNDER CAMPUS MAP AT LEFT.

STAGING PLAN
NOT TO SCALE

PLAN NORTH

PROJECT LOCATION
BUILDING 123
RESIDENTIAL MENTAL
HEALTH FACILITY

OFFICE ROW
(ONE WAY)

EAST VLA LOOP
(ONE WAY)

ACCESS ROAD

30

66

45

23

1

24

52

114

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107

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




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3

4

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S2.5	STAIR PLANS AND STRUCTURAL DETAILS	
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S3.5	STRUCTURAL DETAILS	
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P10.06	DEDUCT ALTERNATE SECOND FLOOR SANITARY PLAN	
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M0.02	MECHANICAL SCHEDULES	
M0.03	MECHANICAL SCHEDULES	
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M2.02	FIRST FLOOR MECHANICAL HVAC PLAN	
M2.03	SECOND FLOOR MECHANICAL HVAC PLAN	
M2.04	MECHANICAL ROOF PLAN	
M2.05	FIRST FLOOR MECHANICAL PIPING PLAN	
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M10.03	DEDUCT ALTERNATE SECOND FLOOR MECHANICAL HVAC PLAN	
M10.04	DEDUCT ALTERNATE FIRST FLOOR MECHANICAL PIPING PLAN	
M10.05	DEDUCT ALTERNATE SECOND FLOOR MECHANICAL PIPING PLAN	
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FPD.04	SECOND FLOOR FIRE PROTECTION PLAN	
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 <p>ZGA ZGA ARCHITECTS & PLANNERS, CHARTERED</p>  <p>JENSENBELTS ASSOCIATES</p> <p>Site Planning / Landscape Architecture 495 Main Street, Boise, Idaho 83702 Ph. (208) 343-7175, Fx. (208) 343-7178</p>	<p><u>OWNER</u> DEPARTMENT OF VETERANS AFFAIRS CONTACT: JOEL HOLTROP, COTR TEL (208) 422-1370 FAX (208) 422-1334</p> <p><u>ARCHITECT</u> ZGA ARCHITECTS & PLANNERS, CHARTERED 408 WEST PARKENTROP BLVD., SUITE 205 BOISE, ID 83706 CONTACT: LOWELL ALSETH, AIA TEL (208) 345-8872 FAX (208) 343-7162</p> <p><u>LANDSCAPE ARCHITECT</u> JENSEN BELTS ASSOCIATES 495 MAIN STREET BOISE, ID 83702 CONTACT: BRUCE TAYLOR TEL (208) 343-7175 FAX (208) 343-7178</p>
 <p>B & A</p>  <p>HINZMAN-JONES</p> <p>5418 N. EAGLE RD. BOISE, IDAHO 83713 (208) 323-0199</p>	<p><u>CIVIL ENGINEER</u> B & A ENGINEERS, INC. 5505 WEST FRANKLIN ROAD BOISE, ID 83705 CONTACT: JOE CANNING TEL (208) 343-3381 FAX (208) 342-5792</p> <p><u>STRUCTURAL ENGINEER</u> AHU ENGINEERS P.C. 5418 N. EAGLE ROAD #140 BOISE, ID 83713 CONTACT: CHRIS HOLLADAY TEL (208) 323-0199 FAX (208) 375-5251</p>
 <p>POWER ENGINEERS</p> <p>Cornerstone Design <i>Healthy & High performance interiors™</i></p> <p>1005 E. PARK BLVD. BOISE, ID 83712 (208) 384-1422 F. 208.389.8311 www.cornerstonedesigninteriors.com</p>	<p><u>MECHANICAL/ELECTRICAL ENGINEER</u> POWER ENGINEERS 2041 S. COBALT POINT WAY MERIDIAN, ID 83642 CONTACT: JUSTIN BEAUCANNON/BEN SPARKS TEL (208) 288-6340 FAX (208) 288-0025</p> <p><u>INTERIOR DESIGN</u> CORNERSTONE DESIGN 1005 E. PARK BLVD. BOISE, ID 83712 CONTACT: ADRIENNE LANE-MARTIN TEL (208) 384-1422 FAX (208) 368-6311</p>

FINAL SET


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$$1'' = 25.4\text{mm}$$

$$1'-0'' = 304.8\text{mm}$$

METRIC CONVERSION FACTOR:
 $1'' = 25.4\text{mm}$
 $1'-0'' = 304.8\text{mm}$

REVISIONS	DATE
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f: (208) 343.7162 | www.zga.com

408 E. Parkcenter Blvd., Suite 205 | Boise, Idaho 83706 | t: (208) 345.8872 | f: (208) 343.7162 | www.zga.com

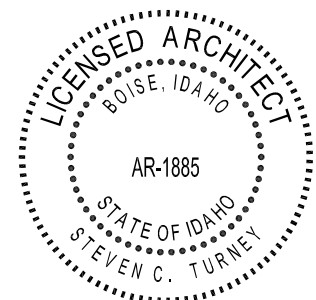CAD FILE NAME:
531CSI102_G101.dwg

XREF FILE NAME:
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X_SITE.dwg
B&A LOGO
Rec CAD Logo
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DRAWING TITLE COVER SHEET		PROJECT TITLE VA RESIDENTIAL MENTAL HEALTH FACILITY VA-260-11-RP-0663	
APPROVED: CHIEF OF FACILITY MANAGEMENT SERVICE <i>Douglas S. Lamb</i>		BUILDING NUMBER 123	CHECKED DRAWN

PROJECT NO.
531-CIS-102

DRAWING NO.

G1.01



DEPARTMENT OF VETERANS AFFAIRS

ENERGY CODE NOTES

R-VALUES LISTED ARE MINIMUM TO BE PROVIDED BY INSULATION MATERIALS AND IS NOT THE TOTAL R-VALUE FOR THE ASSEMBLY.

ROOF ASSEMBLY: R-30 MINIMUM
EXTERIOR STUD WALLS: R-19 MINIMUM
EXTERIOR DOORS, SOLID: R-4 MINIMUM
BELOW SNOW-MELT SLAB: R-15 MINIMUM
EXTERIOR DOORS, GLAZED: U = 0.94 MINIMUM
WINDOW ASSEMBLIES: U = 0.35 MINIMUM
WINDOW SHADING COEFFICIENT: SC = 0.40 MINIMUM

LINE TYPE LEGEND

=====	FIRE/SMOKE COMPARTMENT
-----	1-HOUR FIRE BARRIER
.....	1-HOUR SMOKE PARTITION
FEC	FIRE EXTINGUISHER AND CABINET
FEC (E)	EXISTING FIRE EXTINGUISHER LOCATION
[F]	MANUAL FIRE ALARM PULL STATION
[FACP]	FIRE ALARM CONTROL PANEL

APPLICABLE CODE DATA

CODES	
LIFE SAFETY CODE (NFPA 101):	2009 EDITION
INTERNATIONAL BUILDING CODE (FOR STRUCTURAL DESIGN):	2009 EDITION
ARCHITECTURAL BARRIERS ACT ACCESSIBILITY STANDARDS (ABAA) - AUGUST 5, 2005:	-
INTERNATIONAL PLUMBING CODE:	2009 EDITION
STANDARDS FOR THE INSTALLATION OF AIR CONDITIONING AND VENTILATION SYSTEMS (NFPA 90A):	2009 EDITION
INTERNATIONAL MECHANICAL CODE:	2006 EDITION
INTERNATIONAL FIRE CODE:	2010 EDITION
STANDARD FOR THE INSTALLATION OF SPRINKLER SYSTEMS (NFPA 13):	2011 EDITION
INSPECTION, TESTING AND MAINTENANCE OF WATER BASED FIRE PROTECTION SYSTEMS (NFPA 25):	2011 EDITION
NATIONAL ELECTRICAL CODE (NFPA 70):	2005 EDITION
NATIONAL ELECTRIC SAFETY CODE:	2009 EDITION
INTERNATIONAL ENERGY CONSERVATION CODE:	2010 EDITION
NATIONAL FIRE ALARM CODE (NFPA 72):	2005 EDITION
STANDARD FOR HEALTH CARE FACILITIES (NFPA 99):	2005 EDITION

CODE REVIEW

OCCUPANCY GROUP:	NEW RESIDENTIAL BOARD AND CARE, LARGE FACILITY
CONSTRUCTION TYPE:	V (111), FULLY SPRINKLED
MAXIMUM BUILDING HEIGHT:	2 STORIES (NFPA 5000, TABLE 7.4.1)
MAXIMUM AREA PER FLOOR:	10,500 SF
ACTUAL BUILDING AREA WITH OCCUPANT LOADS:	

BASEMENT	1,640 SF	05 OCCUPANTS
FIRST FLOOR	6,051 SF	31 OCCUPANTS
SECOND FLOOR	6,873 SF	38 OCCUPANTS
ALL FLOORS:	14,564 SF	74 OCCUPANTS


FIRE RESISTIVE RATING REQUIREMENTS FOR BUILDING ELEMENTS, UNLESS NOTED OTHERWISE: (NFPA 220, TABLE 4.1.1)	
STRUCTURAL FRAME:	1-HOUR
BEARING WALLS EXTERIOR:	N/A
BEARING WALLS INTERIOR:	N/A
NON-BEARING WALLS INTERIOR:	NOT RATED
NON-BEARING WALLS EXTERIOR:	NOT RATED
FLOOR CONSTRUCTION:	1-HOUR
ROOF ASSEMBLY:	1-HOUR
CORRIDOR TO SLEEPING ROOM WALLS:	1/2 HOUR SMOKE PARTITION (NFPA 101, 32.3.3.6.3)

SHAFT ENCLOSURES:	1-HOUR
VERTICAL EXIT ENCLOSURE:	1-HOUR
SOILED LINEN ROOMS:	1-HOUR (NFPA 101, TABLE 32.3.3.2.2)
STORAGE ROOMS OVER 100SF:	1-HOUR (NFPA 101, TABLE 32.3.3.2.2)
EXTERIOR OPENINGS:	UNPROTECTED (NFPA 5000 TABLE 7.3.5(a))
EGRESS STAIR WIDTH:	44" MINIMUM
FIRE SPRINKLER REQUIRED:	YES (NFPA 101 TABLE 32.3.1.3)
FIREFLOW:	1500 GPM REQUIRED / 775 GPM AVAILABLE
FIRE ALARM SYSTEM:	MONITOR FIRE SPRINKLER AND HVAC SYSTEMS, INITIATE ELEVATOR RECALL AND SHUNT-TRIP SHUTDOWN


PLUMBING FIXTURES (IBC TABLE 2902.1):		REQUIRED	PROVIDED
WATER CLOSETS:		22	22
LAVATORIES:		21	22
SERVICE SINKS:		2	2
DRINKING FOUNTAINS:		1	0
(DUAL HEIGHT REQUIRED BY ADA 211.2)			*WATER DISPENSER IN DINING ROOM

KEYNOTES


- BEAMS TO RECEIVE 1-HOUR SPRAY-ON FIREPROOFING.
- COLUMNS TO RECEIVE 1-HOUR SPRAY-ON FIREPROOFING OR ENCAPSULATION IN 1-HOUR RATED CONSTRUCTION.

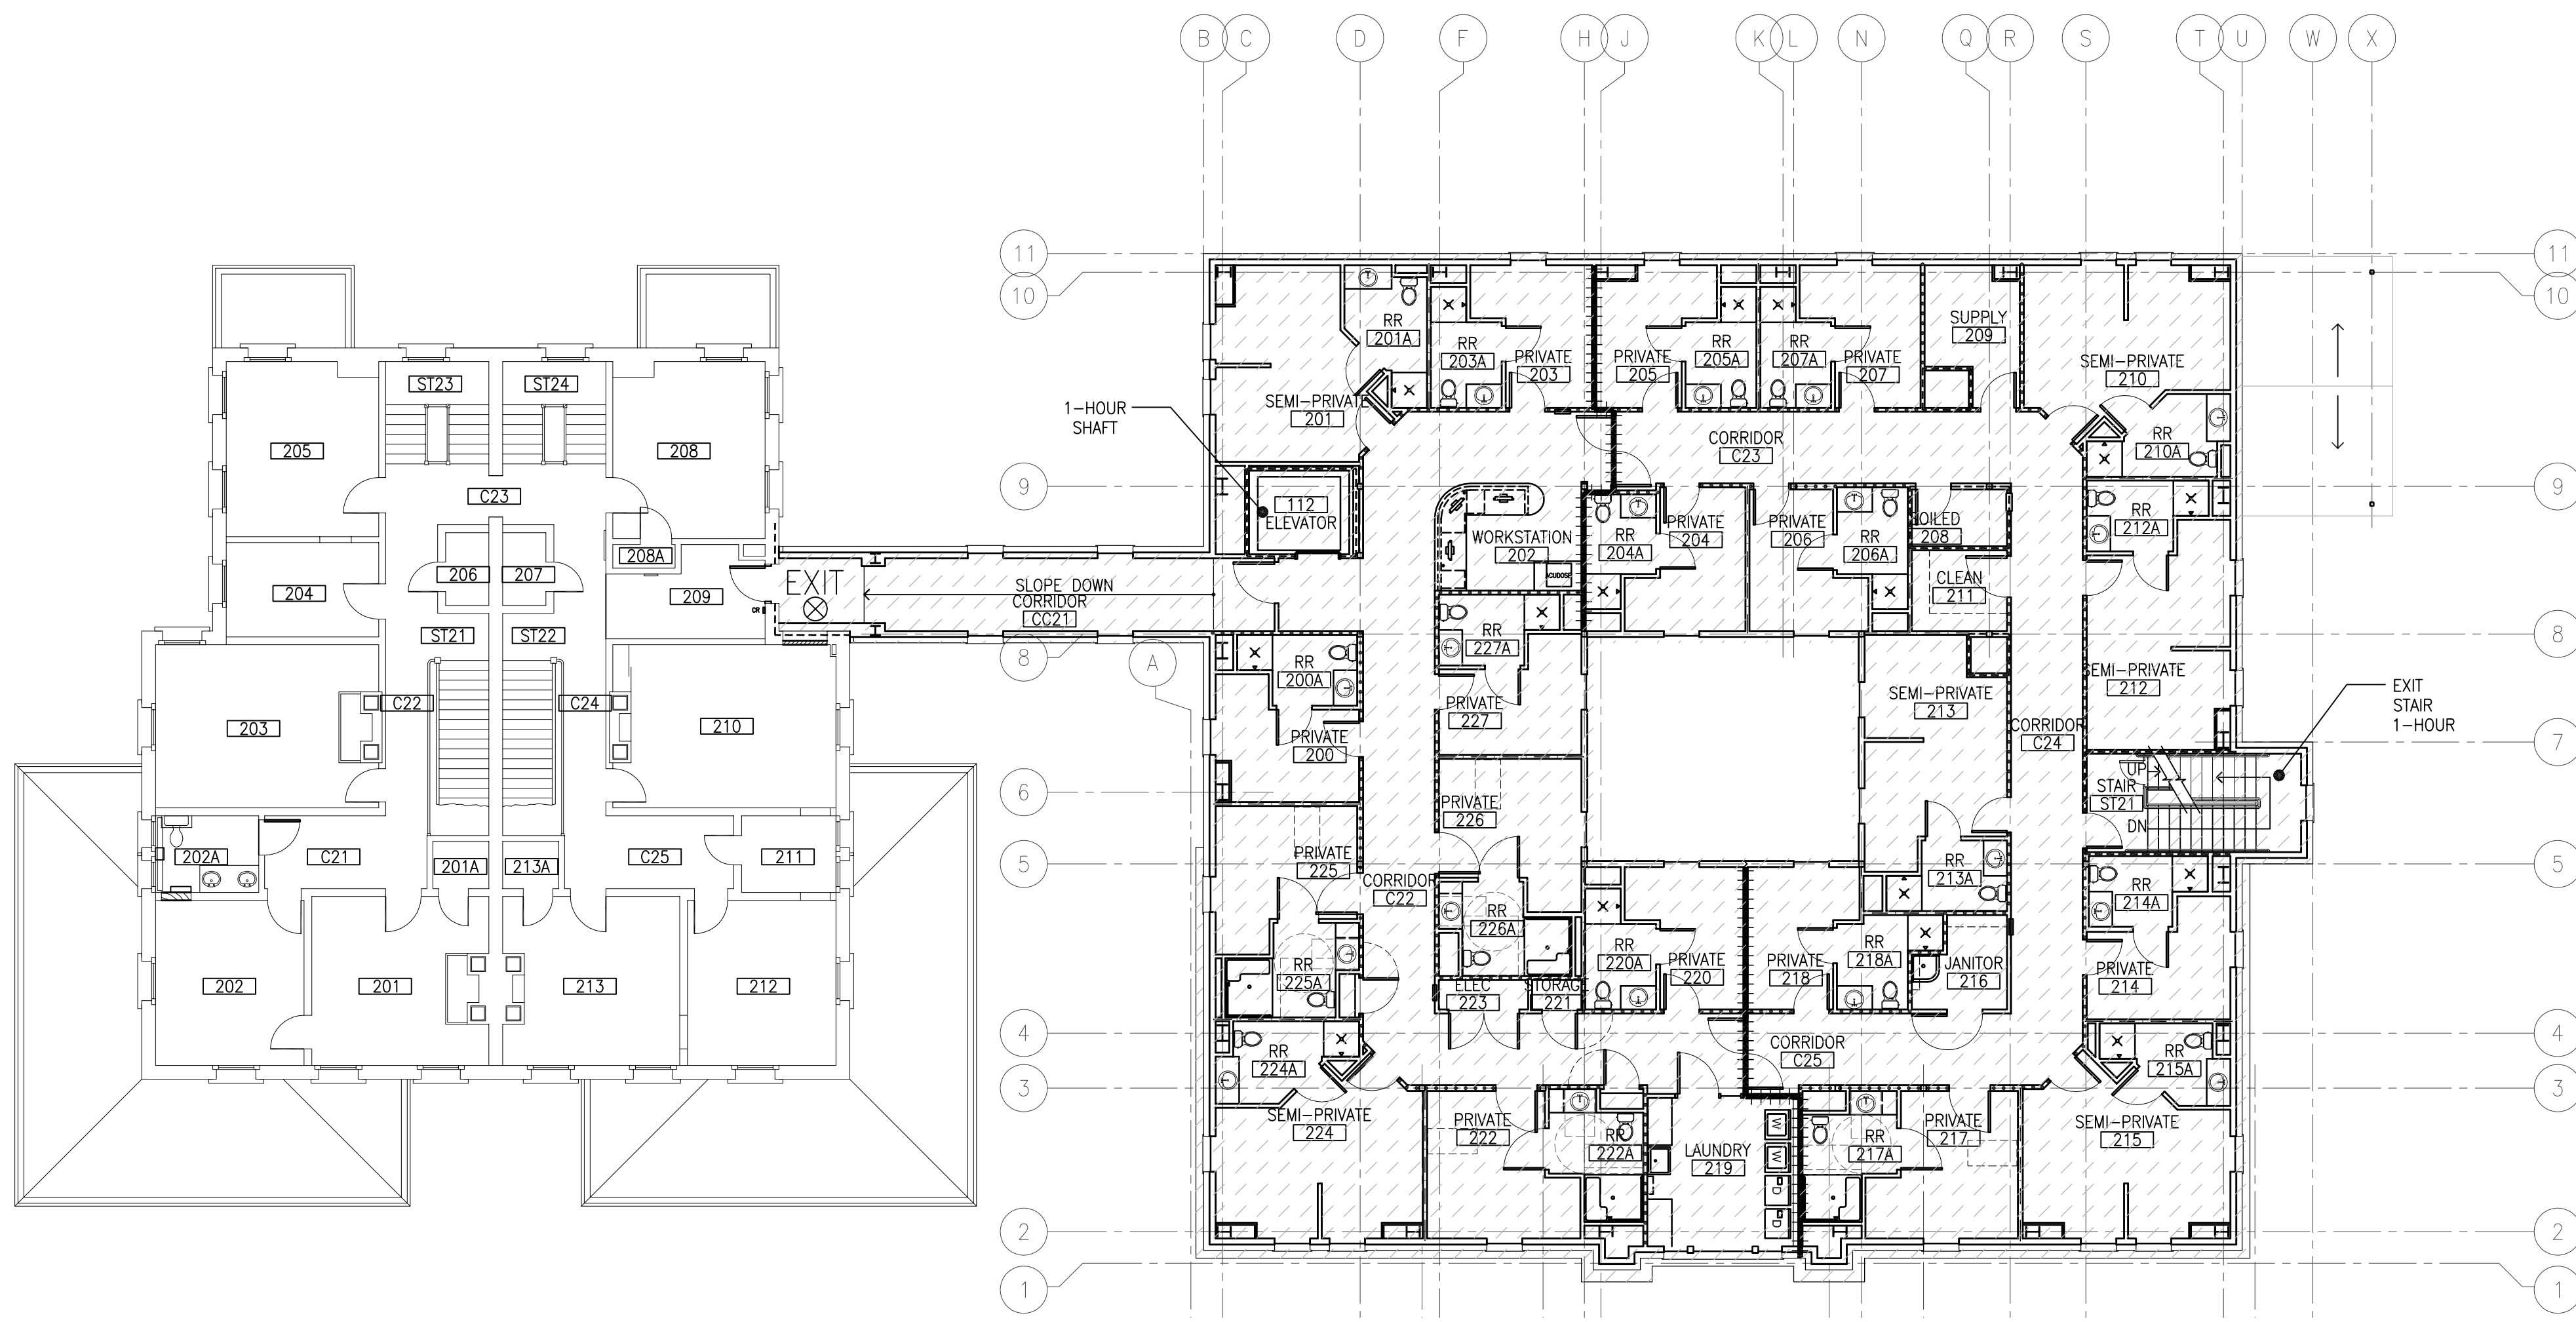


18 LIFE SAFETY PLAN - SECOND FLOOR
SCALE: 3/32" = 1'-0"

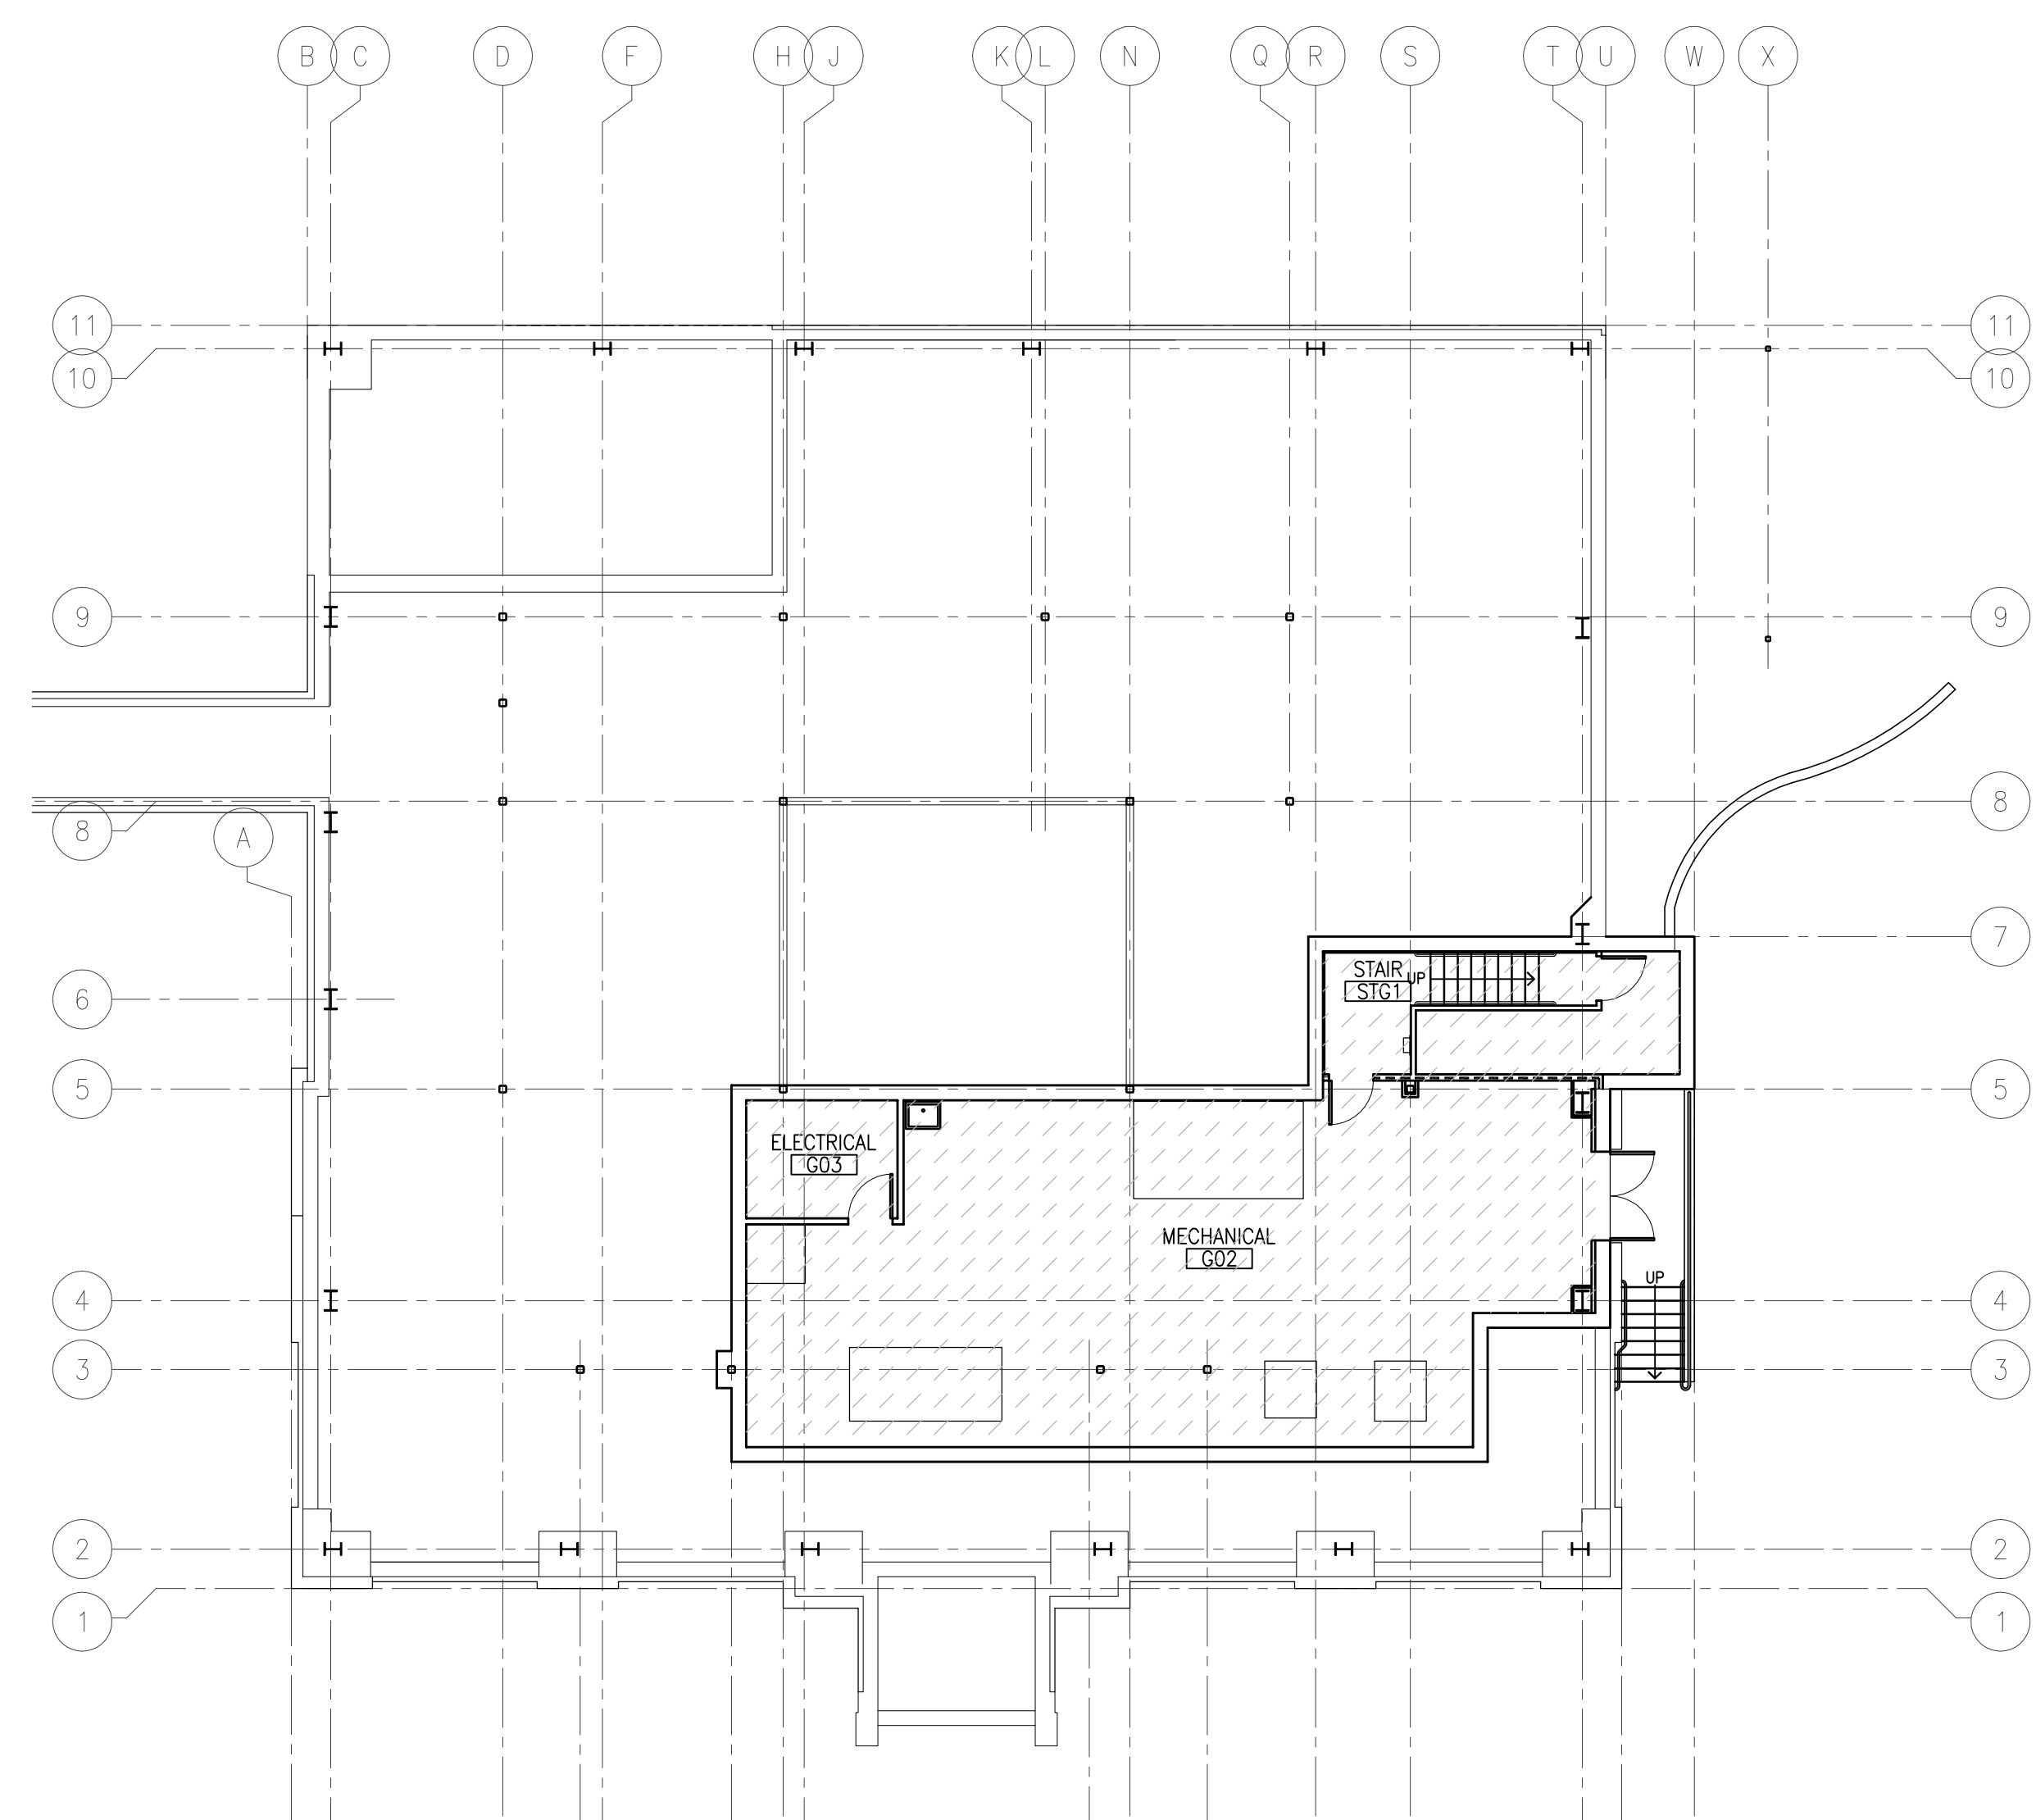

26 LIFE SAFETY PLAN - BASEMENT
SCALE: 3/32" = 1'-0"

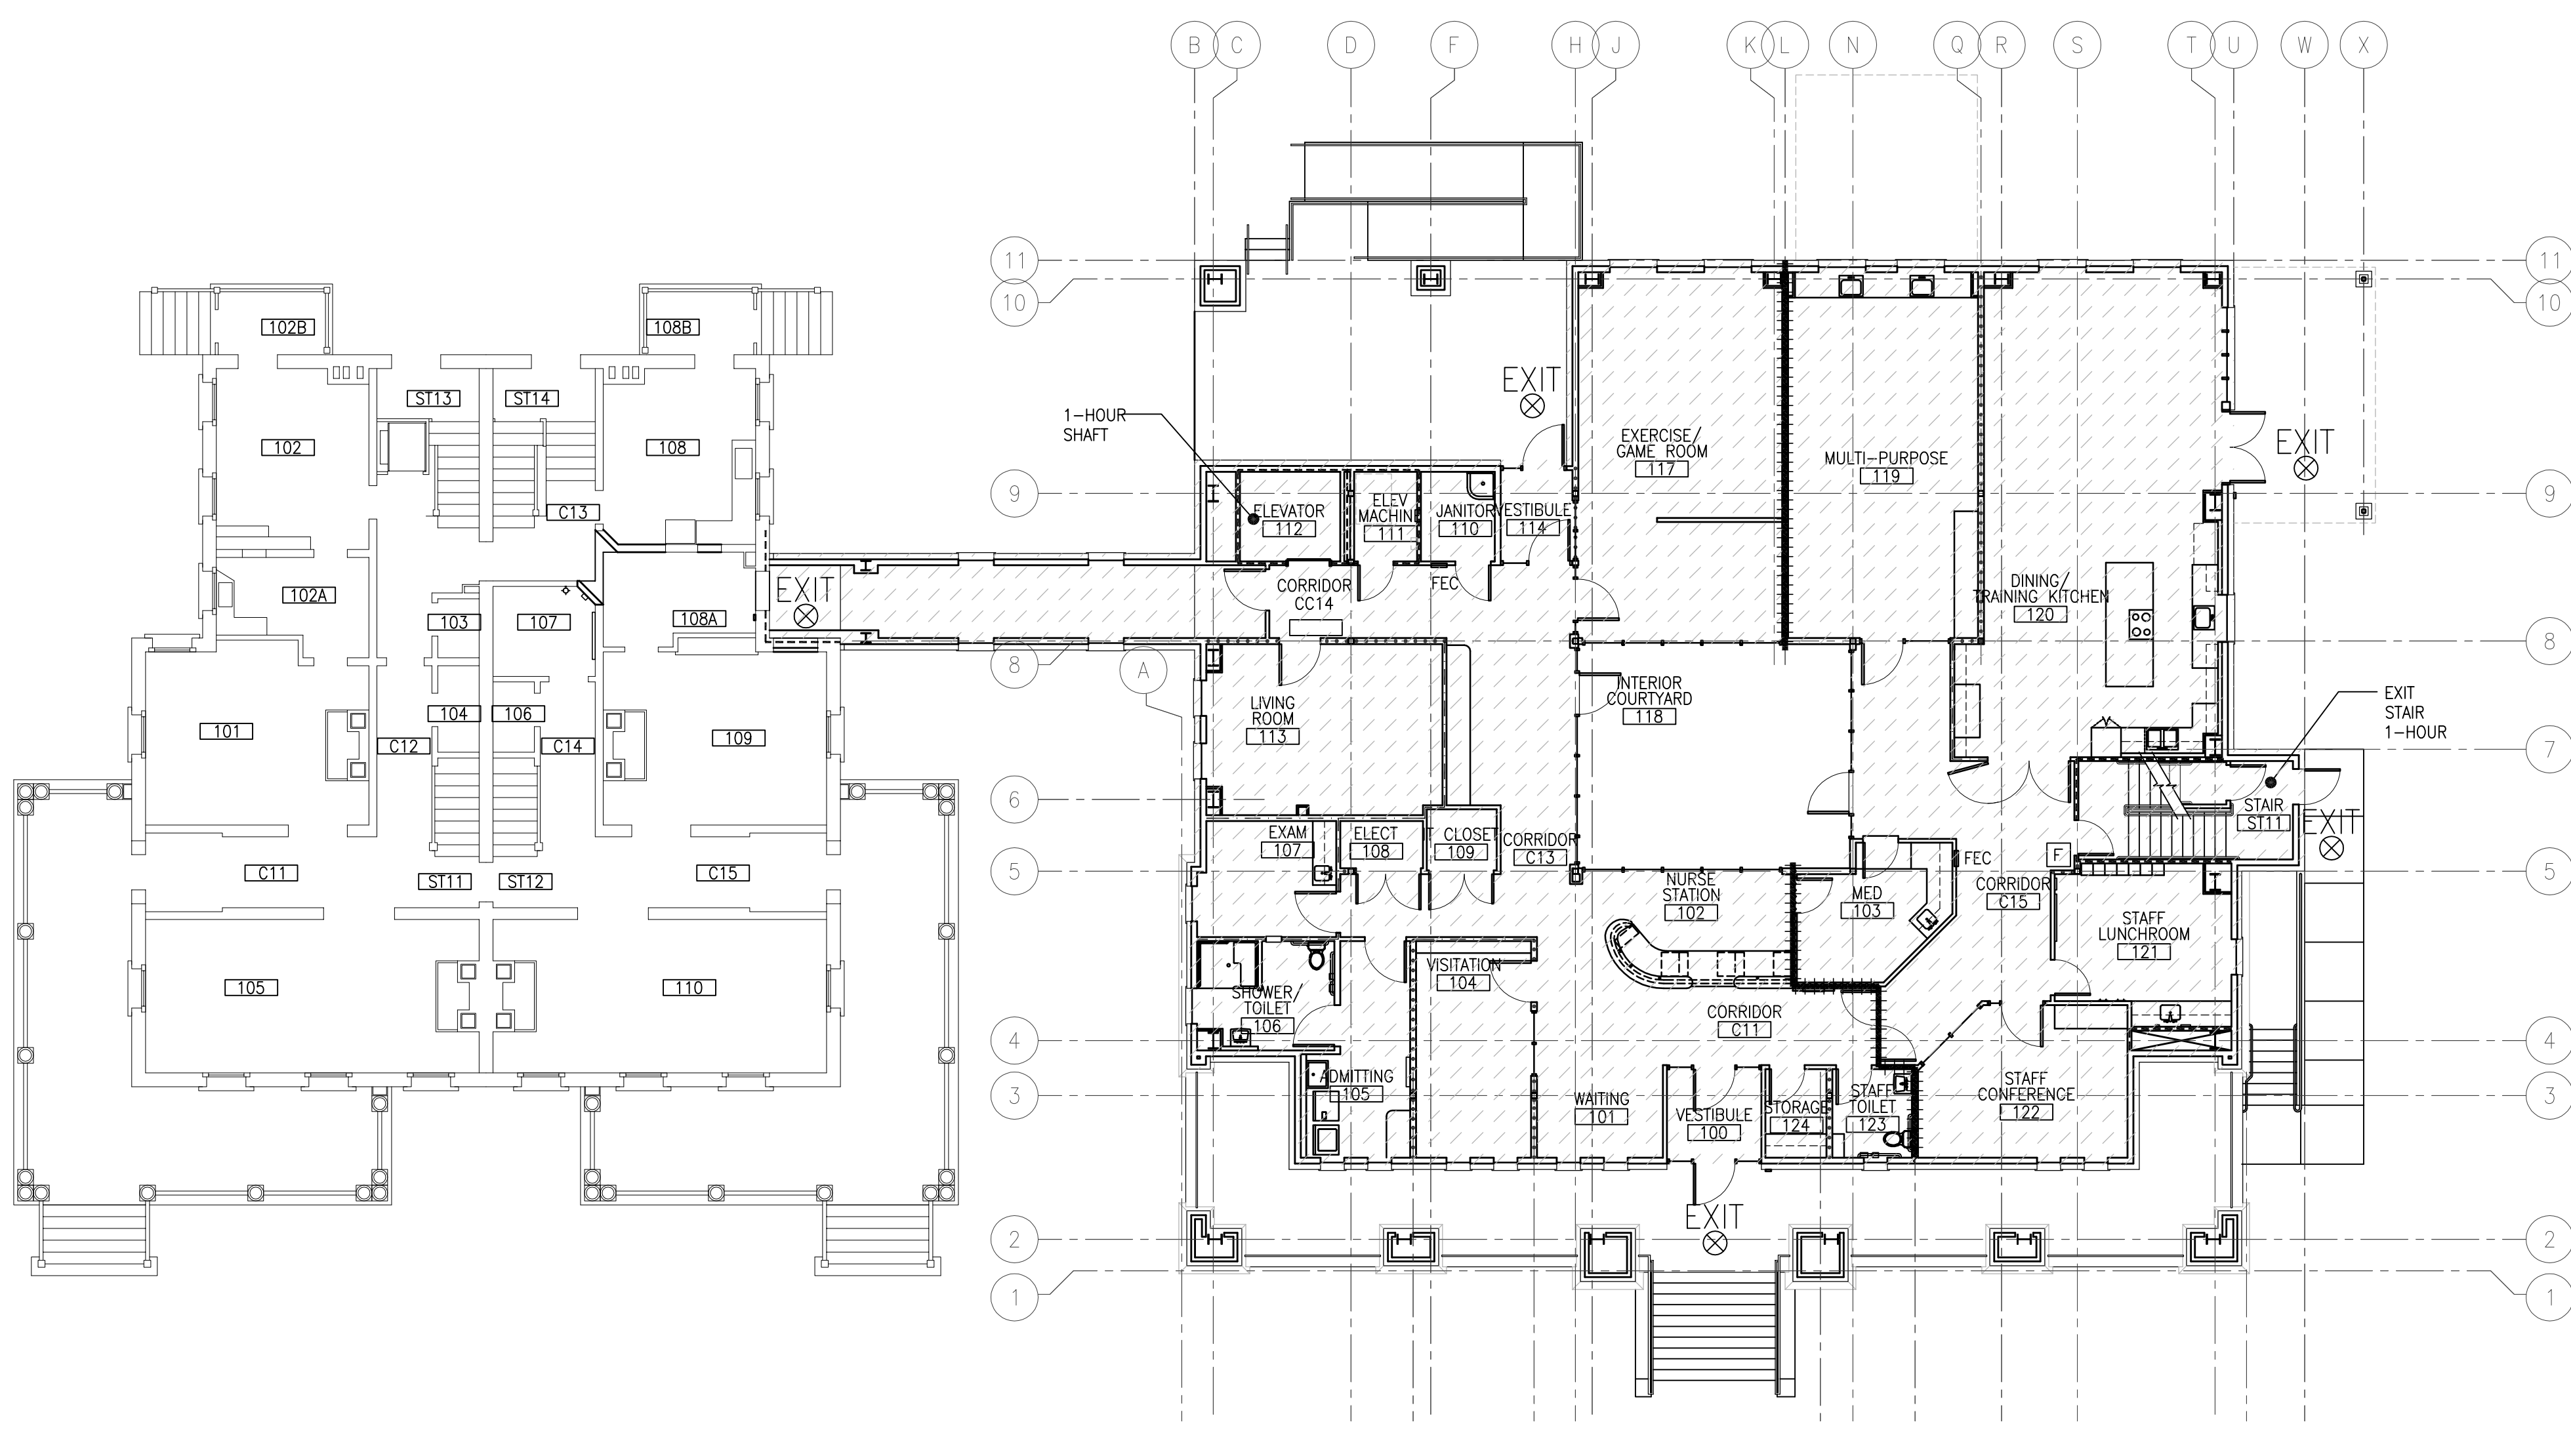

16 LIFE SAFETY PLAN - FIRST FLOOR
SCALE: 3/32" = 1'-0"

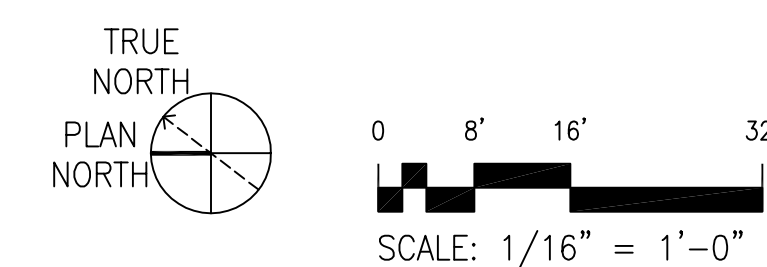


FINAL SET

METRIC CONVERSION FACTOR:
1" = 25.4mm
1'-0" = 304.8mm



DEPARTMENT OF VETERANS AFFAIRS

REVISIONS	DATE

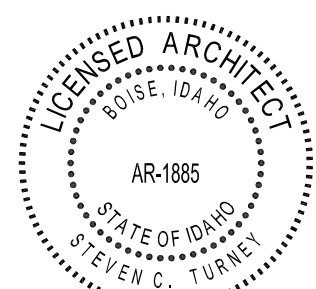

ZGA ARCHITECTS & PLANNERS, CHARTERED

408 E. Parkcenter Blvd., Suite 205 | Boise, Idaho 83706 | t: (208) 345.8872 | f: (208) 343.7182 | www.zga.com

CAD FILE NAME:
531CSI102_G201.dwg
XREF FILE NAME:
xVabard.dwg
531CSI102x0FL
531CSI102x1FL
531CSI102x2FL
531CSI102x2FL
x23a0, x23a1, x23a2

DRAWING TITLE
CODE COMPLIANCE SUMMARY

APPROVED: CHIEF OF FACILITY MANAGEMENT SERVICE

APPROVED: MEDICAL CENTER DIRECTOR

PROJECT TITLE
VA RESIDENTIAL MENTAL
HEALTH FACILITY
VA-260-11-RP-0663

BUILDING NUMBER
123

LOCATION
VAMC BOISE, IDAHO

DATE
JULY 18, '12

PROJECT NO.
531-CSI-102

DRAWING NO.
G2.01

DWG OF