


KEYED NOTES:


1. XXXXXXXXXXXXXXXX

GENERAL NOTES:

1. CONNECT OCCUPANCY SENSORS IN CORRIDORS TO ONE SWITCH LEG CIRCUIT.

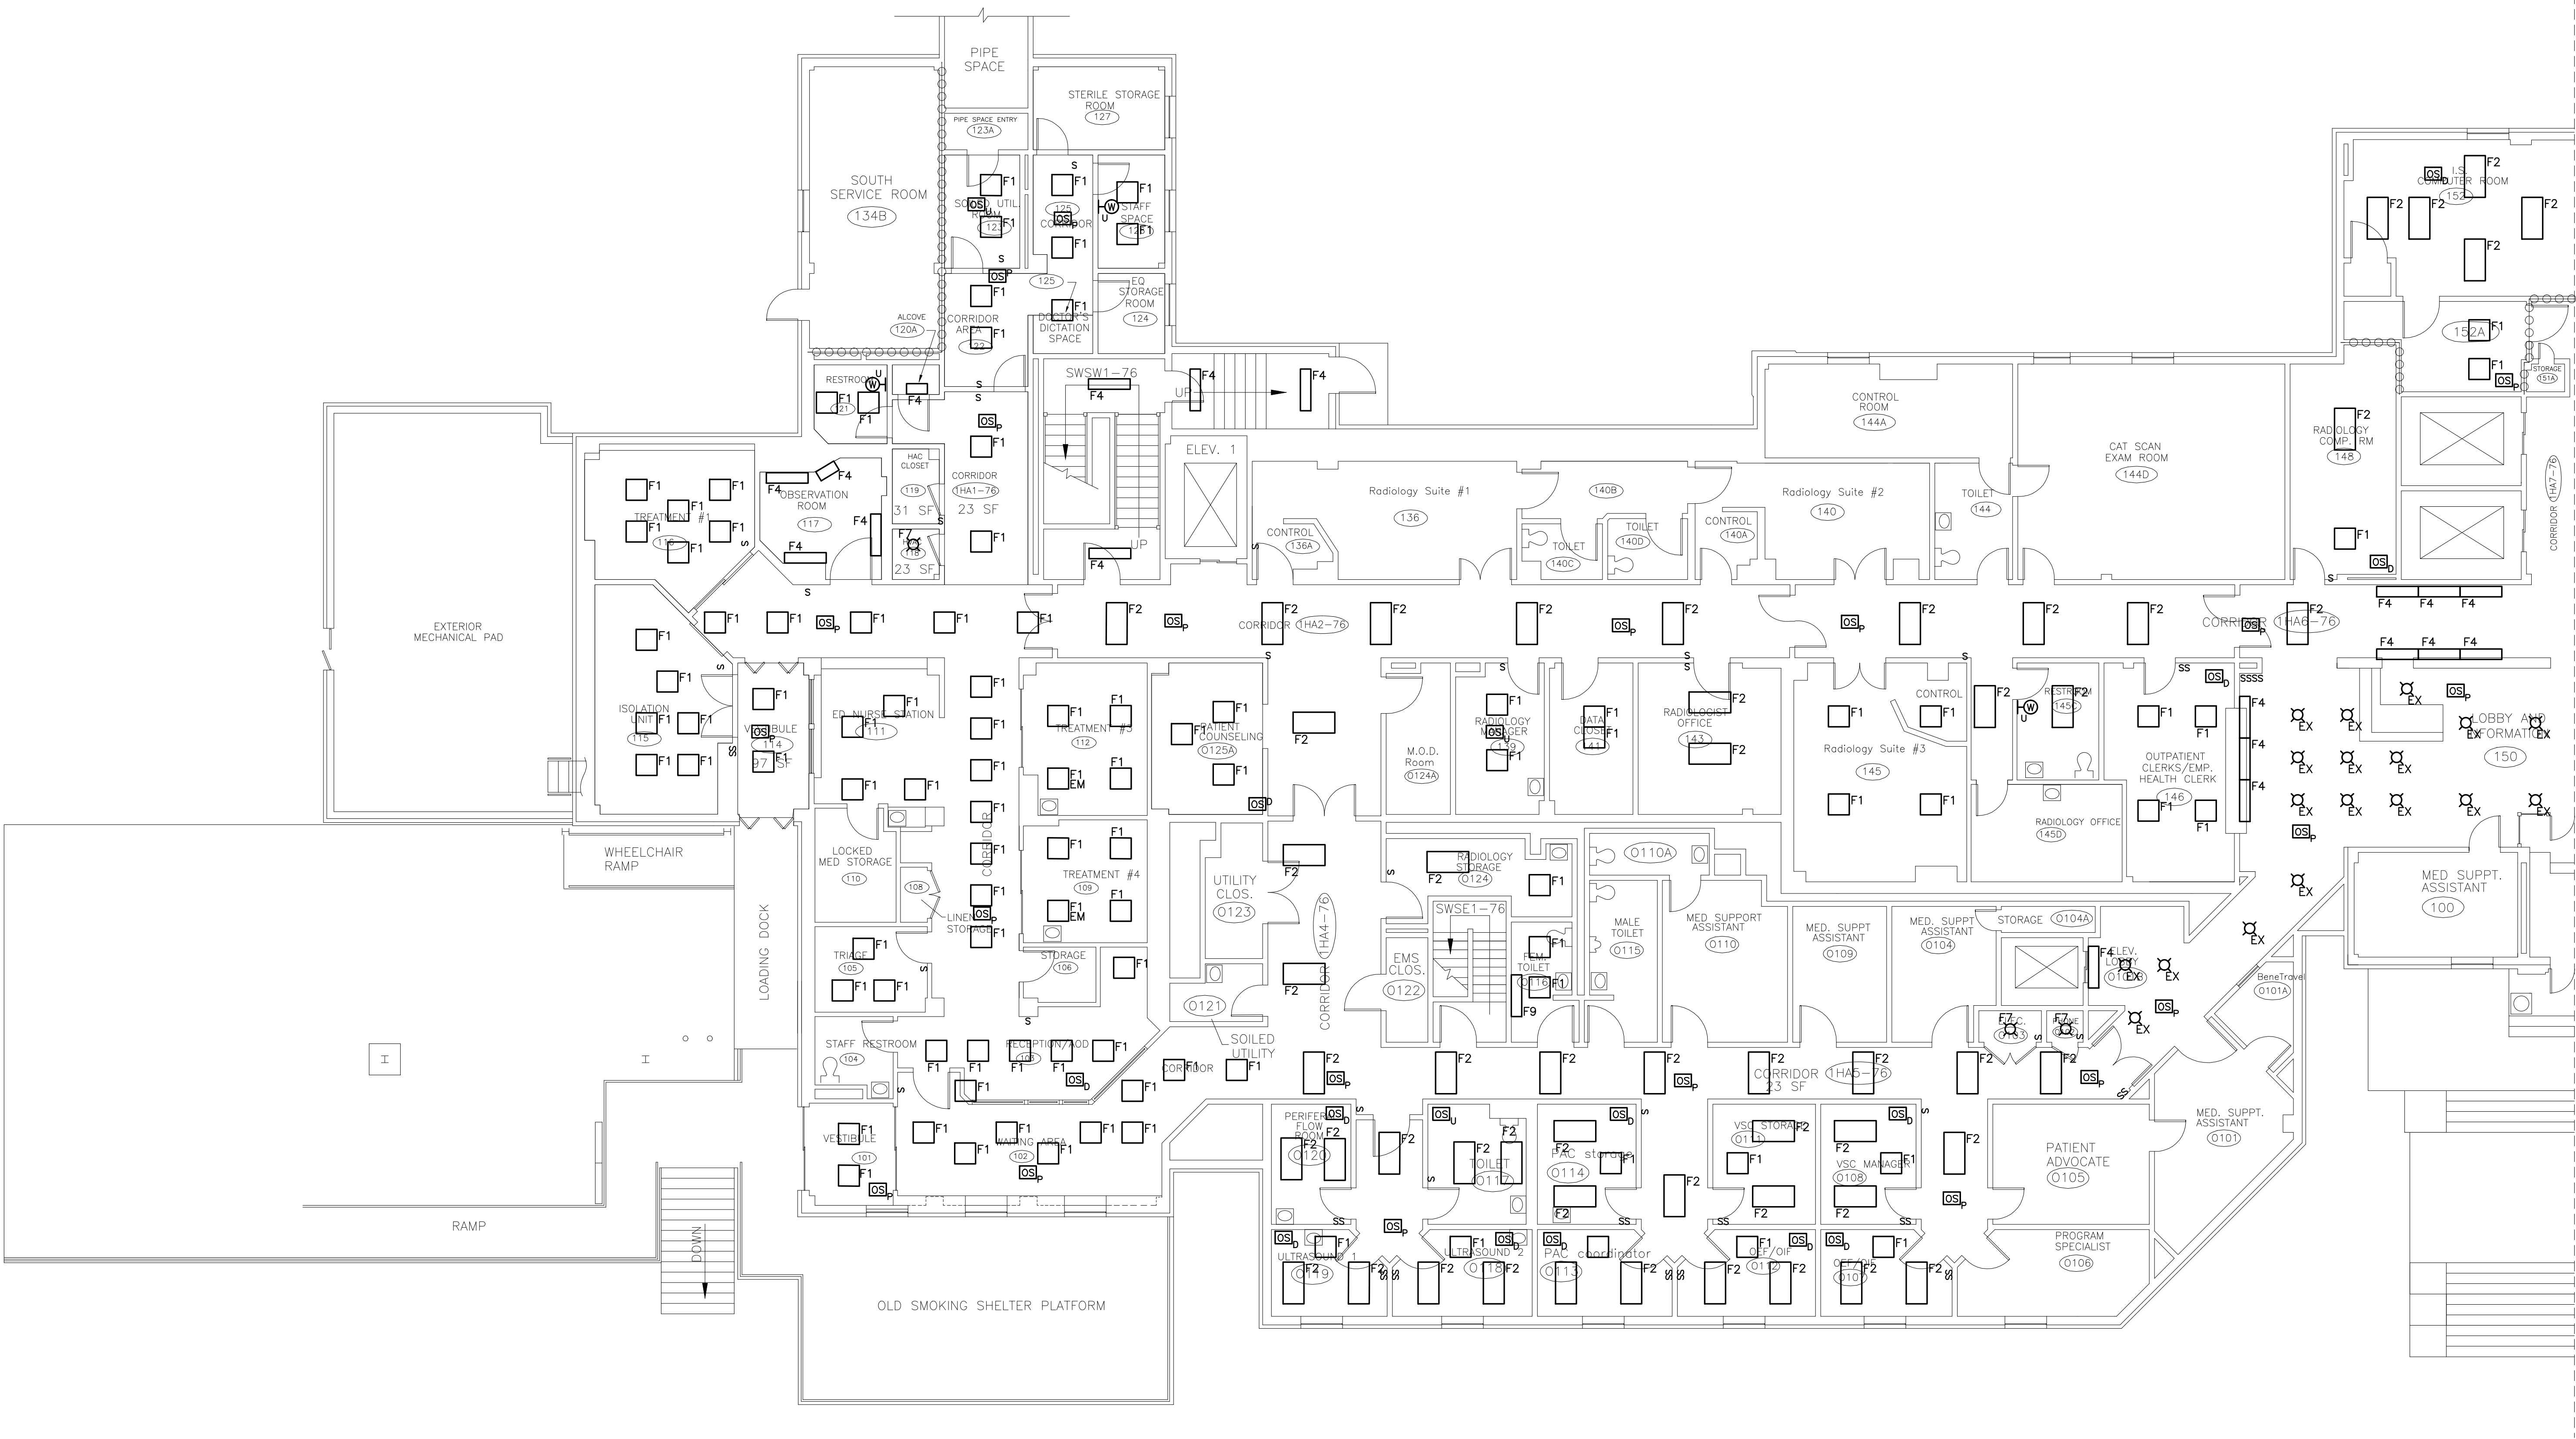

1 FIRST FLOOR ELECTRICAL PLAN
SCALE: 1/8"=1'-0"

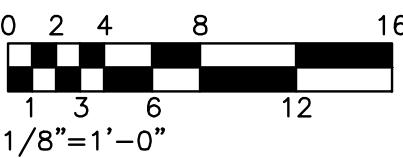

Revisions	Date	<div><div></div><div><div>Bergmann</div><div>associates</div></div><div><div>www.bergmannpc.com</div><div>28 East Main Street</div><div>200 First Federal Plaza</div><div>Rochester, New York 14614</div><div>585.232.5135 / 585.232.4652 fax</div><div>Engineers / Architects / Planners / Surveyors</div></div></div>	ALL WORK TO BE IN ACCORDANCE WITH N.F.P.A., NATIONAL STATE AND CITY CODES & O.S.H.A.		Approved: A.J.G.E. _____ Date _____	Approved: Fire Chief _____ Date _____	Approved: Energy Engineer _____ Date _____	Drawing Title FIRST FLOOR-SOUTH WING ELECTRICAL PLAN	Project Title ENERGY CONSERVATION MEASURES AT THE BATH VAMC	Date 08/15/2012	Project No. 528A6-12-629
			Approved: Logistics Manager _____ Date _____	Approved: Interior Designer _____ Date _____	Approved: Safety Officer _____ Date _____	Approved: M&R Foreman _____ Date _____					
Revisions	Date		Approved: Infection Control Mgr. _____ Date _____	Approved: Info. Sys. _____ Date _____	Approved: Industrial Hygienist _____ Date _____	_____ Date _____	Approved: Eng. Project Supervisor _____ Date _____	Building No. 76	Checked JJD	Drawn TLS	DRAWING NO. 76-E-104 VAMC-528A6-12-629
			Approved: Chief Security _____ Date _____	Approved: Women's Health Rep _____ Date _____	Approved: Space Owner _____ Date _____	_____ Date _____	Approved: Medical Center Director _____ Date _____	Location BATH, NEW YORK	Dwg 104 of 124		