



KEYED NOTES:


1. PROVIDE WIRED JUNCTION BOX FOR CONNECTION TO DDC CONTROL PANEL. CIRCUIT TO NEAREST 120V PANELBOARD. ASSUME DISTANCE TO PANELBOARD TO BE 150'.

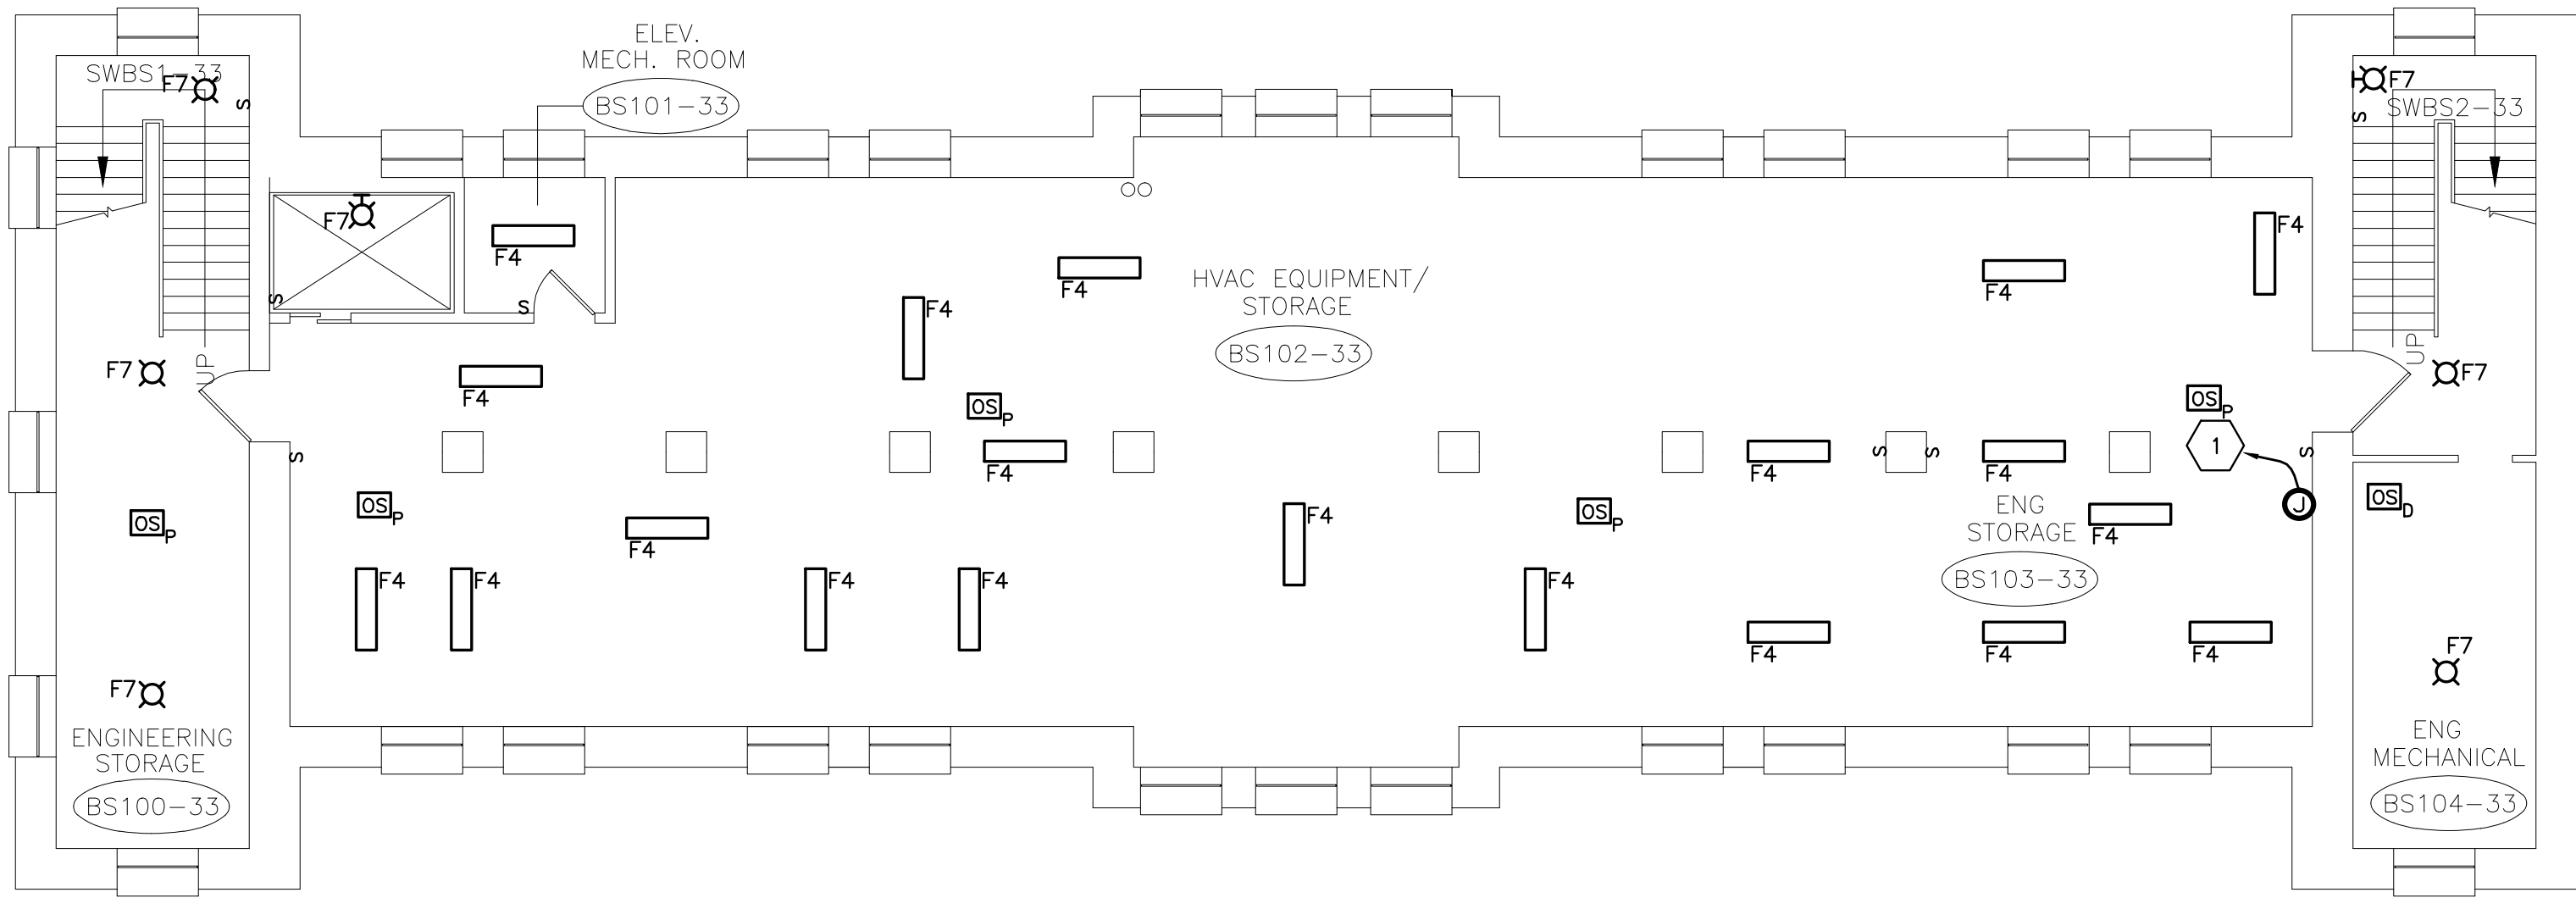

1 BASEMENT ELECTRICAL PLAN  
SCALE: 1/8"=1'-0"

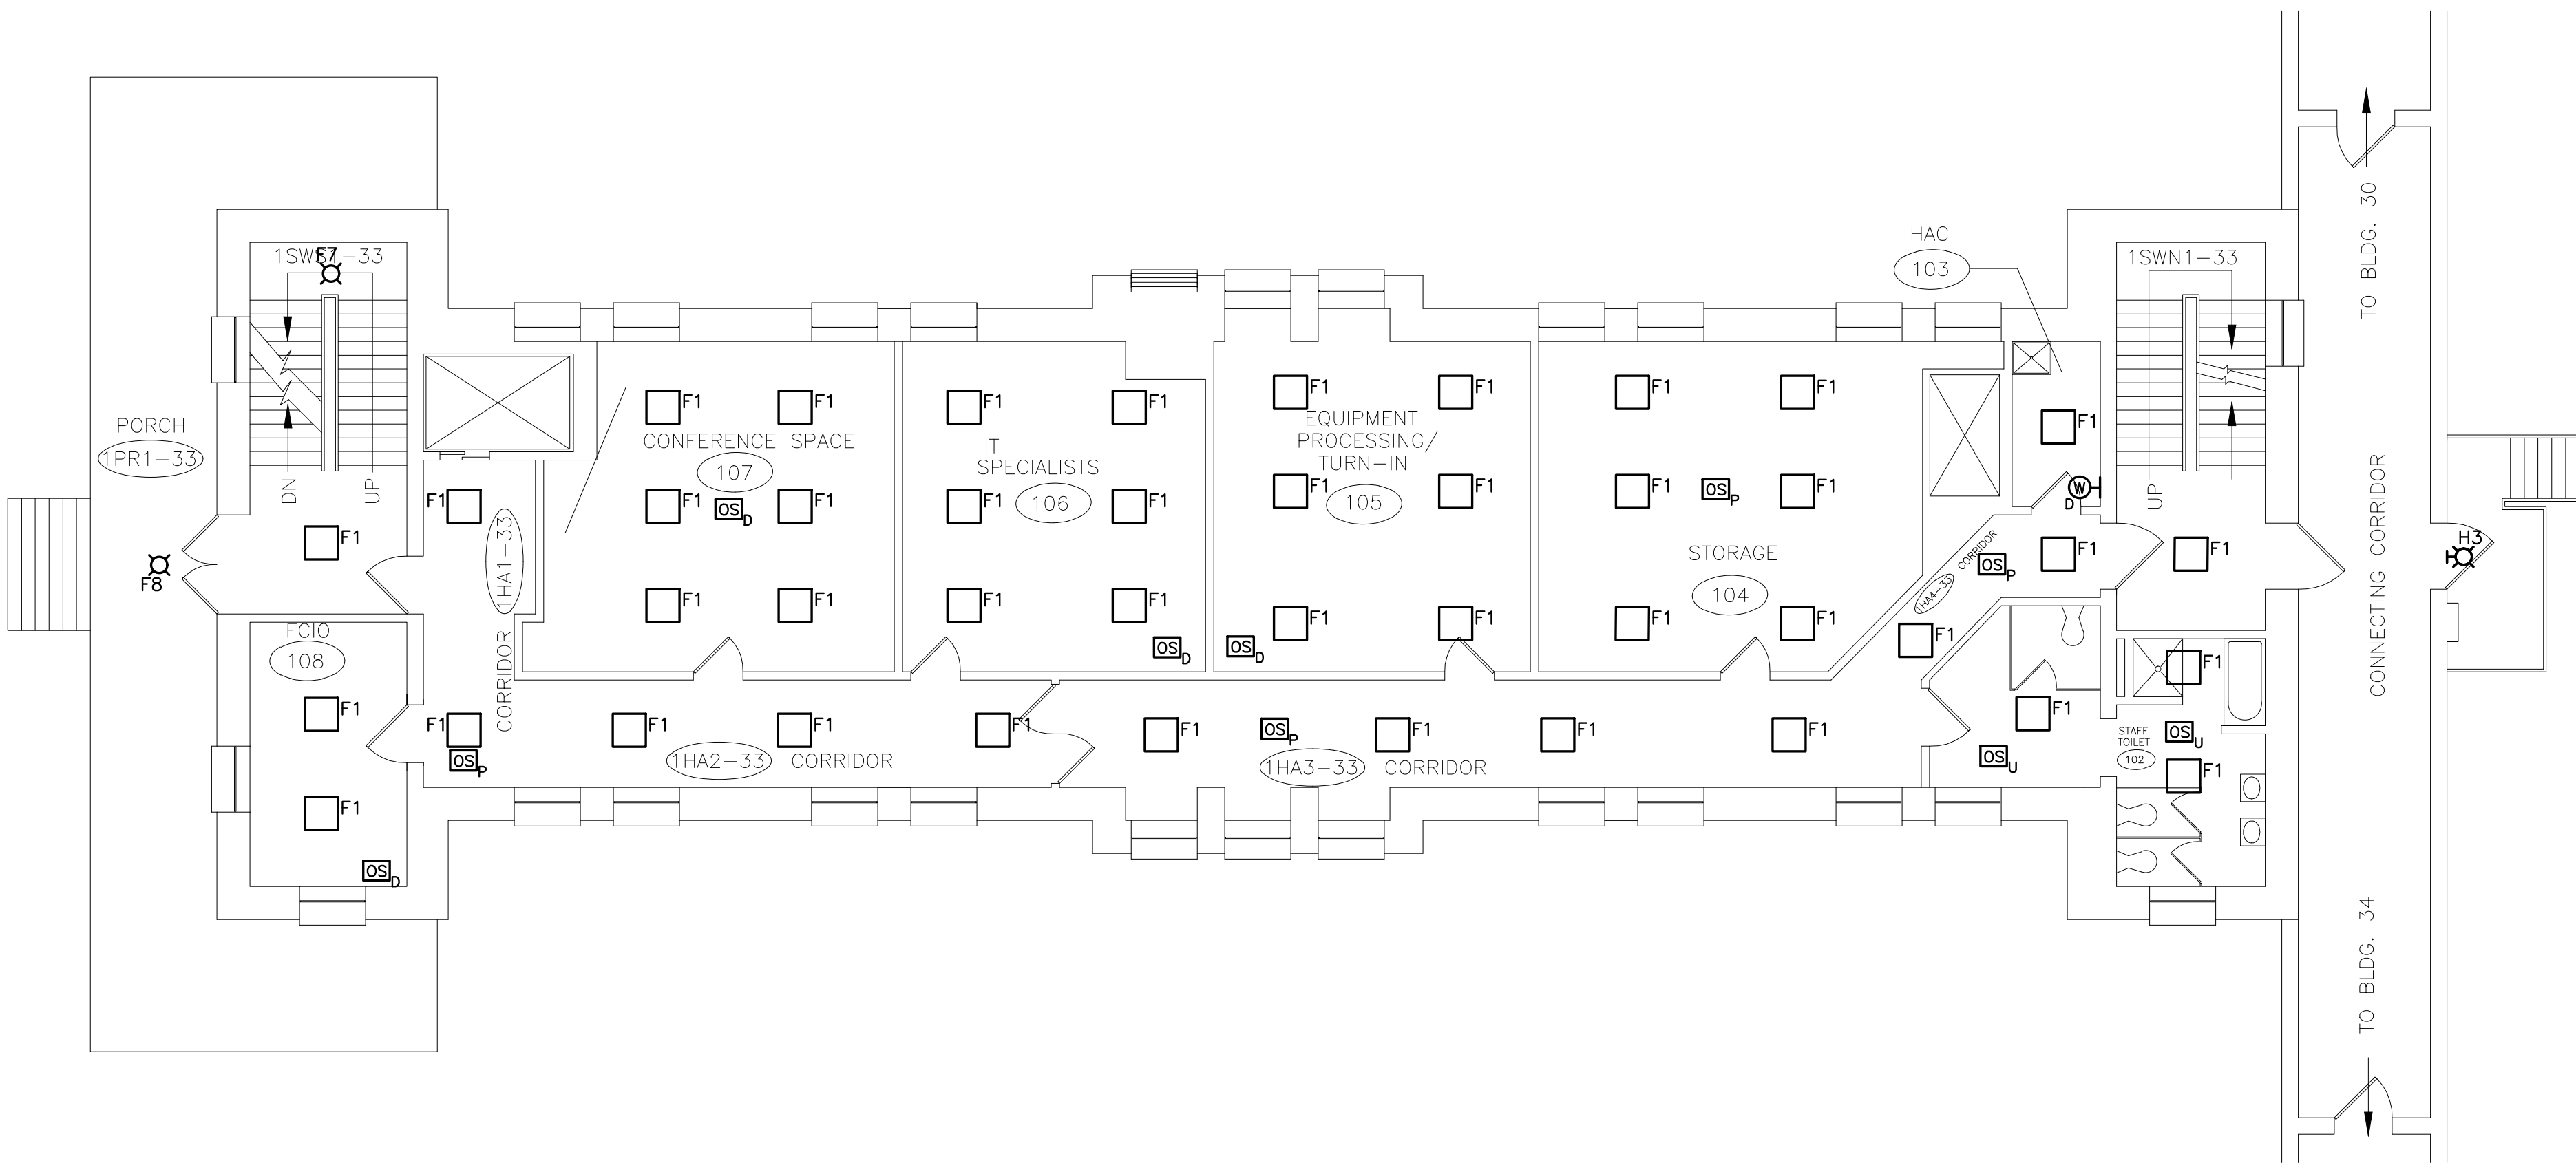

2 FIRST FLOOR ELECTRICAL PLAN  
SCALE: 1/8"=1'-0"

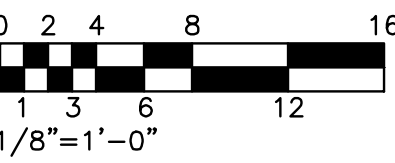

Revisions	Date	 www.bergmannpc.com 28 East Main Street Rochester, New York 14614 585.232.5135 / 585.232.4652 fax Engineers / Architects / Planners / Surveyors	ALL WORK TO BE IN ACCORDANCE WITH N.F.P.A., NATIONAL, STATE AND CITY CODES & O.S.H.A.	Approved: A.P.G.E. _____ Date _____	Approved: Fire Chief _____ Date _____	Approved: Energy Engineer _____ Date _____	Drawing Title BASEMENT & FIRST FLOOR ELECTRICAL PLANS	Project Title ENERGY CONSERVATION MEASURES AT THE BATH VAMC	Date 08/15/2012	
			Approved: Logistics Manager _____ Date _____	Approved: Interior Designer _____ Date _____	Approved: Safety Officer _____ Date _____	Approved: M&R Foreman _____ Date _____	Approved: Eng. Project Supervisor _____ Date _____	Building No. 33	Project No. 528A6-12-629	
Revisions	Date		Approved: Infection Control Mgr. _____ Date _____	Approved: Info. Sys. _____ Date _____	Approved: Industrial Hygienist _____ Date _____	_____ Date _____	Approved: Medical Center Director _____ Date _____	Location BATH, NEW YORK	DRAWING NO. VAMC-528A6-12-629 33-E-101	
			Approved: Chief Security _____ Date _____	Approved: Women's Health Rep _____ Date _____	Approved: Space Owner _____ Date _____	_____ Date _____	Approved: _____ Date _____		Dwg. 96 of 124	