



GENERAL SHEET NOTES:

1. VERTICAL ELEVATIONS ARE SHOWN FROM FLOOD ELEVATION FOR THE BOILER ROOM WAS ESTABLISHED AS 457.2. ALL ELEVATIONS SHOWN WITHIN THE CONTRACT DRAWINGS ARE RELATIVE TO THIS ELEVATION.

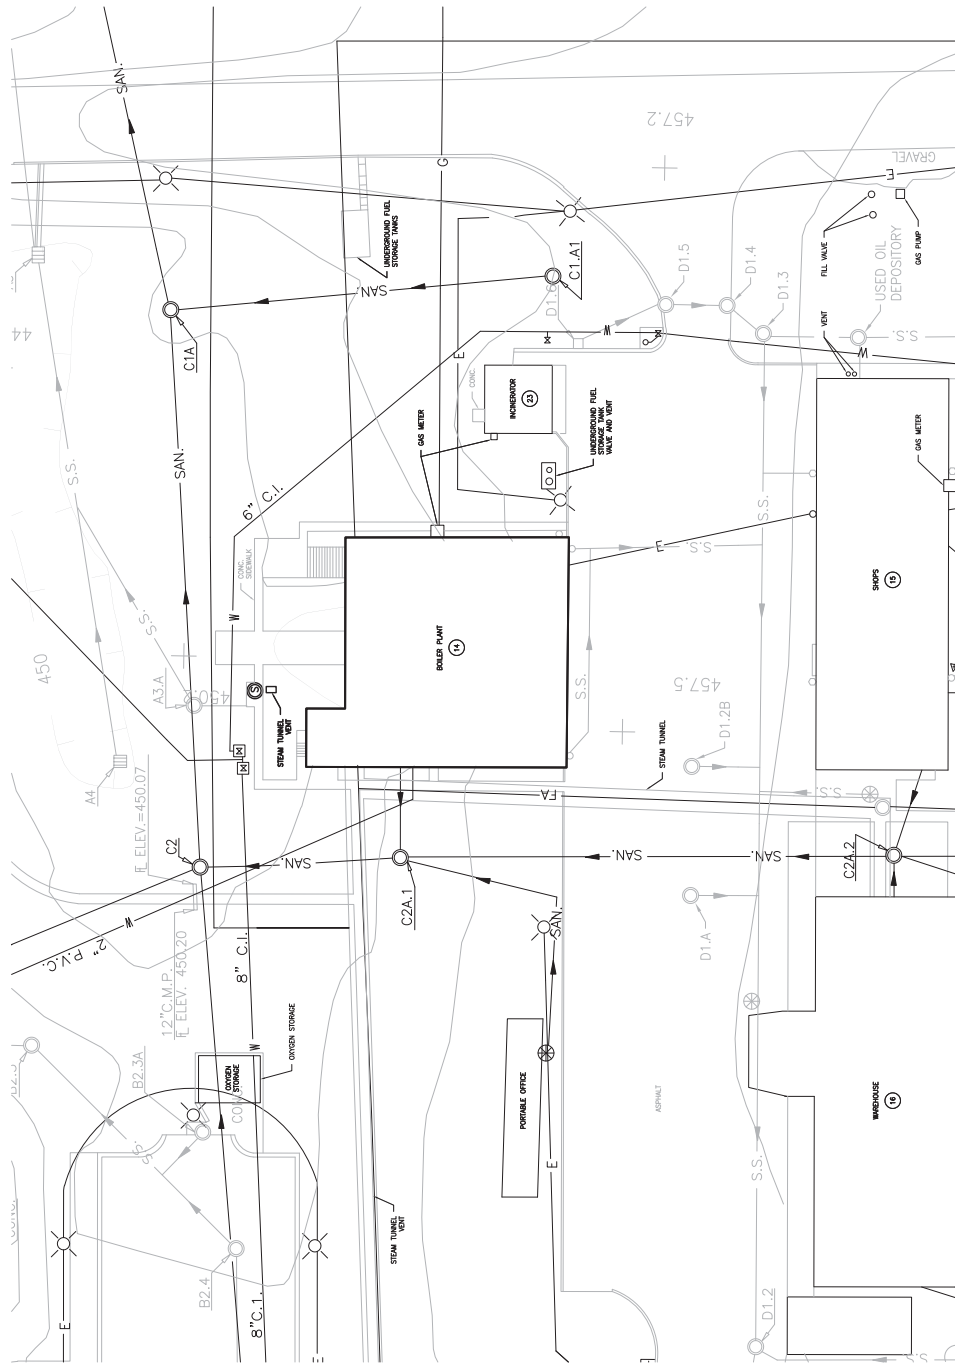


1 CIVIL SITE PLAN
SCALE: 1/8" = 1'-0"

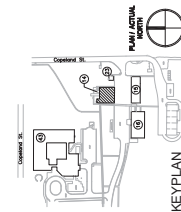

CONSTRUCTION BID DOCUMENTS

CONSULTANTS:		Office of Construction and Facilities Management Department of Veterans Affairs	
PROJECT TITLE REPLACE BOILERS VAMC, MARION, IL		PROJECT NUMBER 657A5-17-107	
DRAWING TITLE CIVIL SITE PLAN		DRAWING NUMBER 14	
APPROVED PROJECT DIRECTOR		CHECKED MR	
DATE 03-23-2018		DESIGNED DS	
MILITARY REGION LLC PROFESSIONAL ENGINEER		MILITARY REGION LLC PROFESSIONAL ENGINEER	
CONSULTANTS:		CONSULTANTS:	
NO.		NO.	
DESCRIPTION		DESCRIPTION	
DATE		DATE	

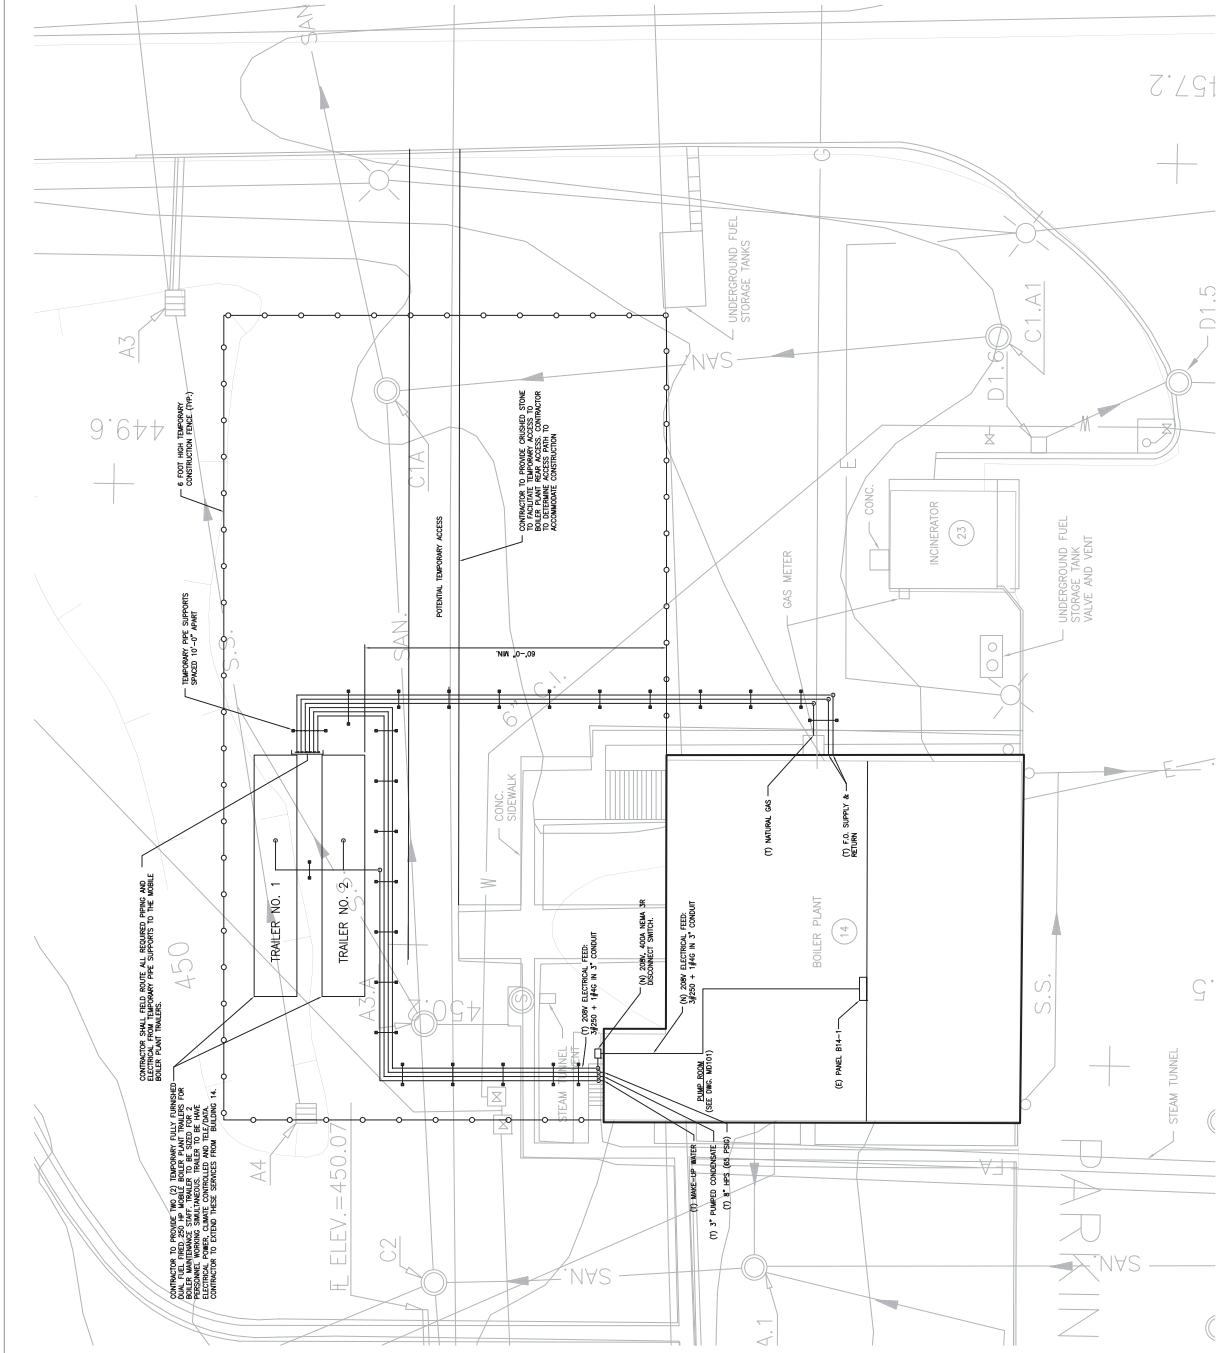

1 CONSTRUCTION SITE PLAN - TEMPORARY BOILERS AND EQUIPMENT TRAILERS
SCALE 1"=15'

CONSULTANTS:

NO.	DESCRIPTION	DATE

PROJECT INFORMATION

PROJECT NO. 657A5-17-107

PROJECT NAME REPLACE BOILERS
VAMC, MARION, IL

LOCATION 2401 MAIN ST., MARION, IL 62959

DATE 03-29-2018

DESIGNED BY MR

CHECKED BY DS

APPROVED BY [Signature]

GENERAL SITE CONSTRUCTION
TEMPORARY BOILERS AND UTILITIES
AND CONSTRUCTION STAGING AREA

APPROVED PROJECT DESIGNER

MILLER-BENICK LLC
100 AVONDALE AVENUE, SUITE 1000
P.O. BOX 1000
MARION, IL 62959-0000
PH: 618-999-0000
FAX: 618-999-0001

Office of
Construction
and Facilities
Management

Department of
Veterans Affairs

Project Number 657A5-17-107

Sheet Number 14

Drawing Number GC101

- GENERAL SHEET NOTES:
1. TEMPORARY ELEVATION: THE AVERAGE FINISH FLOOR ELEVATION FOR THE BOILER ROOM WAS ESTIMATED TO BE 450.00' AS SHOWN WITHIN THE CONSTRUCTION SITE PLAN.
 2. NO WALL PENETRATIONS FOR TEMPORARY PIPES OF CONDENSATE SHALL BE MADE PRIOR TO AUTHORIZATION FROM THE COR. THE EXTERIOR WALLS CORRESPOND TO THE EXTERIOR WALLS CORRESPOND.

PHASING NOTES:

- PHASE 1 - TEMPORARY BOILER
1. WORK THIS DRAWING WITH DRAWING M011.
 2. CONTRACTOR SHALL PROVIDE TWO (2) TEMPORARY MOBILE STEAM GENERATION SYSTEMS WITH 250 HP EACH, FUEL NATURAL GAS & FUEL OIL VALVES, WATER TREATMENT SYSTEMS, FUEL OIL PUMPS, NOTE: STEAM DELIVERED TO THE BOILER ROOM SHALL BE 250 PSI.
 3. CONTRACTOR SHALL PROVIDE 6 FOOT HIGH TEMPORARY FENCE AROUND CONSTRUCTION AREA.
 4. CONTRACTOR SHALL PROVIDE TEMPORARY PIPE INSULATION, NATURAL GAS AND CONDENSATE PIPING SHALL BE INSULATED WITH 1" MINIMUM INSULATION.
 5. CONTRACTOR SHALL PROVIDE TEMPORARY PIPING INSULATION, NATURAL GAS AND CONDENSATE PIPING SHALL BE INSULATED WITH 1" MINIMUM INSULATION.
 6. CONTRACTOR SHALL PROVIDE TEMPORARY CONDENSATE PIPING AND DUMPED PUMP SYSTEMS WITH THE EXISTING STEAM GENERATION PIPING.
 7. CONTRACTOR SHALL PROVIDE TEMPORARY CONDENSATE PIPING AND DUMPED PUMP SYSTEMS WITH THE EXISTING STEAM GENERATION PIPING.
 8. CONTRACTOR SHALL PROVIDE TEMPORARY CONDENSATE PIPING AND DUMPED PUMP SYSTEMS WITH THE EXISTING STEAM GENERATION PIPING.
 9. CONTRACTOR SHALL PROVIDE TEMPORARY CONDENSATE PIPING AND DUMPED PUMP SYSTEMS WITH THE EXISTING STEAM GENERATION PIPING.

