



D1 REFLECTED CEILING PLAN - AREA A PHASE 2
1/8" = 1'-0"

- ### REFLECTED CEILING GENERAL NOTES
- CONTRACTOR TO INSTALL CEILING IN ALL ROOMS AS SHOWN IN THE REFLECTED CEILING PLAN AND AS INDICATED IN THE FINISH SCHEDULE TO RECEIVE NEW CEILINGS. FOLLOW CEILING SYMBOL LEGEND FOR CEILING LAYOUT.
 - WHERE NEW CEILING ARE INDICATED, REMOVE ALL EXISTING CEILINGS TO ALLOW FOR PROPER INSTALLATION OF NEW CEILINGS. PATCH AND REPAIR EXISTING WALLS AS REQUIRED TO INSTALL NEW FINISHES.
 - REMOVE ALL EXISTING CEILINGS TO ALLOW FOR PROPER INSTALLATION OF MECHANICAL, PLUMBING AND ELECTRICAL WORK. PATCH AND REPAIR EXISTING CEILINGS TO MATCH EXISTING OR INSTALL NEW CEILINGS AS INDICATED ON THE REFLECTED CEILING PLAN AND/OR FINISH PLAN.
 - THE CONTRACTOR MUST SUBMIT TO ARCHITECT COORDINATED REFLECTED CEILING PLAN FOR REVIEW AND APPROVAL INCORPORATING LIGHT FIXTURES, SPRINKLER HEADS AND MECHANICAL LAYOUTS.
 - REFER TO HVAC DRAWINGS FOR LOCATION OF SUPPLY DIFFUSERS, RETURN GRILLS.
 - REFER TO ELECTRICAL DRAWINGS FOR LOCATIONS OF LIGHT FIXTURES AND CEILING MOUNTED SMOKE DETECTORS, SPEAKERS, FIRE ALARM DEVICES, NURSE CALL DOME LIGHTS, ETC.
 - SPRINKLER HEADS ARE NOT INDICATED ON THE REFLECTED CEILING PLANS. SPRINKLER HEADS TO ALIGN WITH EACH OTHER IN BOTH NORTHSOUTH AND EASTWEST DIRECTIONS WHERE THEY OCCUR IN A SINGLE SPACE. SIMILARLY FOR OTHER CEILING DEVICES, THE CONTRACTOR SHALL INSTALL SUFFICIENT SPRINKLER HEADS IN ALL SPACES TO PROVIDE (100%) COVERAGE AS DEFINED IN NFPA 13. REFER TO FIRE PROTECTION DRAWINGS FOR LOCATIONS OF THE SPRINKLER HEADS.
 - THE CONTRACTOR SHALL VERIFY THAT ACCESS PANELS OF APPROPRIATE SIZE AND TYPE ARE INSTALLED IN GYPSUM BOARD CEILINGS OR SOFFITS AND OTHER NON ACCESSIBLE TYPE CEILINGS OR SOFFITS WHERE ACCESS, SERVICE OR ADJUSTMENT TO MECHANICAL, PLUMBING OR ELECTRICAL ITEMS MAY BE NEEDED. ACCESS PANELS SHALL BE OF FIRE RATED TYPE EQUAL TO THE RATING OF THE CEILING OR SOFFIT IN WHICH THEY OCCUR.
 - THE CONTRACTOR SHALL PROVIDE ACCESS PANELS IN GYPSUM BOARD CEILINGS AND IN HARD SURFACE SOFFITS SO THAT THE ARCHITECT, THE STATE AND LOCAL OFFICIALS CAN INSPECT RATED WALLS. THESE ACCESS PANELS SHALL BE LOCATED AS NECESSARY TO VIEW ALL SURFACES OF THE RATED WALLS.
 - ALL CEILING HEIGHTS TO BE 9'-0" U.N.O. ALL GWB SOFFIT HEIGHTS TO BE 8'-0" U.N.O.
 - WHERE SUPPORT WIRES FOR ACOUSTICAL CEILING GRID CANNOT BE INSTALLED VERTICALLY, THE CONTRACTOR SHALL PROVIDE A UNISTRUT BENEATH THE OBSTRUCTION AS TO PERMIT WIRES TO BE VERTICALLY ATTACHED TO THE UNISTRUT.

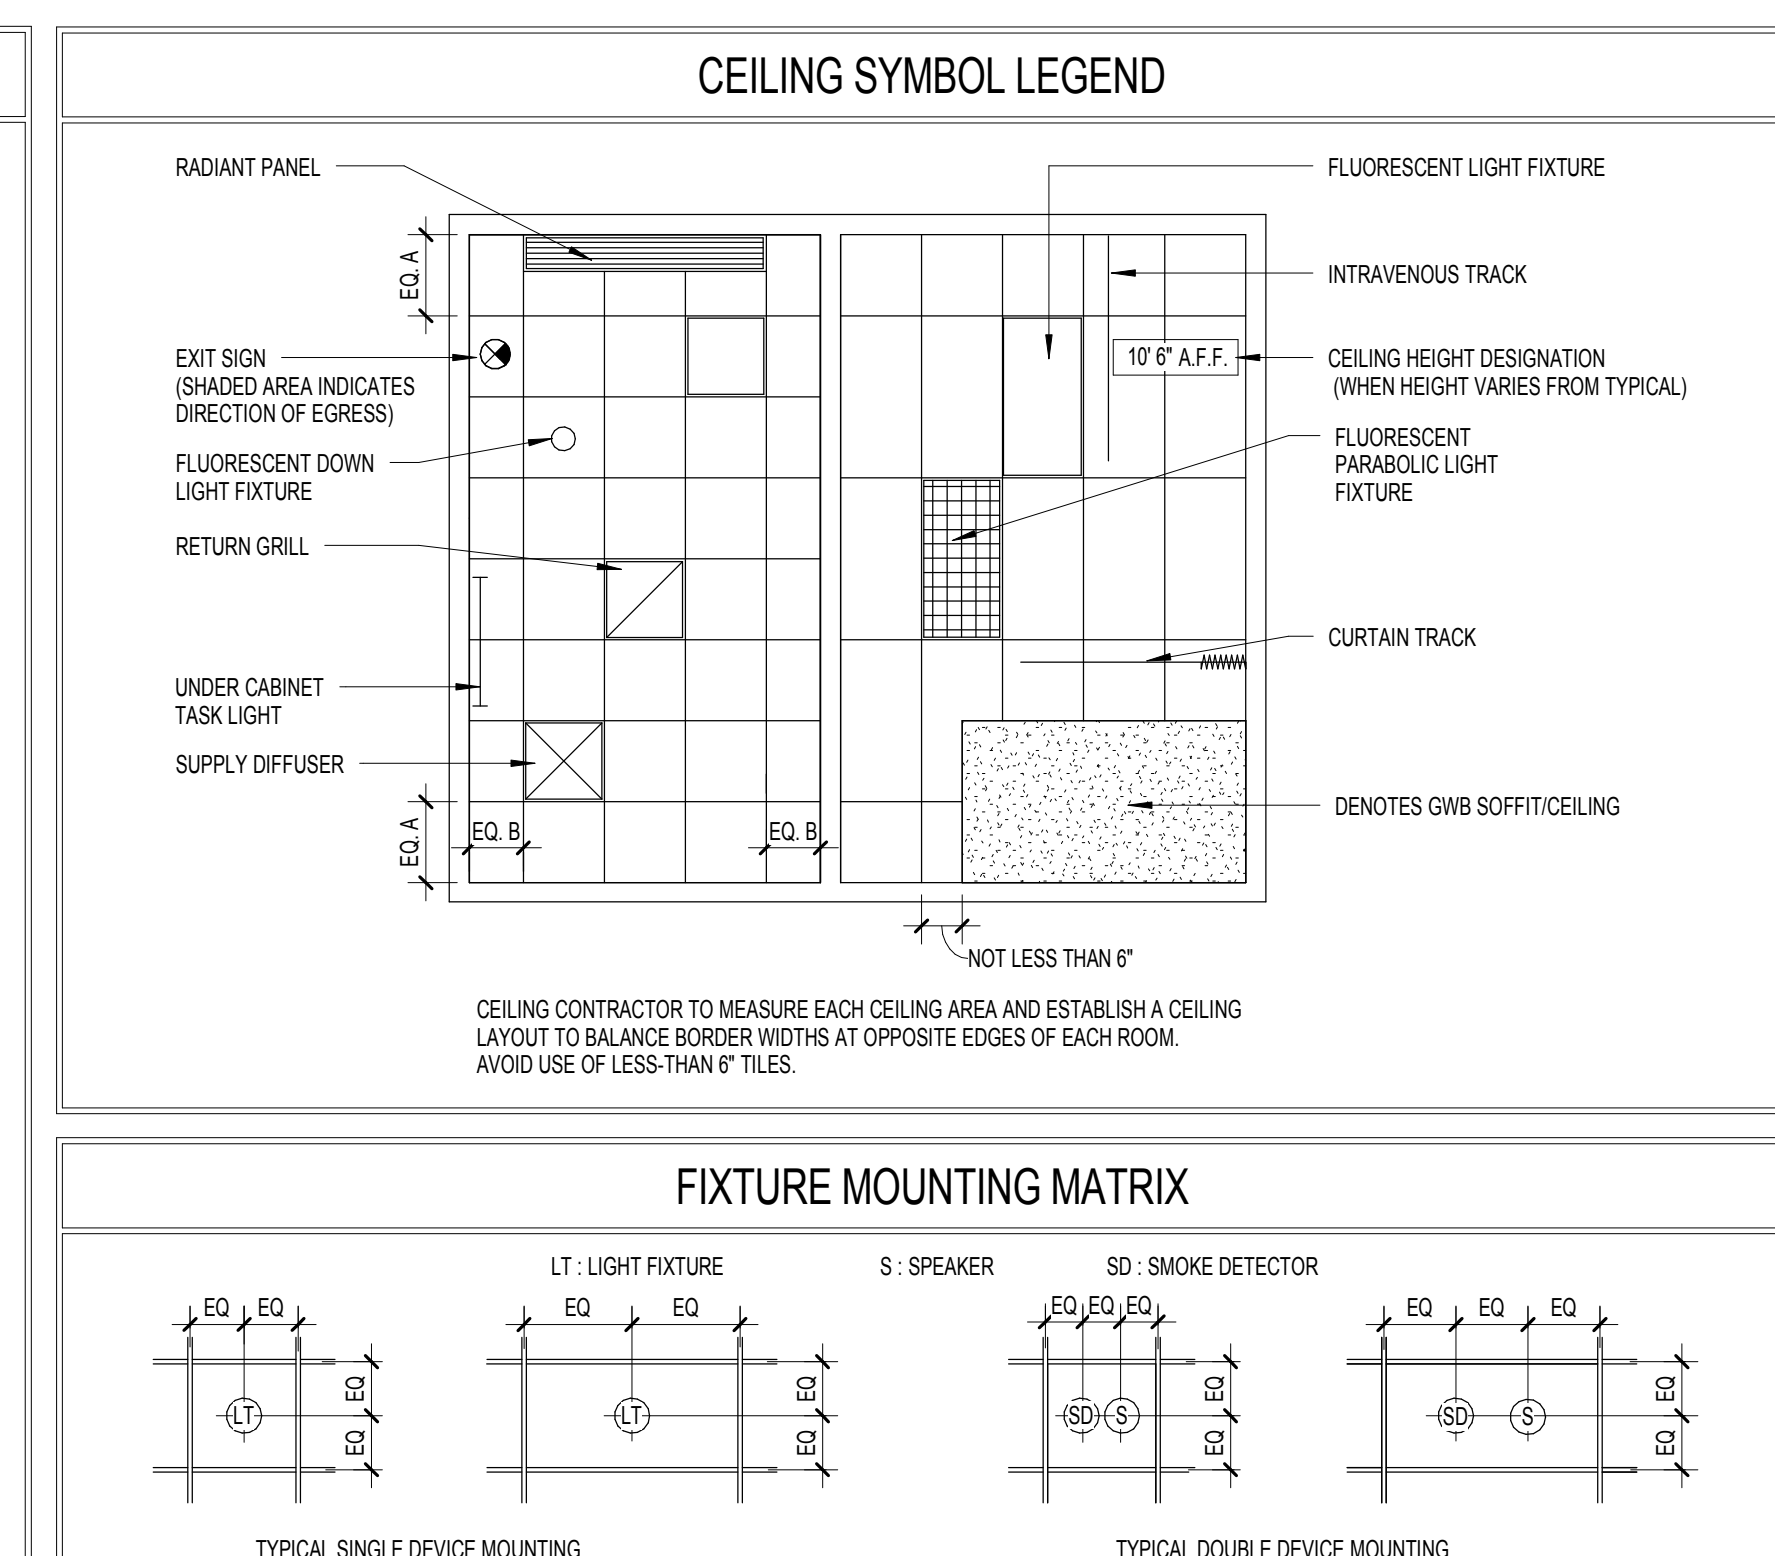

- ### CEILING KEYNOTES
- C1 PATCH SUSPENDED ACOUSTICAL TILE SYSTEM TO MATCH EXISTING ADJACENT SURFACES.
 - C2 PATCH EXISTING SUSPENDED ACOUSTICAL TILE SYSTEM TO ACCOMMODATE NEW WALL CONFIGURATION.
 - C3 NOT USED.
 - C4 REPLACE CEILING TILES AS REQUIRED TO ACCOMMODATE NEW DIFFUSERS. SEE MECHANICAL DRAWINGS.
 - C5 PAINT GWB SOFFIT, EP-2. PROVIDE REVEAL WHERE SOFFIT MEETS WALL IN THE SAME PLANE.
 - C6 PAINT GWB HEADER, EP-3.

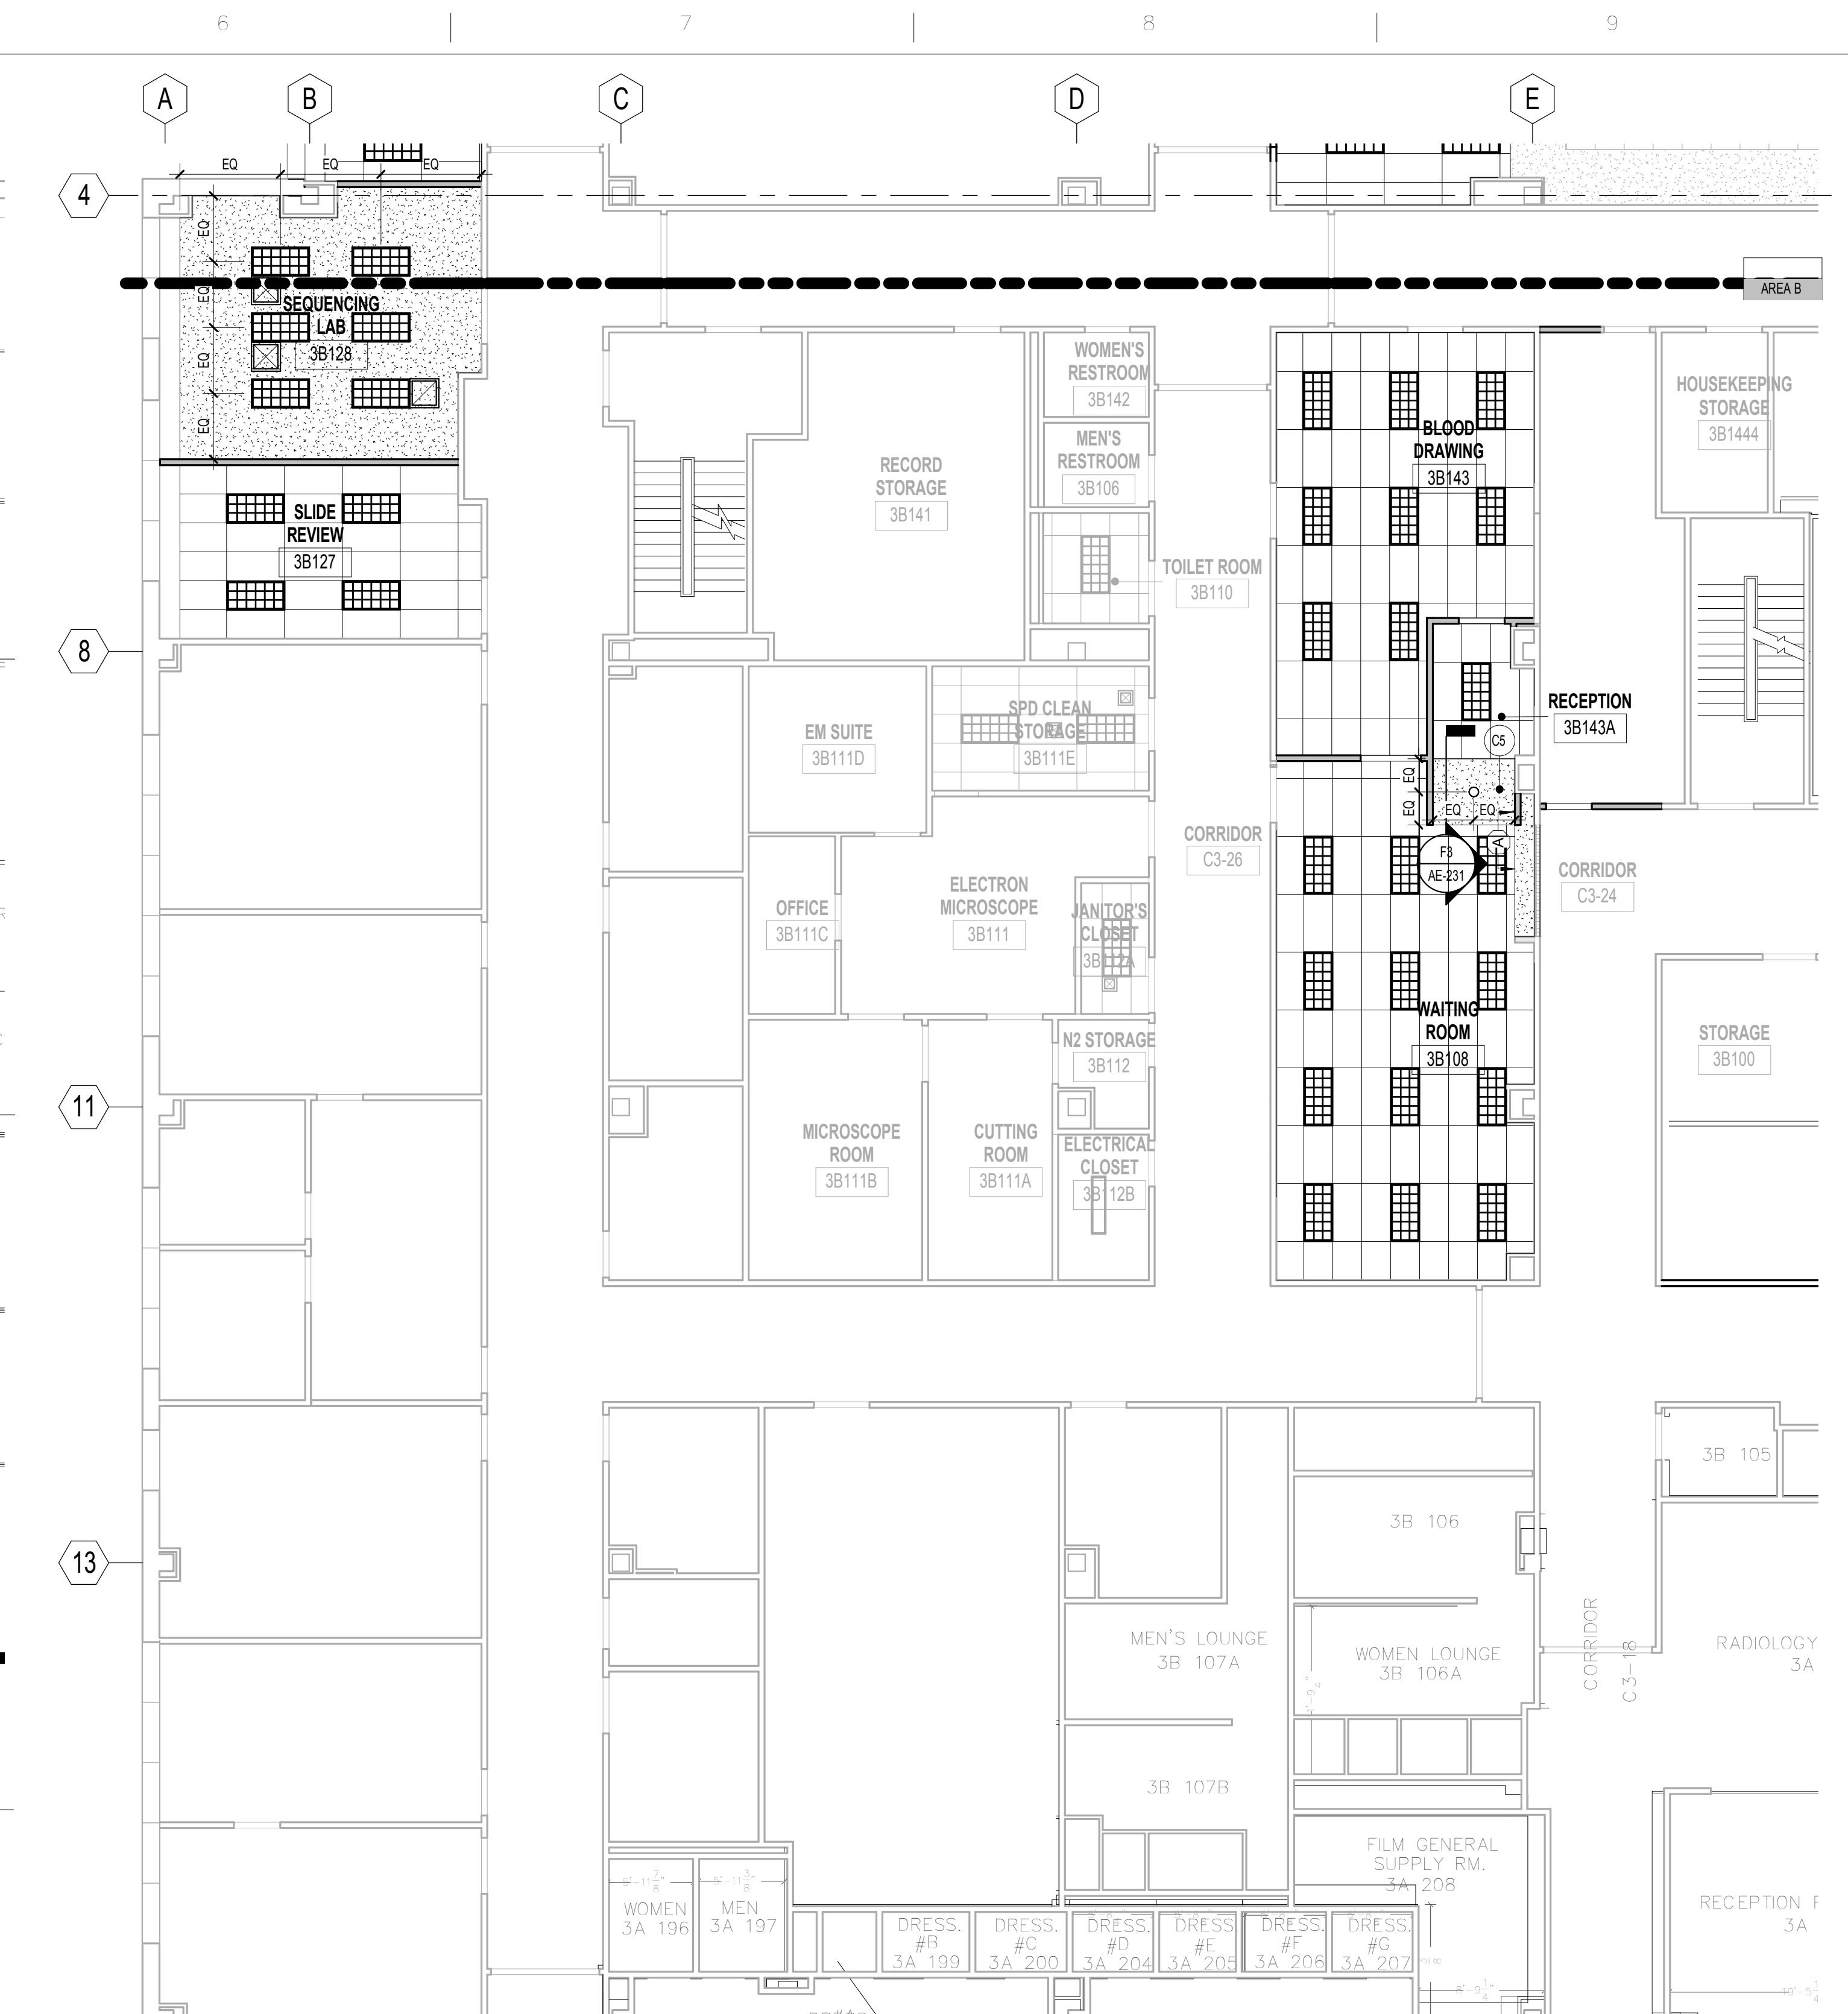

E6 REFLECTED CEILING PLAN - AREA B PHASE 2
1/8" = 1'-0"

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Revisions: _____ Date: _____						Approved: Project Director		Location: 3900 WOODLAND AVENUE PHILADELPHIA, PA 19104		Drawing Number: AE-132B					
								Date: 04-12-2012		Checked: WJ		Drawn: EN		Dwg. of	