



1 TELECOMM ROOM (16-13) WEST ELEVATION  
1/2"=1'-0"

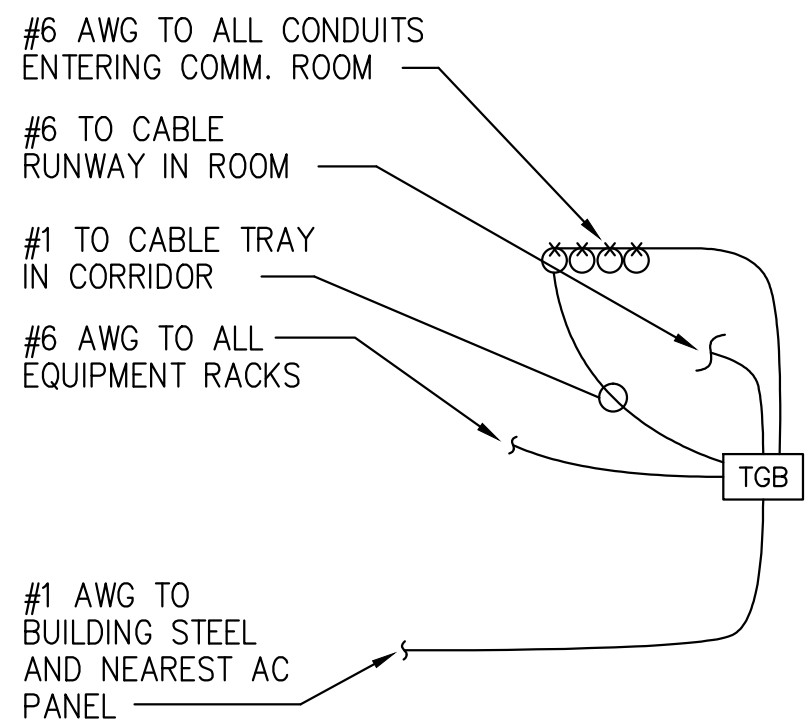

5 TELECOMM ROOM (16-13) GROUNDING DETAIL  
NTS

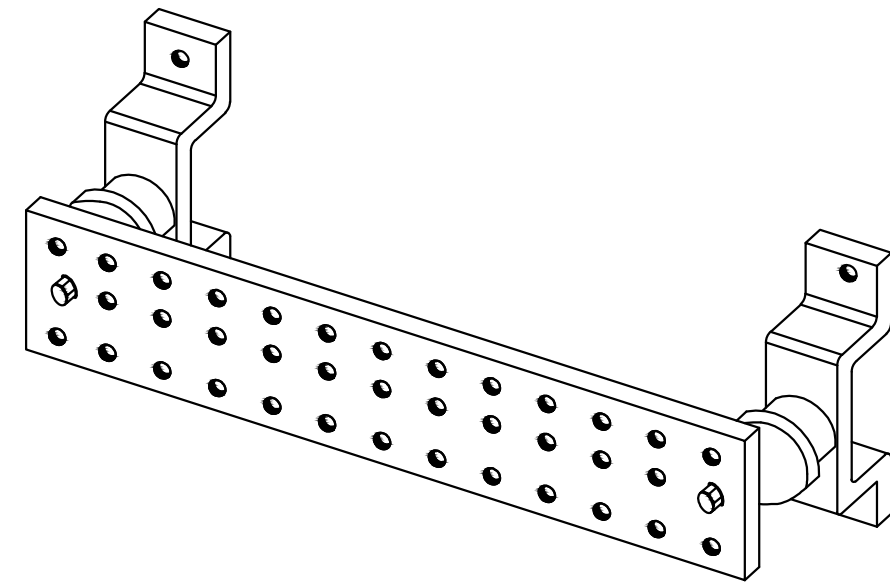


6 TELECOMM ROOM (16-13) GROUNDING BUSBAR  
NTS


WARNING  
IF THESE CONNECTORS OR CABLES ARE LOOSE OR MUST BE REMOVED PLEASE CALL BUILDING TELE-COMMUNICATIONS MANAGER

NOTE: PROVIDE AT TGB


2 TYPICAL BONDING CONDUCTOR LABEL  
NTS

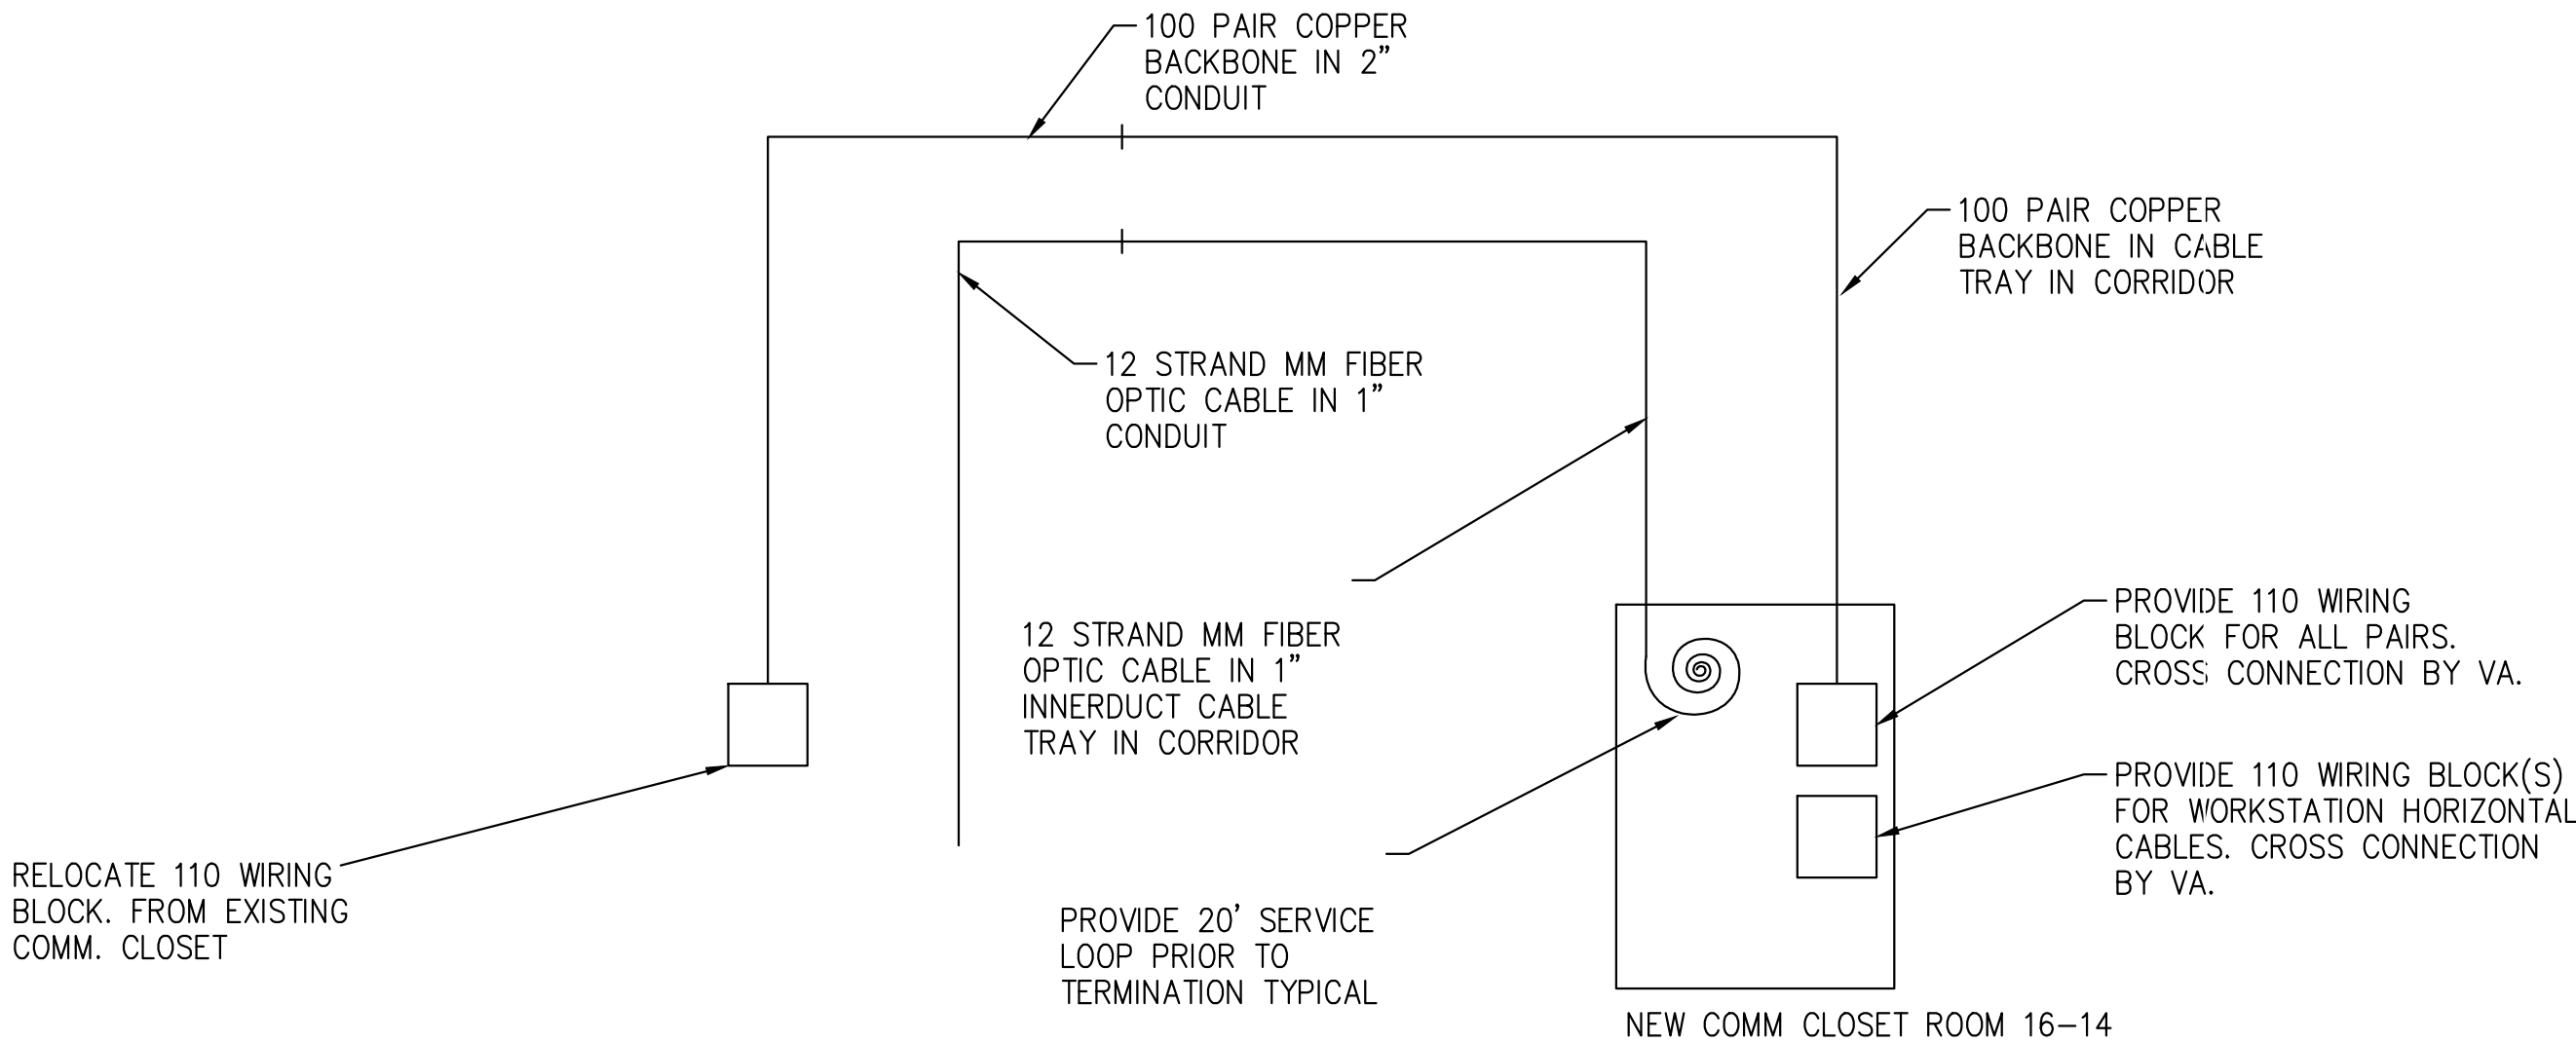

3 COMMUNICATIONS RELOCATION DIAGRAM  
NTS

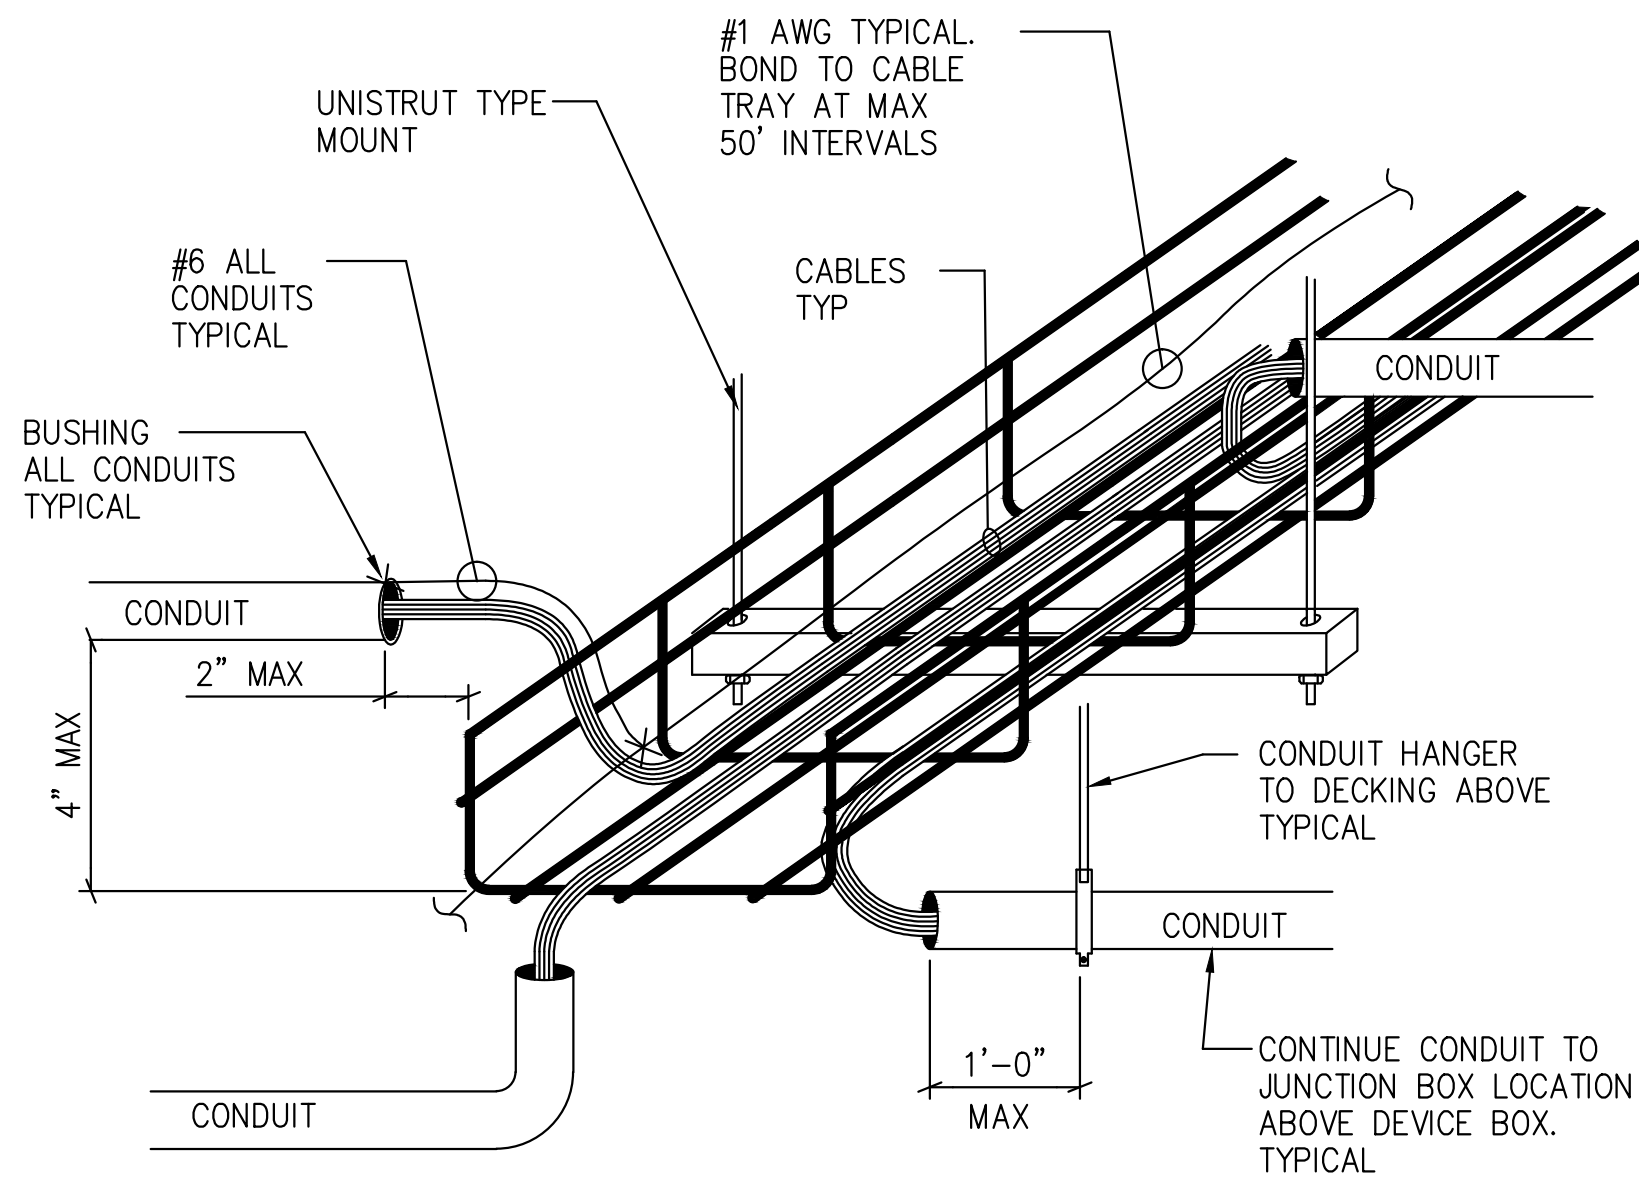


7 FLEXTRAY DETAIL  
NTS

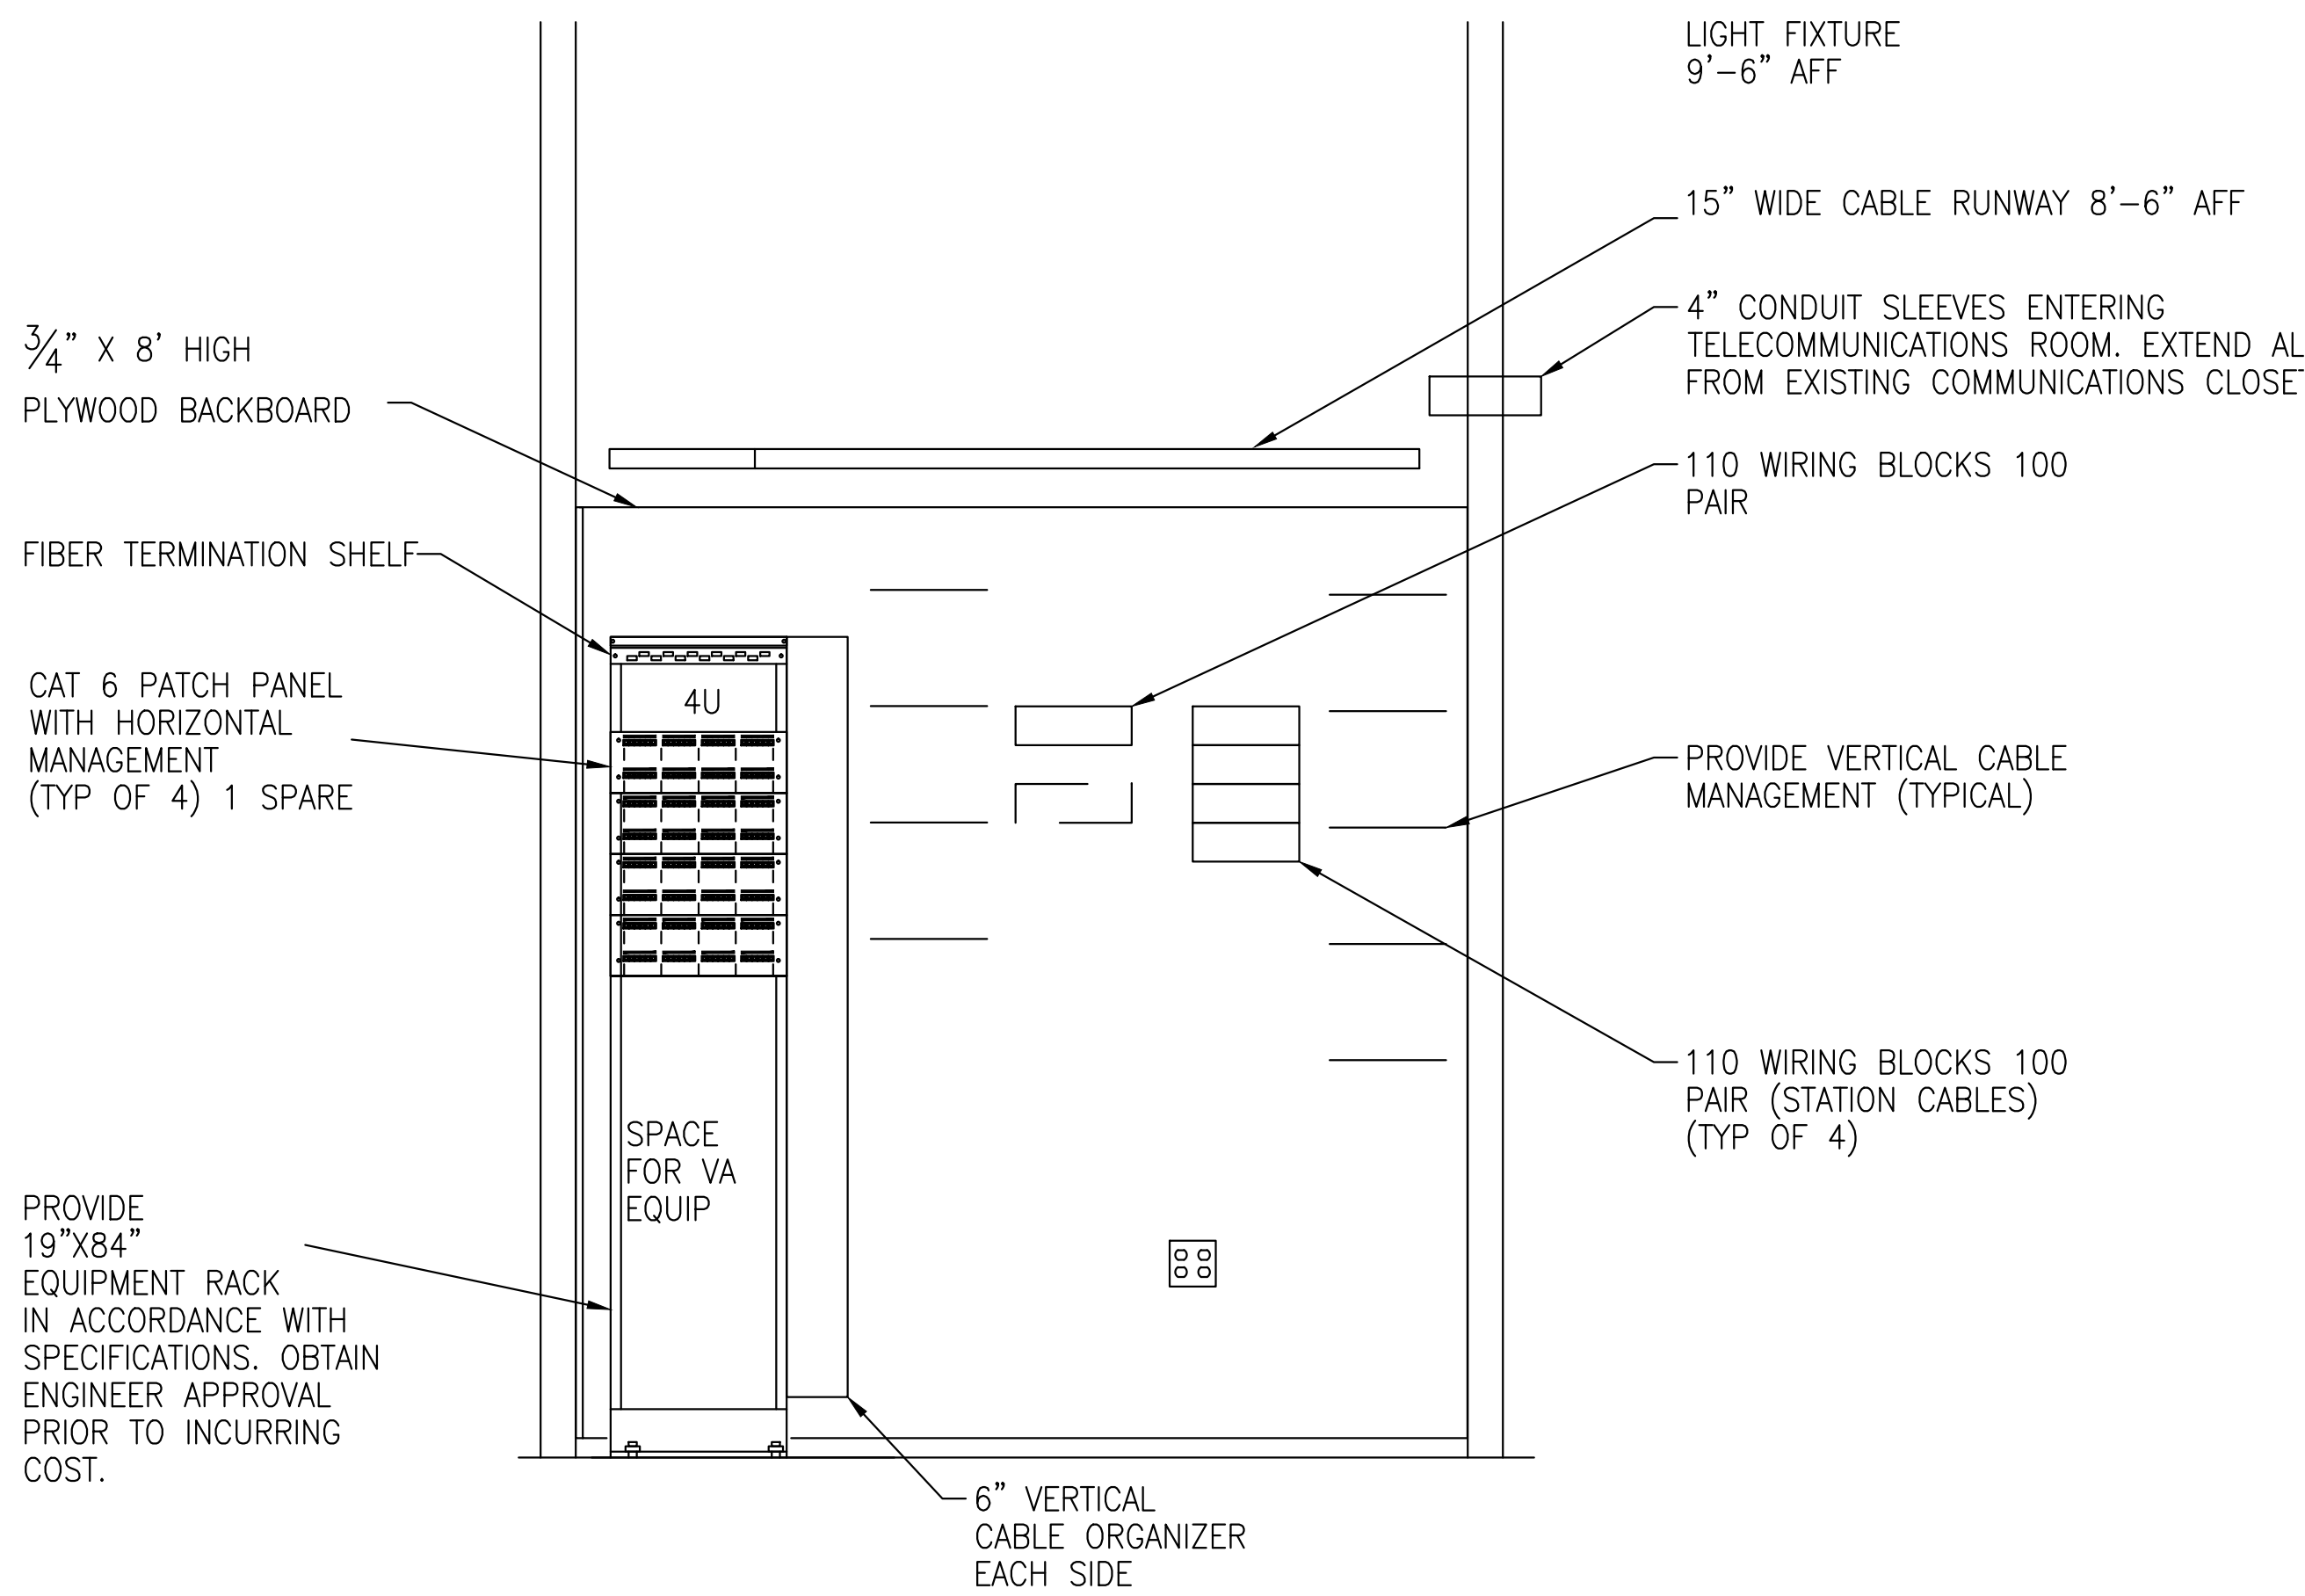

4 TELECOMM ROOM (16-13) SOUTH ELEVATION  
1/2"=1'-0"

GENERAL RENOVATION NOTES

- WALK-THRU WITH OWNER AND VERIFY ALL ELECTRICAL DEVICE LOCATIONS PRIOR TO INSTALLATION.
- ELECTRICAL EQUIPMENT LOCATIONS ARE APPROXIMATE. VERIFY EXACT EQUIPMENT LOCATIONS PRIOR TO FEEDER ROUGH-IN.
- TO MAINTAIN DRAWING CLARITY CIRCUITRY, FOR HVAC/PLUMBING EQUIPMENT MOTOR CONNECTIONS AND CONTROL DEVICES, HAS NOT BEEN SHOWN. REFER TO ELECTRICAL EQUIPMENT & CONTROL SCHEDULE ON DRAWING E-701 FOR HVAC/PLUMBING EQUIPMENT CIRCUITRY REQUIREMENTS AND ADDITIONAL INFORMATION.
- MOTOR CONNECTION LOCATIONS SHOWN ARE APPROXIMATE. VERIFY EXACT LOCATIONS WITH OTHER TRADES PRIOR TO FEEDER/ CONDUIT ROUGH-IN
- THE CONTRACTOR IS RESPONSIBLE FOR PROVIDING ALL SUPPORT HARDWARE FOR SECURELY FASTENING THE HVAC/PLUMBING ELECTRICAL CONTROL DEVICES AND ENCLOSURES TO THE BUILDING STRUCTURE. THE REQUIRED HARDWARE INCLUDES, BUT IS NOT LIMITED TO, INTERMEDIATE STEEL ANGLE, UNISTRUT, FASTENERS, JOISTS CLAMPS, ETC. MOUNT STARTERS, VFD'S, DISCONNECTS, RELAYS, AND OTHER HVAC/PLUMBING ELECTRICAL CONTROL DEVICES AND ENCLOSURES AT LOCATION(S) INDICATED IN ELECTRIC EQUIPMENT & CONTROL SCHEDULE(S). ALLOW MAINTENANCE ACCESS AND SERVICE SPACE AT EACH LOCATION.
- WHERE POSSIBLE, PROVIDE LIGHT SWITCH(ES) & WALL MOUNTED OCCUPANCY SENSOR(S) IN SAME LOCATION AS REMOVED LIGHT SWITCH(ES). PROVIDE CIRCUITRY FOR LIGHT FIXTURE CONTROL AS SHOWN.
- AIM OCCUPANCY SENSOR(S) FOR OPTIMAL COVERAGE OF SPACE. SET EACH SENSOR FOR TIME SETTING AS DIRECTED BY OWNER.
- FIRE ALARM CONDUIT SHALL BE PAINTED RED (RED "TOP-COATED" CONDUIT FROM THE CONDUIT MANUFACTURER MAY BE USED IN LIEU OF PAINTED CONDUIT) IN ACCORDANCE WITH THE REQUIREMENTS OF FIRE ALARM DETECTION AND ALARM SPECIFICATION.
- UNLESS NOTED AS EXISTING, CONTRACTOR SHALL PROVIDE ALL MATERIALS SHOWN ON DRAWINGS. ALL MATERIALS PROVIDED SHALL BE NEW, UNUSED CONDITION.
- THE CONTRACTOR IS RESPONSIBLE FOR REMOVAL OF AND RELOCATION OF OTHER ITEMS, NOT SHOWN ON DRAWINGS, AS REQUIRED TO COMPLETE ALL RENOVATIONS.
- UPON COMPLETION OF THIS PROJECT, THE CONTRACTOR SHALL ALTER EXISTING PANELBOARD CIRCUIT BREAKER DIRECTORIES, MOUNTED IN EXISTING PANELBOARDS, TO DESCRIBE NEW EQUIPMENT AND DEFINE THEIR CORRESPONDING CIRCUIT BREAKER.

		CONSULTANTS:		ARCHITECT/ENGINEERS:		Drawing Title		Project Title		Project Number		
						COMMUNICATIONS ELEVATIONS AND DETAILS		RENOVATE FOR EDUCATION SERVICE AND ADMINISTRATIVE SPACE		528A7-12-732		
						Approved: Project Director		Location		Building Number		Drawing Number
								SYRACUSE VAMC		16		
								Date		Checked	Drawn	C-101
								7/31/2012		CF	AZH	
Revisions:	Date									DWG 22 OF 23		