


three inches = one foot
 one and one half inches = one foot
 one inch = one foot
 three quarters inch = one foot
 one half inch = one foot
 three eighths inch = one foot
 one eighth inch = one foot
 one quarter inch = one foot
 one eighth inch = one foot

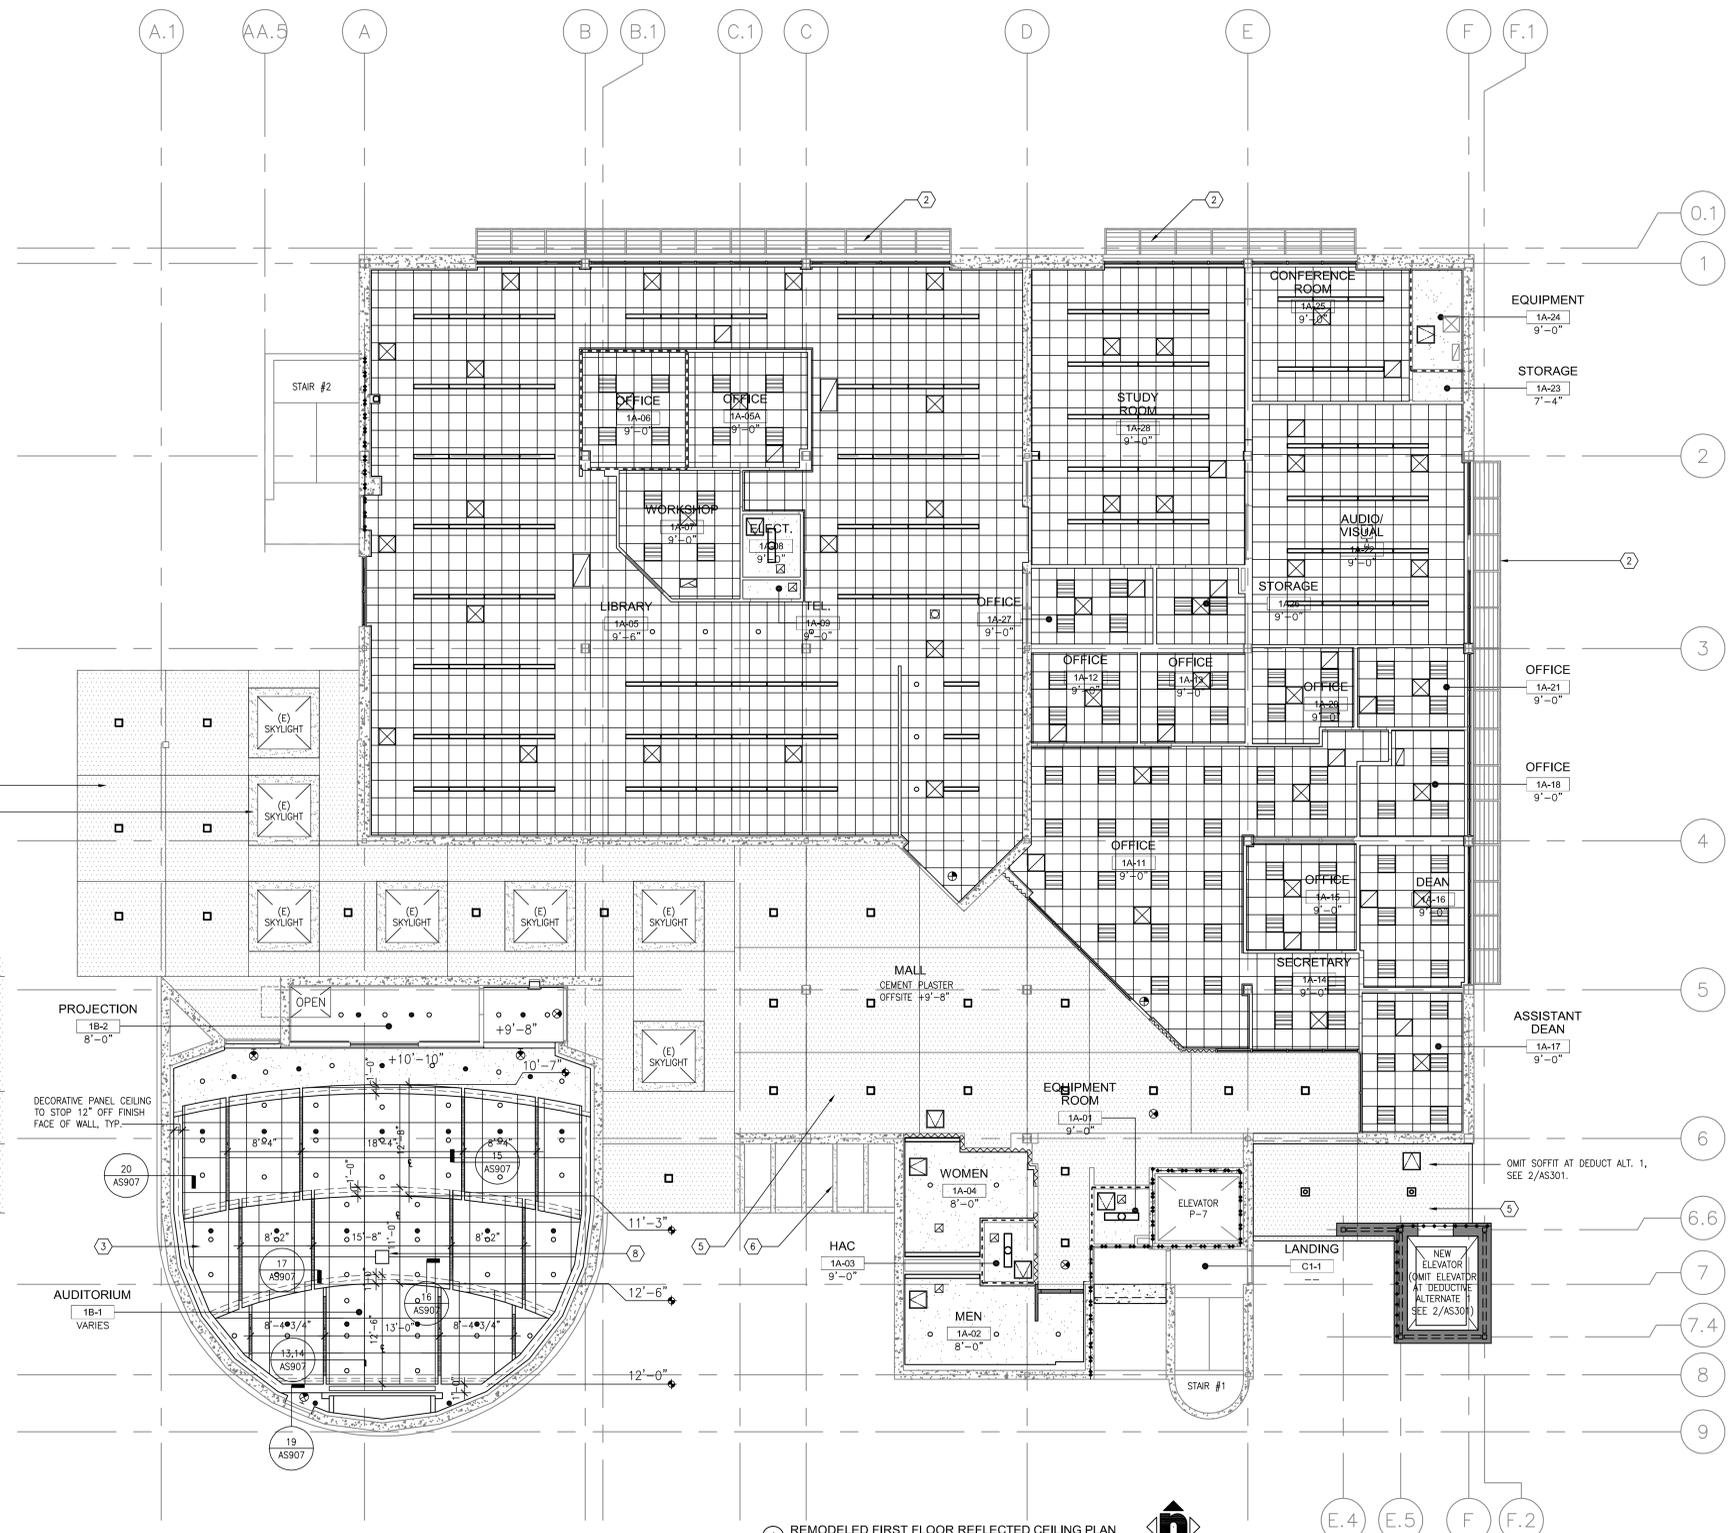


- REFLECTED CEILING PLAN LEGEND**
- FULL HEIGHT METAL STUD @ 16" O.C. U.N.O. WITH SOUND BATT. INSULATION AND FINISHES FULL HEIGHT FROM FINISH FLOOR TO DECK ABOVE. REFER TO DETAIL 6, 7 & 8/AS906.
 - PARTIAL HEIGHT METAL STUD @ 16" O.C. U.N.O. WITH SOUND BATT. INSULATION AND FINISHES FROM FINISH FLOOR TO 2" ABOVE FINISH CEILING. REFER TO DETAIL 5/AS906.
 - (E) METAL STUD WALL WITH SOUND BATTY INSULATION. WALL AND FINISHES FULL HEIGHT FROM FINISH FLOOR TO DECK ABOVE. REPLACE FINISHES WHERE NOTED.
 - (E) METAL STUD WALL WITH THERMAL INSULATION. WALL AND FINISHES FULL HEIGHT FROM FINISH FLOOR TO DECK ABOVE. REPLACE FINISHES WHERE NOTED.
 - (E) FULL HEIGHT STRUCTURAL CONCRETE WALL.
 - (E) METAL STUD WALL WITH SOUND BATTY INSULATION. WALL AND FINISHES PARTIAL HEIGHT. REPLACE FINISHES WHERE NOTED.
 - 1 HR FIRE BARRIER. WALL AND FINISHES FULL HEIGHT FROM FLOOR TO DECK ABOVE.
 - (E) 2 HR FIRE BARRIER. WALL AND FINISHES FULL HEIGHT FROM FLOOR TO DECK ABOVE.
 - CEMENT PLASTER. REFER TO SHEET AS911.
 - SUSPENDED GYPSUM WALLBOARD CEILING. REFER TO SHEET AS911.
 - SUSPENDED T-BAR ACOUSTICAL CEILING WITH 2'-0" x 2'-0" INFILL PANELS. REFER TO SHEET AS911.
 - CONCRETE FLOOR ABOVE. REFER TO STRUCTURAL DRAWINGS.
 - LIGHT FIXTURES. REFER TO ELECTRICAL DRAWINGS FOR FIXTURE TYPES.
 - HVAC DIFFUSERS. REFER TO MECHANICAL DRAWINGS FOR DIFFUSER TYPES.
 - LINEAR DIFFUSER. TITUS FLOWBAR OR EQUAL. REFER TO MECHANICAL.
 - FIRE SPRINKLER HEAD LOCATION AT AUDITORIUM. REFER TO FIRE PROTECTION DRAWINGS FOR SPRINKLER HEAD LOCATIONS THROUGHOUT REMAINDER OF BUILDING.
 - CEILING ACCESS PANEL. ALSO INDICATES DIRECTION OF DOOR SWING. SEE DETAIL 6/AS911.
 - EXIT SIGN. SOLID LINES INDICATES THE LOCATIONS OF ILLUMINATION WITH EXIT DIRECTIONAL ARROW. REFER TO ELECTRICAL DRAWINGS FOR FIXTURE TYPES.
 - (E) SUSPENDED GYP. WALL BOARD CEILING TO REMAIN. PAINT.

- REFLECTED CEILING PLAN - REMODEL KEYNOTES**
- 1 EXISTING SKYLIGHT AND SLOPING CEMENT PLASTER SOFFIT TO REMAIN. TYPICAL OF 7., PAINT CEMENT PLASTER
 - 2 (E) SUNSCREEN TO REMAIN, U.N.O. REMOVE DEBRIS AND CLEAN VIA POWER WASH.
 - 3 DECORATIVE PANEL CEILING. (OMIT DECORATIVE PANEL CEILING AT DEDUCTIVE ALTERNATE 4)
 - 4 (E) CEILING HVAC DIFFUSERS, LIGHTING & ELECTRICAL DEVICES TO REMAIN, TYP.
 - 5 CEMENT PLASTER SOFFIT PAINT
 - 6 (E) CEMENT PLASTER TRELIS, PAINT
 - 7 (E) GYPSUM BOARD CEILING, PAINT.
 - 8 PROJECTOR MOUNT. SEE ELECTRICAL DRAWINGS.

3 AUDITORIUM REFLECTED CEILING PLAN DEDUCTIVE ALTERNATE 4 1/8" = 1'-0"

1 REMODELED FIRST FLOOR REFLECTED CEILING PLAN 1/8" = 1'-0"

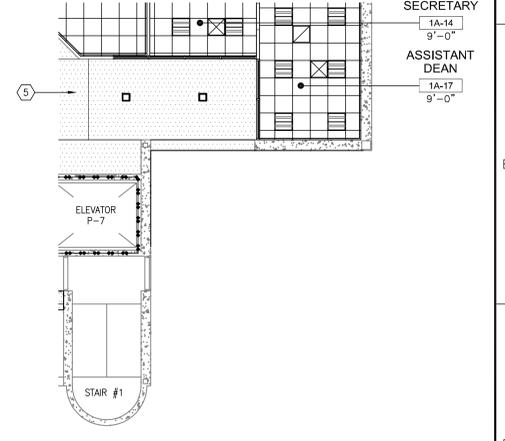

2 REMODELED PARTIAL FIRST FLOOR REFLECTED CEILING PLAN DEDUCTIVE ALTERNATE 1 1/8" = 1'-0"

Revisions	Date

CONSULTANTS:



ARCHITECT/ENGINEERS:

HMC Architects

1827 E. Fir Avenue, Studio 103 / Fresno, CA 93720
 T 559 322 2444 / www.hmcarchitects.com

Drawing Title
FIRST FLOOR REFLECTED CEILING PLAN

Approved Project Director

Project Title
BUILDING 24 SEISMIC CORRECTION AND ADDITION

Location
VAMC FRESNO, CA

Date
October 14, 2011

Checked
BB

Drawn
CLO

Project Number
570-215

Building Number
24

Drawing Number
AS301

Dwg. 56 of 180

Office of Construction and Facilities Management

Department of Veterans Affairs