


A three inches = one foot
 B one and one half inches = one foot
 C one inch = one foot
 D three quarters inch = one foot
 E one half inch = one foot
 F three eighths inch = one foot
 G one quarter inch = one foot
 H one eighth inch = one foot
 I one eighth inch = one foot
 J one eighth inch = one foot
 K one eighth inch = one foot
 L one eighth inch = one foot
 M one eighth inch = one foot
 N one eighth inch = one foot
 O one eighth inch = one foot
 P one eighth inch = one foot
 Q one eighth inch = one foot
 R one eighth inch = one foot
 S one eighth inch = one foot
 T one eighth inch = one foot
 U one eighth inch = one foot
 V one eighth inch = one foot
 W one eighth inch = one foot
 X one eighth inch = one foot
 Y one eighth inch = one foot
 Z one eighth inch = one foot

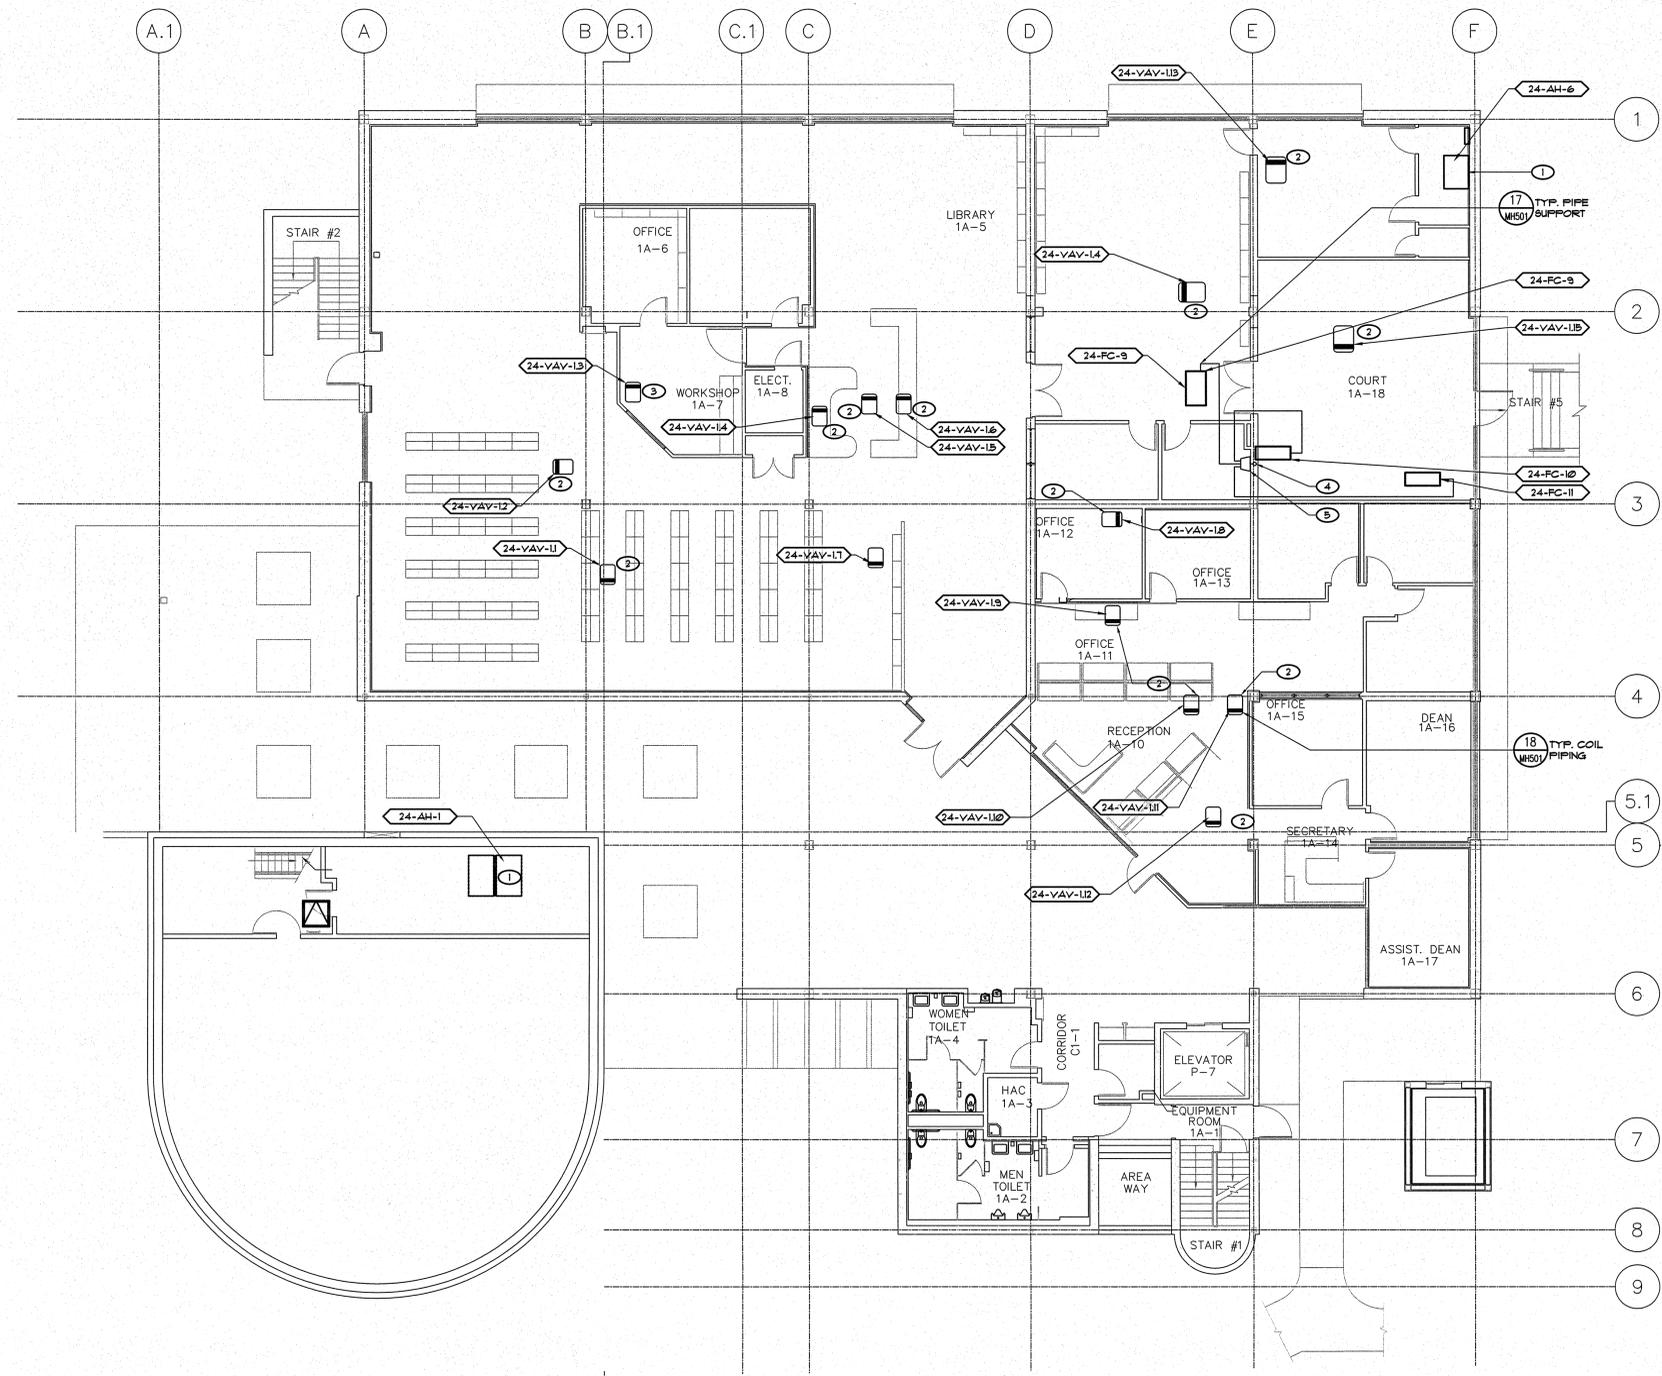

KEY NOTES

- (E) AH TO BE REPLACED, REPLACE ALL COIL PIPING VALVES ALONG WITH ALL ASSOCIATED CONTROLS.
- VAV BOX WITH REHEAT COIL, REPLACE ALL COIL PIPING VALVES ALONG WITH ALL ASSOCIATED CONTROLS.
- VAV BOX, WITH NO HOT WATER COIL.
- REFRIGERANT PIPING DROPS FROM SECOND FLOOR, SEE SHEET MP102 FOR CONTINUATION. EXTEND REFRIGERANT LINES IN ATTIC TO REHEAT BRANCH AND FC'S AS SHOWN, SEE SHEET M14602 FOR PIPE SIZES ON SCHEMATICS.
- REFRIGERANT Y-BRANCH FITTINGS IN ATTIC, SEE PIPING SCHEMATIC SHEET M14602 FOR MODEL.

EQUIPMENT NOTE

REFER TO SHEETS M14600 AND M14601 FOR EQUIPMENT SCHEDULES.

1 FIRST FLOOR MECHANICAL REMODEL PLAN
SCALE: 1/8" = 1'-0"

CONSULTANTS:

LP Consulting Engineers, Inc.
895 W. Ashlan Ave. Suite 101 Clovis, CA 93612
p 559-348-2130 f 559-348-2131
www.lpeengineers.com
Job #: 10-1098

ARCHITECT/ENGINEERS:

HMC Architects
1827 E. Fir Avenue, Studio 103 / Fresno, CA 93720
T 559 322 2444 / www.hmcarchitects.com

Drawing Title
FIRST FLOOR MECHANICAL REMODEL PIPING PLAN

Approved Project Director

Project Title
BUILDING 24 SEISMIC CORRECTION AND ADDITION

Project Number
570-215

Building Number
24

Location
VAMC FRESNO, CA

Date
January 31, 2012

Checked
KK

Drawn
DN

Drawing Number
MP101

Dwg. 147 of 180

Office of Construction and Facilities Management

Department of Veterans Affairs