


STERILE PROCESSING AND DISTRIBUTION FACILITY

PROJECT NUMBER: 405-304
FULLY SPRINKLERED

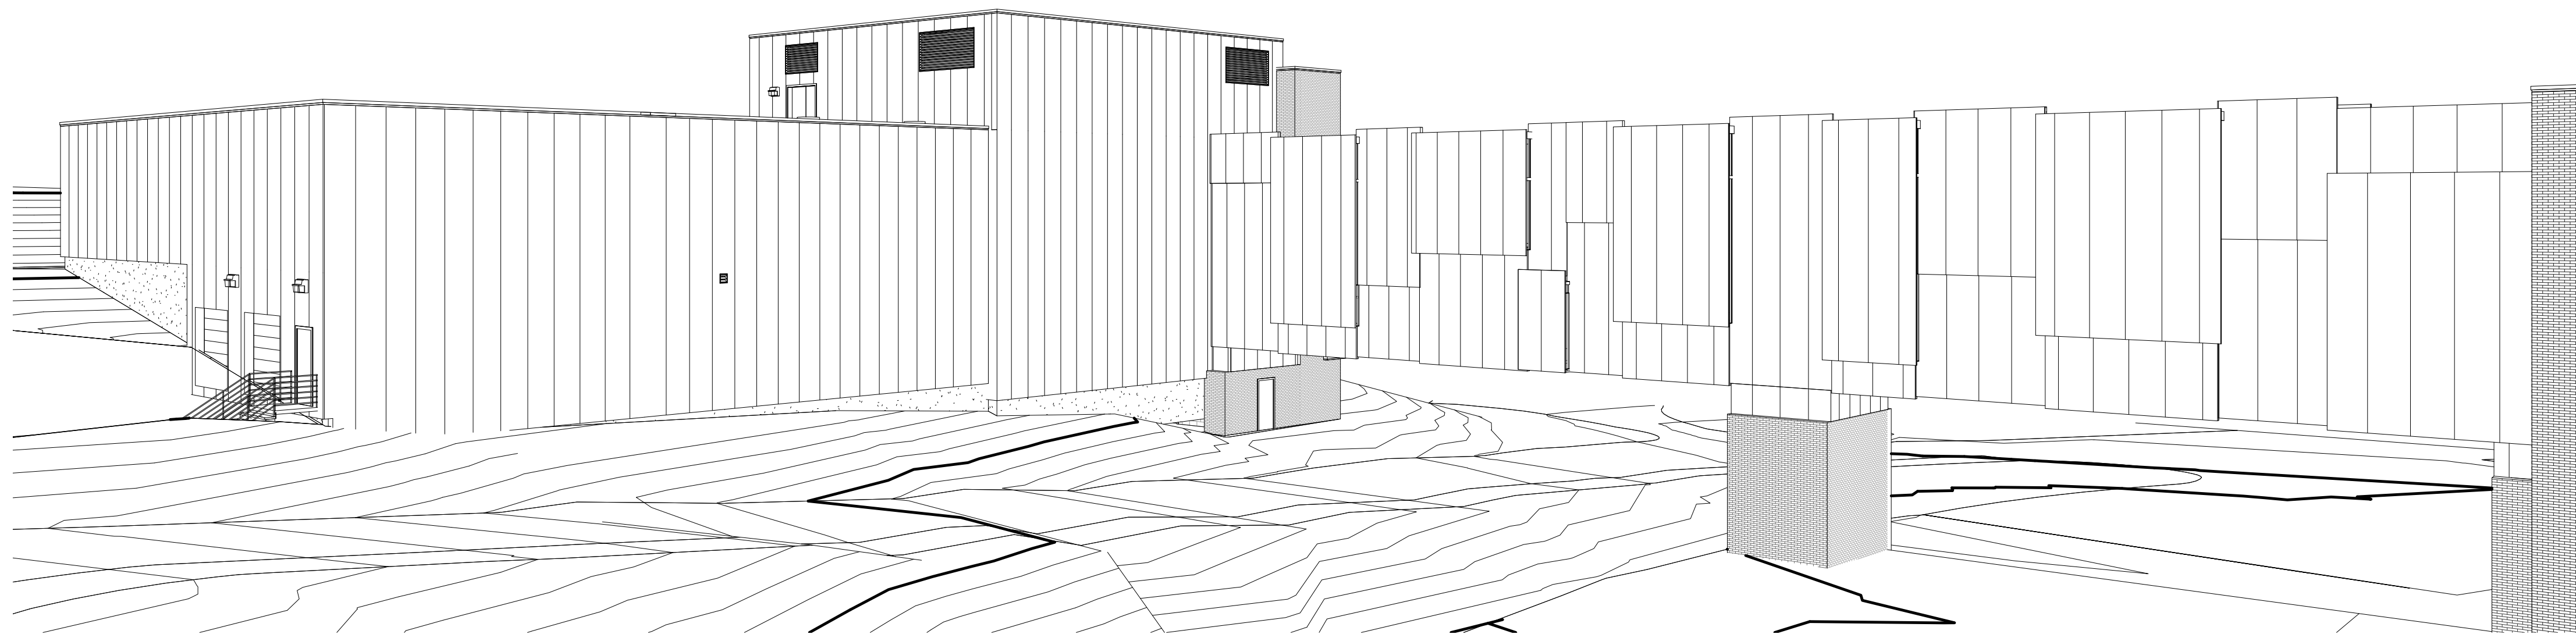


U.S. DEPARTMENT OF VETERAN AFFAIRS
VAMC WHITE RIVER JUNCTION VERMONT
215 NORTH MAIN STREET
WHITE RIVER JUNCTION, VT 05009

WARRENSTREET ARCHITECTS, INC.
ARCHITECTS, LANDSCAPE ARCHITECTS, PLANNERS
27 WARREN STREET, CONCORD, NH 03301
P 603.225.0640 F 603.225.0621

FULLY SPRINKLERED

CIVIL		ARCHITECT		STRUCTURAL		MECHANICAL		ELECTRICAL		WAI PROJECT NUMBER: 2931 DATE: 4/29/11	
McFARLAND-JOHNSON, INC. 53 REGIONAL DRIVE CONCORD, NH 03301 P 603.225.2978 F 603.225.0095		WARRENSTREET ARCHITECTS, INC. 27 WARREN STREET CONCORD, NH 03301 P 603.225.0640 F 603.225.0621		T.F. MORAN 48 CONSTITUTION DRIVE BEDFORD, NH 03110 P 603.472.4488 F 603.472.9747		YEATON ASSOCIATES, INC. 66 JACKSON STREET LITTLETON, NH 03561 P 603.444.6578 F 603.444.2364		YEATON ASSOCIATES, INC. 66 JACKSON STREET LITTLETON, NH 03561 P 603.444.6578 F 603.444.2364		REVISION: DATE ADDENDUM #1 08/01/2012	
DRAWING NAME	DRAWING NUMBER	DRAWING NAME	DRAWING NUMBER	DRAWING NAME	DRAWING NUMBER	DRAWING NAME	DRAWING NUMBER	DRAWING NAME	DRAWING NUMBER	APPROVED	DATE
GRADING AND DRAINAGE PLAN	CG-101	ADA, CONVERSIONS, SYMBOLS, SIGNS & ABBR.S	A001	GENERAL STRUCTUREL NOTES	S-100	BASEMENT & GROUND FLOOR PLAN – PIPING	MD-101	BASEMENT FLOOR PLAN – PLUMBING DEMOLITION	PD-101	BASEMENT FLOOR PLAN – ELECTRICAL DEMOLITION	ED-101
GRADING AND DRAINAGE PLAN	CG-101-ALT	CODE REVIEW - IBC 2009 & NFPA 101, 2009	A002	FOUNDATION PLAN-BASEMENT LEVEL	S-101	DEMOLITION		GROUND FLOOR PLAN – PLUMBING DEMOLITION	PD-102	GROUND FLOOR PLAN – ELECTRICAL DEMOLITION	ED-102
GENERAL NOTES, ABBREVIATIONS AND SYMBOLS	CI-001	PARTITION TYPES	A003	FOUNDATIONS/GROUND FLOOR LEVEL FRAMING PLAN	S-102	1ST & 2ND FLOOR PLAN – PIPING AND		FIRST FLOOR PLAN – PLUMBING DEMOLITION	PD-103	FIRST FLOOR PLAN – ELECTRICAL DEMOLITION	ED-103
EXISTING CONDITIONS PLAN	CS-101	OVERALL BASEMENT PLAN	A101	FIRST FLOOR FRAMING PLAN	S-103	MECHANICAL DEMO		SECOND FLOOR PLAN – PLUMBING DEMOLITION	PD-104	SECOND FLOOR PLAN – ELECTRICAL DEMOLITION	ED-104
SITE LAYOUT PLAN	CS-102	OVERALL GROUND PLAN	A102	SECOND FLOOR FRAMING PLAN	S-104	BASEMENT FLOOR PLAN – DUCTWORK DEMOLITION	MD-103	PLUMBING SCHEDULE, LEGEND AND DETAILS	P-001	ELECTRICAL SITE PLAN	ES-101
SITE LAYOUT PLAN	CS102-ALT	OVERALL FIRST FLOOR PLAN	A103	PENTHOUSE FLOOR/LOW ROOF FRAMING PLAN	S-105	ROOF PLAN – DUCTWORK DEMOLITION	MD-104	BASEMENT FLOOR PLAN – PLUMBING	P-101	ELECTRICAL SITE PLAN DEDUCT ALTERNATE	ES-102
DRAINAGE DETAILS	CS-501	OVERALL SECOND FLOOR PLAN	A104	PENTHOUSE ROOF FRAMING PLAN	S-106	MECHANICAL SITE PLAN	MS-101	GROUND FLOOR PLAN – PLUMBING	P-102	ELECTRICAL LEGENDS & NOTS	E-001
WATER DETAILS	CS-502	OVERALL ROOF PLAN	A105	FOUNDATION DETAILS	S-200	MECHANICAL SITE PLAN – DEDUCT ALTERNATE	MS-102	FIRST FLOOR PART PLAN – PLUMBING	P-103	BASEMENT FLOOR PLAN – LIGHTING	E-101
UTILITY DETAILS	CS-503	B31 DEMO PLANS	A110	FOUNDATION DETAILS	S-201	BASEMENT FLOOR PLAN – PIPING	M-101	FIRST FLOOR PART PLAN – PLUMBING	P-104	GROUND FLOOR PLAN – LIGHTING	E-102
MISCELLANEOUS DETAILS	CS-504	B31 BASEMENT & GROUND FLOOR PLAN	A120	TRUSS/BRACE ELEVATIONS	S-202	GROUND FLOOR PLAN – PIPING	M-102	FIRST FLOOR PART PLAN – PLUMBING – DEDUCT		FIRST FLOOR PLANS – LIGHTING	E-103
EROSION CONTROL NOTES AND DETAILS	CS-505	B31 FIRST & SECOND FLOOR BRIDGE PLANS	A121	COLUMN SCHEDULE	S-300	FIRST FLOOR PLAN – PIPING AND DUCTWORK	M-103	ALTERNATE	P-105	SECOND FLOOR PLAN – LIGHTING	E-104
UTILITY PLAN	CU-101	SPD GROUND & FIRST FLOOR PLAN	A122	FRAMING DETAILS	S-301	SECOND FLOOR PLAN – PIPING AND DUCTWORK	M-104	SECOND FLOOR PART PLAN – PLUMBING	P-106	PENTHOUSE PLAN – LIGHTING	E-105
UTILITY PLAN	CU-101-ALT	SPD SECOND FLOOR & PENTHOUSE PLAN	A123	FRAMING DETAILS	S-400	FIRST & SECOND FLOOR PLAN – PIPING –	M-105	BRIDGE CONNECTOR PLANS – PLUMBING	P-107	BASEMENT FLOOR PLAN – POWER	E-106
		ROOF PLAN	A124	FRAMING DETAILS	S-401	DUCT ALTERNATE	M-106	SECOND FLOOR PART PLAN – PLUMBING – DEDUCT		GROUND FLOOR PLAN – POWER	E-107
		SPD DEDUCT ALTERNATE PLANS	A125	FRAMING DETAILS	S-402	PENTHOUSE FLOOR PLAN – PIPING	M-107	ALTERNATE	P-109	FIRST FLOOR PLAN – POWER	E-108
		B31 BASEMENT & GROUND FLOOR DIMENSION PLAN	A130	FRAMING DETAILS	S-403	BASEMENT FLOOR PLAN – DUCTWORK	M-108	PENTHOUSE FLOOR PLAN – ELECTRICAL DEMOLITION	P-110	SECOND FLOOR PLAN – POWER	E-109
		B31 FIRST & SECOND FLOOR BRIDGE DIMENSION PLAN	A131	FRAMING DETAILS	S-404	GROUND FLOOR PLAN – DUCTWORK	M-109			PENTHOUSE PLAN – POWER	E-110
		SPD GROUND & FIRST FLOOR DIMENSION PLAN	A132			FIRST FLOOR PLAN – DUCTWORK	M-110			BASEMENT FLOOR PLAN – FIRE ALARM	E-111
		SPD SECOND FLOOR AND PENTHOUSE DIMENSION PLAN	A133			ALTERNATE	M-111			GROUND FLOOR PLAN – FIRE ALARM	E-112
		SPD DEDUCT ALTERNATE DIMENSION PLANS	A134			SECOND FLOOR PLAN – DUCTWORK	M-112			FIRST FLOOR PLANS – FIRE ALARM	E-113
		B31 BMNT & GND / SPD GND & PENT. CEILING PLANS	A140			SECOND FLOOR PLAN – DUCTWORK	M-113			SECOND FLOOR PLAN – FIRE ALARM	E-114
		B31 FIRST & SECOND FLOOR BRIDGE CEILING PLANS	A141			ALTERNATE	M-114			PENTHOUSE PLAN – FIRE ALARM	E-115
		SPD FIRST & SECOND FLOOR CEILING PLANS	A142			PENTHOUSE FLOOR PLANS – DUCTWORK	M-115			ELECTRICAL DETAILS	E-401
		SPD DEDUCT ALTERNATE CEILING PLANS	A143			FIRST AND SECOND FLOOR PLANS – PRESSURIZATION	M-116			ELECTRICAL DETAILS	E-402
		B31 BMNT & GND / SPD GND FLR FINISH PLAN	A150			DUCT ALTERNATE	M-117			ELECTRICAL ONLINE DIAGRAM	E-501
		B31 FIRST & SECOND FLOOR BRIDGE FINISH PLAN	A151			PENTHOUSE SECTIONS	M-301			ELECTRICAL PANEL SCHEDULES	E-601
		FIRST & SECOND FLOOR FINISH PLAN	A152			MECHANICAL DETAILS	M-501				E-602
		EQUIPMENT SCHEDULE & EXISTING CONDITIONS	A160			MECHANICAL DETAILS	M-502				
		SPD EQUIPMENT PLANS	A161			MECHANICAL SCHEDULES	M-503				
		STAIR PLANS	A170			MECHANICAL SCHEDULES	M-601				
		PARTIAL PLANS	A171			CONTROL DIAGRAMS	M-602				
		FINISH SCHEDULE	A201			HVAC-1E AND HVAC-1S AUTOMATIC TEMPERATURE	M-701				
		DOOR SCHEDULE	A202			CONTROLS	M-702				
		WINDOW SCHEDULE & ELEVATIONS	A203			HVAC-2 AUTOMATIC TEMPERATURE CONTROLS	M-703				
		SOUTH & WEST ELEVATIONS	A301			AND CONTROLS DIAGRAMS	M-703				
		NORTH & EAST ELEVATIONS	A302			HVAC-2 AUTOMATIC TEMPERATURE CONTROLS	M-704				
		DEDUCT ALT. ELEVATIONS	A303			AND CONTROLS DIAGRAMS					
		BRIDGE SECTION	A304								
		BUILDING SECTIONS	A401								



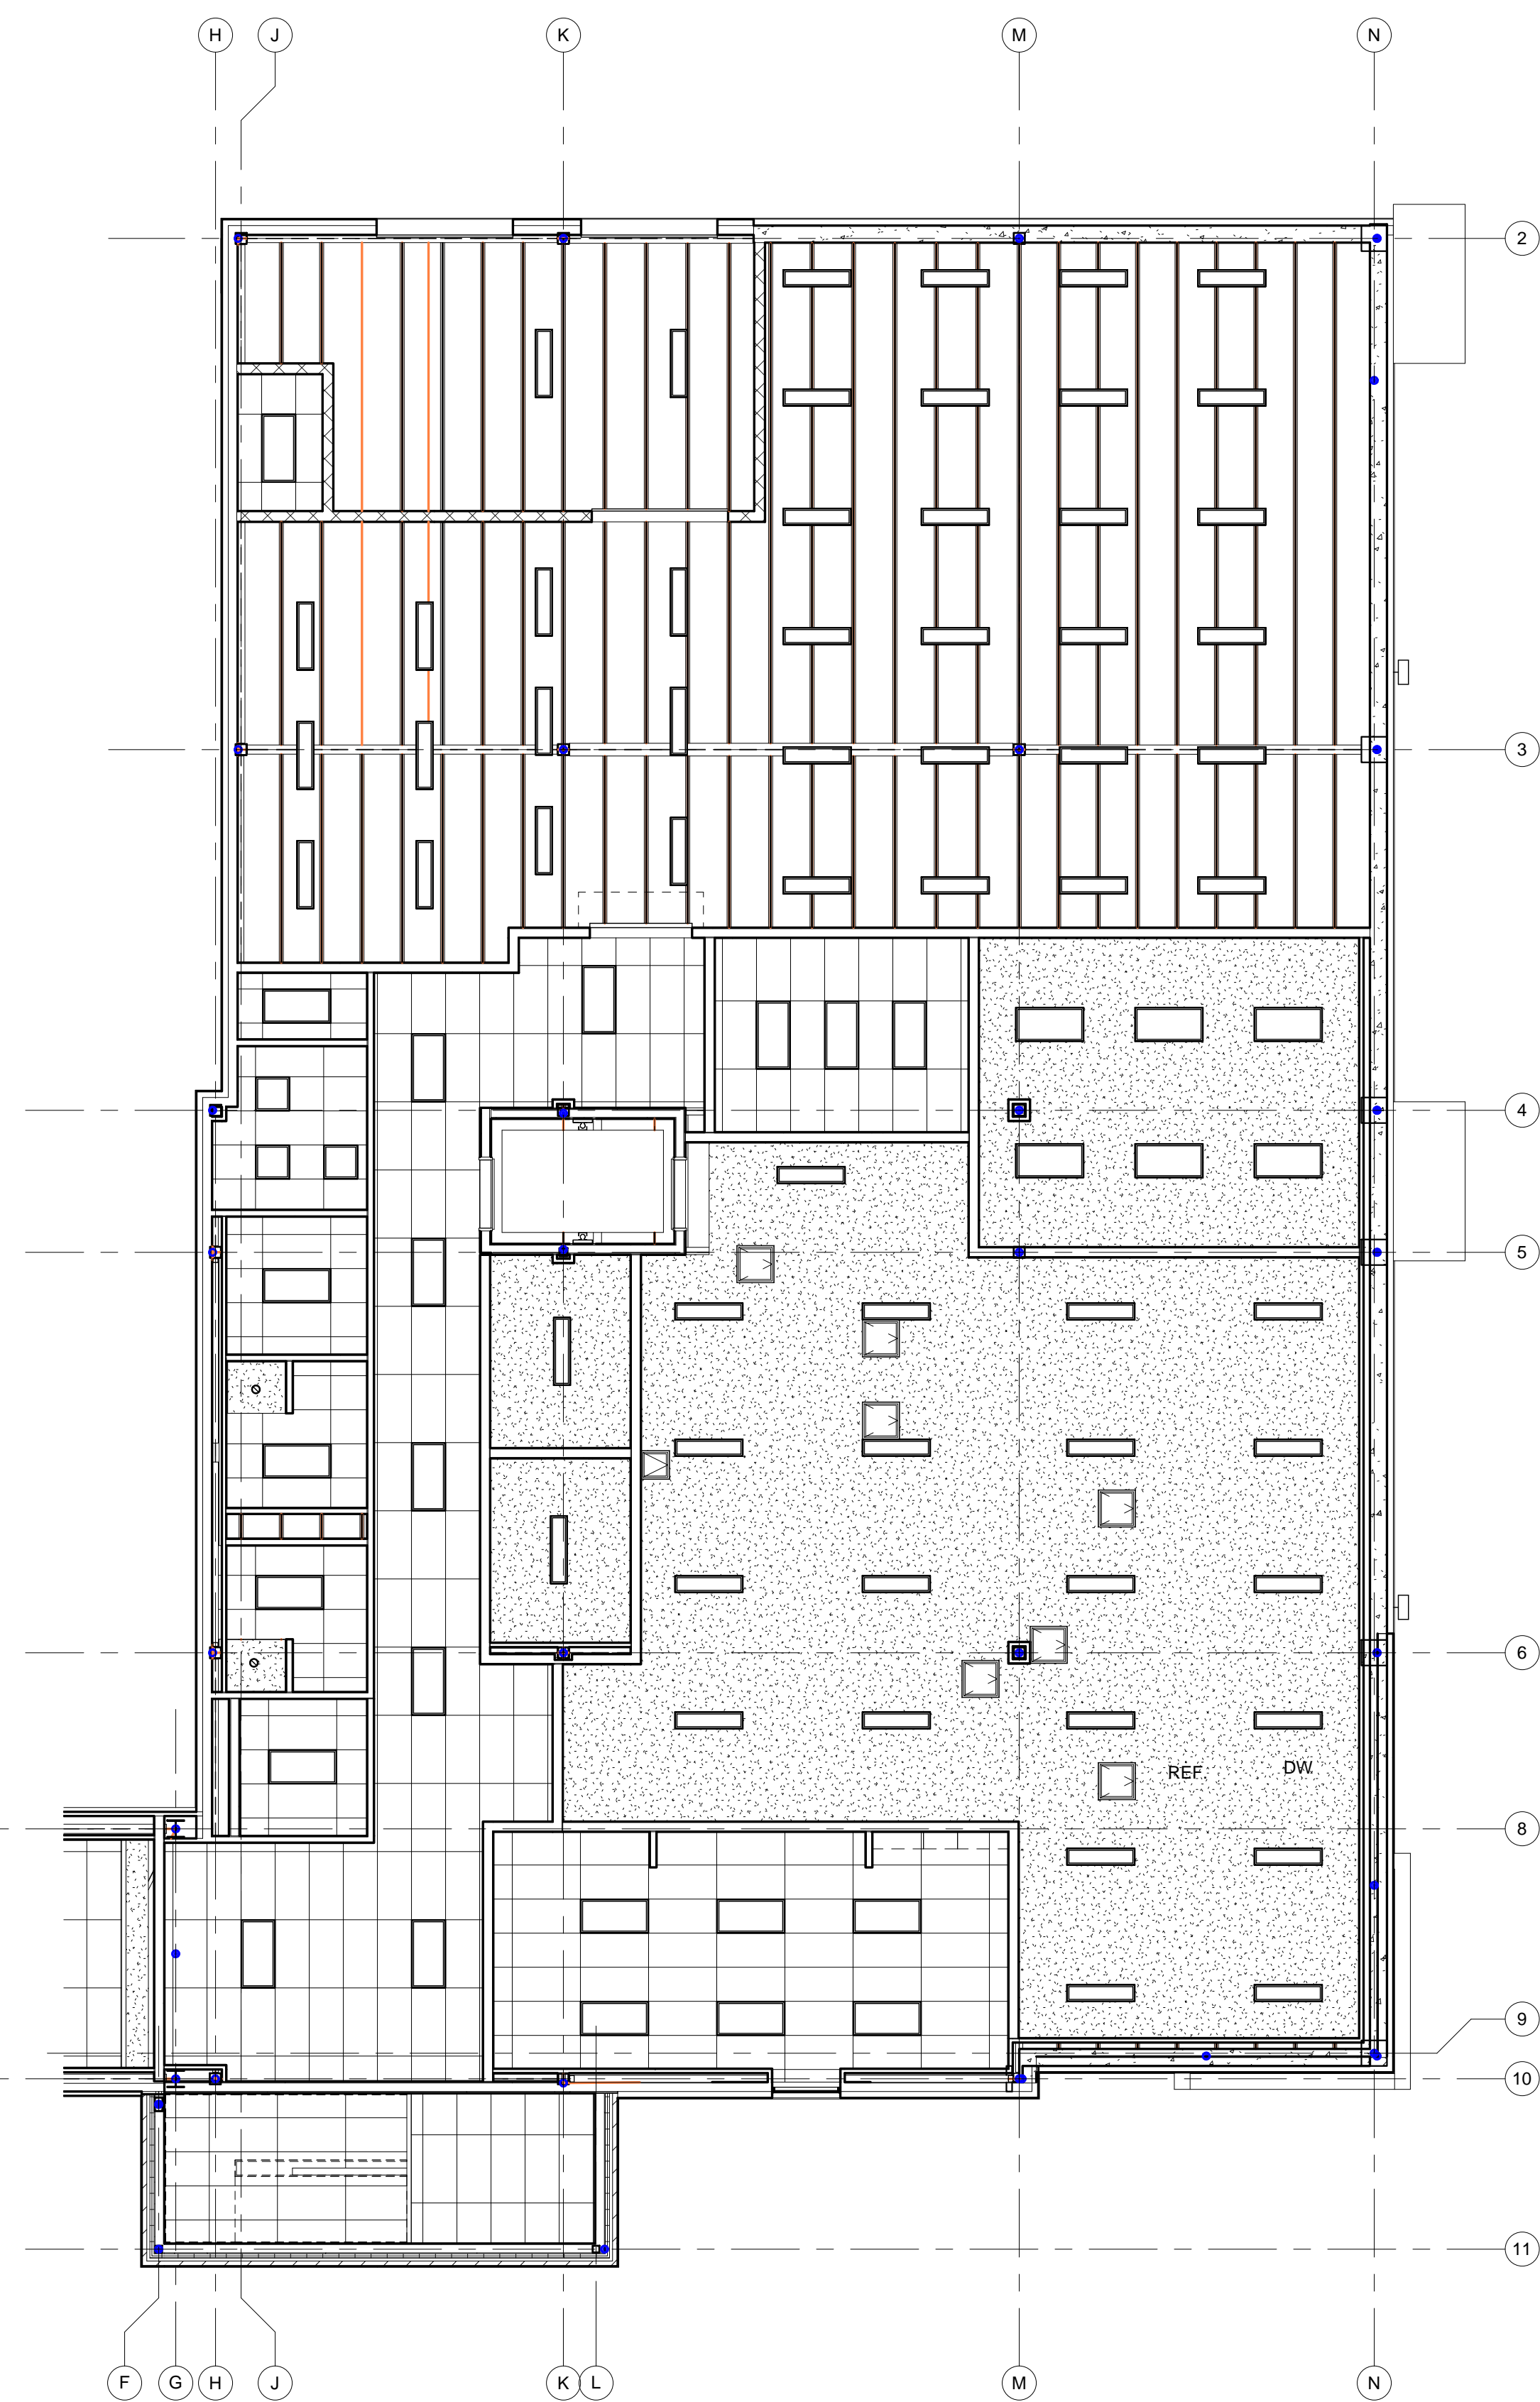

1 SPD ALT. FIRST FLOOR CEILING PLAN
1/8" = 1'-0"

ADDENDUM # 1 CLARIFICATIONS - 8/1/2012 FULLY SPRINKLERED

[illegible]

[illegible]