



SHEET NOTES:

- 1 DUCT THRU ROOF. SEE 7/H6.1. CUT AND PATCH ROOF WATER TIGHT.
- 2 EXTERNALLY INSULATE DUCTWORK ON ROOF, PROVIDE DUCT SUPPORTS PER 10/H6.1.
- 3 MOUNT AHU ON LEVEL ROOF CURB, SEE 6/H6.1. PROVIDE CONDENSATE DRAIN PER 4/H6.1 AND EXTEND TO APPROVED LOCATION; SEE 5 & 9/H6.1 FOR COIL PIPING DETAIL.
- 4 PROVIDE ENCLOSURE OVER BOOSTER PUMPS TO PROTECT FROM WEATHER.

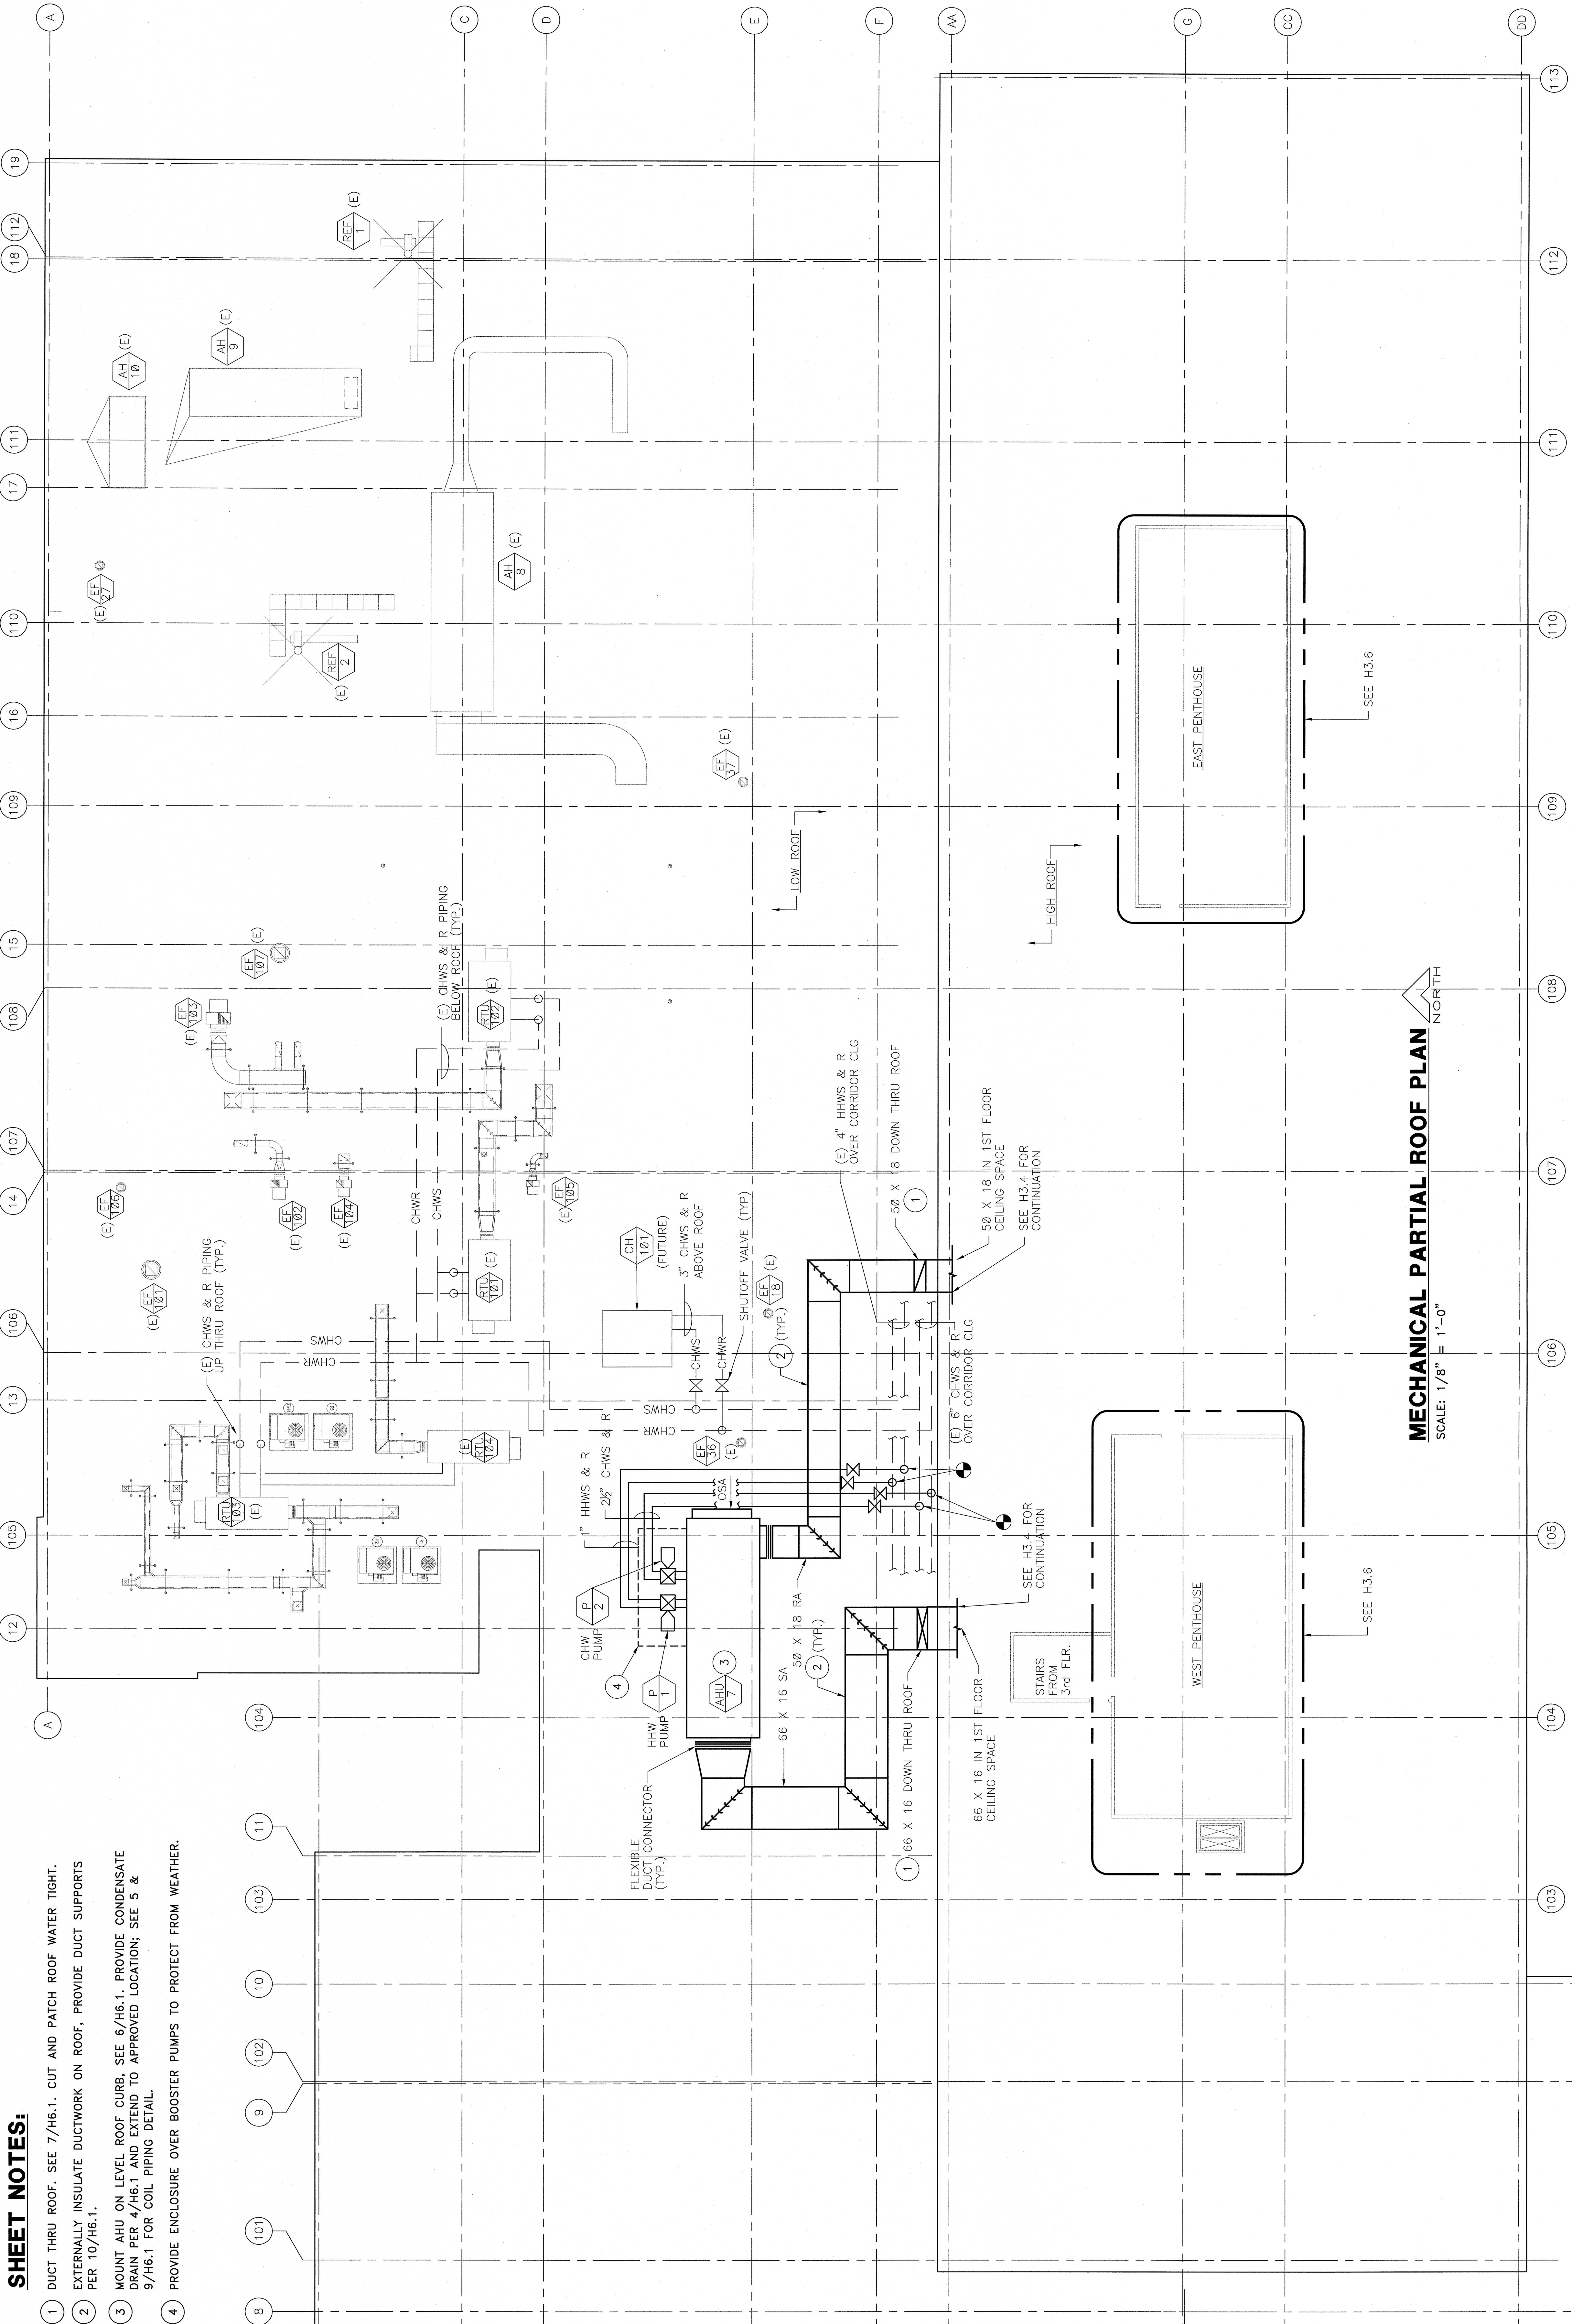

MECHANICAL PARTIAL ROOF PLAN
SCALE: 1/8" = 1'-0"

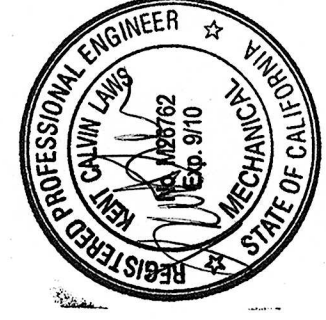

BLDG 650

KEY PLAN

K.F. DAVIS ENGINEERING, INC
550 LA GONDA WAY, SUITE E
DANVILLE, CA 94526

Revisions:	Drawing Title:	Project Title:	Date:
	MECHANICAL ROOF PLANS EAST	BLDG 650 REPLACE AIR HANDLERS 7 AND 9 - 15	08/25/08
Approved:	Approved: Medical Center Director	Building Number:	Project No:
Approved:	Approved: Chief, Engineering Service	Drawn: RMK	61244-07-342
		Checked: KL	DRAWING No.
			H3.3
		Location: MATHER VAMC MATHER CALIFORNIA	Page: 1 of 1



Department of
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