

DOOR SCHEDULE - BASEMENT LEVEL


DOOR NUMBER	FROM ROOM		TO ROOM		SIZE			DOOR			FRAME			DETAILS			RATINGS			COMMENTS	REVISED IN (DELTA'S)	
	NUMBER	NAME	NUMBER	NAME	WIDTH	HEIGHT	THICKNESS	ELEVATIONS	TYPE	DESCRIPTION	FINISH	TYPE	DESCRIPTION	FINISH	HEAD	JAMB 1	JAMB 2	THRESHOLD	FIRE			STC @ ADJ.WALL
001				EXISTING ELEVATOR LOBBY	6'-0"	8'-0"	1 3/4"	D	HMR	HOLLOW METAL (FIRE RATED)		HMI	HOLLOW METAL									
001.1	CB-002	CORRIDOR	S1	STAIR 1	3'-0"	7'-0"	1 3/4"	A	WDR	WOOD FLUSH (FIRE RATED)		HMI	HOLLOW METAL									
002.1	BH002	MECHANICAL	BH005	SERVICE WELL	8'-0"	8'-0"	1 3/4"	F	HMI	HOLLOW METAL (INSULATED)		HMI	HOLLOW METAL									
002.2	CB-002	CORRIDOR	BH002	MECHANICAL	8'-0"	7'-0"	1 3/4"	F	HMR	HOLLOW METAL (FIRE RATED)		HMI	HOLLOW METAL									
003.1	BH003	ELECTRICAL	BH005	SERVICE WELL	8'-0"	8'-0"	1 3/4"	F	HMI	HOLLOW METAL (INSULATED)		HMI	HOLLOW METAL									
003.2	BH003	ELECTRICAL	CB-002	CORRIDOR	6'-0"	7'-0"	1 3/4"	B	HMR	HOLLOW METAL (FIRE RATED)		HMI	HOLLOW METAL									
004.1	BH004	EMERGENCY ELECTRICAL	BH005	SERVICE WELL	8'-0"	8'-0"	1 3/4"	F	HMI	HOLLOW METAL (INSULATED)		HMI	HOLLOW METAL									
004.2	BH003	ELECTRICAL	BH004	EMERGENCY ELECTRICAL	3'-0"	7'-0"	1 3/4"	A	HMI	HOLLOW METAL (INSULATED)		HMI	HOLLOW METAL									
BA201	BH003	ELECTRICAL	BH004	EMERGENCY ELECTRICAL	3'-0"	7'-0"	1 3/4"		(none)			(none)	HOLLOW METAL									

DOOR SCHEDULE - PENTHOUSE ROOF

DOOR NUMBER	FROM ROOM		TO ROOM		SIZE			DOOR			FRAME			DETAILS			RATINGS			COMMENTS	REVISED IN (DELTA'S)	
	NUMBER	NAME	NUMBER	NAME	WIDTH	HEIGHT	THICKNESS	ELEVATION	TYPE	DESCRIPTION	FINISH	TYPE	DESCRIPTION	FINISH	HEAD	JAMB 1	JAMB 2	THRESHOLD	FIRE			STC @ ADJ.WALL
401.1	MH401	VESTIBULE	MH402	MECHANICAL	6'-0"	7'-0"	1 3/4"	B	WDSC	WOOD FLUSH (SOLID CORE)		HMI	HOLLOW METAL									
401.2	MH402	MECHANICAL	MH401A	CONTROL ROOM	3'-0"	7'-0"	1 3/4"	A	WDR	WOOD FLUSH (FIRE RATED)		HMI	HOLLOW METAL									
403.1	MH403	VESTIBULE		EXTERIOR	6'-0"	7'-0"	1 3/4"	F	HMI	HOLLOW METAL (INSULATED)		HMI	HOLLOW METAL									
403.2	MH402	MECHANICAL	MH403	VESTIBULE	6'-0"	7'-0"	1 3/4"	F	HMR	HOLLOW METAL (FIRE RATED)		HMI	HOLLOW METAL									
403.3	MH403	VESTIBULE	S1	STAIR 1	3'-0"	7'-0"	1 3/4"	A	WDR	WOOD FLUSH (FIRE RATED)		HMI	HOLLOW METAL									
404.1	MH404	VESTIBULE		EXTERIOR	6'-0"	7'-0"	1 3/4"	F	HMI	HOLLOW METAL (INSULATED)		HMI	HOLLOW METAL									
404.2	MH404	VESTIBULE	MH402	MECHANICAL	6'-0"	7'-0"	1 3/4"	F	HMR	HOLLOW METAL (FIRE RATED)		HMI	HOLLOW METAL									
404.3	MH404	VESTIBULE	SZ	STAIR 2	3'-0"	7'-0"	1 3/4"	A	WDR	WOOD FLUSH (FIRE RATED)		HMI	HOLLOW METAL									

150.1	2H220	MECHANICAL PENTHOUSE			6'-0"	7'-10"	1 3/4"	F	HMI	HOLLOW METAL (INSULATED)		HMI	HOLLOW METAL									
150.2	2H220	MECHANICAL PENTHOUSE			6'-0"	7'-10"	1 3/4"	F	HMI	HOLLOW METAL (INSULATED)		HMI	HOLLOW METAL									
501					3'-0"	7'-0"	1 3/4"	F	HMI	HOLLOW METAL (INSULATED)		HMI	HOLLOW METAL									

DOOR SCHEDULE - ELEVATIONS

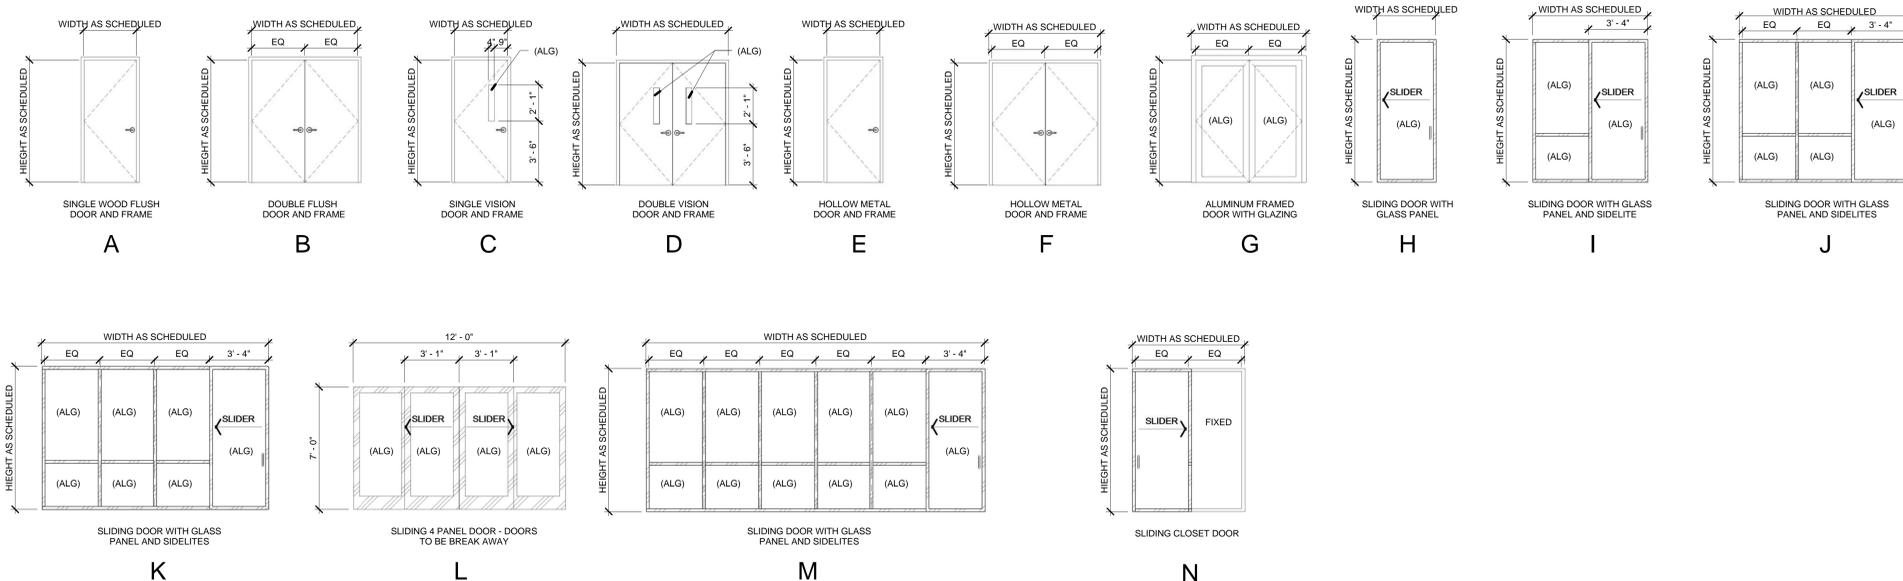

GENERAL NOTES - DOORS

- ALL DOORS ALONG RATED CORRIDORS SHALL MEET THE MINIMUM REQUIREMENTS OF 2000 IBC SECTION 714.2.3 - ALL DOORS ALONG A 1 HOUR RATED CORRIDORS SHALL HAVE A MINIMUM FIRE PROTECTION OF 20 MINUTES UNLESS NOTED OTHERWISE - DOOR OPENINGS ALONG A FIRE RATED CORRIDORS SHALL BE PROTECTED BY TIGHT-FITTING SMOKE AND DRAFT CONTROL ASSEMBLY - DOORS SHALL MAINTAIN A SELF-CLOSING DEVICE PER IBC SECTION 714.2.7. FIRE DOORS SHALL MEET THE REQUIREMENTS FOR A SMOKE AND DRAFT CONTROL DOOR ASSEMBLY OF THE DOOR ASSEMBLY.
- ALL DOORS SHALL BE PROVIDED WITH A LEVEL FLOOR OR LANDING - ALL THRESHOLDS PROVIDED SHALL HAVE A MAXIMUM OF 12" ABOVE THE FLOOR OR LANDING PER CODE.
- ALL EXTERIOR DOORS SHALL BE WEATHERSTRIPPED.
- ALL HARDWARE SHALL COMPLY WITH "ADA" SECTIONS AND SHALL BE MADE OF THE SAME MATERIAL AND HAVE THE SAME FINISH AS SELECTED BY THE ARCHITECT - REFER TO SPECIFICATIONS FOR HARDWARE INFORMATION.
- EXCEPT FOR SLIDING DOORS THE LOWER 12" OF ALL DOORS SHALL COMPLY WITH CODE AND SHALL BE SMOOTH AND UNINTERRUPTED TO ALLOW THE DOOR TO BE OPENED BY A WHEELCHAIR FOOT REST WITHOUT CREATING A TRAP OR HAZARDOUS CONDITION.
- LABELING REQUIREMENTS OF RATED DOORS SHALL BE LABELED SHOWING THE NAME OF THE MANUFACTURER, THE NAME OF THE THIRD PARTY INSPECTION AGENCY, THE FIRE PROTECTION RATING AND, WHERE REQUIRED FOR FIRE DOORS IN EXIT ENCLOSURES BY SECTION 714.2.4 - THE MAXIMUM TRANSMITTED TEMPERATURE END POINT, SMOKE AND DRAFT CONTROL DOORS COMPLYING WITH UL 1784 SHALL BE LABELED AS A SMOKE AND DRAFT CONTROL DOOR - LABELS SHALL BE APPROVED AND PERMANENTLY AFFIXED - THE LABEL SHALL BE APPLIED AT THE FACTORY WHERE FABRICATION AND ASSEMBLY ARE PERFORMED.
- OPENING SIZE IS EQUAL TO NET OPENING - ROUGH OPENING IS EQUAL TO OPENING SIZE AND FRAME DIMENSION.
- THE DETAILS AS INDICATED ON DRAWINGS REFLECT DESIGN INTENT ONLY - ATTACHMENTS AND SEALANT DETAILS ARE SCHEMATIC AND TOGETHER WITH SPECIFICATIONS AND PROFILES SHOWN ARE INTENDED TO ESTABLISH THE PERFORMANCE REQUIREMENTS AND MATERIAL QUALITIES REQUIRED - DETAILS NOT SHOWN SHALL BE SIMILAR IN CHARACTER TO THOSE DETAILED - WHERE SPECIFIC DIMENSION DETAIL OR INTENT CANNOT BE DETERMINED, OR ARE NOT CLEARLY DEFINED, THE ARCHITECT'S CLARIFICATION SHALL BE REQUESTED BEFORE PROCEEDING WITH THAT PORTION OF THE WORK. THE CONTRACTOR SHALL DEVELOP A FINAL DETAIL TO ACCOMMODATE THE FABRICATION (SHOP DRAWINGS), ERECTION AND INSTALLATION OF THE WORK IN ACCORDANCE WITH THE DESIGN INTENT SHOWN.
- THE DOOR NUMBER IN THE SCHEDULE CORRESPONDS WITH THE NUMBER OF THE ROOM OF WHICH THE DOOR IS LOCATED - PLUS THE LETTER SUFFIX INDICATED ON THE PLAN FOR THAT DOOR - REFER ALSO TO THE FLOOR PLAN AND THE INTERIOR AND EXTERIOR ELEVATIONS.
- THE MAXIMUM EFFORT TO OPERATE DOORS APPLIED AT RIGHT ANGLES TO HINGED DOORS OR AT THE CENTER PLANE SLIDING DOORS SHALL COMPLY WITH THE LATEST CODE REQUIREMENTS.
- UNLESS NOTED OTHERWISE THE DOOR OPENING IN RATED WALLS SHALL BE PROTECTED BY A TIGHT FITTING SMOKE AND DRAFT CONTROL ASSEMBLY HAVING A FIRE PROTECTION RATING OF NOT LESS THAN 20 MINUTES - THE LABELED ASSEMBLY SHALL BE SELF-CLOSING OR AUTOMATIC CLOSING ACTUATION OF A SMOKE DETECTOR AND SHALL BE PROVIDED WITH A CONTINUOUS GASKET ALONG THE STOP AT THE DOOR JAMB AND HEAD.
- ALL GLAZING WITHIN OR ADJACENT TO DOOR PANELS ARE TO BE (ALG) ACOUSTICAL LAMINATED GLAZING UNLESS WITHIN FIRE RATED PARTITIONS.

ENTIRE SHEET MODIFIED

CONSTRUCTION DOCUMENT

BUILDING IS FULLY SPRINKLED

Revisions:	Date:
1 Addendum #01	08/15/2012
2 Addendum #02	08/22/2012

**CONSULTANTS:**

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 GEOTECHNICAL: LASALLE ENGINEERING, 1000 YORK ROAD, WILLOW GROVE, PA 19090  
 FIRE & LIFE SAFETY:

KEY PLAN

ARCHITECT/ENGINEERS:



Drawing Title

Door Type and Schedule

Scale: 1/4" = 1'-0"

Approved: Project Director

*Melan Arskic*

Project Title  
VA Medical Center - PHASE V,  
Administration Bldg. & Education Ctr.  
Addition

Location  
North Las Vegas, NV

Date  
June 15, 2012

Checked  
Drawn  
Author

Project Number  
593CA2202

Building Number  
6

Drawing Number  
AE-6101

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Office of  
Construction  
and  
Facilities  
Management

