



three inches = one foot
 one and one half inch = one foot
 one inch = one foot
 three-quarters inch = one foot
 one-half inch = one foot
 three-eighths inch = one foot
 one-quarter inch = one foot
 one-eighth inch = one foot

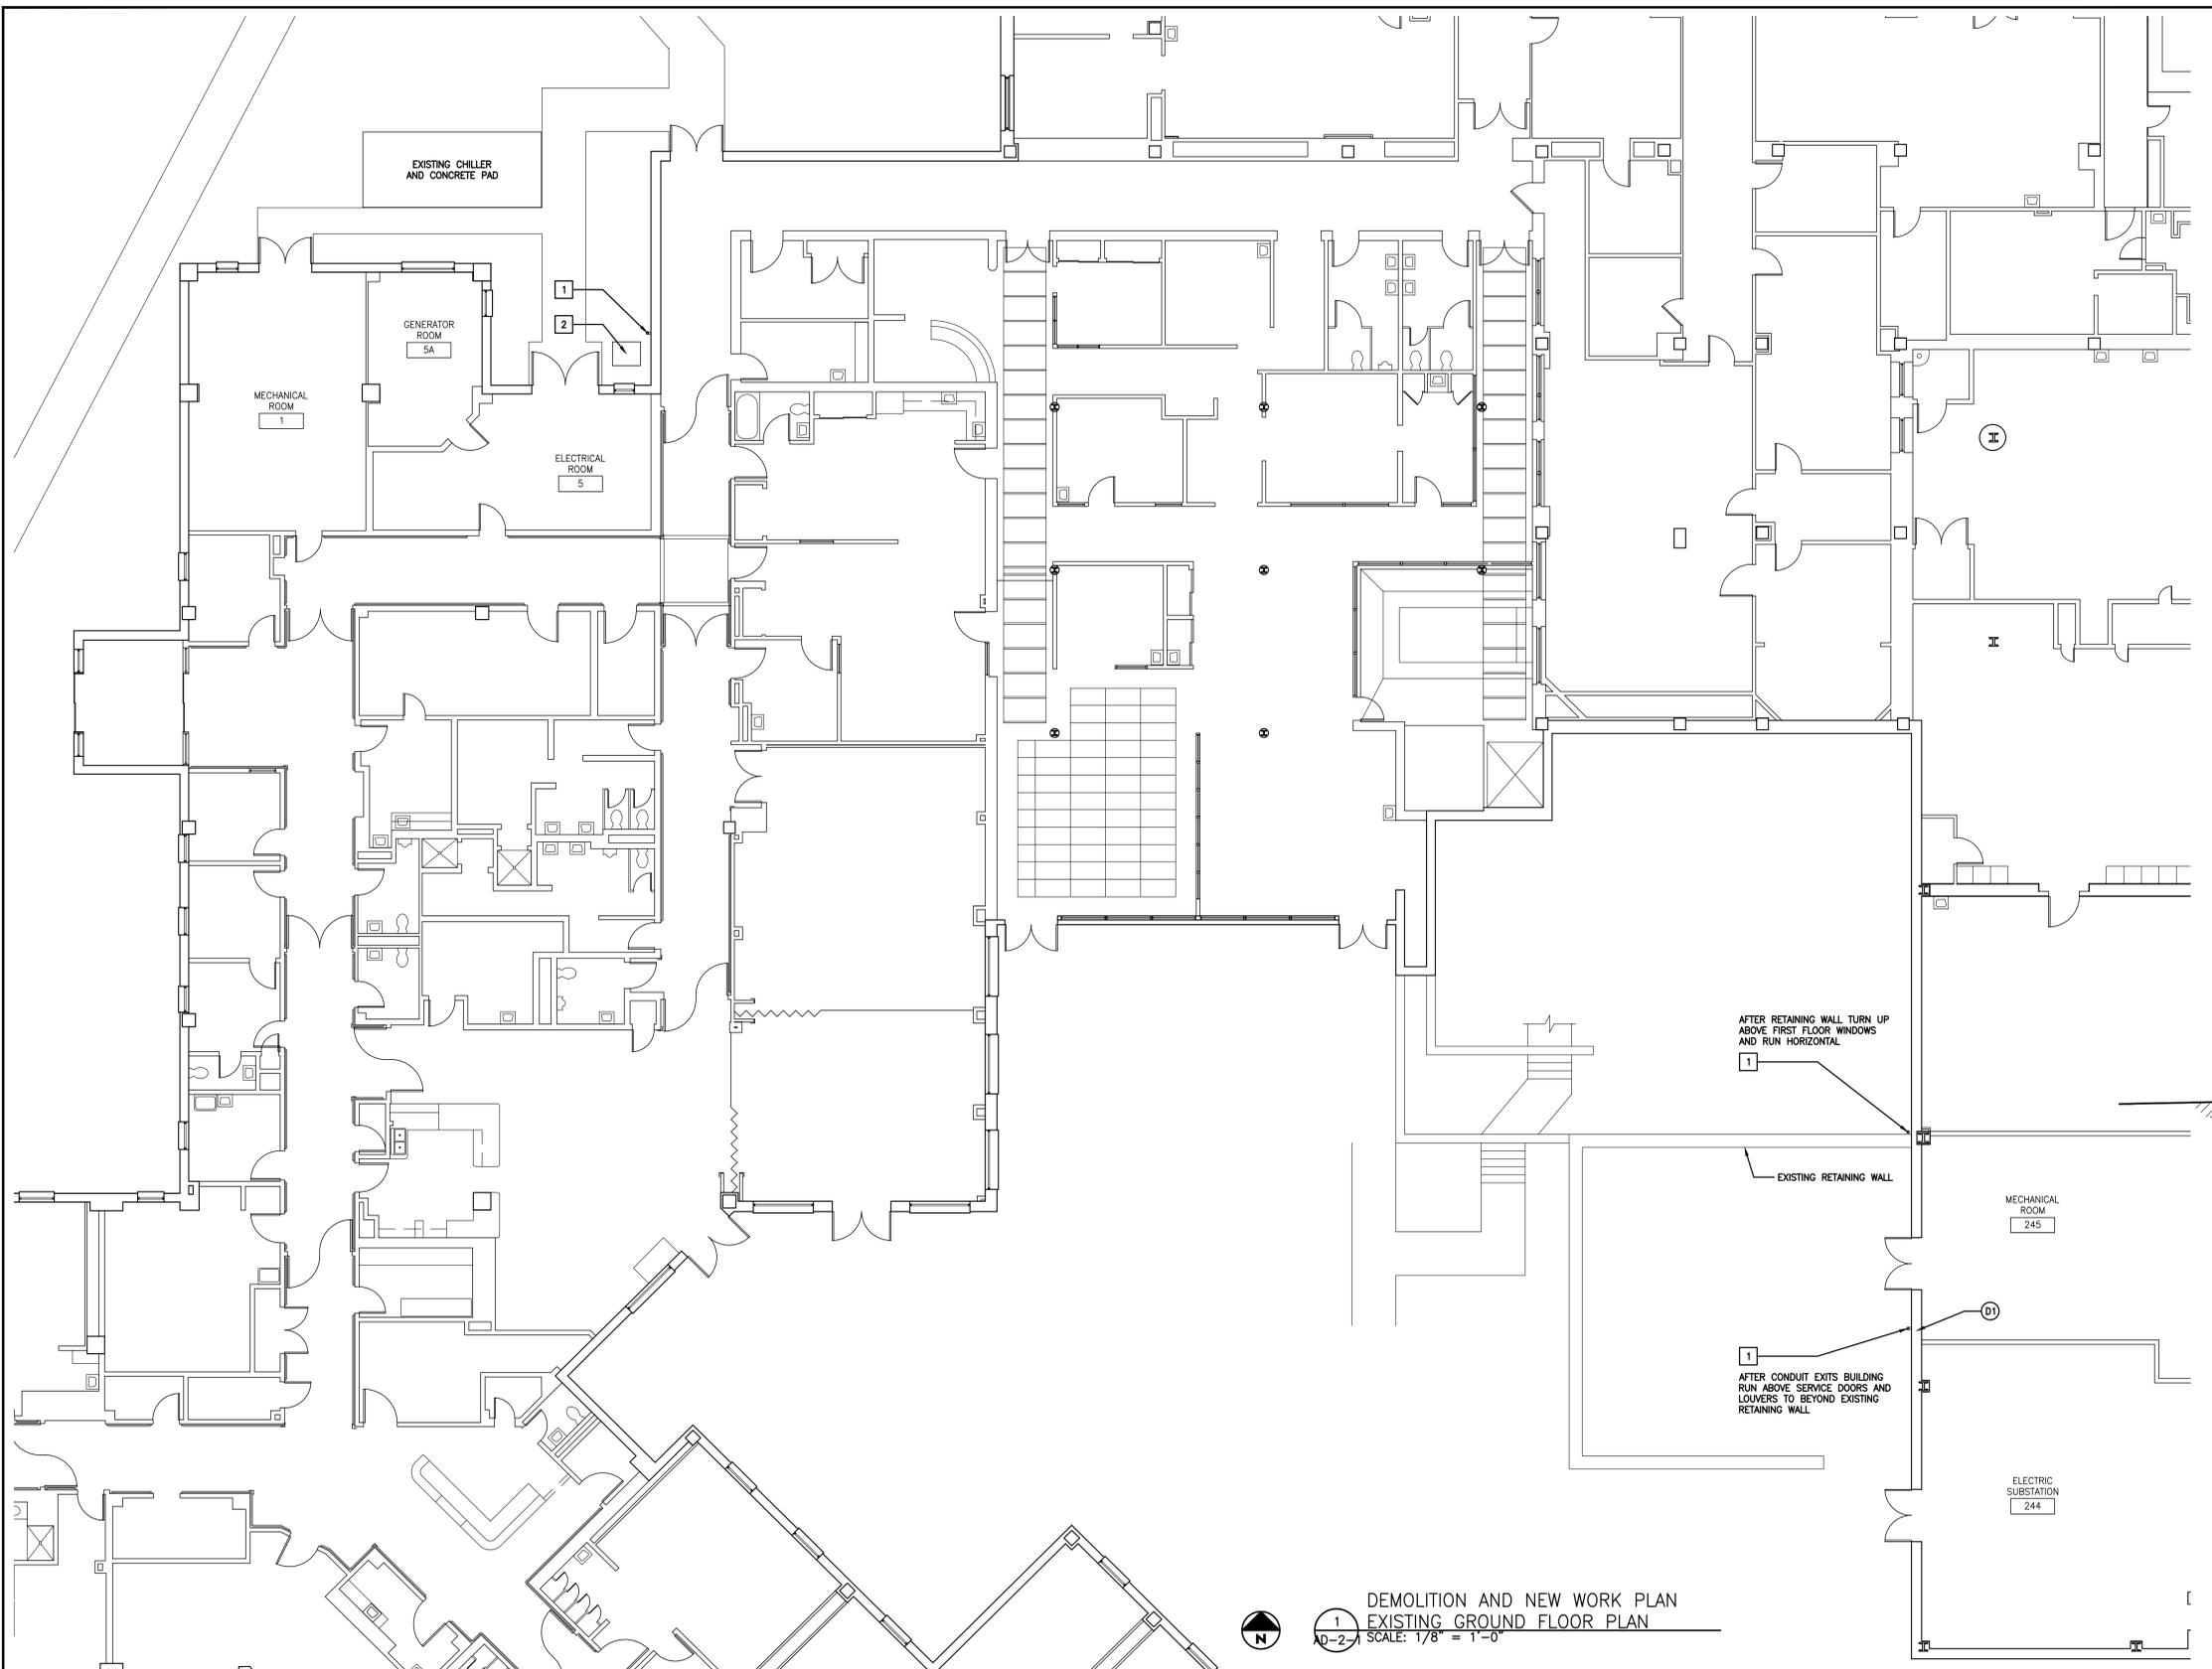


DEMOLITION KEYNOTES (SHEET AD-2-1 AND AD-2-2 ONLY):
 (D1) CORE-DRILL PER CONDUIT REQUIREMENTS AT EXTERIOR WALL. REFER TO ELECTRICAL DRAWINGS FOR CONDUIT SIZE AND QUANTITY AND ALL REQUIREMENTS FOR CONDUIT REQUIRED. PROVIDE ALL REQUIRED FIRE-STOPPING AND SEALANT. CRITICAL: ALL OUTSIDE DIAMETERS OF REQUIRED CONDUITS SHALL BE A MINIMUM OF 3" CLEAR FROM ALL VERTICAL AND HORIZONTAL EDGES OF EXISTING CONCRETE/STONE VENEER PANELS - FIELD VERIFY EXACT LOCATIONS TO PENETRATE.

NEW WORK KEYNOTES (SHEET AD-2-1 AND AD-2-2 ONLY):
 1 CONDUIT - REFER TO SHEETS AD-2-3, AD-2-4, AD-2-5 AND AD-2-6 FOR ADDITIONAL INFORMATION.
 2 42" x 36" CONCRETE PAD FOR TRANSFORMER - REFER TO SHEET AD-2-5, AD-2-6 AND DETAIL 2/AD-2-1 THIS SHEET FOR ADDITIONAL INFORMATION.
 3 CONDUIT BLOCKS FULLY ADHERED TO ROOF SYSTEM PER CONDUIT BLOCK MANUFACTURER RECOMMENDATIONS AND COMPATIBLE WITH EXISTING ROOF SYSTEMS. AT AREAS OF ROOF BALLAST, REMOVE STONE TO MINIMAL EXTENT REQUIRED FOR FULL ADHESION OF CONDUIT BLOCK. REFER TO SHEET AD-2-6 FOR ADDITIONAL INFORMATION.

GENERAL NOTES (ALL SHEETS):
 THE CONTRACTOR SHALL LOCATE ANY AND ALL EXISTING UNDERGROUND UTILITIES IN THE LIMITS OF WORK AREA. COORDINATE LOCATION OF NEW AND EXISTING UNDERGROUND UTILITIES WITH THE COFR.
 TEMPORARILY REMOVE EXISTING ACOUSTIC CEILING TILE TO MINIMAL EXTENT REQUIRED TO PERFORM WORK (REMOVE ASSOCIATED GRID AND OTHER CEILING DEVICES IF REQUIRED) AND STORE IN A SAFE PLACE. UPON COMPLETION OF WORK REINSTALL ACOUSTIC CEILING TILE, CEILING GRID AND DEVICES TO MATCH EXISTING. REPAIR AND REPLACE ANY DAMAGED COMPONENT TO MATCH EXISTING CONDITION IF REQUIRED.
 REMOVE EXISTING GYPSUM BOARD CEILING TO MINIMAL EXTENT REQUIRED TO PERFORM WORK (REMOVE ASSOCIATED HARDWARE AND OTHER CEILING DEVICES IF REQUIRED). STORE HARDWARE AND DEVICES IN A SAFE PLACE. UPON COMPLETION OF WORK PATCH AND REPAIR GYPSUM BOARD CEILING TO MATCH EXISTING CONDITION AND REINSTALL DEVICES TO MATCH EXISTING CONDITION AND LOCATION. REPAIR AND REPLACE ANY DAMAGED COMPONENT TO MATCH EXISTING CONDITION IF REQUIRED.
 C.M.U. WALLS AND METAL STUD WITH GYPSUM BOARD MAY EXTEND TO UNDERSIDE OF EXISTING SLAB ABOVE. CORE-DRILL AND SAW-OUT PER WALL TYPE. UPON COMPLETION OF WORK SEAL ALL PENETRATIONS AS REQUIRED TO MEET WALL RATING (IF REQUIRED).
 CONTRACTOR SHALL COORDINATE THE EXACT CONDUIT ROUTE WITH THE COFR.

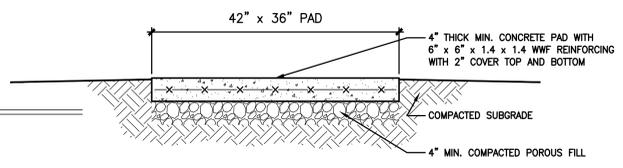

2 CONCRETE PAD DETAIL
 AD-2-1 SCALE: 1" = 1'-0"

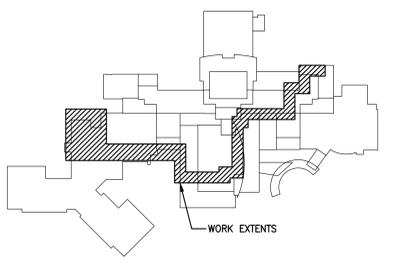

KEYPLAN

DEMOLITION AND NEW WORK PLAN
 EXISTING GROUND FLOOR PLAN
 1 AD-2-1 SCALE: 1/8" = 1'-0"

Additions:	Date:
Revisions:	

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Drawing Scale:	Drawing Title: EXISTING FLOOR PLANS
Drawing Start Date:	Approved: Associate Director for Operations:
Drawing Finish Date:	Approved: Chief, Facilities Engineer:
Drawing Approved:	Approved: Director, Medical Center:

Project Title: EMERGENCY POWER TO MAIN HOSPITAL ELEVATORS		
Building No: 1	Checked: CAJ	Drawn: BDA
Location: VAMHCS MEDICAL CENTER WILMINGTON, DELAWARE		

Date: 9-4-2012
Project No: 460-12-123
DRAWING NO: AD-2-1
Dwg. 1 Of 6

