


- GENERAL SELECTIVE DEMOLITION NOTES:**
1. SELECTIVE DEMOLITION REFERENCE NOTES ARE INTENDED TO GENERALLY LOCATIONS WHERE REQUIRED AND SHALL NOT BE HELD BY THE CONTRACTOR OF THE FULL RESPONSIBILITY FOR EXAMINING AND VERIFYING THE FULL EXTENT OF EXISTING CONDITIONS.
 2. EXISTING CONDITIONS INCLUDING PARTIAL OR COMPLETE REMOVAL AND/OR MODIFICATION TO COMPONENTS OR ASSEMBLIES PERTAINING TO THE EXISTING BUILDING STRUCTURE.
 3. REPAIRS TO EXISTING STRUCTURE SHALL BE PERFORMED PER APPROVED REPAIRS PREPARING TO THE REMOVAL, RELOCATION, AND/OR MODIFICATION OF ITEMS RELATED TO EXISTING MECHANICAL, PLUMBING, AND ELECTRICAL SYSTEMS. ELECTRICAL REPAIRS FOR SEPARATE NOTES TO MECHANICAL AND ELECTRICAL ITEMS.
 4. ALL ACCESSORIES RELATED TO THE REMOVED ITEMS (SUCH AS ANCHOR SUPPORTS, TRIM PIECES, ETC.) SHALL BE REMOVED INCLUDING BUT NOT LIMITED TO CONDUIT, WIRING MOTORS AND CONTROLS.
 5. DISPOSITION OF EXISTING UNDERGROUND UTILITIES AND STEEL LINES IN THE PROJECT VICINITY.
 6. THE CONTRACTOR IS RESPONSIBLE FOR REMOVING ALL ITEMS FROM THE WORK AREA AS REQUIRED FOR NEW CONSTRUCTION INCLUDING BUT NOT LIMITED TO: EXISTING CONCRETE, STEEL, BRICK, BLOCK, CONCRETE PILING AND INLET DRAINS.
- KEYNOTES:** (KEYNOTES REFERENCED THIS SHEET ONLY)
1. REMOVE EXISTING BRICK AND CAUL CAVITY WALL
 2. REMOVE EXISTING DOOR AND FRAME REMAIN
 3. REMOVE GROUT AND EXISTING CONCRETE
 4. REMOVE EXISTING CONCRETE TO REMAIN
 5. EXISTING ROOF LEADER TO REMAIN
 6. REMOVE EXISTING STEEL PLATFORM AND RAILING
 7. REMOVE EXISTING STAIRS AND RAILING
 8. REMOVE EXISTING CHAIN LINK FENCE AND SLIDING GATE
 9. REMOVE EXISTING FACE BRICK AND ROOF INSULATION. PREPARE FOR REPAIRS TO EXISTING STRUCTURE.
 10. REMOVE EXISTING FACE BRICK AND ROOF INSULATION. PREPARE FOR REPAIRS TO EXISTING STRUCTURE.
 11. REMOVE EXISTING SUPERHEATED PLASTER CEILING AND INSULATION FOR ALL AREAS FOR NEW WORK.
 12. REMOVE EXISTING SUPERHEATED PLASTER CEILING AND INSULATION FOR ALL AREAS FOR NEW WORK.
 13. REMOVE EXISTING CONCRETE PAVING FOR BUILDING PAD AREA. REFER TO FOUNDATIONS FOR PROPOSED WORK. DRAWINGS FOR LOCATIONS OF FOUNDATIONS FOR PROPOSED WORK.
 14. REMOVE EXISTING DOCK LEVELERS, DOCK LIFTS, DOCK BARRIERS, DOCK SEALS AND RELATED ACCESSORIES. CONCRETE WORK SHALL BE PERFORMED PER APPROVED REPAIRS PREPARING TO THE REMOVAL, RELOCATION, AND/OR MODIFICATION OF ITEMS RELATED TO EXISTING MECHANICAL, PLUMBING, AND ELECTRICAL SYSTEMS. ELECTRICAL REPAIRS FOR SEPARATE NOTES TO MECHANICAL AND ELECTRICAL ITEMS.
 15. REMOVE EXISTING FACE BRICK AND ROOF INSULATION. PREPARE WALL FOR METAL STUDS AND OVERLAP BOARD IN PLACE OF REMOVED BRICK. REFER TO FLOOR PLANS AND REFERENCED WALL SECTIONS AND PLAN SECTIONS.
 17. EXISTING ELECTRICAL BUS DUCT, CONDUIT AND WIRING TO REMAIN.
 18. REMOVE EXISTING HEATER, HVAC DUCT OR EQUIPMENT ITEM. SEE
 19. EXISTING LOUVER. SEE MECHANICAL.
 20. EXISTING CONCRETE PLATFORM
 21. REMOVE EXISTING METAL RAILING. WIRE MESH AND STEEL
 22. REMOVE EXISTING MARGOLAE ENCLOSURE IN ITS ENTIRETY INCLUDING BUT NOT LIMITED TO FOUNDATIONS AND FOOTINGS
 23. DRAWINGS FOR MARGOLAE ENCLOSURE TO REMAIN
 24. EXISTING CAST IRON WASTE PIPING. REFER TO PLUMBING
 25. EXISTING ELECTRICAL TRANSFORMER TO REMAIN
 26. EXISTING ELECTRICAL TRANSFORMER TO BE REMOVED BY SEPARATE CONTRACTOR PRIOR TO WORK FOR THIS PROJECT
 27. REMOVE EXISTING CONCRETE WALK
 28. EXISTING MANHOLE AND COVER TO REMAIN
 29. SHARED AREA INDICATES CONSTRUCTION WORK FOR MODERNIZATION OF COL BITS. PROJECT NO. 646-366 TO BE PERFORMED BY OTHERS. SHOWN ON THIS DRAWING FOR REFERENCE ONLY
 30. EXISTING ACCESS OPENING TO CRAWLSPACE TO REMAIN
 31. RELOCATE EXISTING CONDENSING UNITS. REFER TO MECHANICAL
 32. REPAIR EXISTING CEILING PANELS REFER TO REFERENCED CEILING
 33. REMOVE EXISTING CONCRETE BARRIERS
 34. EXISTING EMERGENCY EYEWASH STATION TO BE REMOVED AND RELOCATED TO STORAGE ROOM. SEE FLOOR PLANS FOR
 35. EXISTING MANHOLE TO BE REMOVED OR RELOCATED
 36. EXISTING STAIR INLET TO BE REMOVED
 37. REMOVE EXISTING TILE FLOORING. PREPARE SURFACE TO RECEIVE NEW FLOOR FINISH

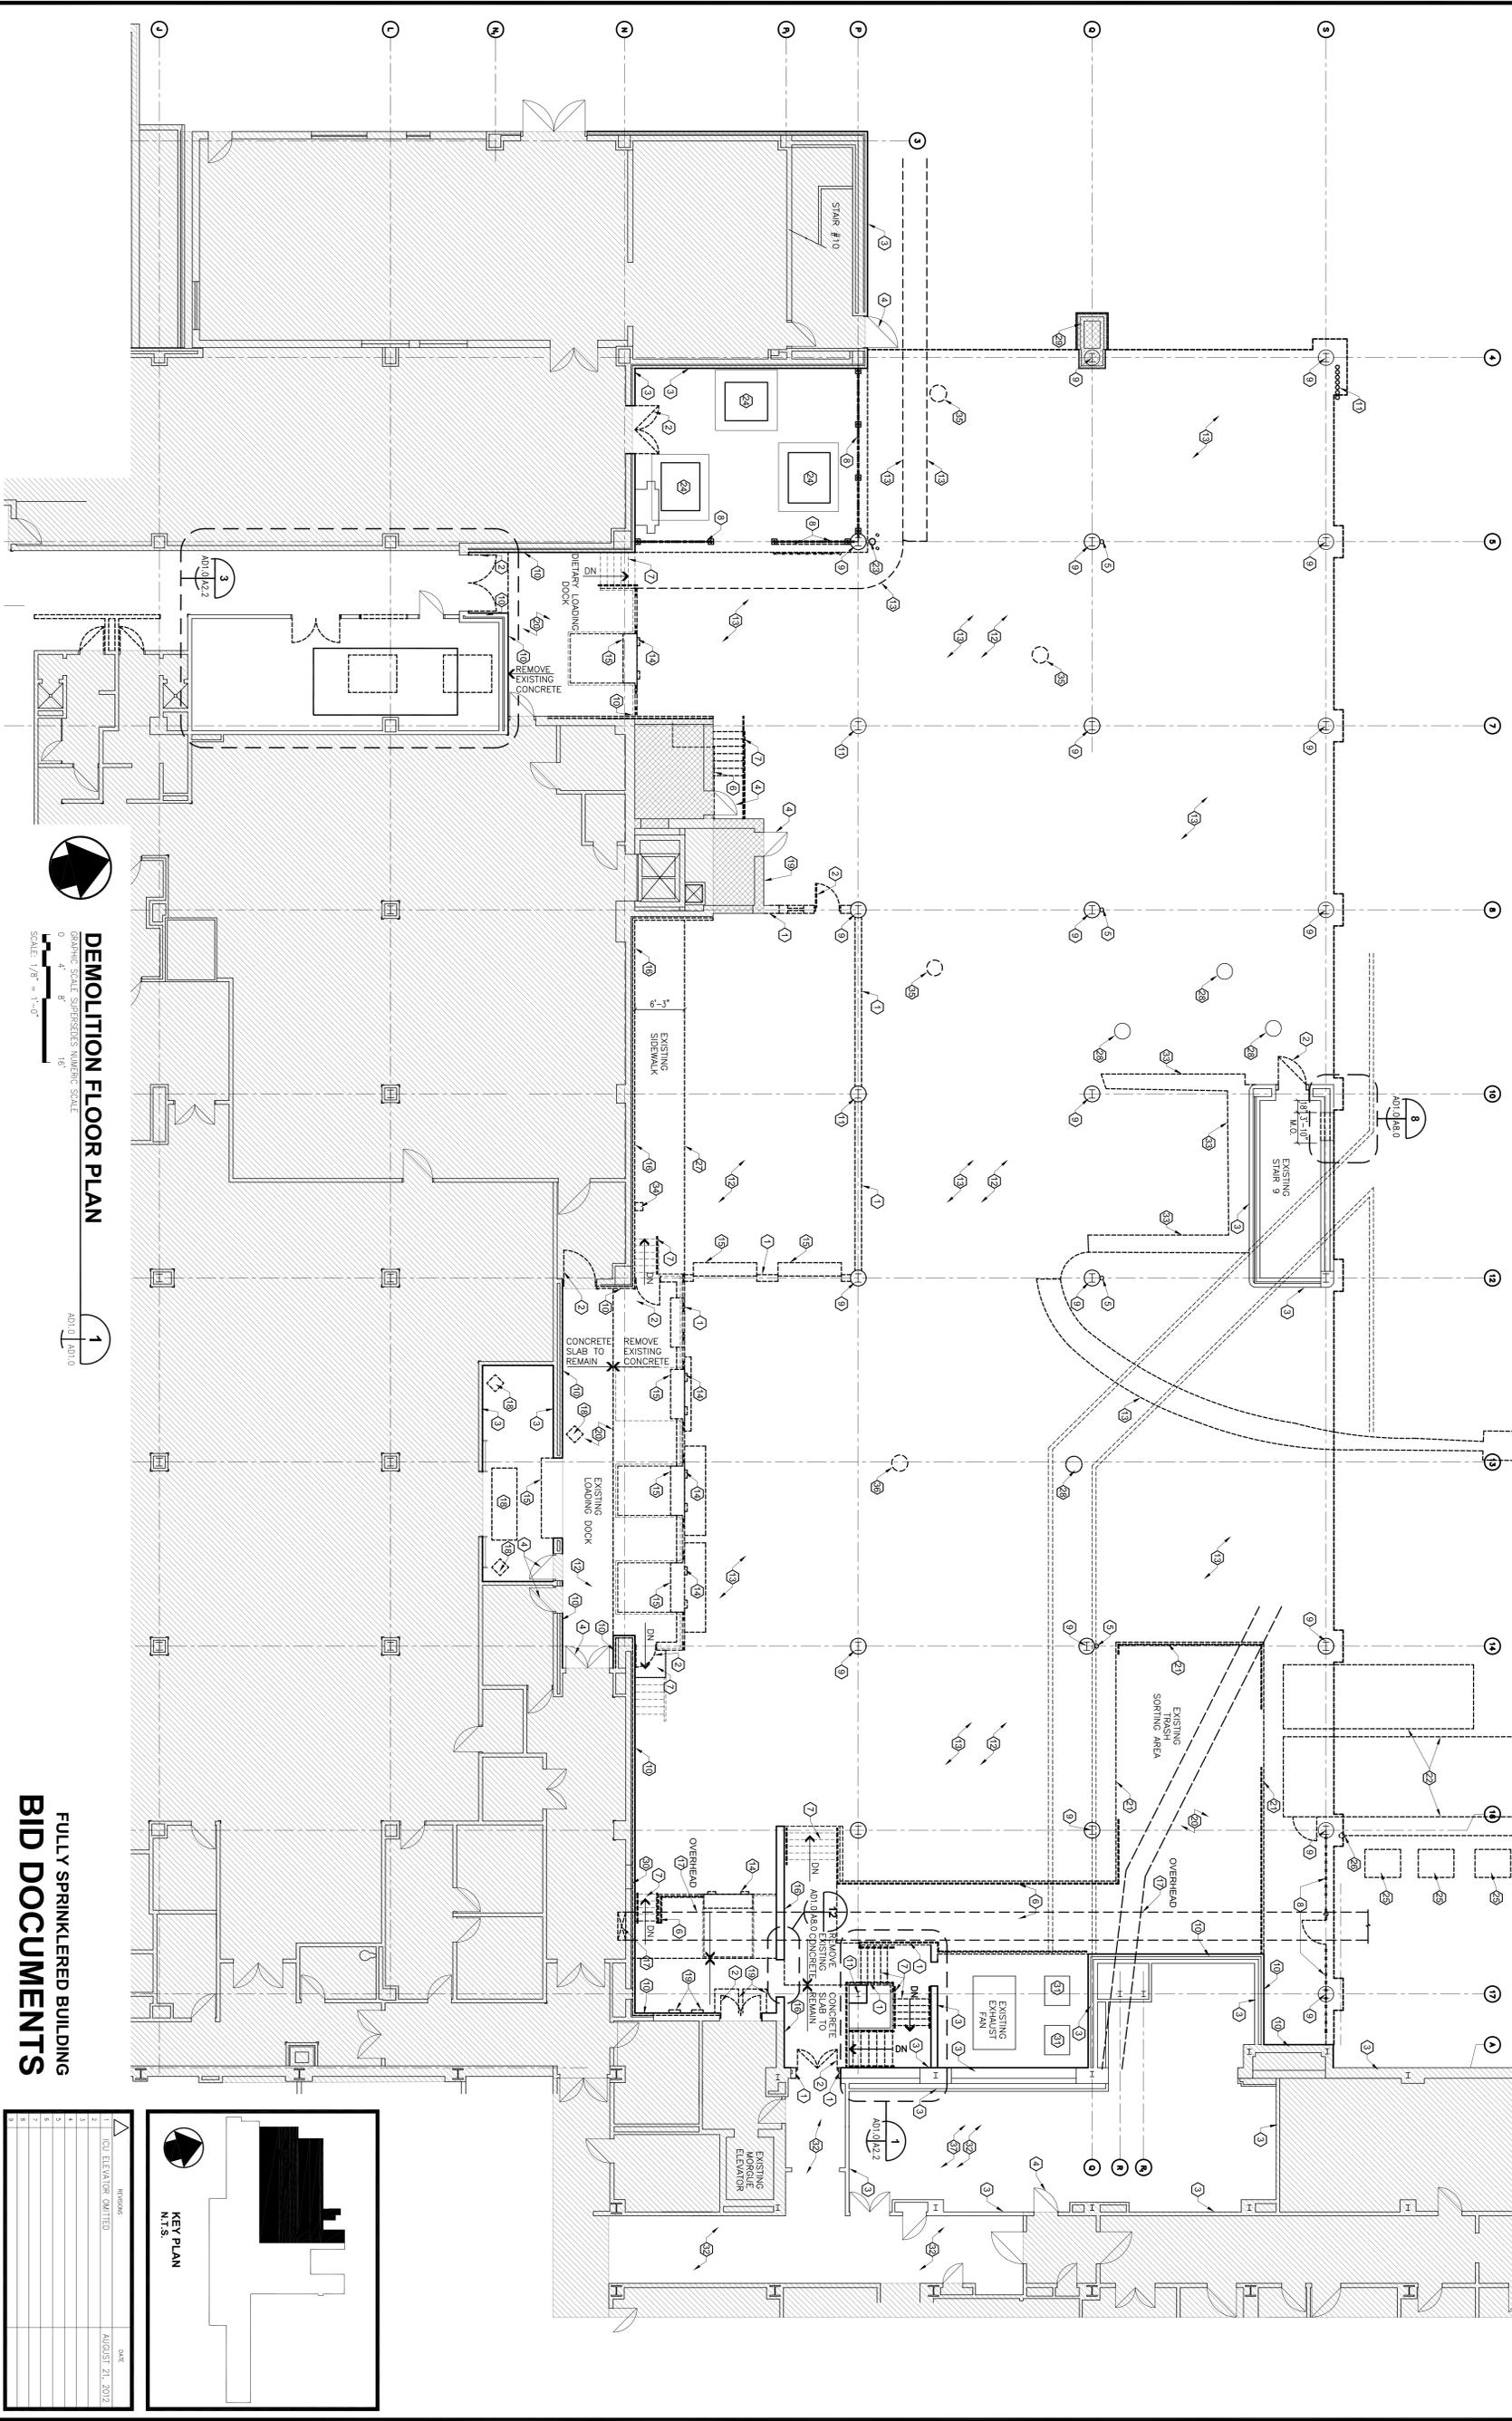


DEMOLITION FLOOR PLAN

GRAPHIC SCALE SUPERSEDES NUMERIC SCALE

SCALE: 1/8" = 1'-0"

FULLY SPRINKLERED BUILDING

BID DOCUMENTS

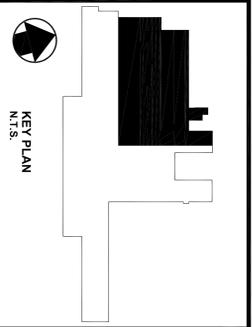

| NO. | REVISION | DATE |
|-----|---------------------------|-----------------|
| 1 | ADD ELEVATION ON 11/13/20 | AUGUST 21, 2012 |
| 2 | | |
| 3 | | |
| 4 | | |
| 5 | | |
| 6 | | |
| 7 | | |

Department of Veterans Affairs

UPGRADE SPD AND SECURITY DOCK
PROJECT: 646-367
VA PITTSBURGH HEALTHCARE SYSTEM
UNIVERSITY DRIVE C
PITTSBURGH, PENNSYLVANIA 15240

PARADIGM
ENGINEERS AND CONSTRUCTORS
PO BOX 436223
Louisville, Kentucky 40253
502-399-8511 www.paradigmusa.com

PROJECT NO. AD1.0R1
DATE: AUGUST 21, 2012
DRAWN BY: JG
CHECKED BY: JG
SCALE: 7/8\"/>