




one and one half inches = one foot
 one inch = one foot
 three quarters inch = one foot
 one half inch = one foot
 one quarter inch = one foot
 one eighth inch = one foot

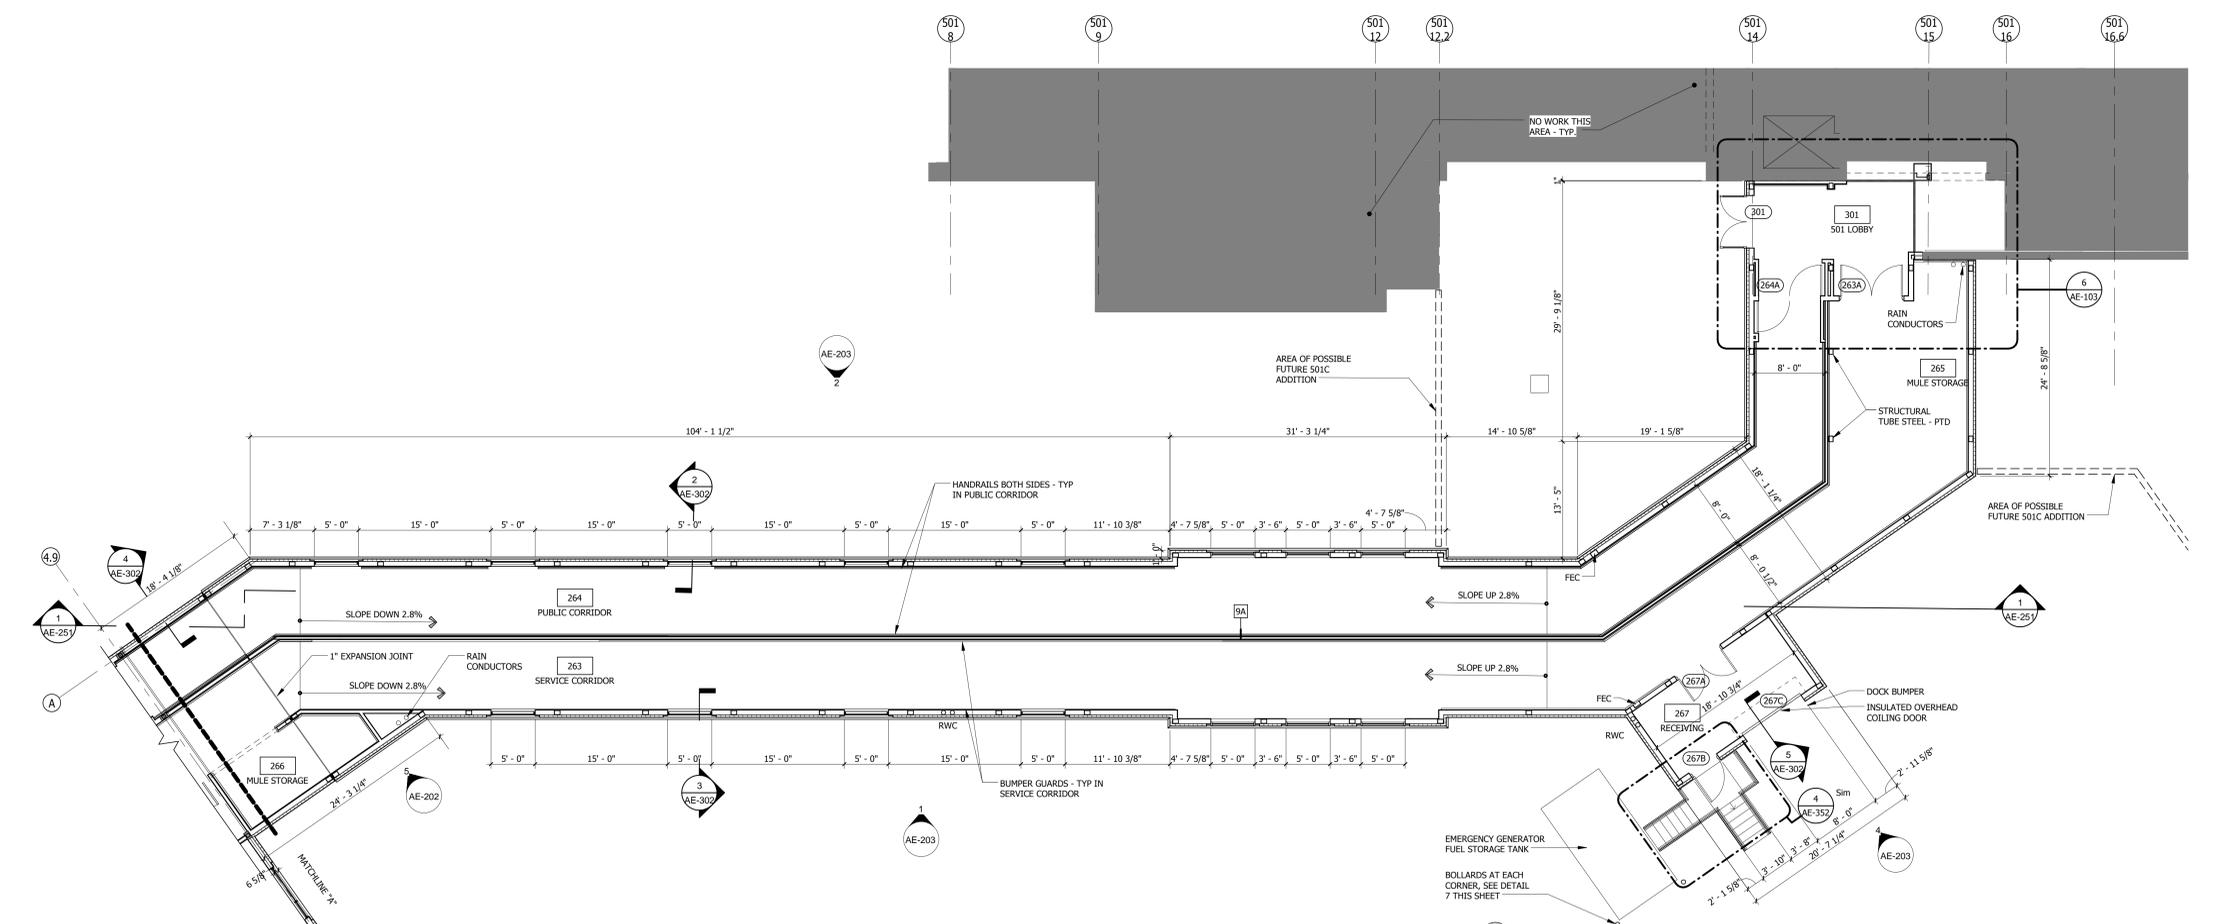


3 501 GROUND FLOOR PLAN -CONNECTOR
 SCALE 1/8" = 1'-0"

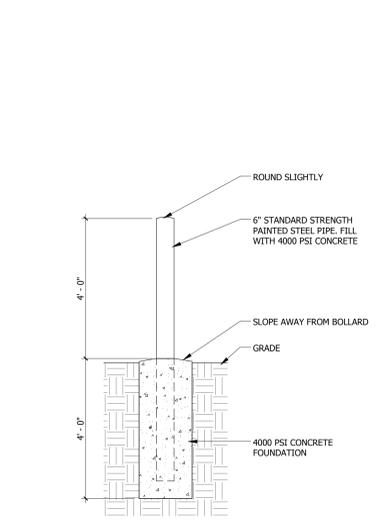


7 BOLLARD DETAIL
 SCALE 1/2" = 1'-0"

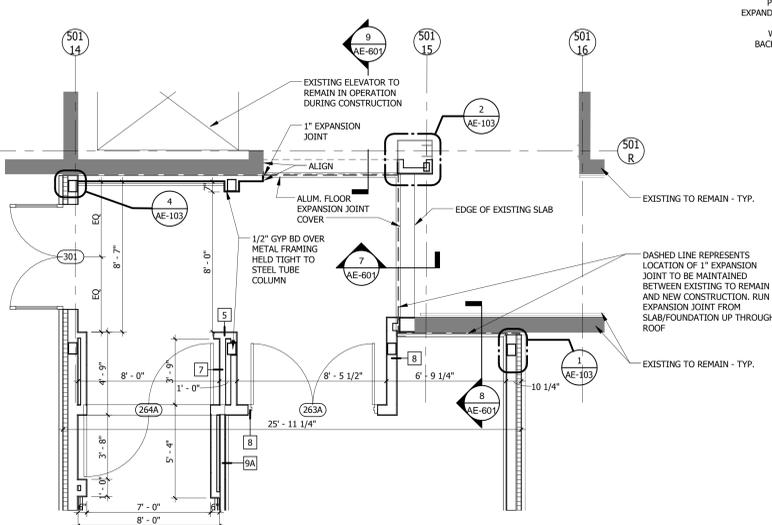


6 ENLARGED FLOOR PLAN AT 501C CONNECTION
 SCALE 1/4" = 1'-0"

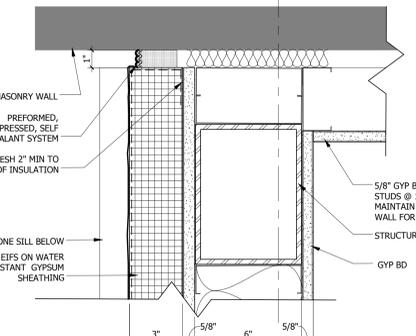


4 EXPANSION JOINT PLAN DETAIL
 SCALE 3" = 1'-0"

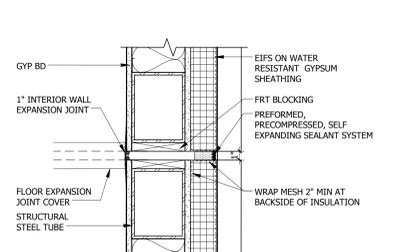

5 EXPANSION JOINT PLAN DETAIL
 SCALE 1 1/2" = 1'-0"

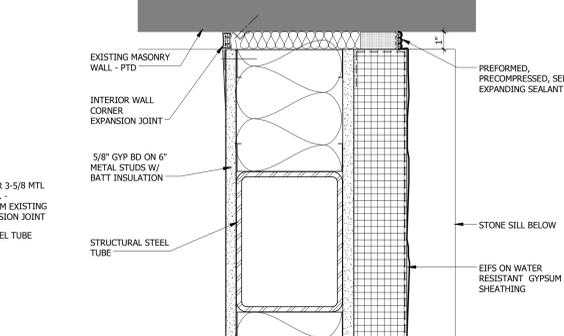

1 EXPANSION JOINT PLAN DETAIL
 SCALE 3" = 1'-0"

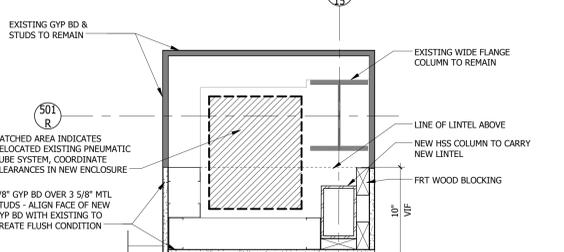

2 PLAN DETAIL AT 501C
 SCALE 1 1/2" = 1'-0"

- GENERAL NOTES:**
- INTERIOR DIMENSIONS ARE FROM FINISH TO FINISH OR CENTERLINE OF COLUMNS UNLESS NOTED OTHERWISE.
 - TOLERANCES FOR BUILT-IN ITEMS, INCLUDING ARCHITECTURAL WINDOWS, CASEWORK AND APPLIANCES MUST BE FIELD VERIFIED BY THE CONTRACTOR TO ENSURE ADEQUATE CLEARANCES AND PROPER FIT.
 - REFER TO REFLECTED CEILING PLANS FOR CEILING HEIGHT AND TYPES.
 - REFER TO FINISH SCHEDULE FOR ALL FINISHES THROUGHOUT THE PROJECT.
 - REFER TO 1/8" SCALE PLANS FOR DOOR AND WINDOW DESIGNATIONS.
 - REFER TO LIFE SAFETY PLANS FOR LOCATION OF FIRE RATED PARTITIONS.
 - PROVIDE FIRE RETARDATION WOOD BLOCKING AS REQUIRED FOR INSTALLATION OF FUTURE GRAB BARS.
 - PROVIDE FIBER-REINFORCED WATER & MOLD RESISTANT GYPSUM PANELS AT ALL WET WALL LOCATIONS AND WALLS BEHIND AND ADJACENT TO SINKS.
 - CENTER VANITY LIGHTS ABOVE MIRRORS.
 - ALL ROOFTOP HVAC EQUIPMENT TO HAVE SCREENED ENCLOSURES.

- PARTITION TYPES:**
- 1 HOUR FIRE-RATED BARRIER OR 1 HOUR FIRE RATED SMOKE BARRIER**
 5/8" FIRE-RATED GYP.BD. ON BOTH SIDES OF 3 5/8" METAL STUDS @ 16" O.C. FROM FLOOR TO ROOF OR FLOOR DECK ABOVE. PROVIDE RATE SEALANT AT TOP AND BOTTOM EDGES OF GYP. BD. PROVIDE FIRE SAFING AT FLUTES OF FLOOR OR ROOF DECK ABOVE PER UL NO. U419.
 - 1 HOUR SMOKE PARTITION (NON-RATED)**
 CORRIDOR PARTITION, SMOKE SEALED TOP, AT RATED CEILING AND AT FLOOR. 5/8" GYP.BD. ON BOTH SIDES OF 3 5/8" METAL STUDS @ 16" O.C. (AT CHASE WALLS, PROVIDE GYP.BD. ON FINISHED SIDE OF STUDS).
 - 2 HOUR FIRE-RATED BARRIER**
 2 LAYERS 5/8" FIRE-RATED GYP.BD. ON BOTH SIDES OF 3 5/8" METAL STUDS @ 16" O.C. SEAL GYP.BD. AT FLOOR AND AT ROOF DECK ON FLOOR STRUCTURE ABOVE. PROVIDE FIRE SAFING AT FLUTES OF FLOOR OR ROOF DECK ABOVE PER UL NO. U419.
 - 1 HOUR FIRE-RATED BARRIER**
 NOMINAL 8"X8"X16" CONCRETE MASONRY UNIT TO UNDERSIDE OF RATED STRUCTURE ABOVE PER IBC TABLE 720.1(2). ADD ONE LAYER OF 5/8" GYP. BD. ON ONE SIDE OF 1 5/8" METAL STUD FURRING @ 16" O.C. SEAL TOP OF WALL WITH FIRE SAFING AT ROOF OR FLOOR DECK ABOVE.
 - 1 HOUR FIRE-RATED BARRIER**
 NOMINAL 8"X8"X16" CONCRETE MASONRY UNITS TO UNDERSIDE OF RATED STRUCTURE PER IBC TABLE 720.1(2).
 - 1 HOUR FIRE-RATED SHAFT WALL**
 1 1/2" C#1 STUDS AT 24" O.C. COVERED ONE SIDE W/ ONE LAYER 5/8" TYPE "X" GYPSUM BOARD, OPPOSITE SIDE COVERED W/ 1" GYPSUM PANELS, PER UL NO. U415A.
 - 2 HOUR FIRE-RATED SHAFT WALL**
 1 1/2" C#1 STUDS AT 24" O.C. COVERED ONE SIDE W/ TWO LAYERS 5/8" TYPE "X" GYPSUM BOARD, OPPOSITE SIDE COVERED W/ 1" GYPSUM PANELS, PER UL NO. U415B.
 - 2 HOUR FIRE-RATED BARRIER**
 2" CMU FROM FLOOR TO STRUCTURE ABOVE- SEAL TOP OF WALL WITH FIRE SAFING AT ROOF OR FLOOR DECK ABOVE PER UL NO. U905.
 - TYPICAL PARTITION**
 5/8" GYP. BD. ON BOTH SIDES OF 3 5/8" METAL STUDS, @ 16" O.C., GYP. BD. TO STRUCTURE ABOVE.
 - SAME AS (5) W/ 2" SOUND ATTENUATION BLANKETS
 - NOT USED.
 - CHASE WALL (WIDTH VARIES)**
 5/8" GYP.BD. ON ONE SIDE OF STAGGERED 3 5/8" METAL STUDS, @ 16" O.C., PROVIDE GYP.BD. ON EACH FINISH SIDE OF CHASE; GYP.BD. TO FIRE-RATED CEILING OR ROOF ASSEMBLY ABOVE.
 - SAME AS (7) W/ 2" SOUND ATTENUATION BLANKETS IN BOTH LINES OF STUDS.
 - 5/8" GYP.BD. ON BOTH SIDES OF 6" METAL STUDS
 - 0 HOUR RATED PARTITION W/ SOUND BATING**
 1/4" BASE LAYER GYP.BD. W/ 5/8" GYP.BD. ON BOTH SIDES OF 2 1/2" METAL STUDS @ 24" O.C., W/ 1" SOUND INSULATION (SCCS)
 - LOW WALL PARTITION**
 5/8" GYP. BD. ON BOTH SIDES OF 3 5/8" METAL STUDS @ 16" O.C., TO HEIGHT OF COUNTER TOP

- LEGEND:**
- FEC = FIRE EXTINGUISHER CABINET
 - RWC = RAIN WATER CONDUCTOR AND OVERFLOW CONDUCTOR
 - == = HANDRAIL LOCATED ON BOTH SIDES OF CORRIDOR, TYP.
 - = FUTURE CONSTRUCTION
 - = EXISTING CONSTRUCTION TO REMAIN

BID DOCUMENTS
 FULLY SPRINKLERED

Revisions:	CONSULTANTS:		ARCHITECT/ENGINEERS:	Drawing Title	Project Title	Project Number
			C.C. HODGSON ARCHITECTURAL GROUP, INC.	FLOOR PLAN - CONNECTOR	RELOCATE DEMENTIA UNIT	VA PN 613-107
				Approved: Project Director	Location	Building Number
					VAMC MARTINSBURG	513
					Date	Drawing Number
					8/6/2012	AE-103
					Checked	Dwg. of
					Author	

