




one and one half inches = one foot
 one inch = one foot
 three quarters inch = one foot
 one half inch = one foot
 one quarter inch = one foot
 one eighth inch = one foot

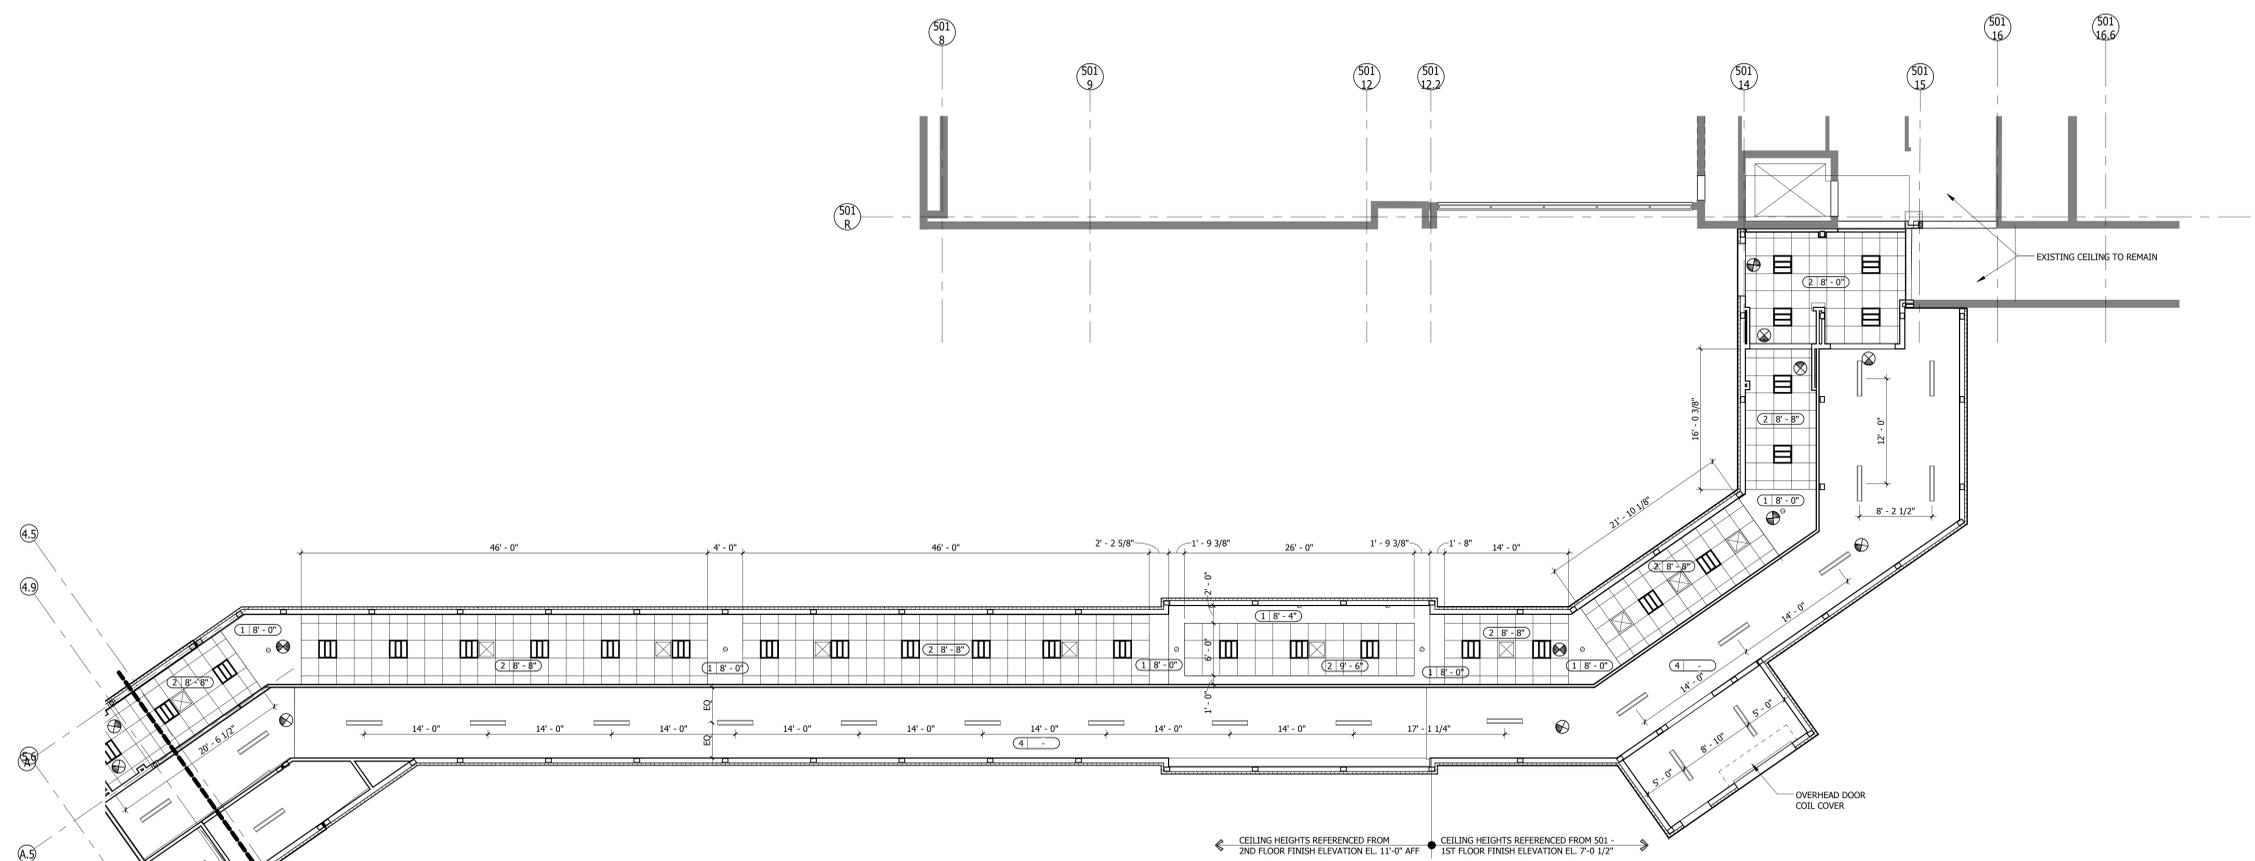

1 REFLECTED CEILING PLAN - CONNECTOR
 SCALE 1/8" = 1'-0"

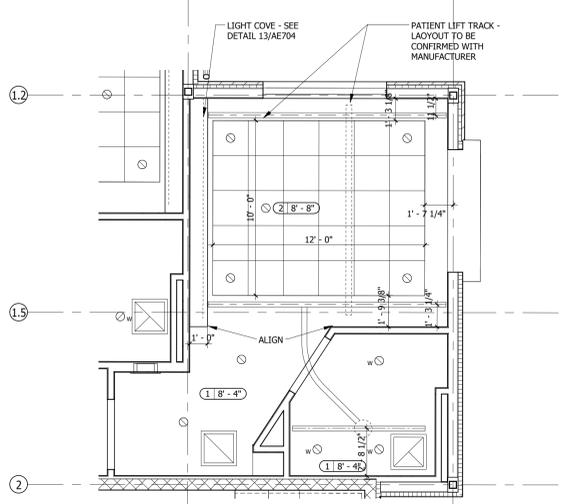

3 ENLARGED CEILING PLAN - CORNER UNIT
 SCALE 1/4" = 1'-0"

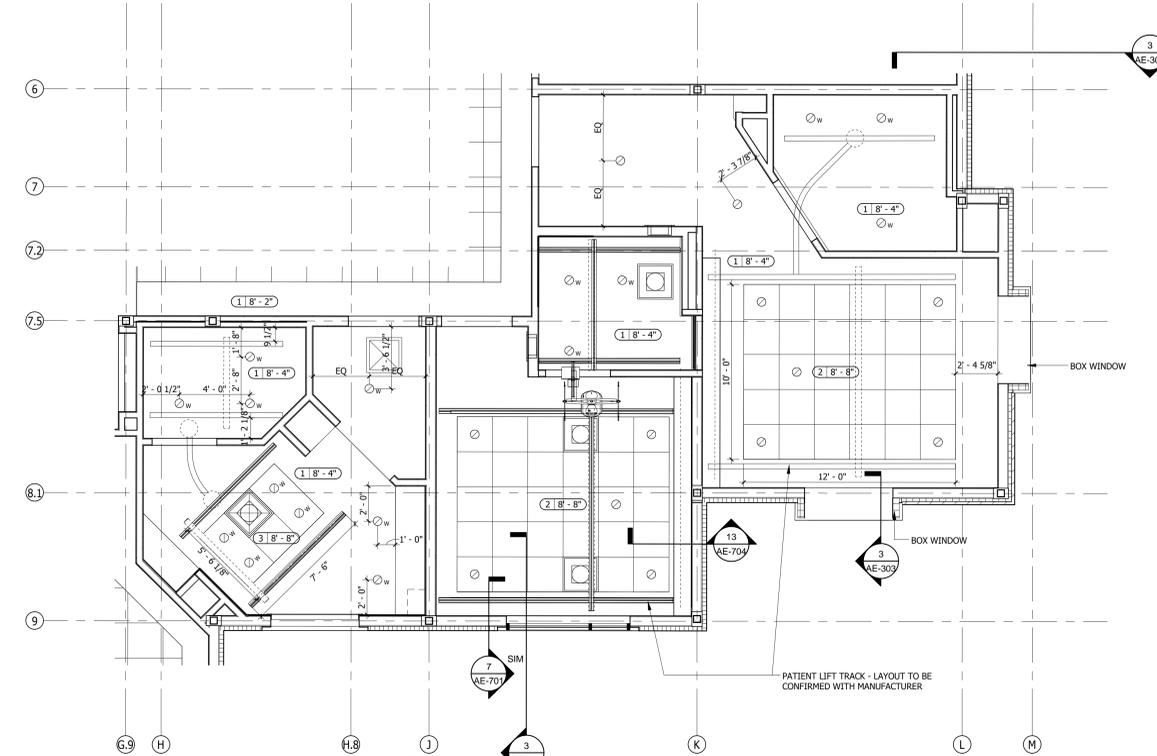

2 ENLARGED CEILING PLAN
 SCALE 1/4" = 1'-0"

- GENERAL NOTES:**
- A. DIFFUSERS, SPEAKERS, ETC. THAT ARE A PART OF THE CEILING SYSTEM ARE TO BE PAINTED OR PREFINISHED TO MATCH GRID SYSTEM.
 - B. GYPSUM BOARD CEILING AND SOFFITS ARE TO BE PAINTED. VERTICAL SURFACES OF SOFFIT ARE TO RECEIVE FINISH TO MATCH ADJACENT CEILING (WHITE), UNLESS INDICATED OTHERWISE.
 - C. CENTER CEILING GRID SYSTEM IN SPACES, UNLESS INDICATED OTHERWISE.
 - D. COORDINATE DIFFUSER AND LIGHT FIXTURE LOCATIONS WITH MECHANICAL AND ELECTRICAL REQUIREMENTS. EXACT LOCATIONS SHOWN ON ARCHITECTURAL CEILING PLANS SHALL GOVERN. THE ARCHITECT IS TO BE NOTIFIED OF ANY DISCREPANCIES.
 - E. COORDINATE FIRE ALARM SIGNALING DEVICES, EXIT SIGNS, SMOKE DETECTORS, ETC. WITH ELECTRICAL DRAWINGS AND APPROVED SHOP DRAWINGS.
 - F. COORDINATE LOCATIONS OF SPRINKLER HEADS WITH APPROVED SHOP DRAWINGS. HEADS TO BE LOCATED IN THE CENTER OF A CEILING PANEL OF SCORED AREA OF PANEL IN SUSPENDED ACOUSTIC CEILING.
 - G. REFLECTED CEILING PLANS MAY NOT SHOW FULL EXTENT OF LIGHTING, MECHANICAL PENETRATIONS OR REQUIRED ACCESS PANELS. COORDINATE WITH MECHANICAL AND ELECTRICAL DRAWINGS FOR ANY ADDITIONAL INFORMATION.
 - H. PROVIDE SUPPORT AND REINFORCEMENT FOR PENDANT LIGHT FIXTURES AND CEILING FANS.
 - I. PROVIDE EXTERNAL WALL MOUNTED FIXTURE AT EXIT AREAS.

- CEILING TYPES:**
- 1 Height) TYPE 1: PAINTED GYPSUM BOARD. USE FIBER-REINFORCED WATER AND MOLD RESISTANT GYPSUM PANEL IN BATHING ROOMS, LOCKER ROOMS AND EXTERIOR STORAGE ROOMS.
 - 2 Height) TYPE 2: AT-1 2' X 2' ACOUSTICAL PANEL CEILING SYSTEM WITH TEGULAR EDGE.
 - 3 Height) TYPE 3: AT-2 2' X 4' MOISTURE RESISTANT ACOUSTICAL PANEL CEILING SYSTEM WITH TEGULAR EDGE.
 - 4 Height) TYPE 4: NO CEILING - EXTEND GYP. BD. TO BOTTOM OF DECK
 - 5 Height) TYPE 5: DIRECT-APPLIED EXTERIOR FINISH SYSTEM (DAFS) - VENTED

- CEILING LEGEND:**
- TYPE 1: GYPSUM BOARD
 - TYPE 2: ARMSTRONG ULTIMA 2' X 2', TEGULAR EDGE W/ 15/16" SUPRA FINE TEE GRID
 - TYPE 3: ARMSTRONG ULTIMA HIGH WASHABILITY 2' X 4' SQUARE EDGE W/ 15/16" SUPRA FINE TEE GRID
 - TYPE 4: EXPOSED STRUCTURE - PTD.
 - DECORATIVE FLOURESCENT PENDANT LIGHT FIXTURE
 - 6" RECESSED COMPACT FLOURESCENT DOWNLIGHT RATED FOR WET AREA
 - 6" RECESSED COMPACT FLOURESCENT DOWNLIGHT
 - 6" RECESSED COMPACT FLOURESCENT DIRECTIONAL DOWNLIGHT
 - LOW VOLTAGE STEM MOUNTED MINI PENDANT
 - INCANDESCENT WALL SCONCES
 - DECORATIVE FLOURESCENT WALL SCONCE MOUNTED OVER VANITY IN RESIDENT BATHROOM
 - DIRECT/INDIRECT LINEAR FLOURESCENT PENDANT
 - CEILING MOUNTED LINEAR FIXTURE
 - WALL MOUNTED LINEAR FIXTURE
 - 2X2 RECESSED FLOURESCENT LIGHT FIXTURE WITH PARABOLIC LENS
 - 2X4 RECESSED FLOURESCENT LIGHT FIXTURE WITH PARABOLIC LENS
 - 2X2 RECESSED DIRECT/INDIRECT FLOURESCENT LIGHT FIXTURE WITH PARABOLIC LENS
 - DECORATIVE INCANDESCENT PENDANT LIGHT FIXTURE
 - SUPPLY AIR DIFFUSER
 - RETURN AIR DIFFUSER
 - EXHAUST FAN
 - CONTINUOUS LED STRIP LIGHTING WITHIN COVE
 - RECESSED LIFT TRACK OCCURS IN ROOMS (102, 104, 106, 108, 110, AND 202)
 - EXIT SIGN

**BID DOCUMENTS
 FULLY SPRINKLERED**

Revisions:	Date:	CONSULTANTS:			ARCHITECT/ENGINEERS:		Drawing Title		Project Number		Project Title		Drawing Number	
					C.C. HODGSON ARCHITECTURAL GROUP, INC.		REFLECTED CEILING PLAN - LINK		VA PN 613-107		RELOCATE DEMENTIA UNIT		AE-173	
						Approved: Project Director		Location		Checked		Drawn		
								VAMC MARTINSBURG		Date		Author		
								8/6/2012		8/6/2012		Dwg. of --		

**Office of
 Construction
 and Facilities
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 Department of
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