


1
E200
ELECTRICAL LIGHTING PLAN
SCALE: 1/4" = 1'-0"

GENERAL NOTES:


- CIRCUIT CORRIDOR EMERGENCY LIGHT FIXTURES TO EXISTING CORRIDOR LIFE SAFETY CIRCUIT.
- REFER TO DRAWING ER100 FOR WORK ASSOCIATED WITH LIGHT FIXTURES LABELED 'EXR'.

KEYED NOTES:

- CONNECT TO EXISTING 120V LIGHTING CIRCUIT REMAINING FROM REMOVALS.
- THREE AND FOUR-WAY SWITCHES SHALL BE WIRED TO SWITCH DIMMER CONTROLLED CIRCUIT.
- CONNECT TO EXISTING 120V CORRIDOR LIGHTING CIRCUIT.
- CONNECT EXIT SIGN TO EXISTING EXIT SIGN CIRCUIT REMAINING FROM REMOVALS.
- COORDINATE AND ADJUST LIGHT FIXTURE LOCATIONS WITH DUCTWORK/PIPING.

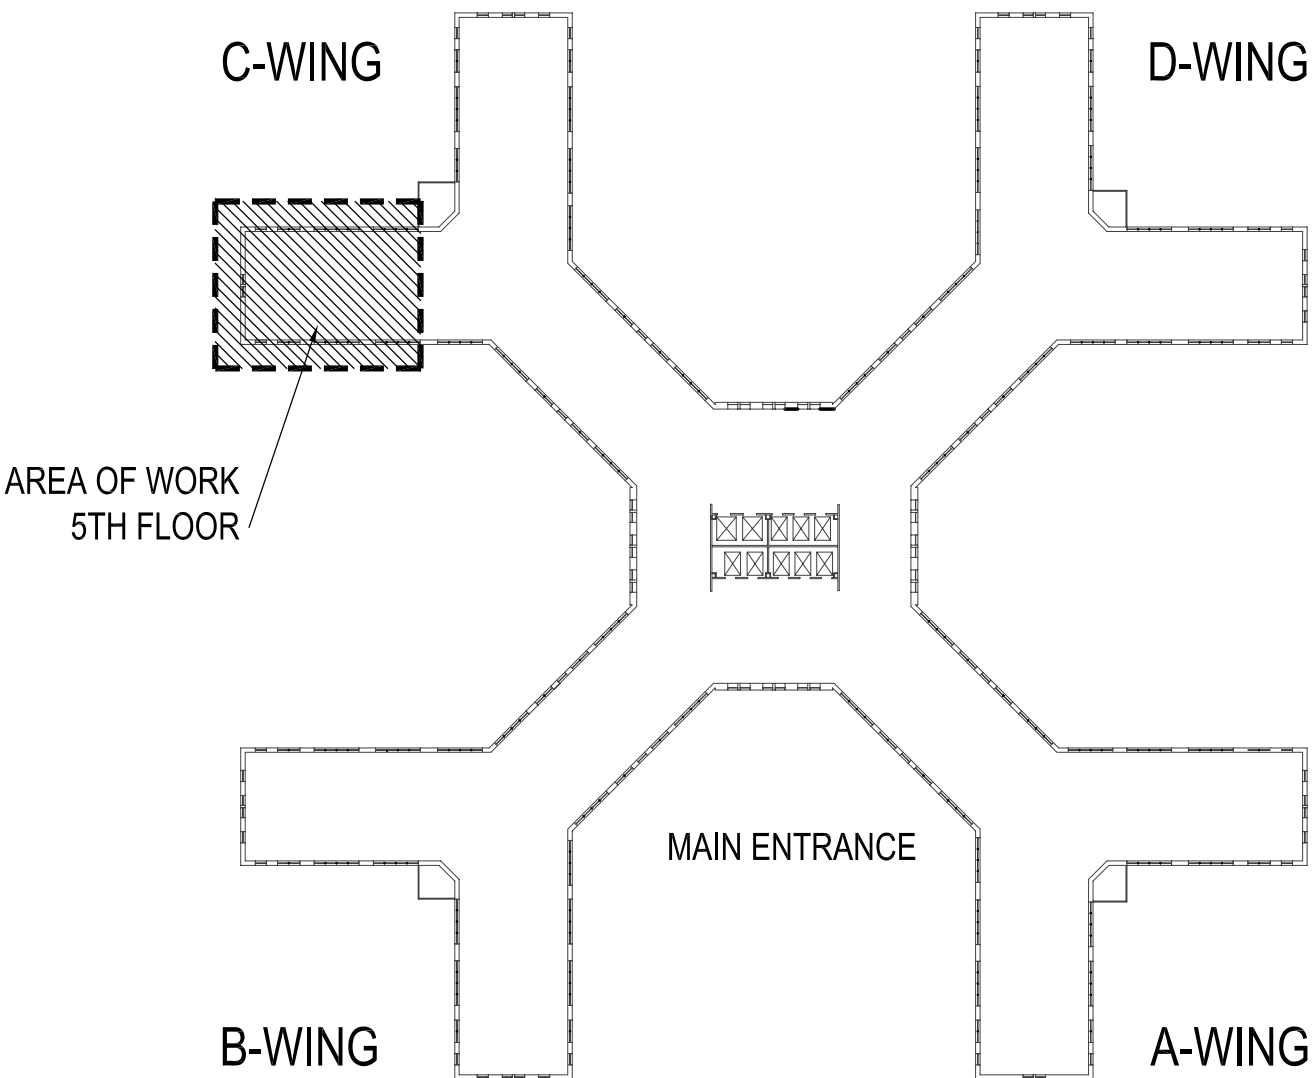

2
E200
WORK KEY PLAN
SCALE: N.T.S.

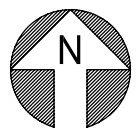

		CONSULTANTS:		ARCHITECT/ENGINEERS:	Drawing Title		Project Title		Project Number		STRATTON VA MEDICAL CENTER				
					ELECTRICAL LIGHTING PLAN		VISION CLINIC RENOVATIONS		528A8-08-830						
									Building Number						
									1						
100% SUBMISSION	05/13/11								Drawing Number						
95% SUBMISSION - REISSUED	06/04/10								E200						
95% SUBMISSION	02/12/10			Approved: Project Director		Location		Date		Checked		Drawn			
60% SUBMISSION	07/17/09					ALBANY, NEW YORK		MAY 13, 2011		SCY		JRT			
Revisions:	Date													Department of Veterans Affairs	