
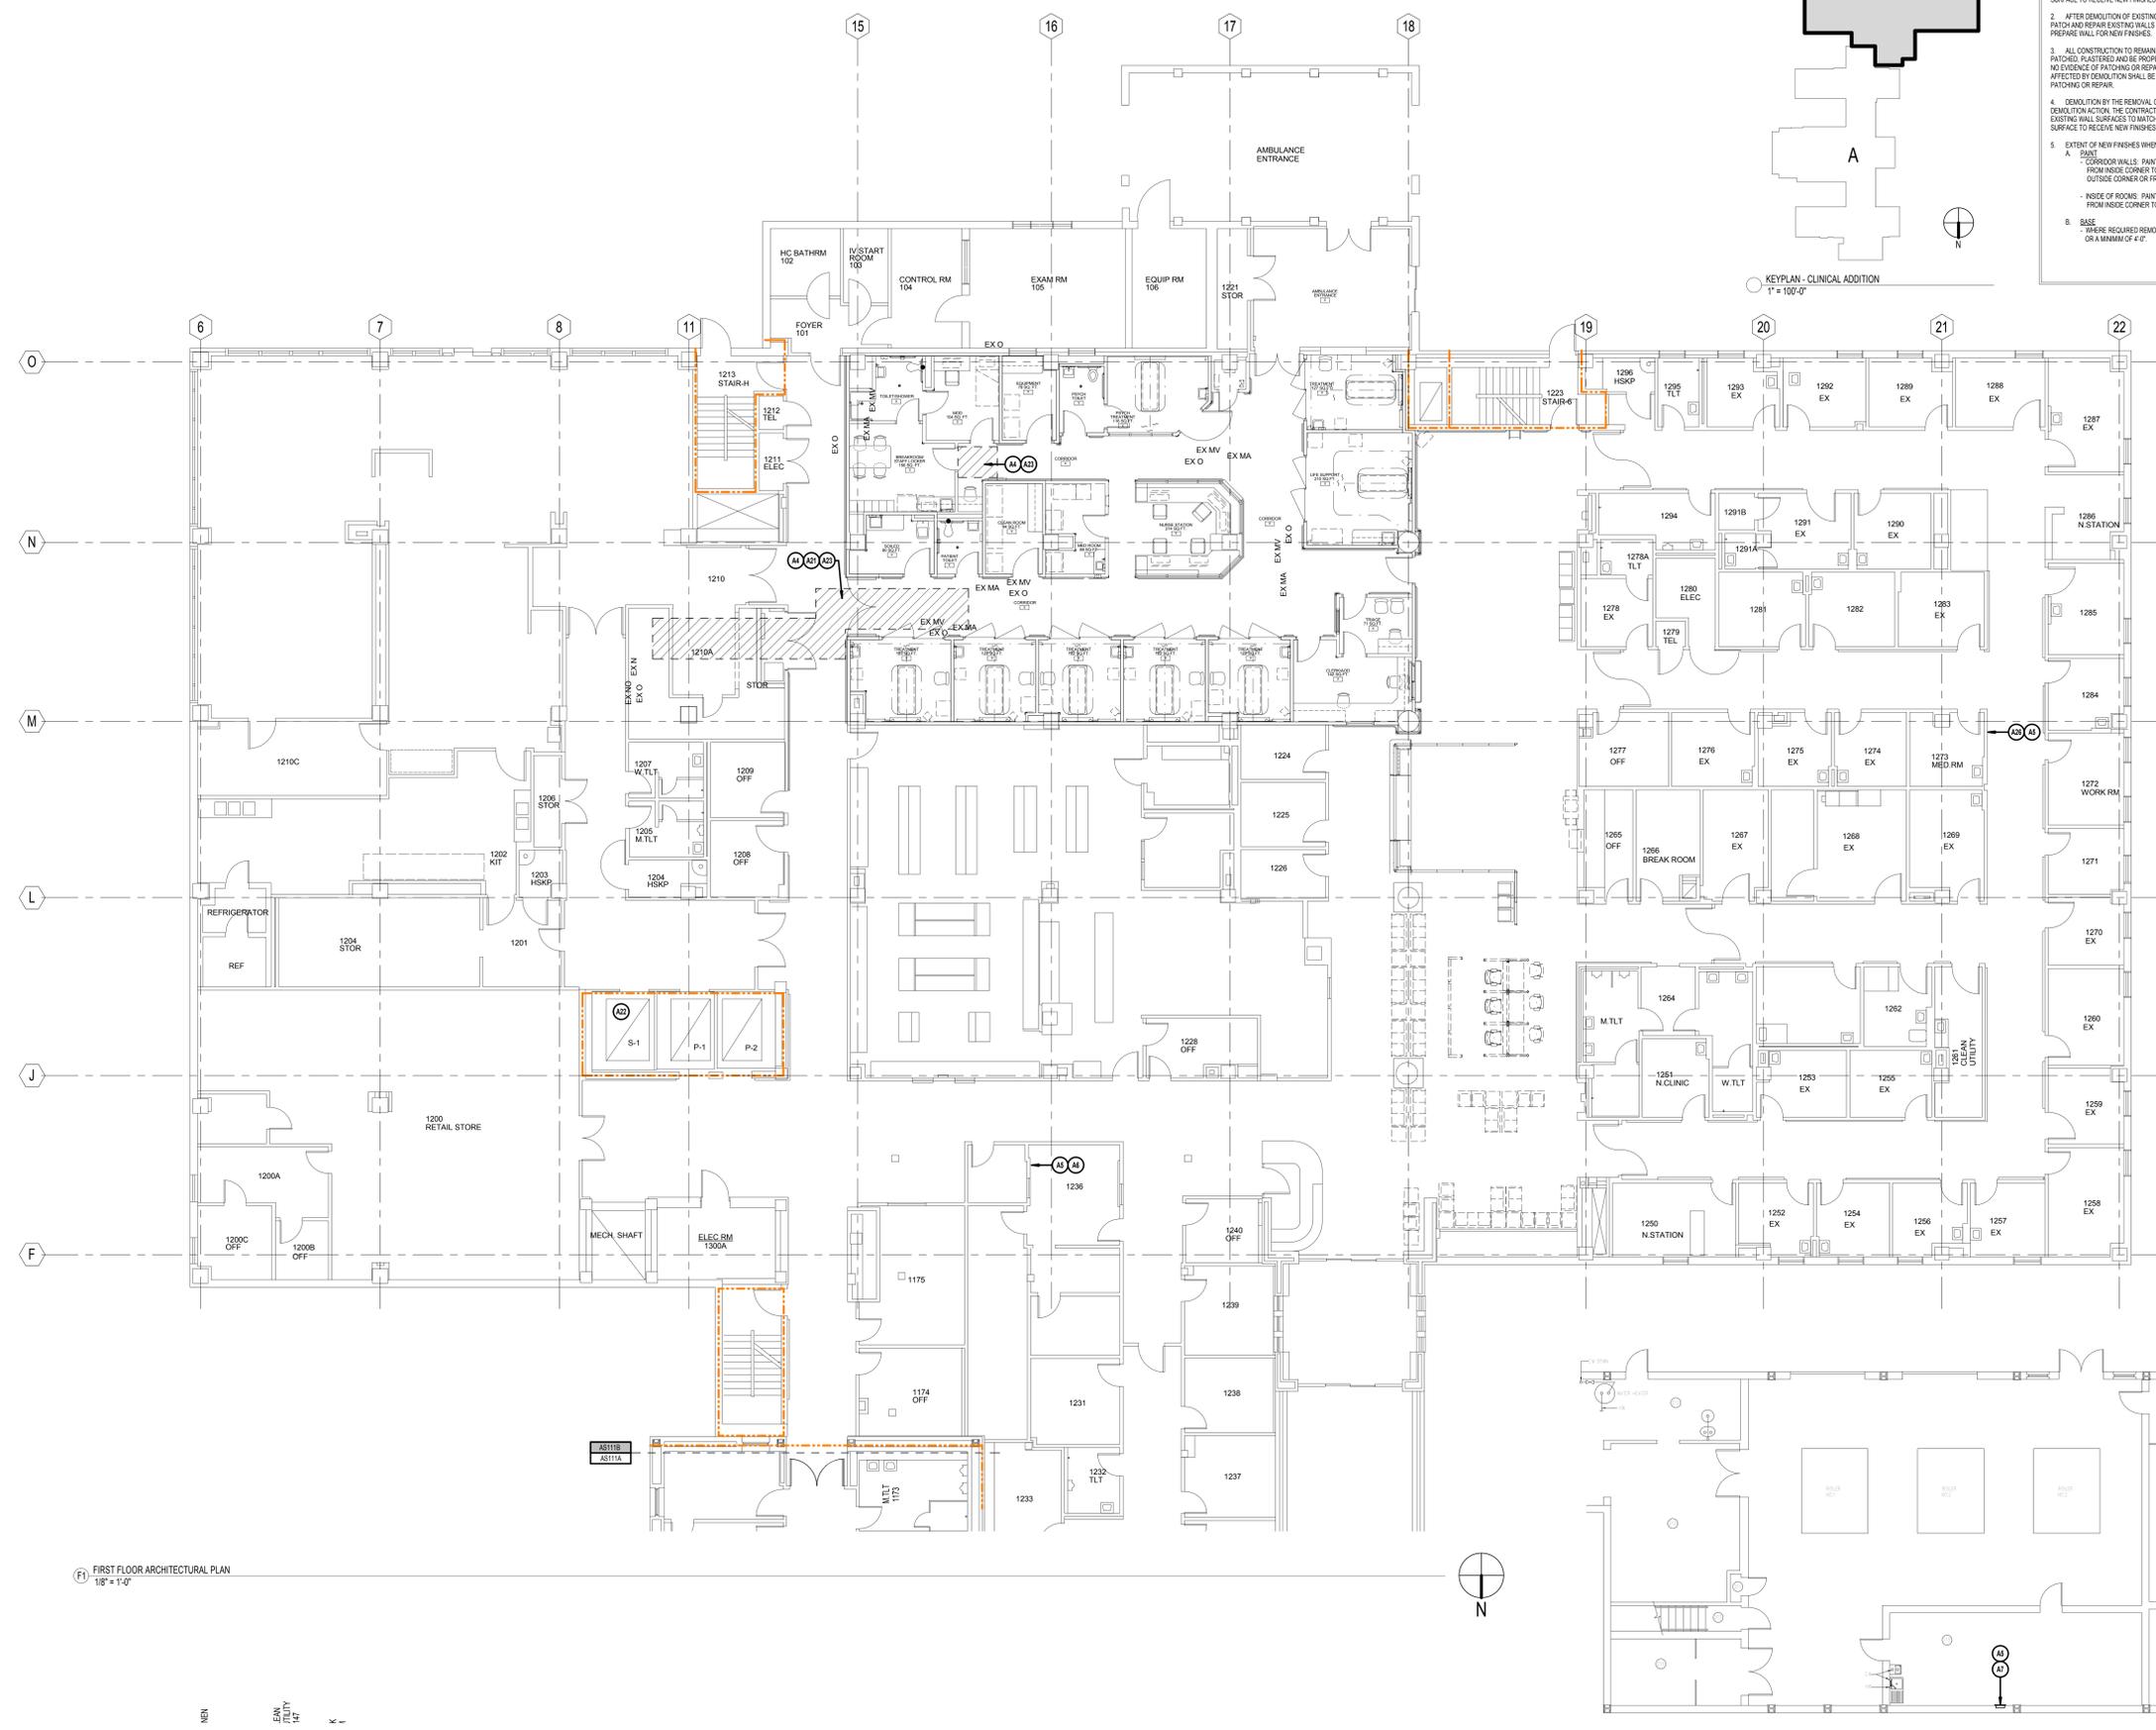


- ### GENERAL CUTTING AND PATCHING NOTES
- WHERE EXISTING EXTERIOR WALL OR INTERIOR PARTITIONS ARE DAMAGED IN AREAS OF SELECTIVE DEMOLITION BY THE REMOVAL OF EXISTING CONSTRUCTION OR ANY OTHER DEMOLITION ACTION, THE CONTRACTOR SHALL BE RESPONSIBLE TO REPAIR EXISTING WALL SURFACES TO MATCH EXISTING OR TO PRODUCE A SMOOTH SURFACE TO RECEIVE NEW FINISHES.
 - AFTER DEMOLITION OF EXISTING M.P.E. WORK, EQUIPMENT AND CASWORK, PATCH AND REPAIR EXISTING WALLS TO MATCH EXISTING CONSTRUCTION AND PREPARE WALL FOR NEW FINISHES.
 - ALL CONSTRUCTION TO REMAIN WHICH IS AFFECTED BY DEMOLITION SHALL BE PATCHED, PLASTERED AND BE PROPERLY REPAIRED AND ADJUSTED AS TO LEAVE NO EVIDENCE OF PATCHING OR REPAIR. ALL ADJACENT FLOORS AND CEILING SO AFFECTED BY DEMOLITION SHALL BE PATCHED SO AS TO LEAVE NO EVIDENCE OF PATCHING OR REPAIR.
 - DEMOLITION BY THE REMOVAL OF EXISTING CONSTRUCTION OR ANY OTHER DEMOLITION ACTION, THE CONTRACTOR SHALL BE RESPONSIBLE TO REPAIR EXISTING WALL SURFACES TO MATCH EXISTING OR TO PRODUCE A SMOOTH SURFACE TO RECEIVE NEW FINISHES.
 - EXTENT OF NEW FINISHES WHEN PATCHING WALLS TO MATCH EXISTING:
 - INTERIOR WALLS: PAINT ENTIRE WALL FROM FLOOR TO CEILING AND FROM INSIDE CORNER TO INSIDE CORNER FROM OUTSIDE CORNER TO OUTSIDE CORNER OR FROM OUTSIDE CORNER TO INSIDE CORNER.
 - INSIDE OF ROOMS: PAINT ENTIRE WALL FROM FLOOR TO CEILING AND FROM INSIDE CORNER TO INSIDE CORNER.

- ### GENERAL NOTES
- SEE SHEET 0202 FOR NOTES PERTAINING TO DEMOLITION, CONTRACTORS RESPONSIBILITIES, AND ARCHITECTURAL GENERAL NOTES.
 - SEE SHEET 0202 FOR PARTITION TYPES AND DETAILS.
 - SEE SHEET 0202 FOR INFECTION CONTROL REQUIREMENTS.
 - SEE SHEETS 0101 THRU 0103 FOR ICRA PLANS.
 - SEE SHEET AS118 FOR MED GAS BOX ELEVATIONS.

- ### ARCHITECTURAL KEYNOTES
- EXISTING WALL HANG SINK TO BE REMOVED. SEE PLUMBING DRAWINGS. PATCH AND REPAIR AREA AS REQUIRED TO RECEIVE FINISHES TO MATCH EXISTING.
 - SAW CUT PORTION OF EXISTING ASPHALT PAVING AND REPLACE WITH 7" THK CONCRETE FINISH. PROVIDE OPENING WITH SLAB TO ACCEPT EXISTING GREASE TRAP LID. SEE DETAILS IN DRAWING AS108 AND SPECIFICATIONS FOR ADDITIONAL INFORMATION.
 - REMOVE PAINTING MARKINGS. COORDINATE WITH COITR FOR DIRECTION. SEE SPECIFICATIONS FOR ADDITIONAL INFORMATION.
 - AREA ABOVE CEILING FOR WHICH SELECTIVE DEMOLITION IS REQUIRED. SEE SPECIFICATIONS SECTION 01729 / 02410 FOR ADDITIONAL INFORMATION.
 - ALL CONSTRUCTION TO REMAIN WHICH IS AFFECTED BY DEMOLITION SHALL BE PATCHED, PLASTERED TO MATCH EXISTING AND ADJUSTED AS TO LEAVE NO EVIDENCE OF PATCHING OR REPAIR.
 - REMOVE EXISTING MED GAS ALARM PANELS. COORDINATE WITH MECHANICAL DRAWINGS.
 - REMOVE PORTION OF EXISTING WALL AS REQUIRED TO ACCOMMODATE NEW WORK. SEE MECHANICAL, ELECTRICAL, AND PLUMBING DRAWINGS.
 - EXISTING MED GAS VALVE PANEL TO BE REMOVED. COORDINATE LOCATIONS WITH PLUMBING DRAWINGS. PATCH AND REPAIR EXISTING WALL TO RECEIVE NEW FINISHES.
 - REMOVE EXISTING MEDICAL GAS OUTLETS AND CAP EXISTING MED GAS LINES. REFER TO MEP DRAWINGS.
 - CONTRACTOR TO CUT OPENING IN EXISTING FFIRM ROOF AND CONCRETE ROOF SYSTEM AS PER CUTTING AND PATCHING SPECIFICATION SECTION AS REQUIRED TO INSTALL NEW MEDICAL AIR INTAKE. PATCH AND REPAIR ROOF TO PROVIDE A WATERPROOF SEAL AND TO BE COMPATIBLE WITH EXISTING STRUCTURE. COORDINATE WITH COITR. SEE MECHANICAL, ELECTRICAL, AND PLUMBING DRAWINGS.
 - REMOVE EXISTING OXYGEN MANIFOLD AND ASSOCIATED PIPING. PATCH AND REPAIR WALL AS REQUIRED TO RECEIVE NEW FINISHES.
 - PROVIDE METAL ENCLOSURE TO 8" R.F.F. AROUND NEW MEDICAL GAS PIPING.
 - REMOVE EXISTING ACoustICAL CEILING SYSTEM IN ITS ENTIRETY. SALVAGE EXISTING LIGHTING FIXTURES AND CEILING MOUNTED EQUIPMENT. UPON REMOVAL OF MEDICAL GAS WORK, INSTALL NEW ACT AT 7'-10" AFF. EXTEND DUCTWORK AND SPRINKLER LINES AS REQUIRED.
 - PROVIDE 4" THICK HOUSEKEEPING PAD, 3000 PSI CONCRETE TO BE INSTALLED PER AC STANDARDS. PAD SHALL BE 6" LARGER IN BOTH DIRECTIONS. COORDINATE SIZE WITH PURCHASED EQUIPMENT.
 - REMOVE PORTION OF EXISTING WALL AS REQUIRED TO INSTALL NEW MED GAS. SEE DETAIL IN DRAWING AS118 AND PLUMBING DRAWINGS.
 - SAW CUT PORTION OF EXISTING WALL AS REQUIRED TO INSTALL NEW MEDICAL GAS PIPING. PROVIDE FIRE SEALANT AT WALL PENETRATION. RATING TO MATCH ADJACENT WALL.
 - NEW ELECTRICAL PANEL. SEE ELECTRICAL DRAWINGS.
 - REMOVE EXISTING EMERGENCY OXYGEN CONNECTION. SEE PLUMBING DRAWINGS. PATCH AND REPAIR EXTERIOR WALL AS REQUIRED TO MATCH EXISTING.
 - SAW CUT EXISTING EXTERIOR WALL AS REQUIRED TO INSTALL NEW EMERGENCY OXYGEN CONNECTION. SEE PLUMBING DRAWINGS.
 - CONTRACTOR IS RESPONSIBLE TO PATCH AND REPAIR PENETRATIONS RESULTING FROM THE REMOVAL AND/OR DEMOLITION OF ABOVE CEILING MEDICAL GAS PIPING IN A MANNER TO MATCH EXISTING ADJACENT CONDITIONS AND TO ENSURE CONTINUITY OF FIRE RATING REQUIREMENTS WHERE APPLICABLE.
 - CONTRACTOR IS RESPONSIBLE TO SEAL PENETRATIONS RESULTING FROM THE INSTALLATION OF NEW ABOVE CEILING PIPING IN A MANNER TO MATCH EXISTING ADJACENT CONDITIONS AND TO ENSURE CONTINUITY OF FIRE RATING REQUIREMENTS WHERE APPLICABLE.
 - SERVICE ELEVATOR TO BE USED FOR TRASH REMOVAL AND MATERIAL TRANSPORTATION. CONTRACTOR TO COORDINATE WITH COITR AND SPECIFICATIONS FOR PROCEDURES AND REQUIREMENTS.
 - WORK TO BE PERFORMED AFTER-HOURS. COORDINATE WITH COITR AND USER.
 - EXISTING MED GAS OUTLET TO BE REMOVED AND REPLACED WITH NEW MED GAS OUTLET. SEE PLUMBING DRAWINGS.
 - REMOVE EXISTING MED GAS VALVE PANEL AND PREPARE OPENING AS REQUIRED TO RECEIVE NEW MED GAS VALVE PANEL. SEE PLUMBING DRAWINGS.
 - REMOVE PORTION OF EXISTING WALL AS REQUIRED TO INSTALL NEW MED GAS PRESSURE GAUGE BOX. SEE DETAIL IN DRAWING AS118 AND PLUMBING DRAWINGS.
 - PROVIDE WALL ENCLOSURE TO CONCEAL NEW VACUUM EXHAUST PIPING.
 - PROVIDE 4" WIDE 14 GA. STAINLESS STEEL ENCLOSURE AROUND EXISTING PIPE ALLOW FOR 1/2" GAP BETWEEN BOTTOM OF ENCLOSURE AND GROUND. FASTEN TO EXISTING EXTERIOR WALL WITH STAINLESS STEEL BOLTS.
 - EXISTING ASPHALT PAVING TO REMAIN.
 - EXISTING RAMP TO REMAIN.
 - EXISTING CONCRETE SIDEWALK TO REMAIN.
 - EXISTING GREASE TRAP LID TO BE REMOVED AND REINSTALLED. MODIFY MP OF GREASE TRAP AS REQUIRED TO BE INSTALLED IN NEW CONCRETE PAVING.
 - EXTEND EXISTING CONCRETE PAD AS REQUIRED TO ACCOMMODATE NEW EQUIPMENT. CONCRETE TO BE 3000 PSI AND SHALL BE INSTALLED PER AC STANDARDS. COORDINATE SIZE WITH PURCHASED UNIT.
- NOTE: ALL DEMOLITION AND PATCHING WORK TO BE PERFORMED IN ACCORDANCE WITH SPECIFICATIONS SECTION 01700, CUTTING AND PATCHING AND SECTION 01000, DEMOLITION.

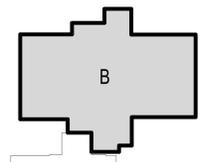

F FIRST FLOOR ARCHITECTURAL PLAN
1/8" = 1'-0"

F7 PARTIAL BOILER PLANT FLOOR PLAN
1/8" = 1'-0"

100% CONSTRUCTION DOCUMENTS

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Project Number: 3439.02
 Scale: As indicated
 Drawing Title: FIRST FLOOR ARCHITECTURAL & DEMOLITION PLAN
 Approved: Project Director

Project Title: LAJ VA CLARKSBURG MEDICAL UPGRADE
 Location: 1 Med Center Drive, Clarksburg, WV
 Date: 07/20/2012
 Checked: EBC
 Drawn: EN

VA Project Number: VA244-P-1491
 Building Number: 02
 Drawing Number: AS111B
 Dwg. 6 of 41
 Office of Facilities Management
 Department of Veterans Affairs

Revisions	Date