


Revisions

Revision	Date

CONSULTANTS:

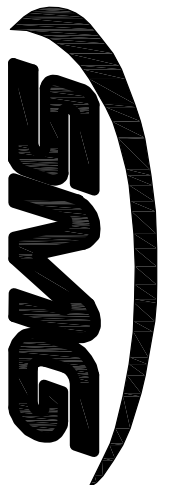


Smith Management Group

1405 Mercer Road Lexington, KY 40511

1860 B Williamson Court Louisville, KY 40223

www.smithmange.com

ARCHITECT/ENGINEERS:

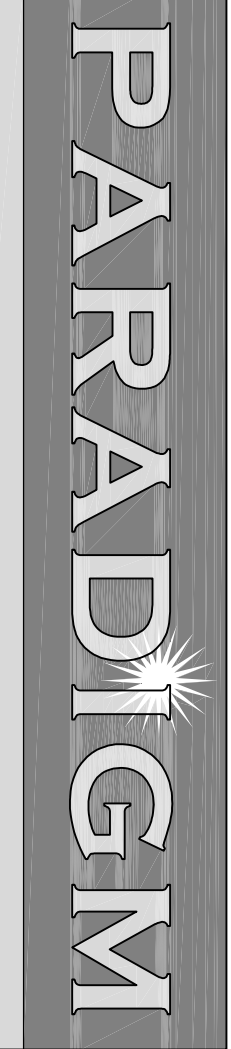

ENGINEERS AND CONSTRUCTORS

Pd Box 43623 Louisville, Kentucky 40251 - Ph: 502.339.8511 - www.paradigmus.com

Drawing Title:
PINGING AND FLOOR TILE / MASTIC
ASBESTOS ABATEMENT PLAN

Project Title:
SURGICAL SUPPORT AND LOCKERS

Building Number:
1

Drawing Number:
1-ASB2

Location:
OWA CITY VAMC

Date:
07-15-12

Checked:
KLP

Drawn:
JEM

Project Number:
606A8-11-011

Office of
Construction
and Facilities
Management

Department of
Veterans Affairs

ASBESTOS ABATEMENT PLAN

1/8" = 1'-0"

1


1/8"


KEY PLAN

NOT TO SCALE

FULLY SPRINKLERED BUILDING

BID DOCUMENTS

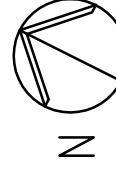

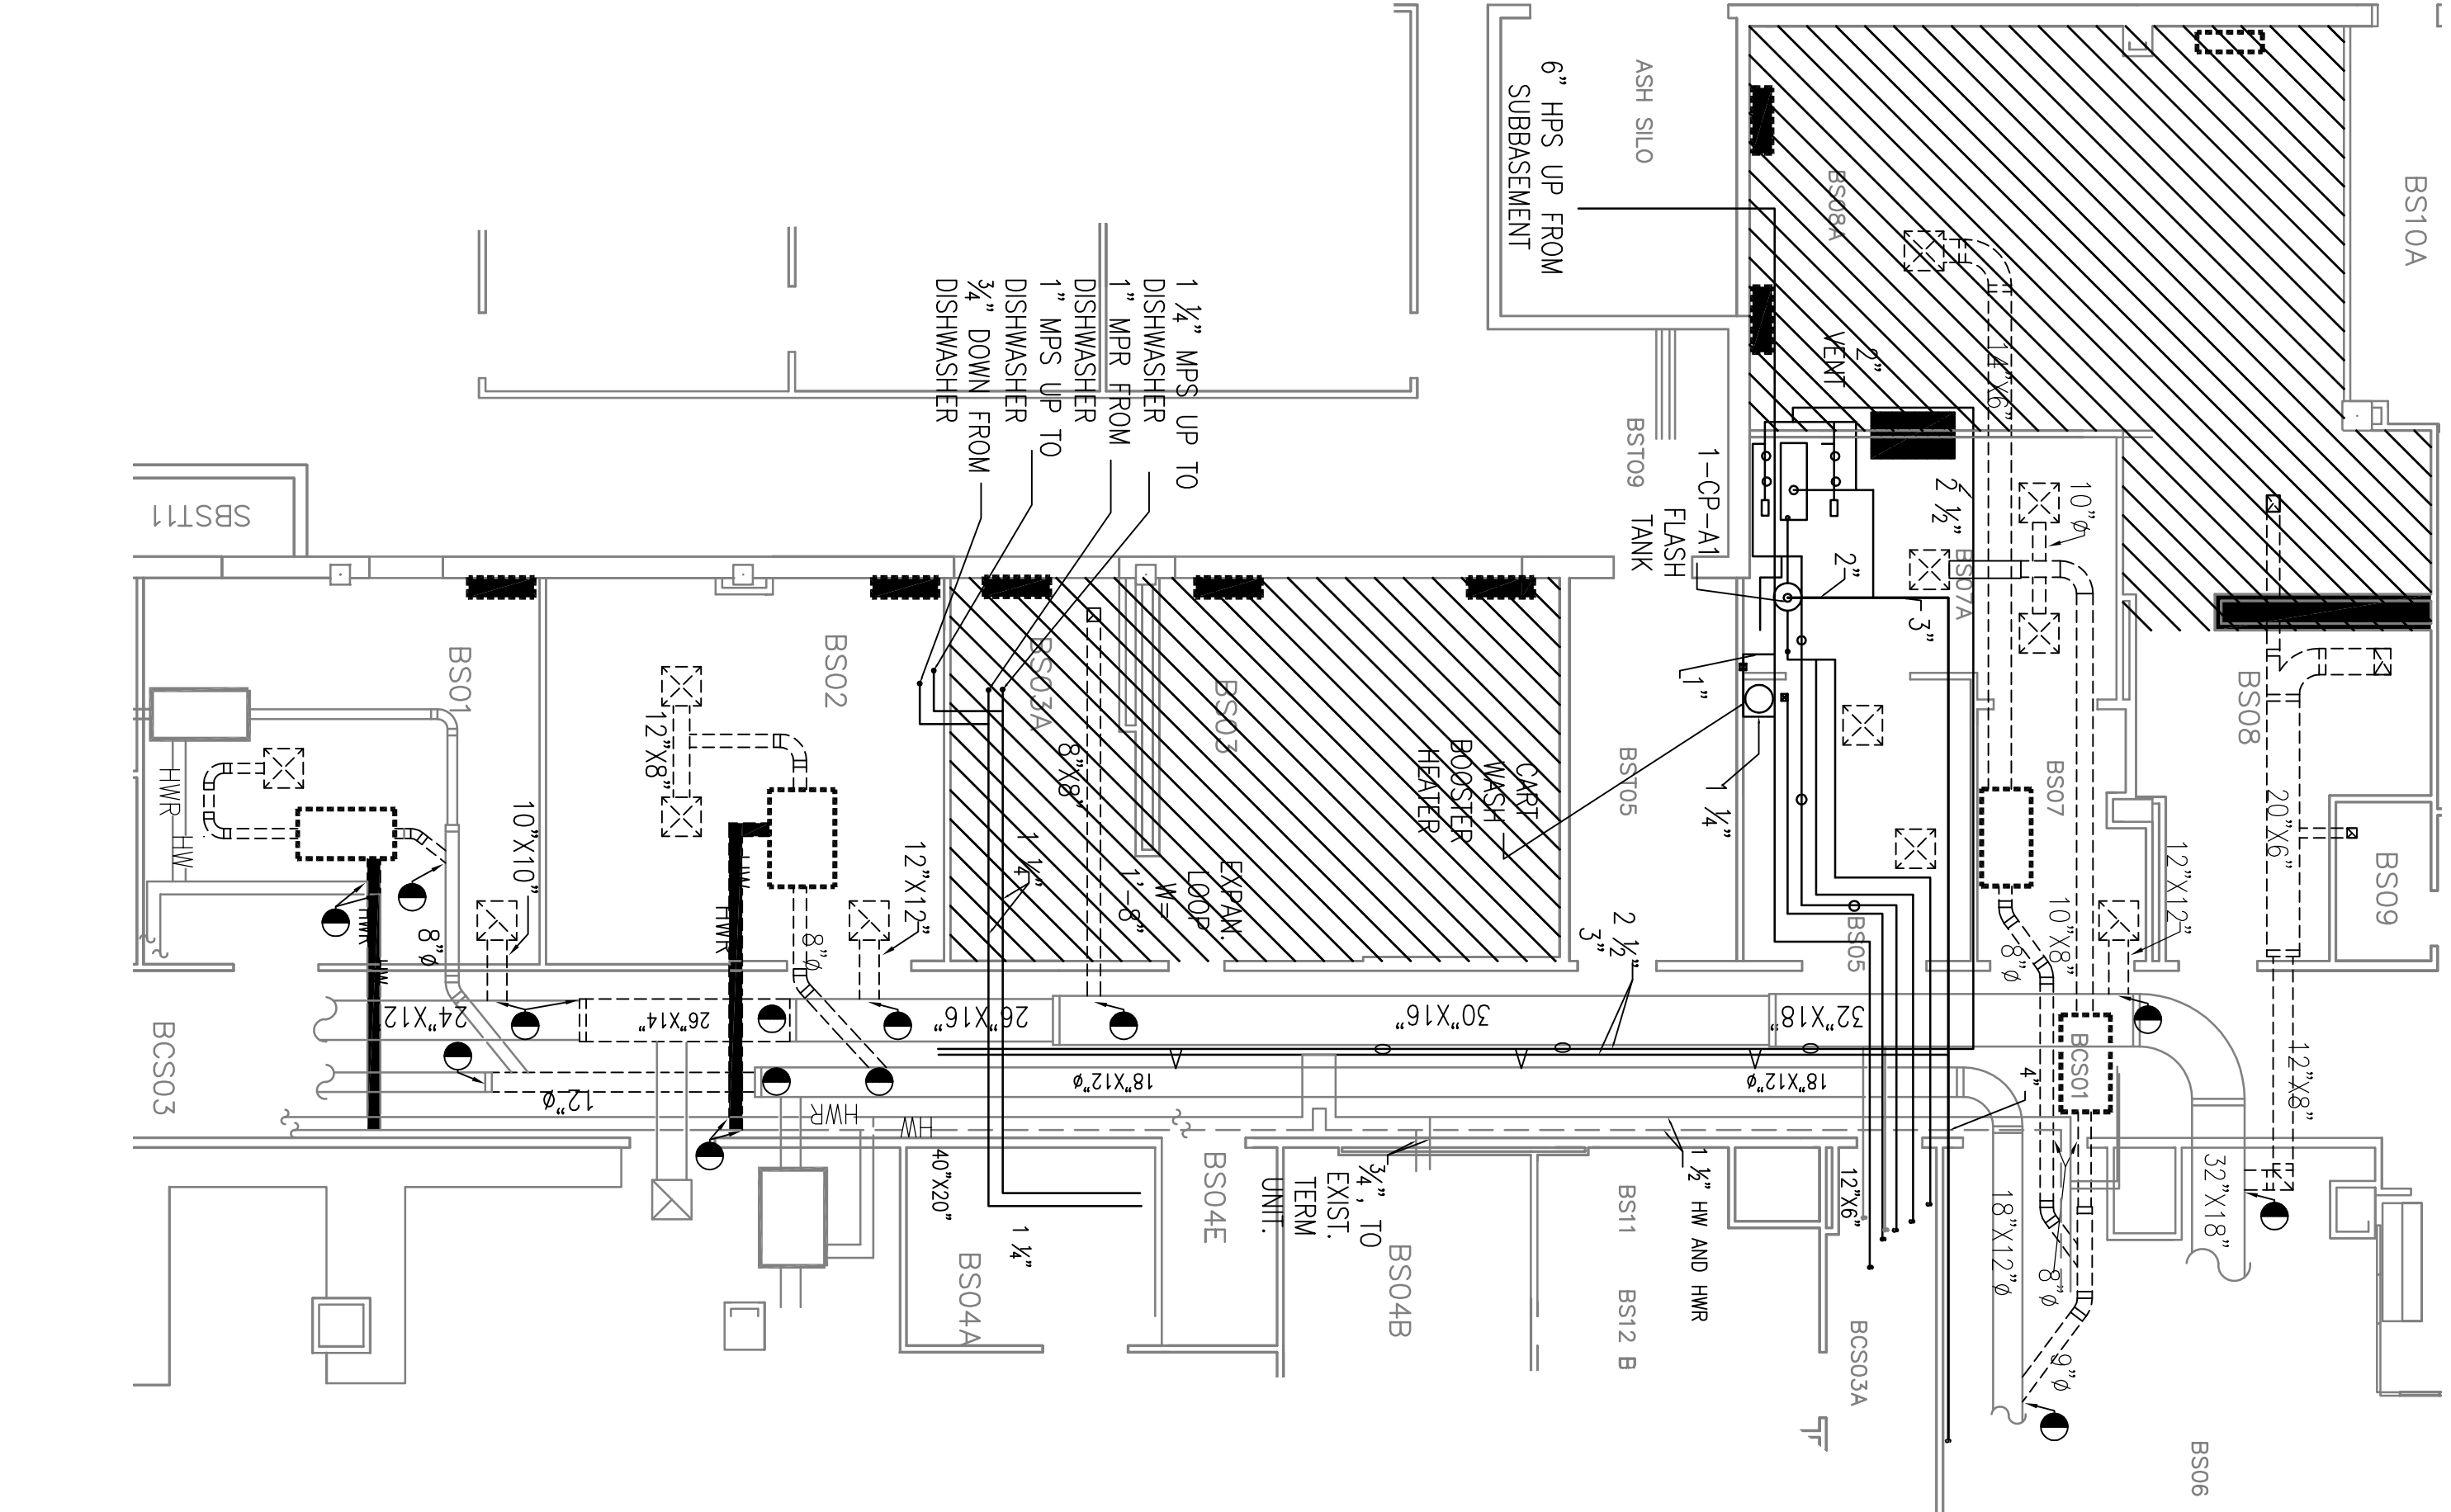


CLASS II NON-FRIABLE ASBESTOS ABATEMENT


Remove and dispose of approximately 390 square feet of asbestos-containing 12"x12" Gray Floor Tile and associated mastic on non-FRPS as indicated on the drawing and according to project specifications. FRPS AND NON-FRPS ARE BOTH CLASS II ASBESTOS-CONTAINING MATERIALS. REMOVE APPROXIMATELY 390 SQUARE FEET OF ASBESTOS-CONTAINING MASTIC FROM ROOM BS08 AS INDICATED ON THE DRAWING AND ACCORDING TO PROJECT SPECIFICATIONS.


ASBESTOS ABATEMENT NOTES (FLOOR TILE):


1. Remove and dispose of asbestos-containing floor tile and mastic to be abated. The abatement contractor shall provide a unit price per square foot in addition to base bid and shall field verify existing conditions and established abatement with the VA and Construction Management Team.


ASBESTOS ABATEMENT LEGEND:


 Asbestos-Containing Floor Tile and Mastic Location


- SYMBOLS/EQUIPMENT LEGEND
-  LIMIT OF DEMOLITION

 EXISTING UNIT TO REMAIN

 EXISTING UNIT TO BE DEMOLISHED

 EXISTING HEATING WATER SUPPLY

 EXISTING HEATING WATER RETURN

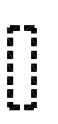 EXISTING RADIATOR TO BE DEMOLISHED

GENERAL NOTE:

ALL EXISTING PIPING, DUCTWORK, SPRINKLERS, CONDUIT, LIGHTING OR OTHER CONSTRUCTION SHALL BE RELOCATED AS NECESSARY FOR ALL DEMOLITION AND INSTALLATION WORK.

- GENERAL NOTES
1. ALL MECHANICAL DEMOLITION WILL BE COORDINATED WITH NEW CONSTRUCTION. THE MAINTENANCE OF EXISTING SERVICE IN THOSE UTILITIES NOT TO BE DEMOLISHED UNTIL THE LATEST POSSIBLE TIME, AND WITH THE CONSTRUCTION PHASING SHEET/NOTES. COORDINATE EXACT PHASING OF ALL WORK WITH CONSTRUCTION MANAGER.

2. MECHANICAL CONTRACTOR SHALL VISIT AND EXAMINE THE SITE PRIOR TO SUBMITTING BID TO BECOME FAMILIAR WITH SITE, STAFF AND EXISTING CONDITIONS, AND TO DETERMINE THE SCOPE OF MECHANICAL DEMOLITION WORK.

3. COORDINATE ALL WORK WITH EXISTING CONDITIONS, ALL OTHER TRADES, AND IN ACCORDANCE WITH ALL STATE, LOCAL AND NATIONAL CODES, AS WELL AS WITH ALL FEDERAL HEALTH CARE REGULATIONS.

4. CONTRACTOR SHALL BE RESPONSIBLE FOR ALL FEES, PERMITS AND LICENSES FOR THE COMPLETE INSTALLATION OF THEIR WORK.

5. CARE SHOULD BE TAKEN BY ALL CONTRIBUTORS TO AVOID DAMAGING OR DISTURBING EXISTING CONSTRUCTION WHICH IS TO REMAIN. CONTRACTORS SHALL BE RESPONSIBLE FOR ANY DAMAGE TO EXISTING CONSTRUCTION AND SHALL BE RESPONSIBLE FOR REPAIRING AND RESTORE EXISTING CONSTRUCTION TO UNDISTURBED STATE UPON COMPLETION OF WORK AT NO EXPENSE TO OWNER.

6. ALL CONTRIBUTORS SHALL THOROUGHLY FAMILIARIZE THEMSELVES WITH ALL ENGINEERING AND PHASING DRAWINGS AND DETAILS PRIOR TO BEGINNING CONSTRUCTION FOR COORDINATION OF ALL DEMOLITION WORK FOR EACH RESPECTIVE TRADE.

7. UNLESS NOTED, OTHERWISE SHOWN OR SPECIFIED, ALL MATERIALS AND EQUIPMENT REMOVED OR DEMOLISHED (EXCEPT THAT WHICH IS TO BE SALVAGED OR RELOCATED) AS DIRECTED BY DRAWINGS AND SPECIFICATIONS SHALL BECOME THE PROPERTY OF THE CONTRACTOR AND SHALL BE DISPOSED OF LEGALLY.

8. CONTRACTOR SHALL GIVE A MINIMUM NOTICE OF FIVE (5) DAYS NOTICE TO VA CORP PRIOR TO SHUTDOWN OF ANY EXISTING UTILITIES.

9. MECHANICAL CONTRACTOR SHALL REMOVE CW AND HWV PIPING, AND DUCTWORK AS REQUIRED TO CONTINUE SERVICE TO ALL UNITS TO REMAIN AND DISCONNECTED FROM SERVICE BY DEMOLITION.

10. REFER TO DEMOLITION DRAWINGS OF OTHER TRADES FOR ADDITIONAL WORK REQUIRED.

11. REFER TO ELECTRICAL DEMOLITION PLANS FOR EXTENT OF ELECTRICAL EQUIPMENT, LIGHTING, ETC. BEING REMOVED. REMOVE ALL ELECTRICAL WORK ASSOCIATED WITH MECHANICAL EQUIPMENT AS NOTED ON ELECTRICAL PLANS.

12. CONTRACTOR SHALL COORDINATE WITH VA CORP BEFORE SECURITY/ACCESS SYSTEM IS DISMANTLED FOR ANY REASON OR LENGTH OF TIME.

13. CONTRACTOR SHALL BE RESPONSIBLE FOR REMOVING ANY ABANDONED MECHANICAL/PIPING EQUIPMENT AND UTILITIES NOT SHOWN ON THIS DRAWING AND ANY OTHER MECHANICAL DEMOLITION INCIDENTAL TO NEW WORK.

14. CONTRACTOR SHALL BE RESPONSIBLE FOR REPAIRING ANY FIRE-PROTECTING/STOPPING MATERIAL, DAMAGED, DISTURBED, OR REMOVED DURING THIS WORK.

15. CONTRACTOR SHALL BE RESPONSIBLE FOR REPAIRING ANY ARCHITECTURAL WORK (INCLUDING, BUT NOT LIMITED TO: FLOORING, CEILING, TILE AND GRID, SMOKE PARTITIONS ABOVE CEILING, Gypsum WALL BOARD AND PAINTING, PLASTER, ETC.) THAT IS DAMAGED, DISTURBED, OR REMOVED INCIDENTAL TO THIS WORK.

16. SOME DUCTWORK, AIR HANDLERS, PIPING, AND AIR TERMINAL UNITS ARE LOCATED IN ATTIC SPACES.

17. CONTRACTOR SHALL BE RESPONSIBLE FOR PROVIDING TEMPORARY COOLING TO ANY SPACE AFFECTED BY DEMOLITION OR NEW WORK, AS WELL AS WITH NEGATIVE AIR CAPABILITY.

18. CONTRACTOR SHALL BE RESPONSIBLE FOR ANY AND ALL ASBESTOS ABATEMENT RELATED TO DEMOLITION OR NEW WORK.

19. PER SPECIFICATIONS, CONTRACTOR SHALL BE RESPONSIBLE FOR PERFORMANCE TEST AND BALANCE WORK TO MEAS OUTSIDE OF THIS SCOPE (BUT INCLUDING DEMOLITION OR NEW TRADE WORK), AND FOR RETURNING THOSE AREAS TO THEIR PRE-WORK FLOW RATES AFTER ALL NEW WORK HAS BEEN COMPLETED.