


UPGRADE FIBER BACKBONE

PROJECT NO. 568-13-113

one eighth inch = one foot
 one quarter inch = one foot
 one half inch = one foot
 three eighths inch = one foot
 three quarters inch = one foot
 one inch = one foot
 one and one half inches = one foot
 three inches = one foot

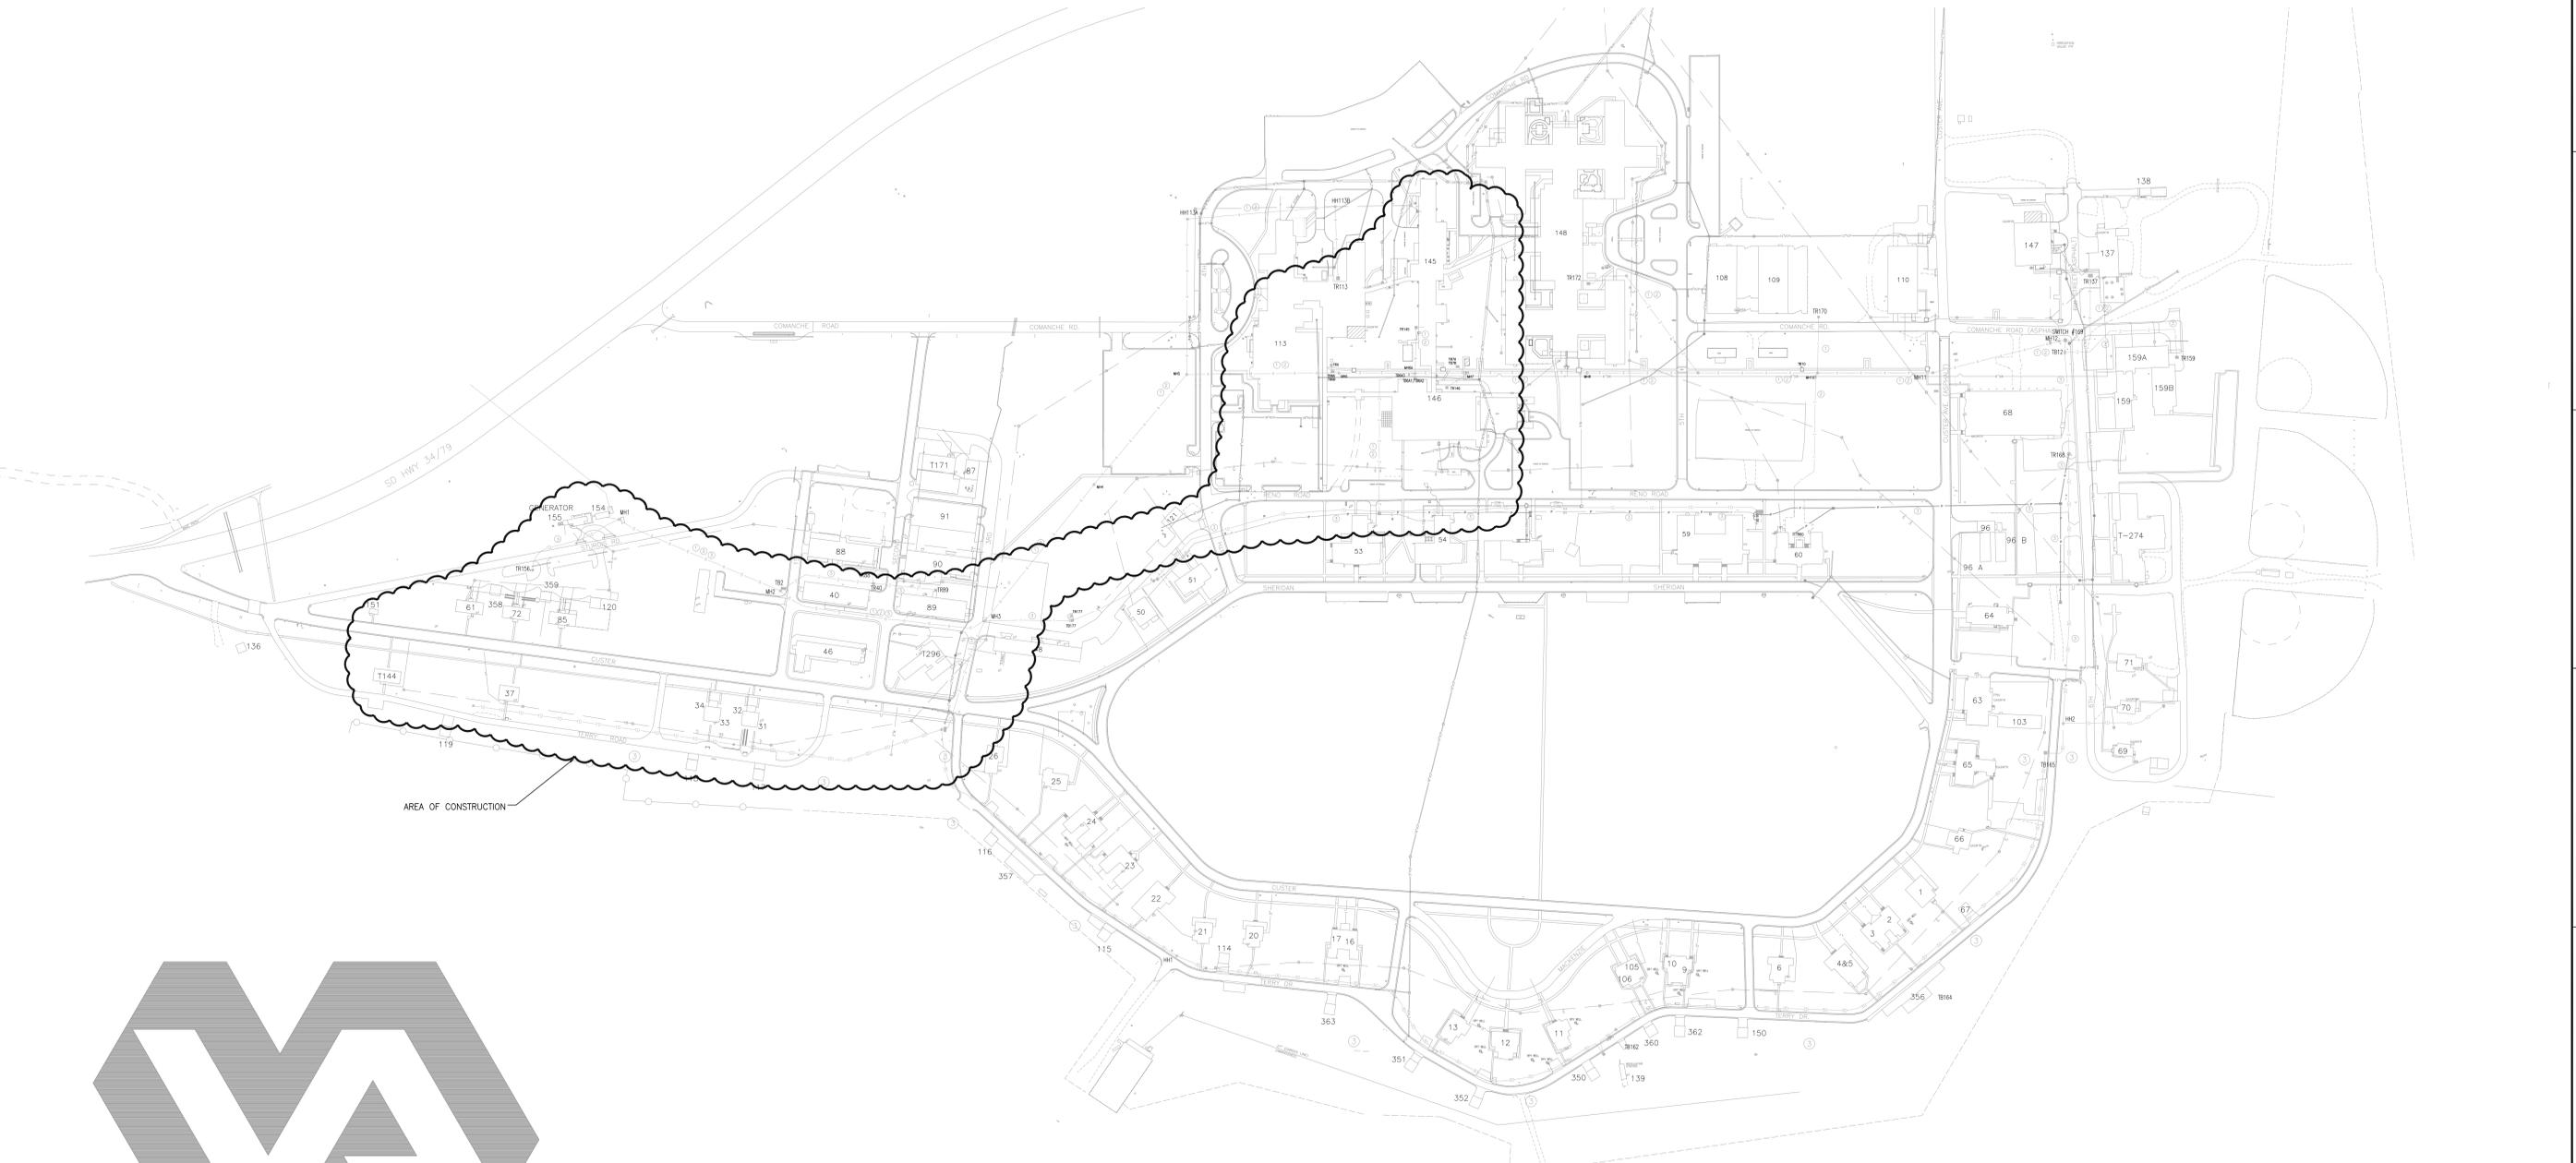

V.A. MEDICAL CENTER


FT. MEADE, S.D.

SHEET INDEX			
E-001	OVERALL SITE PLAN		
E-101	BUILDING 89, 144, 154 - ELECTRICAL PLANS		
E-102	BUILDING 145 CRAWL SPACE - ELECTRICAL PLAN		
E-103	BUILDING 113 BASEMENT LEVEL - ELECTRICAL PLAN		
ES101	ELECTRICAL SITE PLAN - WEST		
ES102	ELECTRICAL SITE PLAN - EAST		
E-601	RISER DIAGRAMS		

PLAN NORTH
F1 OVERALL SITE PLAN
 SCALE: 1" = 150'-0"

Revisions	Date

CONSULTANTS:

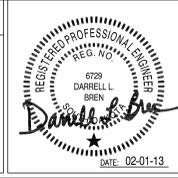

ARCHITECT/ENGINEERS:



TSP, Inc.
 1112 N. West Ave.
 Sioux Falls, SD 57104
 phone: (605) 336-1160
 fax: (605) 336-7926
 www.teamtsp.com
 TSP PROJECT #04121145

To Solve. To Excel. Together.

Drawing Title OVERALL SITE PLAN
Approved Project Director


Project Title UPGRADE FIBER BACKBONE
Location FORT MEADE, SD
Date 02-01-13
Checked DLB
Drawn JNK

Project Number 568-13-113
Building Number CAMPUS
Drawing Number E-001
Dwg 1 of 7

Office of
 Construction
 and Facilities
 Management



three inches = one foot
 one and one half inches = one foot
 one inch = one foot
 three quarters inch = one foot
 one half inch = one foot
 three eighths inch = one foot
 one quarter inch = one foot
 one eighth inch = one foot
 one eighth inch = one foot

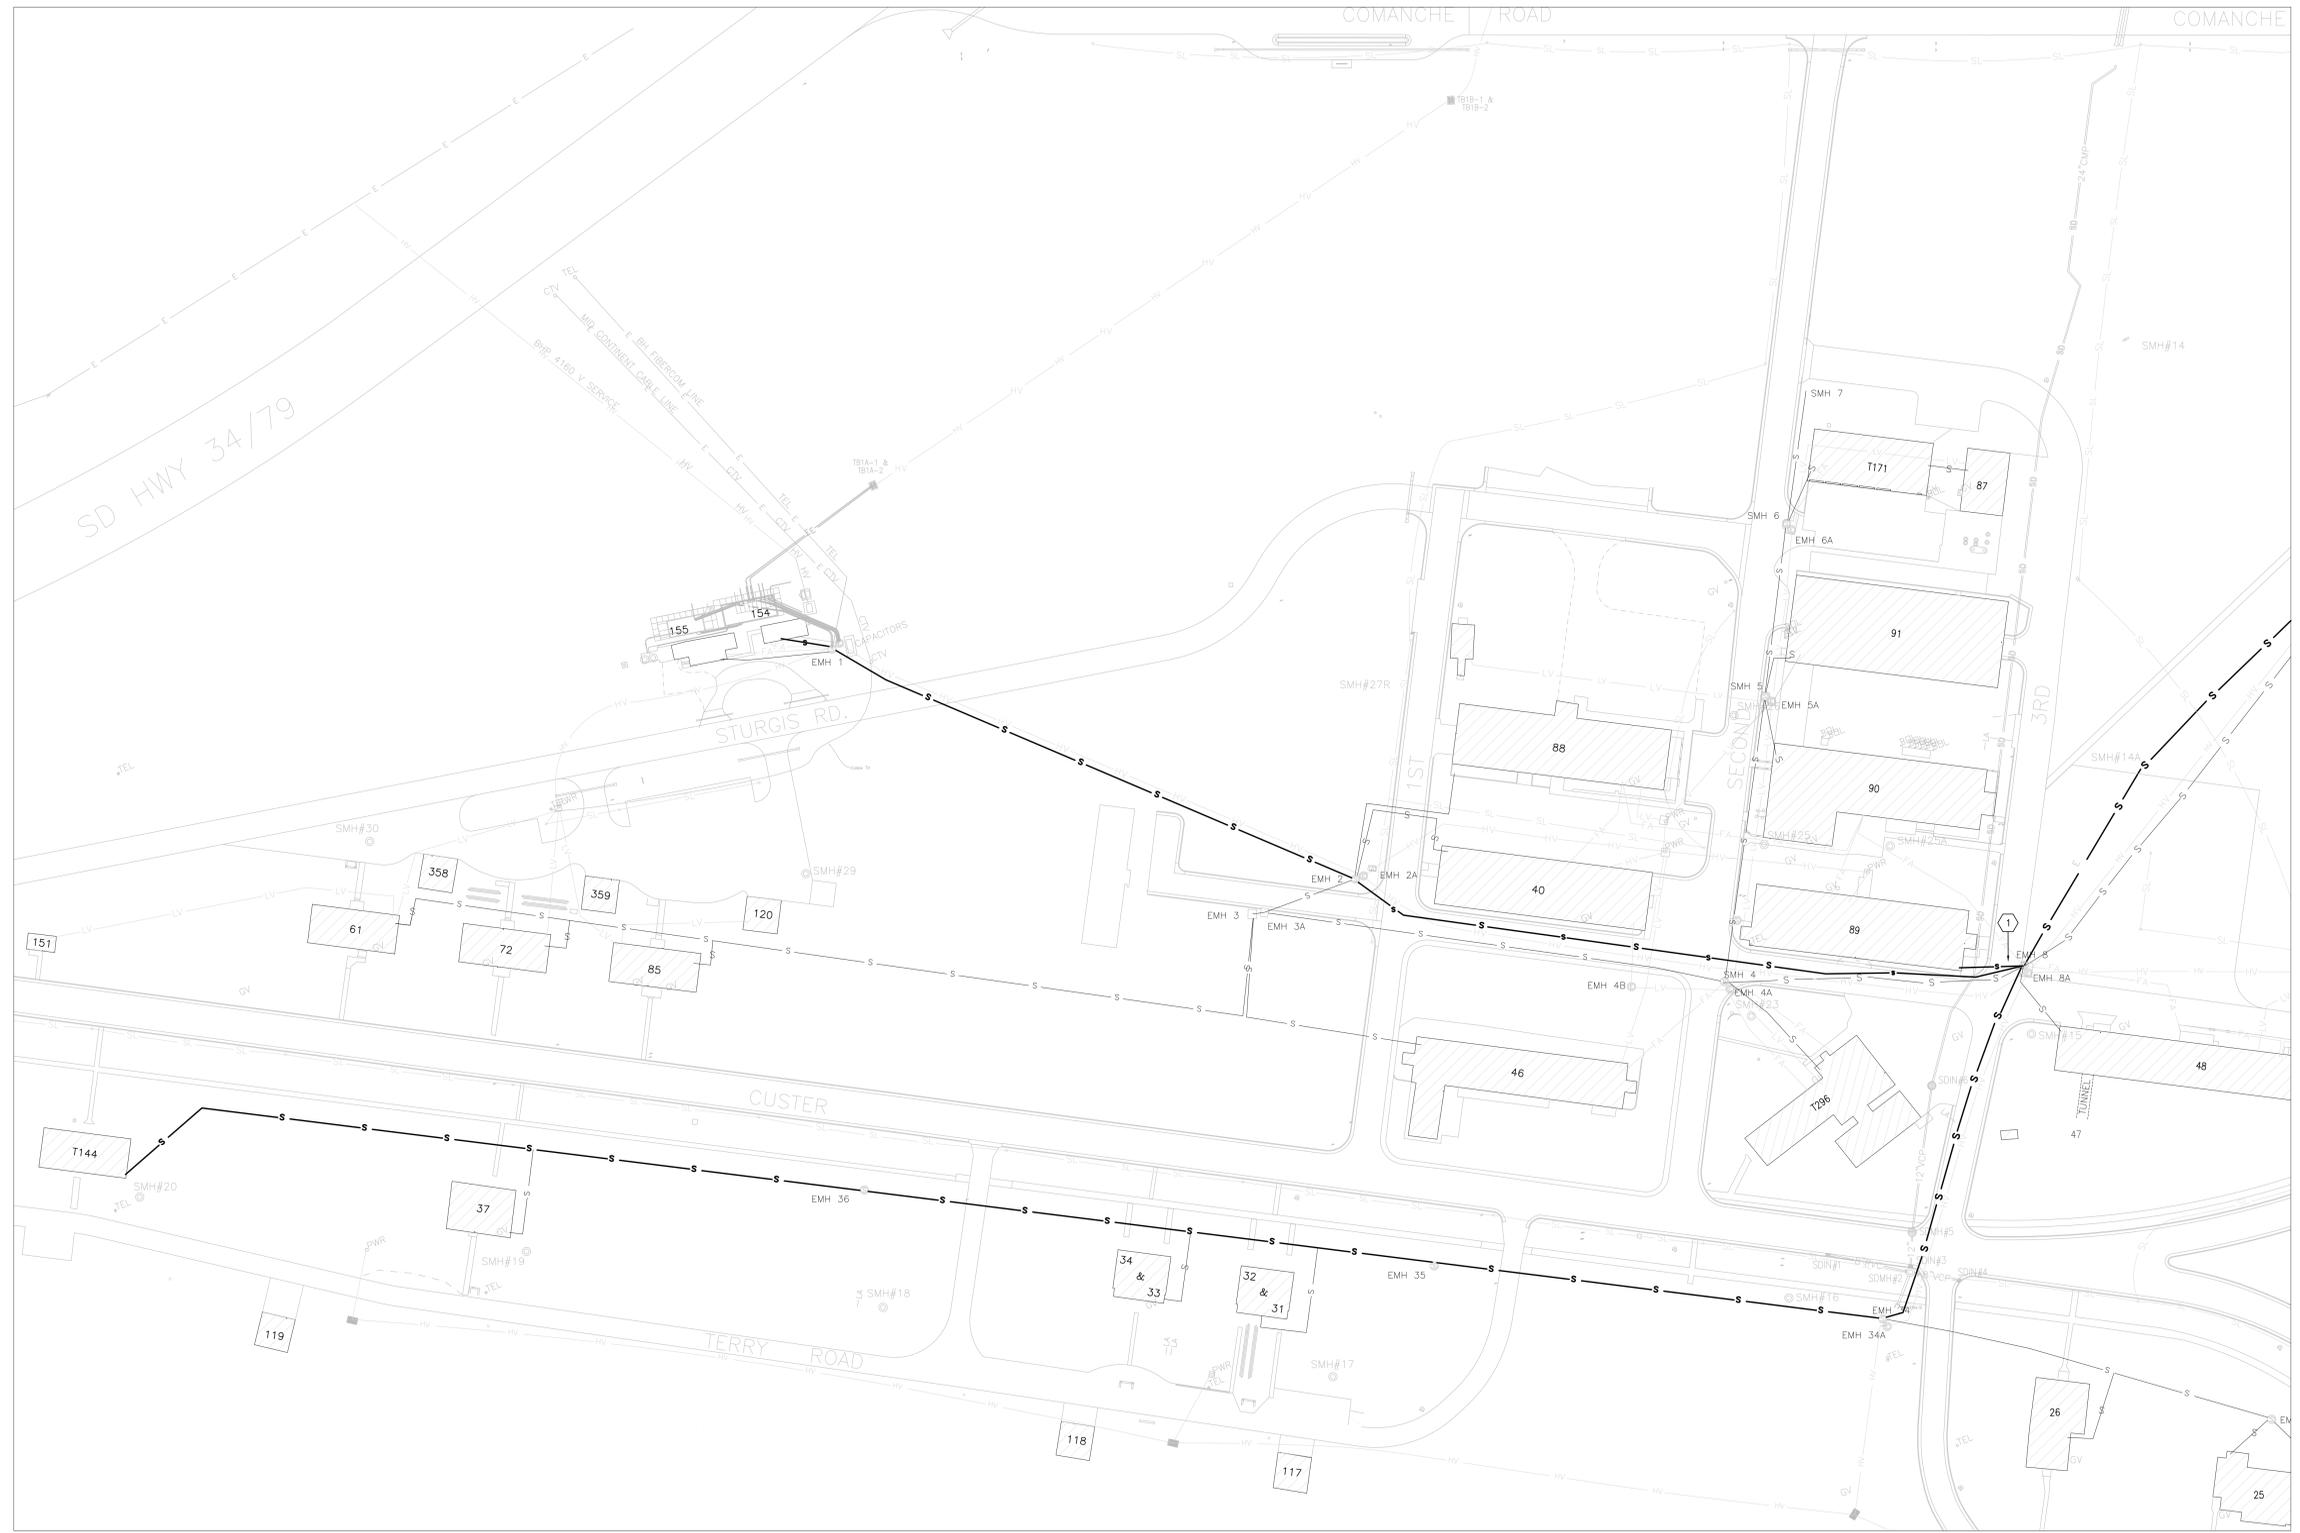


SHEET GENERAL NOTES

- THIS PLAN SHOWS THE ROUTING OF THE FIBER THROUGH THE MANHOLES AND DUCT BANKS. SEE RISER DIAGRAMS AND BUILDING PLANS.
- CONTRACTOR SHALL FIELD VERIFY ALL EXISTING CONDUITS, EXISTING MATERIALS TYPES (FOR PATCHING), AND LENGTHS/DIMENSIONS OF ALL MATERIALS BEFORE SUBMITTING A BID.

SHEET KEYNOTES

- CUT AND PATCH STREET, CURB, AND AREA FOR INSTALLATION OF NEW CONDUITS FROM EMH-8 TO EAST SIDE OF BUILDING 89. SEE DETAIL 1D ON E-101 FOR FURTHER INFORMATION.

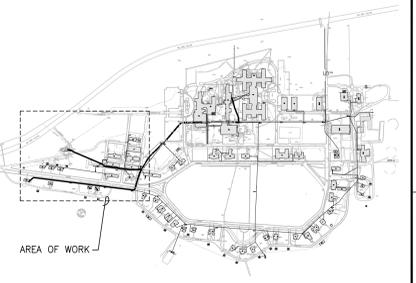


1D ELECTRICAL SITE PLAN - WEST
 SCALE: 1" = 50'-0"

9D KEY PLAN
 SCALE: NO SCALE

Revisions	Date

CONSULTANTS:

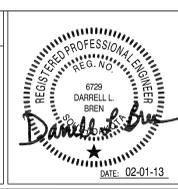

ARCHITECT/ENGINEERS:

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 TSP PROJECT #04121145

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Drawing Title
ELECTRICAL SITE PLAN - WEST

Approved Project Director

Project Title
UPGRADE FIBER BACKBONE

Location
FORT MEADE, SD

Date
 02-01-13

Checked
 DLB

Drawn
 JNK

Project Number
 568-13-113

Building Number
SITE - WEST


Drawing Number
ES101

Dwg 5 of 7



one eighth inch = one foot
 one quarter inch = one foot
 three eighths inch = one foot
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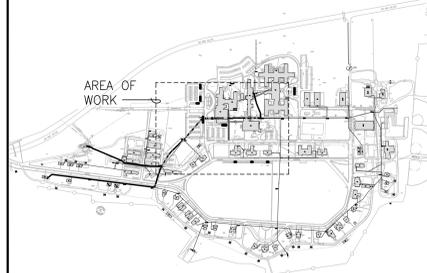
GA2012.04121145 Dept. of Veterans Affairs - Upgrade Fiber Backbone.D=Drawings\Electrical\ES102.dwg 2-04-13 10:26:25 AM kennejyn

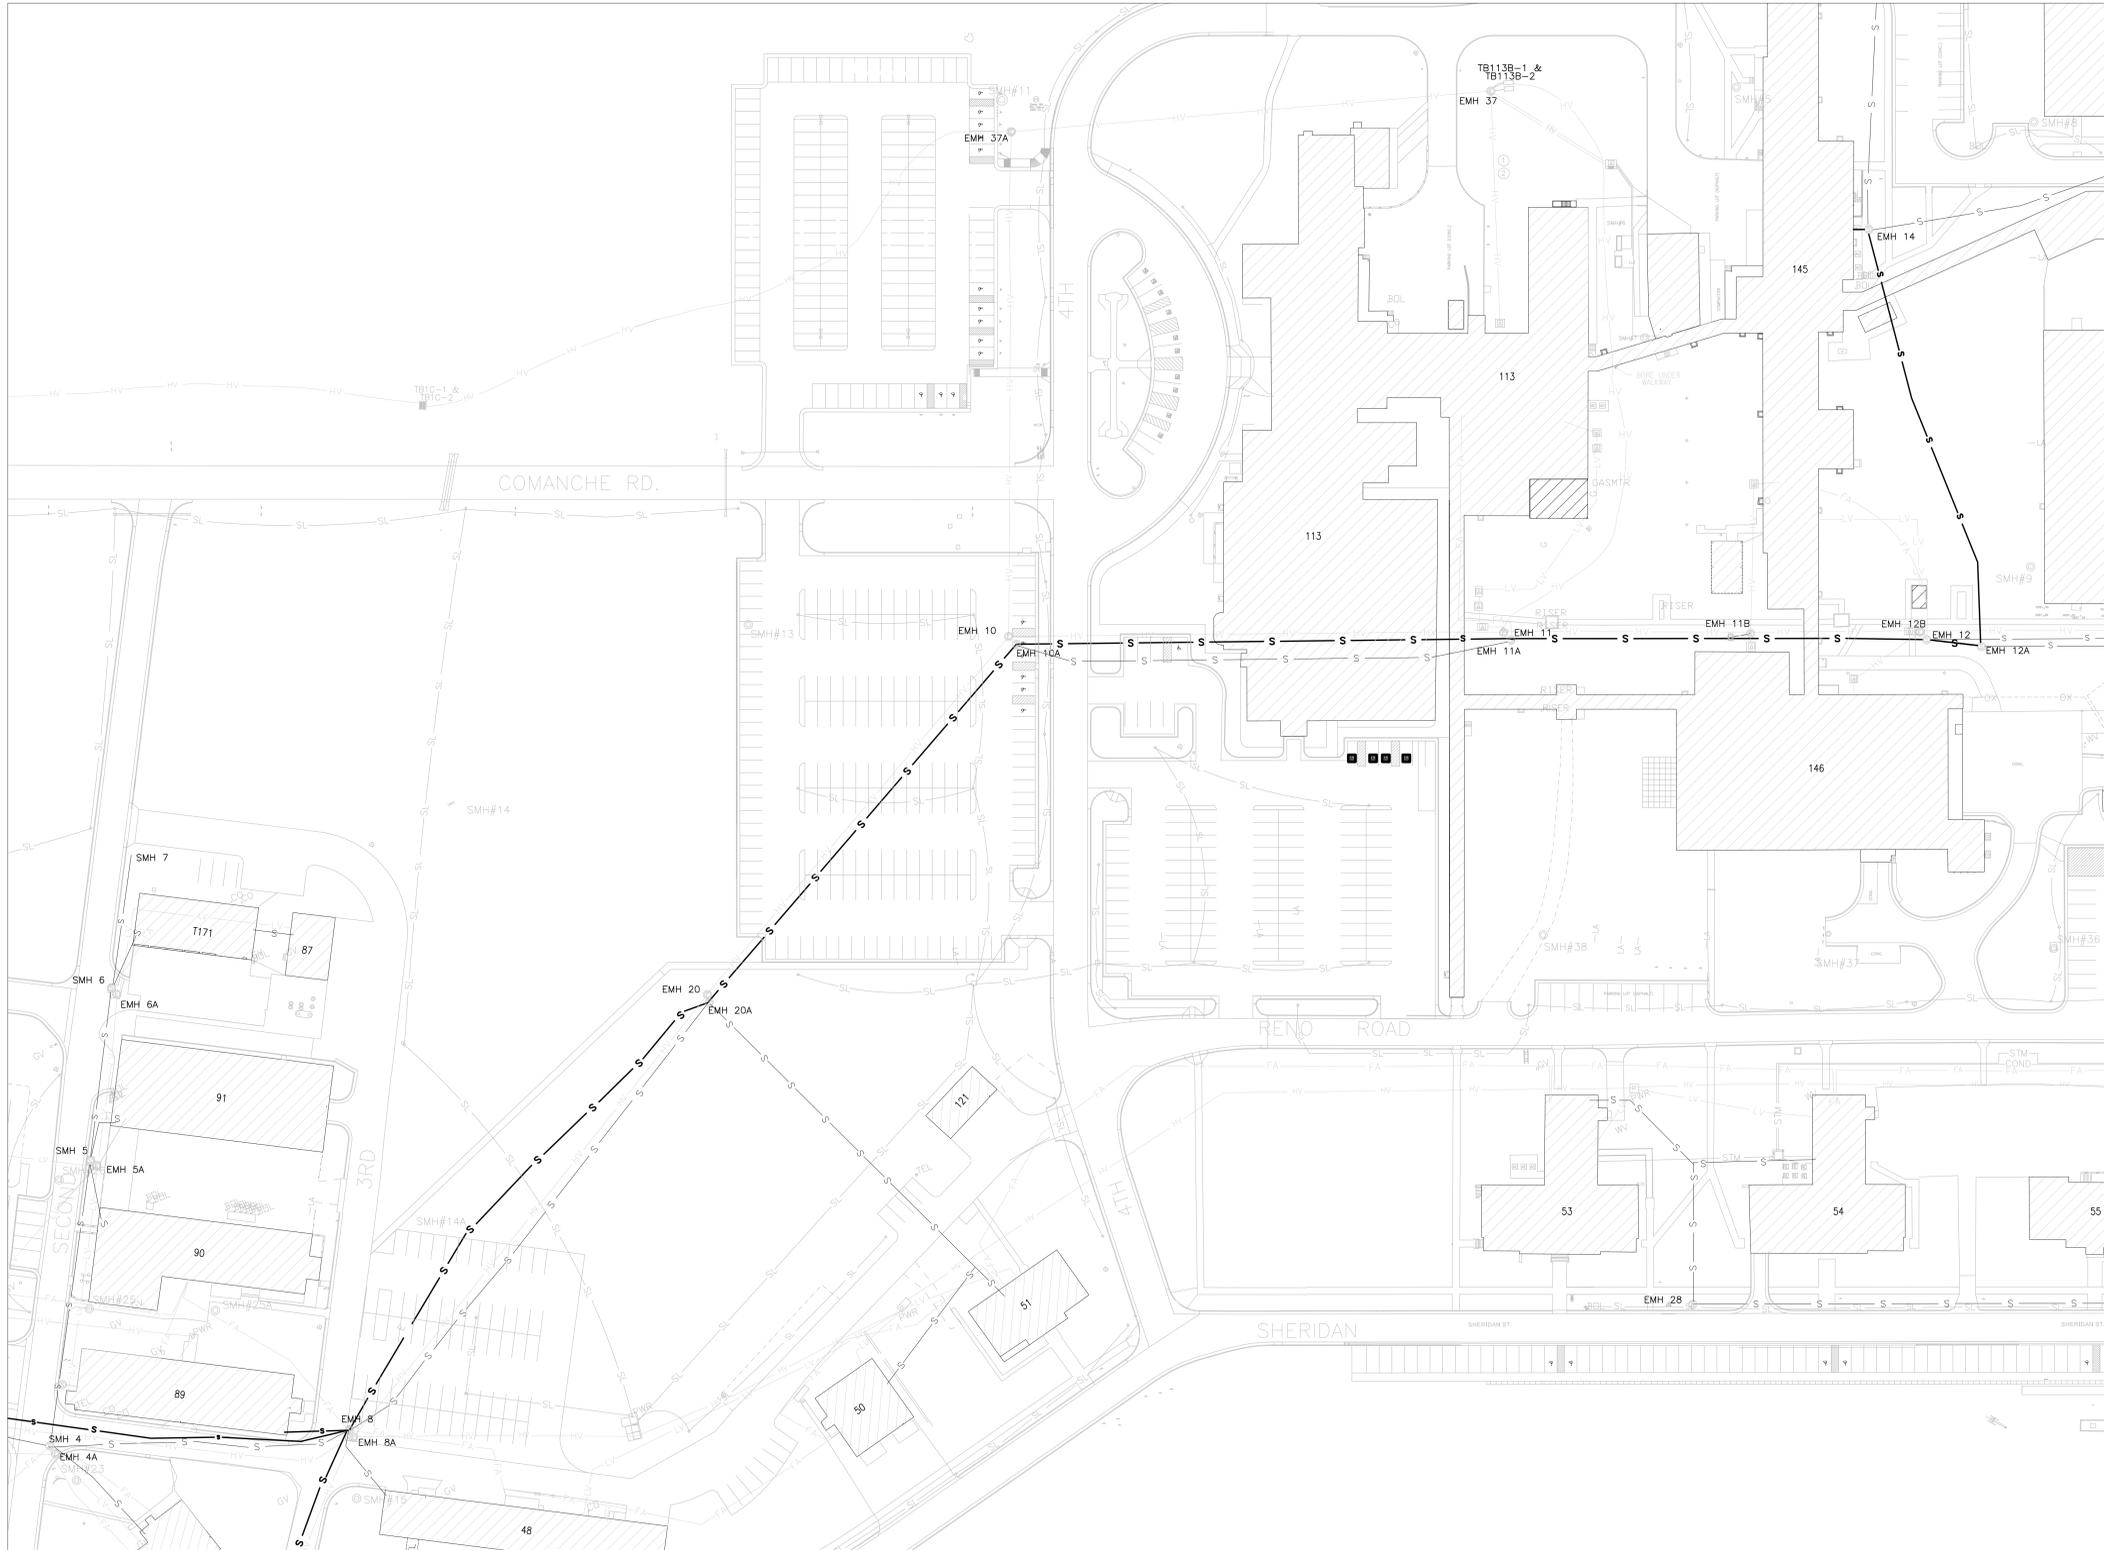

- SHEET GENERAL NOTES**
- THIS PLAN SHOWS THE ROUTING OF THE FIBER THROUGH THE MANHOLES AND DUCT BANKS. SEE RISER DIAGRAMS AND BUILDING PLANS.
 - CONTRACTOR SHALL FIELD VERIFY ALL EXISTING CONDUITS, EXISTING MATERIALS TYPES (FOR PATCHING), AND LENGTHS/DIMENSIONS OF ALL MATERIALS BEFORE SUBMITTING A BID.

1D ELECTRICAL SITE PLAN - EAST
 SCALE: 1" = 50'-0"

9D KEY PLAN
 SCALE: NO SCALE



Revisions	Date

CONSULTANTS:



ARCHITECT/ENGINEERS:

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 www.teamtsp.com
 TSP PROJECT #04121145

To Solve. To Excel. Together.

Drawing Title
ELECTRICAL SITE PLAN - EAST

Approved Project Director

Project Title
UPGRADE FIBER BACKBONE

Location
FORT MEADE, SD

Date
 02-01-13

Checked
 DLB

Drawn
 JNK

Project Number
 568-13-113

Building Number
 SITE - EAST

Drawing Number
ES102

Dwg 6 of 7



