



FIRST FLOOR ELECTRICAL PLANS:

- 1 UNLESS OTHERWISE NOTED, EXISTING ELECTRICAL TO REMAIN.
- 2 PROVIDE NEW GFI RECEPTACLE FOR NEW ELECTRIC PARKING COUNTER, VERIFY RECEPTACLE LOCATION WITH ECP SUPPLIER, PROVIDE NEW CONDUITS AND WIRING AS REQUIRED TO CONNECT NEW AND EXISTING CIRCUIT.
- 3 PROVIDE NEW CONDUITS AND WIRING TO RECONNECT EXISTING BRANCH CIRCUIT. VERIFY WORK REQUIRED IN FIELD.
- 4 RUN NEW CONDUITS AND WIRING TO CONNECT EXISTING AND NEW RECEPTACLES.
- 5 RECONNECT EXISTING WORK STATION TO EXISTING POWER AND TEL/DATA WIRING AS REQUIRED.
- 6 SEE ELECTRICAL DEMO PLANS FOR WORK ON EXISTING OUTLETS.
- 7 PROVIDE NEW LIGHT AND SWITCH AND RECEPTACLE IN ELEVATOR PIT, AS DIRECTED BY ELEVATOR SUPPLIER. LIGHT SHALL BE WALL MOUNTED COMPACT FLUORESCENT WITH GLOBE AND SOUVEN. HUBBELL #16270-42550 OR EQUAL.
- 8 RUN 3/4" WITH #2#12 + #12 GROUND TO NEW PANEL, "P18". RUN IN FIRST FLOOR. VERIFY ROUTING IN FIELD. PROVIDE ACCESSIBLE PULL BOXES AS REQUIRED.
- 9 PROVIDE NEW PANEL, SURFACE MOUNT ON WALL.
- 10 RUN FEEDER PER LINE DIAGRAM TO EXISTING DISTRIBUTION PANEL, "DP" IN SECOND FLOOR ELECTRICAL ROOM. VERIFY ROUTING IN FIELD. PROVIDE ACCESSIBLE PULL BOXES AS REQUIRED.
- 11 SUB ONE 1-1/2" WITH PULL WIRE FROM PANEL UP INTO ACCESSIBLE ATTIC. VERIFY CONNECTION LOCATION OF ELECTRIFIED FURNITURE PANEL IN FIELD.
- 12 PROVIDE POWER JUNCTION BOX IN WALL. RUN 3/4" FLEX WITH #2#12 + #12 GROUND TO CONNECT FURNITURE PANEL.
- 13 PROVIDE TEL/DATA JUNCTION BOX IN WALL. PROVIDE TWO TEL/DATA OUTLETS IN PANEL. RUN ONE 1-1/4" FLEX WITH FOUR DATA CABLES TO CONNECT TEL/DATA OUTLETS IN PANEL. PROVIDE CABLES IN PANEL CHASES.
- 14 RUN ONE 1-1/4" WITH FOUR DATA CABLES TO EXISTING IDF AND TEL BACKBOARD.
- 15 EXISTING RECEPTACLE AND WIRING TO REMAIN.
- 16 REPLACE EXISTING RECEPTACLE WITH WP/GFI RECEPTACLE WITH WP PLATE AND COVER. RECONNECT EXISTING WIRING.
- 17 NEW WP/GFI RECEPTACLE IN SURFACE ITS BOX. MOUNT ON WALL AT +24" AFF.
- 18 PROVIDE JUNCTION BOX IN ATTIC FOR BRANCH CIRCUIT WIRING. PROVIDE BRANCH CIRCUIT BREAKER IN ATTIC. RUN 3/4" THROUGH EXTERIOR BLOCK WALL TO NEW SURFACE BOX ON WALL.
- 19 PROVIDE JUNCTION BOX IN ATTIC FOR BRANCH CIRCUIT WIRING. PROVIDE NEW FLUSH OUTLET IN WALL. RUN 3/4" FROM WALL AT +24". RUN 3/4" IN EXTERIOR WALL TO NEW ELECTRICAL WORK. IN AUDITORIUM SHALL BE INCLUDED IN DEDUCTIVE ALTERNATE 4.
- 20 EXISTING PANELS TO REMAIN AND TO BE REUSED.
- 21 EXISTING RECEPTACLE AND HOMERUN TO PANEL TO REMAIN. CONNECT TO CIRCUIT IN PANEL AS INDICATED.
- 22 EXISTING SOUND PACK, RECEPTACLES AND WIRING TO REMAIN.
- 23 EXISTING SOUND TC TO REMAIN.
- 24 PROVIDE NEW TEL/DATA TC, 12" W X 18" H X 6" D WITH HINGED DOOR.
- 25 RUN TWO 2" WITH CABLES TO EXISTING TEL BACKBOARD AND IDF ON FIRST FLOOR.
- 26 PROVIDE 4" X 4" X 3/8" GUTTER ON WALL AT CEILING AT SOUND BACK LOCATION FOR OWNER'S AV CABLING. RUN TWO 2" WITH PULL WIRE TO NEW T/D TC.
- 27 LOCATE RECEPTACLE IN CEILING FOR PROJECTOR, AS DIRECTED BY CORR.
- 28 AT PROJECTOR LOCATION, PROVIDE TWO JUNCTION BOXES IN CEILING. RUN TWO 1-1/4" FROM EACH JUNCTION BOX TO AV GUTTER IN CONTROL ROOM.
- 29 CONNECT MOTORIZED PROJECTION SCREEN.
- 30 CONTROL SWITCH FOR SCREEN SHALL BE FURNISHED BY SUPPLIER, INSTALLED BY CONTRACTOR. LOCATE AS DIRECTED BY CORR.
- 31 PROVIDE JUNCTION BOX WITH 1-GANG BLANK PLATE IN WALL AT +15" FOR AV GUTTER.
- 32 VERIFY LOCATION OF FLOOR BOXES WITH CORR. FLOOR BOXES SHALL BE WIRING/DUCT EXHIBITION SERIES OR EQUAL. #2#12 WITH TWO DUPLEX RECEPTACLES AND PROVISION FOR SIX COMBINATION TEL/DATA AND AV DEVICES. RUN FROM EACH POWER COMPARTMENT ONE 1" SPARE WITH PULL WIRE TO PANEL, AUD-P.
- 33 RUN FROM FLOOR BOX COMMUNICATION COMPARTMENTS ONE 1-1/4" WITH THREE DATA CABLES TO T/D TC. CONTINUE TO EXISTING TEL BACKBOARD AND IDF. TWO 2" WITH PULL WIRES TO AV GUTTER.
- 34 PROVIDE RECEPTACLE FOR FUTURE SMARTBOARD. VERIFY LOCATION WITH CORR.
- 35 PROVIDE JUNCTION BOXES, 4-1/16" X 2-1/8" WITH 1-GANG BLANK PLATES. PULL WIRE FROM EACH OUTLET TO AV GUTTER IN PROJECTION ROOM.
- 36 PROVIDE TEL/DATA OUTLETS FOR FUTURE SMARTBOARD. VERIFY LOCATION WITH CORR. RUN ONE 1-1/4" WITH THREE DATA CABLES TO T/D TC IN PROJECTION ROOM. CONTINUE TO EXISTING TEL BACKBOARD AND IDF.
- 37 PROVIDE TEL/DATA OUTLETS IN WALL AT +15". RUN ONE 1-1/4" WITH THREE DATA CABLES TO T/D TC IN PROJECTION ROOM. CONTINUE TO EXISTING TEL BACKBOARD AND IDF.
- 38 PROVIDE TEL/DATA OUTLETS IN WALL AT +15" AT CONTROL STATION. RUN ONE 1-1/4" WITH THREE DATA CABLES TO T/D TC. CONTINUE TO EXISTING TEL BACKBOARD AND IDF.
- 39 STRIPUP FROM AV GUTTER TWO 2" WITH PULL WIRE INTO ATTIC, AS DIRECTED BY CORR.
- 40 STRIPUP FROM PANEL, AUD-P ONE 1-1/4" WITH PULL WIRE INTO ATTIC, AS DIRECTED BY CORR.
- 41 PROVIDE JUNCTION BOX, 4-1/16" X 2-1/8" WITH 1-GANG BLANK PLATE IN WALL AT +15". RUN ONE 1-1/4" WITH PULL WIRE TO PANEL, AUD-P.

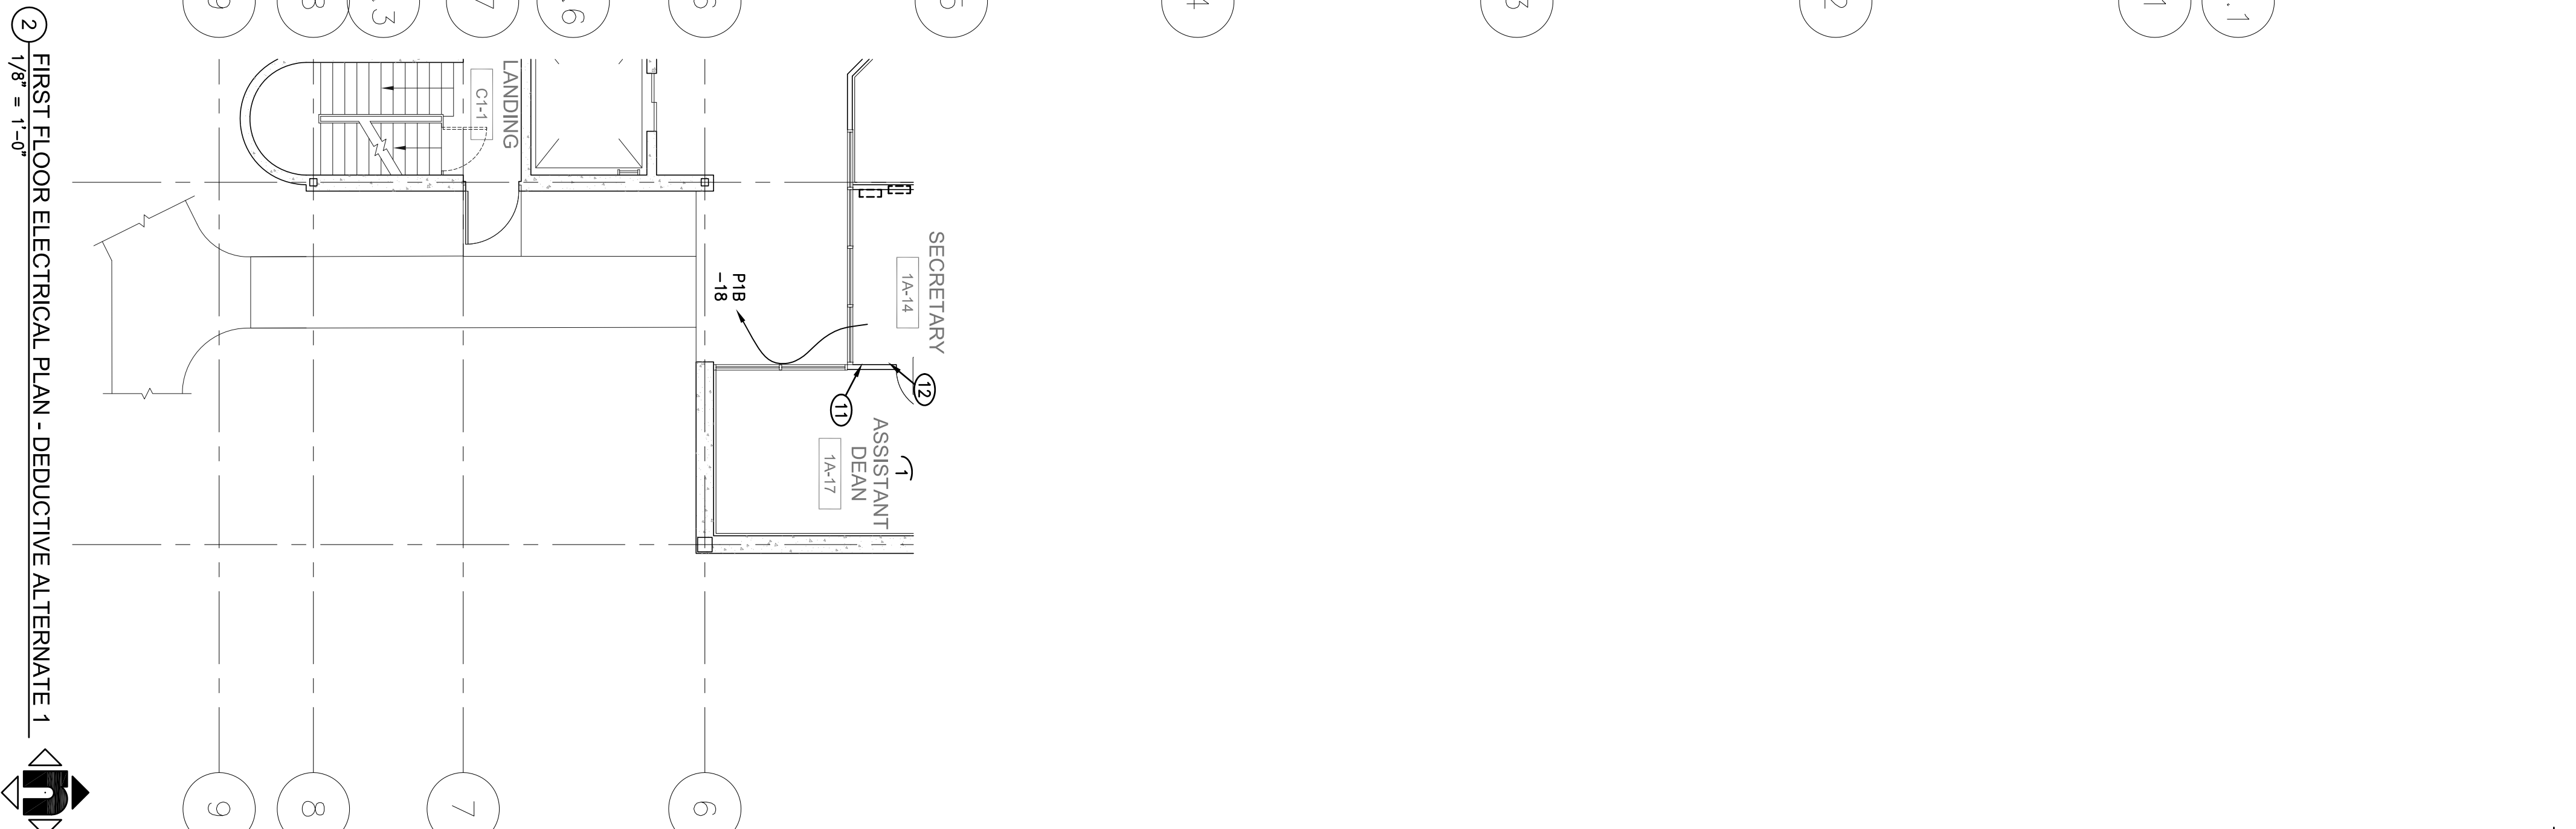

1 FIRST FLOOR ELECTRICAL PLAN
1/8" = 1'-0"

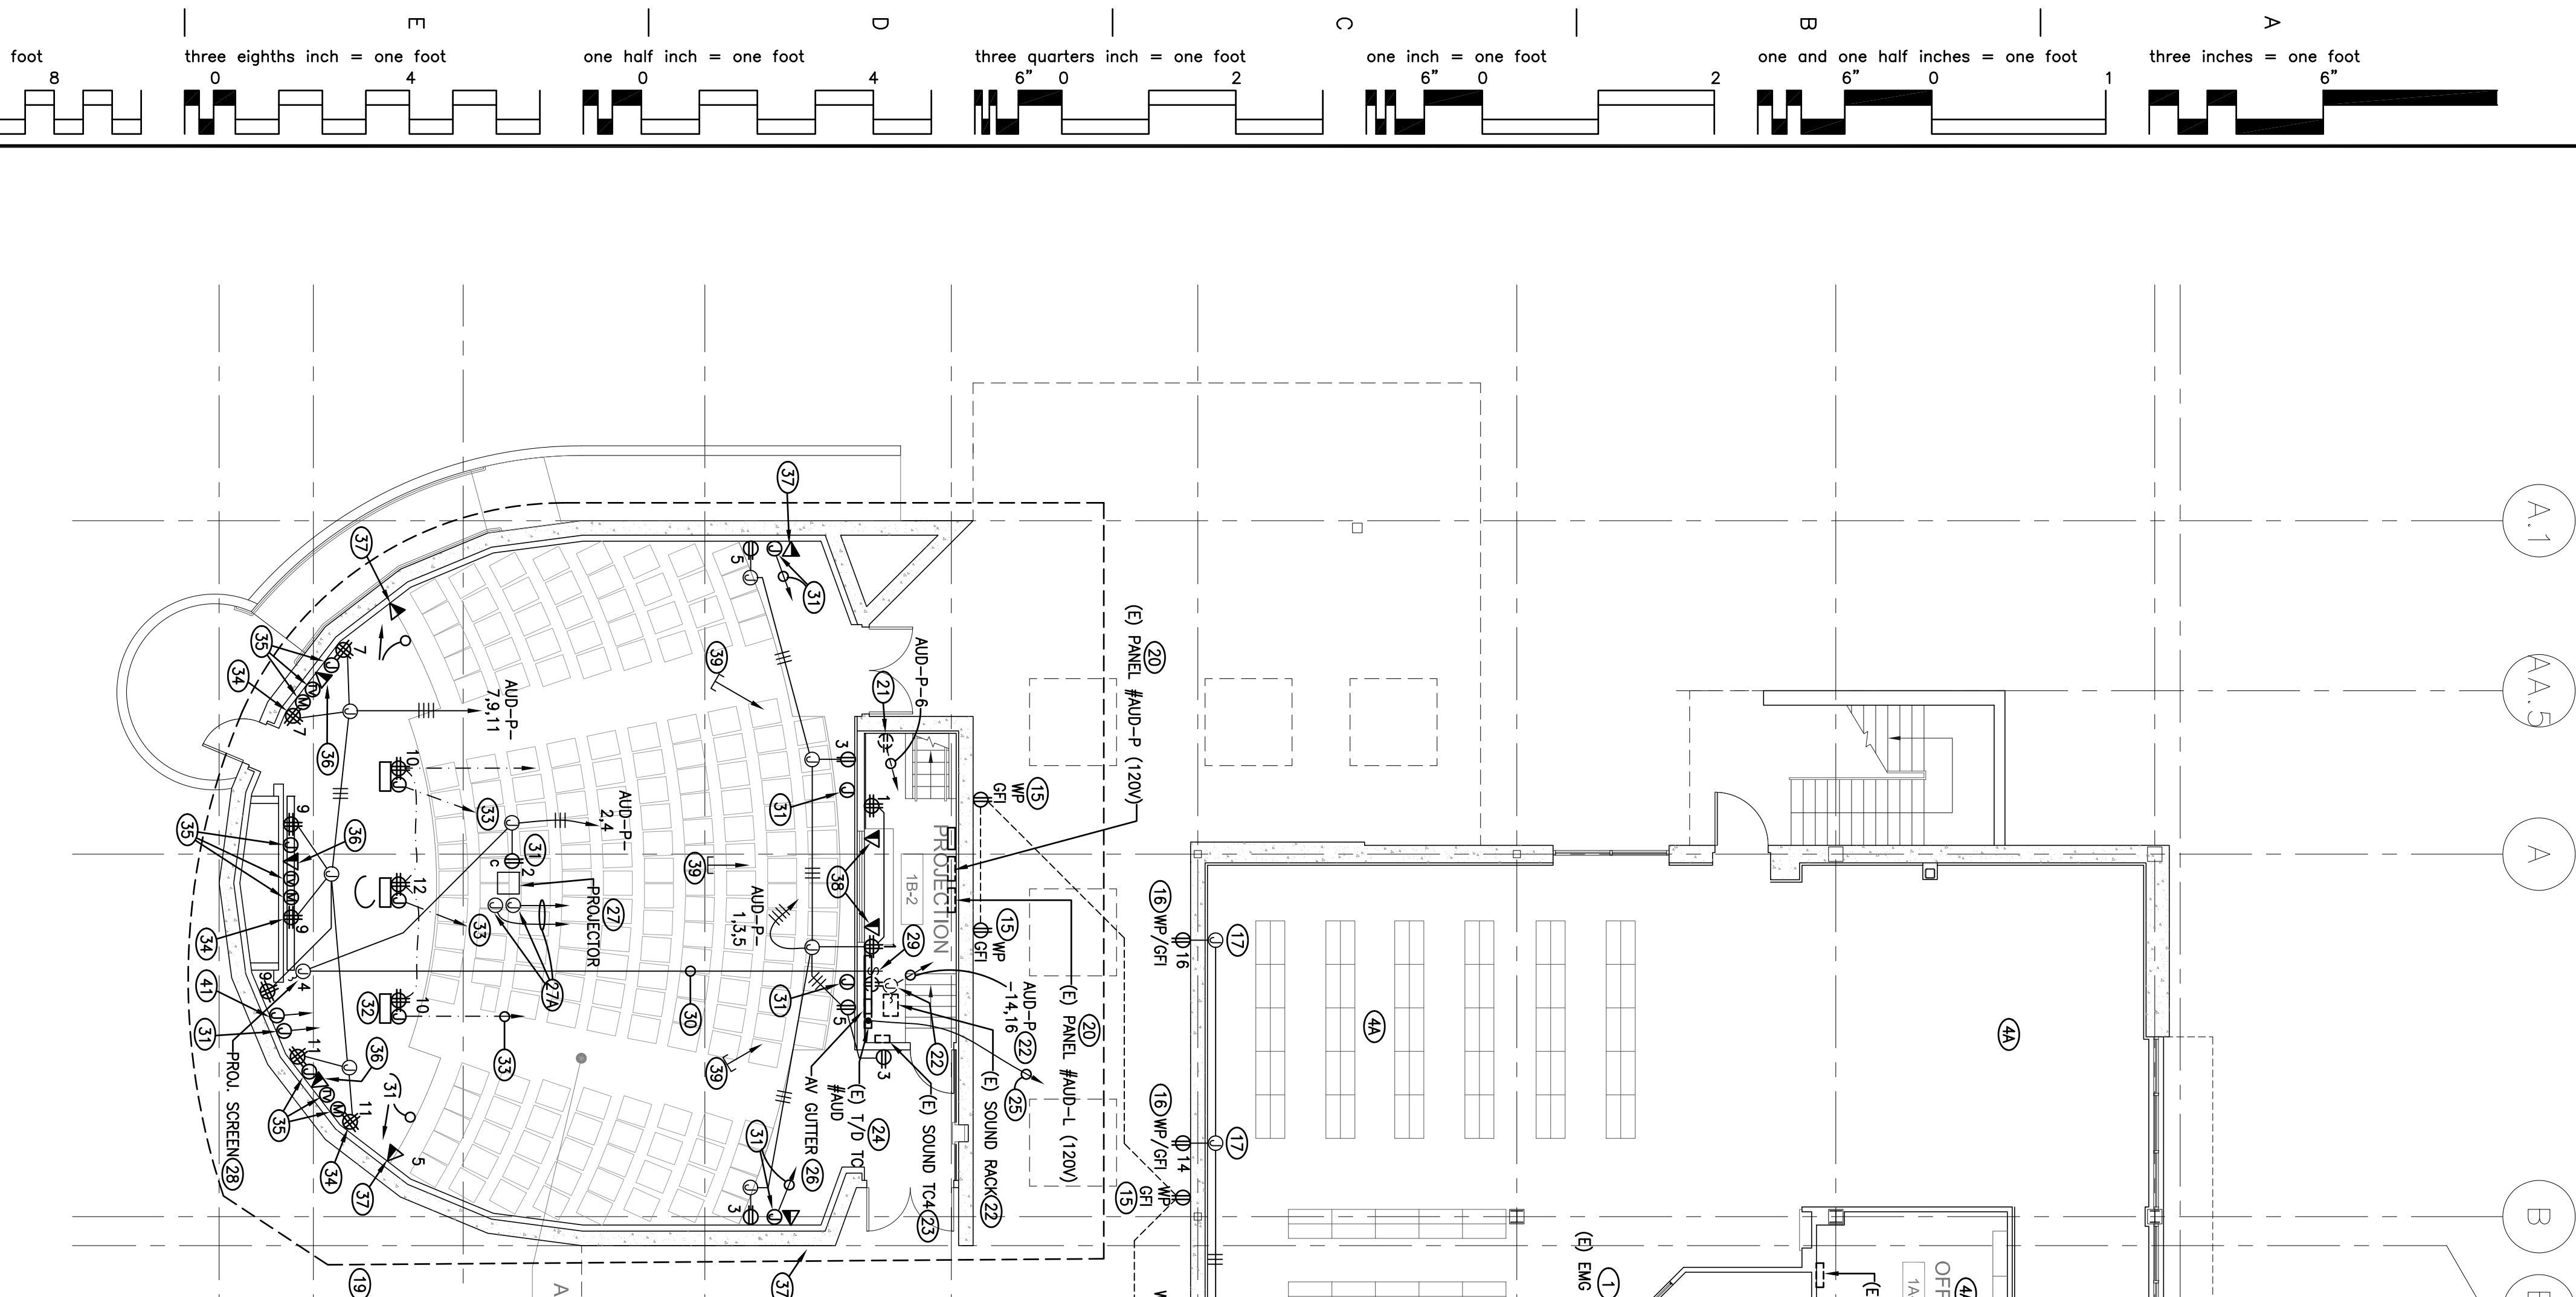

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Drawing Title		Project Title	
FIRST FLOOR ELECTRICAL PLAN		BUILDING 24 SEISMIC CORRECTION AND ADDITION	
Approved Project Director		Location VAMC FRESNO, CA	
Date March 12, 2018	Checked FK	Drawn FK/L/S	Dwg. No. 108 of 180
Project Number 570-215		Building Number 24	
Drawing Number ESI02		Office of Construction and Facilities Management Department of Veterans Affairs	