

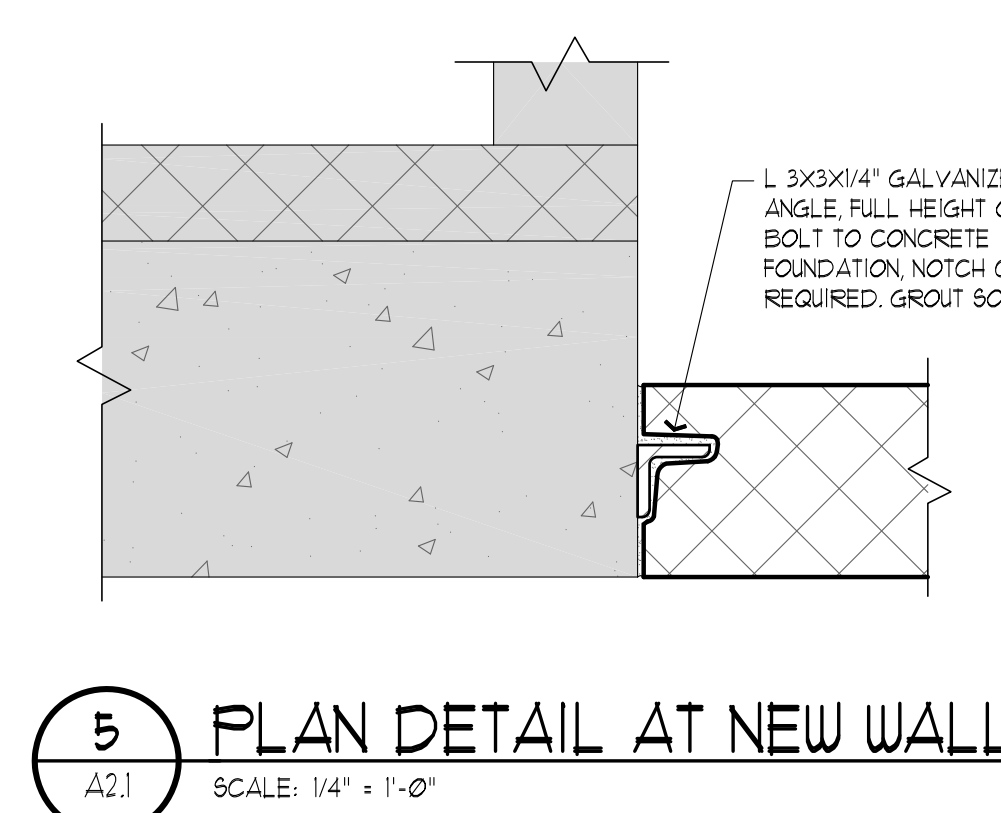


TUNNEL WATERPROOFING NOTES:

1. PROVIDE SIMILAR WATERPROOFING FOR CAST-IN-PLACE PORTIONS OF TUNNEL.
2. COORDINATE WATERPROOFING WITH CONSTRUCTION OF REMAINDER OF TUNNEL IN SEPARATE PROPOSED TUNNEL PHASE 2 PROJECT. PHASE 1 HAS NOT BEEN INSTALLED. WATERPROOF TEMPORARY CLOSURE END. SEE STRUCTURAL DRAWINGS FOR CLOSURE PIECE CONSTRUCTION. IF PHASE 2 PORTION OF TUNNEL HAS BEEN INSTALLED, OVERLAP WATERPROOFING A MINIMUM OF 12" ONTO THE EXISTING TUNNEL SEGMENT.

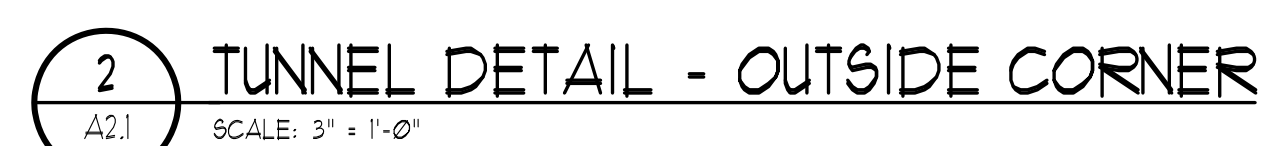

5 PLAN DETAIL AT NEW WALL
A2.1 SCALE: 1/4" = 1'-0"

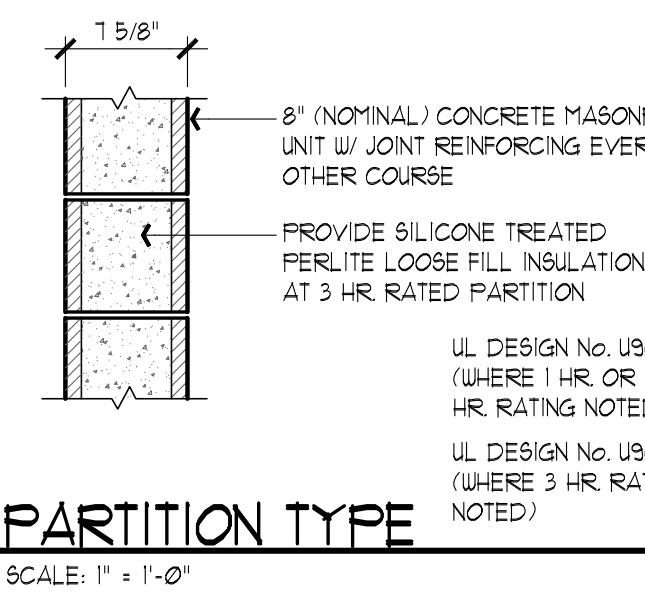





D04 PARTITION TYPE
SCALE: 1" = 1'-0"

1. ANY PENETRATION THROUGH HOURLY RATED PARTITIONS SHALL BE SEALED WITH AN APPROVED SYSTEM TO EQUAL THE ORIGINAL RATING OF THE PARTITION SYSTEM IN ACCORDANCE WITH THE SPECIFICATIONS. EXISTING WALLS WITH NEW PENETRATIONS ARE TO BE SEALED AS REQUIRED TO MAINTAIN RATING.
2. RESTORE DAMAGED AND EXPOSED FINISHES OR PATCHED AREAS IN A MANNER WHICH ELIMINATES EVIDENCE OF PATCHING AND REFINISHING.
3. DOOR OPEN TO BE "A" LABEL, 1 3/4 RATED, 4'-0" W X 6'-8" H PAINTED HOLLOW METAL PARTITION WITH HOLLOW METAL PARTITION FINISH. LEAD TO "A" LABEL, 1 3/4 RATED, 4'-0" W X 6'-8" H DOOR AND FRAME PAINT COLOR TO MATCH EXISTING ADJACENT WAREHOUSE DOOR COLOR.
4. INSTALL FIRE BARRIER BLOCKS AROUND PIPING PENETRATIONS. PROVIDE FIRE BLOCK AT PERIMETER OF ALL OPENINGS.

Figure 1.1 shows various basic symbols used in architectural drawings. The symbols are arranged in two columns, with their corresponding labels to the right. The symbols include: EXISTING WALL (two parallel lines), NEW WALL (two parallel lines with a dashed center line), EXISTING DOOR AND FRAME (a simple door outline), NEW DOOR AND FRAME (a door outline with a thick frame), DETAIL KEY (a circle with 'X' and 'AX'), ELEVATION KEY (a circle with '4' and 'AII' and an arrow), SECTION KEY (a circle with 'X' and 'AX' and a thick line), ROOM NAME AND NUMBER (a rectangle with 'ROOM' and '003'), and DOOR NUMBER (a rectangle with '003').



UNREVIEWED FINAL DESIGN (100%)
NOT FOR CONSTRUCTION

		CONSULTANTS:		ARCHITECT/ENGINEERS:		Drawing Title WALL SECTIONS AND DETAILS		Project Title REPAIR HOT WATER LINES PHASE III Stratton VA Medical Center		Project Number VA 528A8-10-814		Office of Construction and Facilities Management	
		<div><p>Quality Service Since 1944 FRIEDMAN FISHER ASSOCIATES, P.C. CONSULTING ENGINEERS 25 AVIATION ROAD, ALBANY, NEW YORK 12205 TEL (518) 458-7040 FAX (518) 458-7043 info@friedmanfisher.com</p></div>		<div><p>RYAN-BIGGS ASSOCIATES, P.C. 251 ULSTER ROAD CLINTON, NY 12520 • 518-486-5556 www.ryanbiggs.com</p></div>		<div><p>Hyman & Hayes ASSOCIATES 6 WEADLEY COURT, ALBANY, NEW YORK 12205 (518) 452-3470 (518) 452-3783 FAX</p></div>		Approved Project Director		Location Albany, New York			
Revisions:		Date		HHA Proj. 12072		Date MARCH 20, 2013		Checked MKH		Drawn MW/RS		 Department of Veterans Affairs	