


VA LEXINGTON PROSTHETICS RENOVATION

2/21/2013

LEXINGTON VA MEDICAL CENTER,
LEESTOWN DIVISION
2250 LEESTOWN ROAD
LEXINGTON, KENTUCKY 40511

PROJECT # 596-12-103

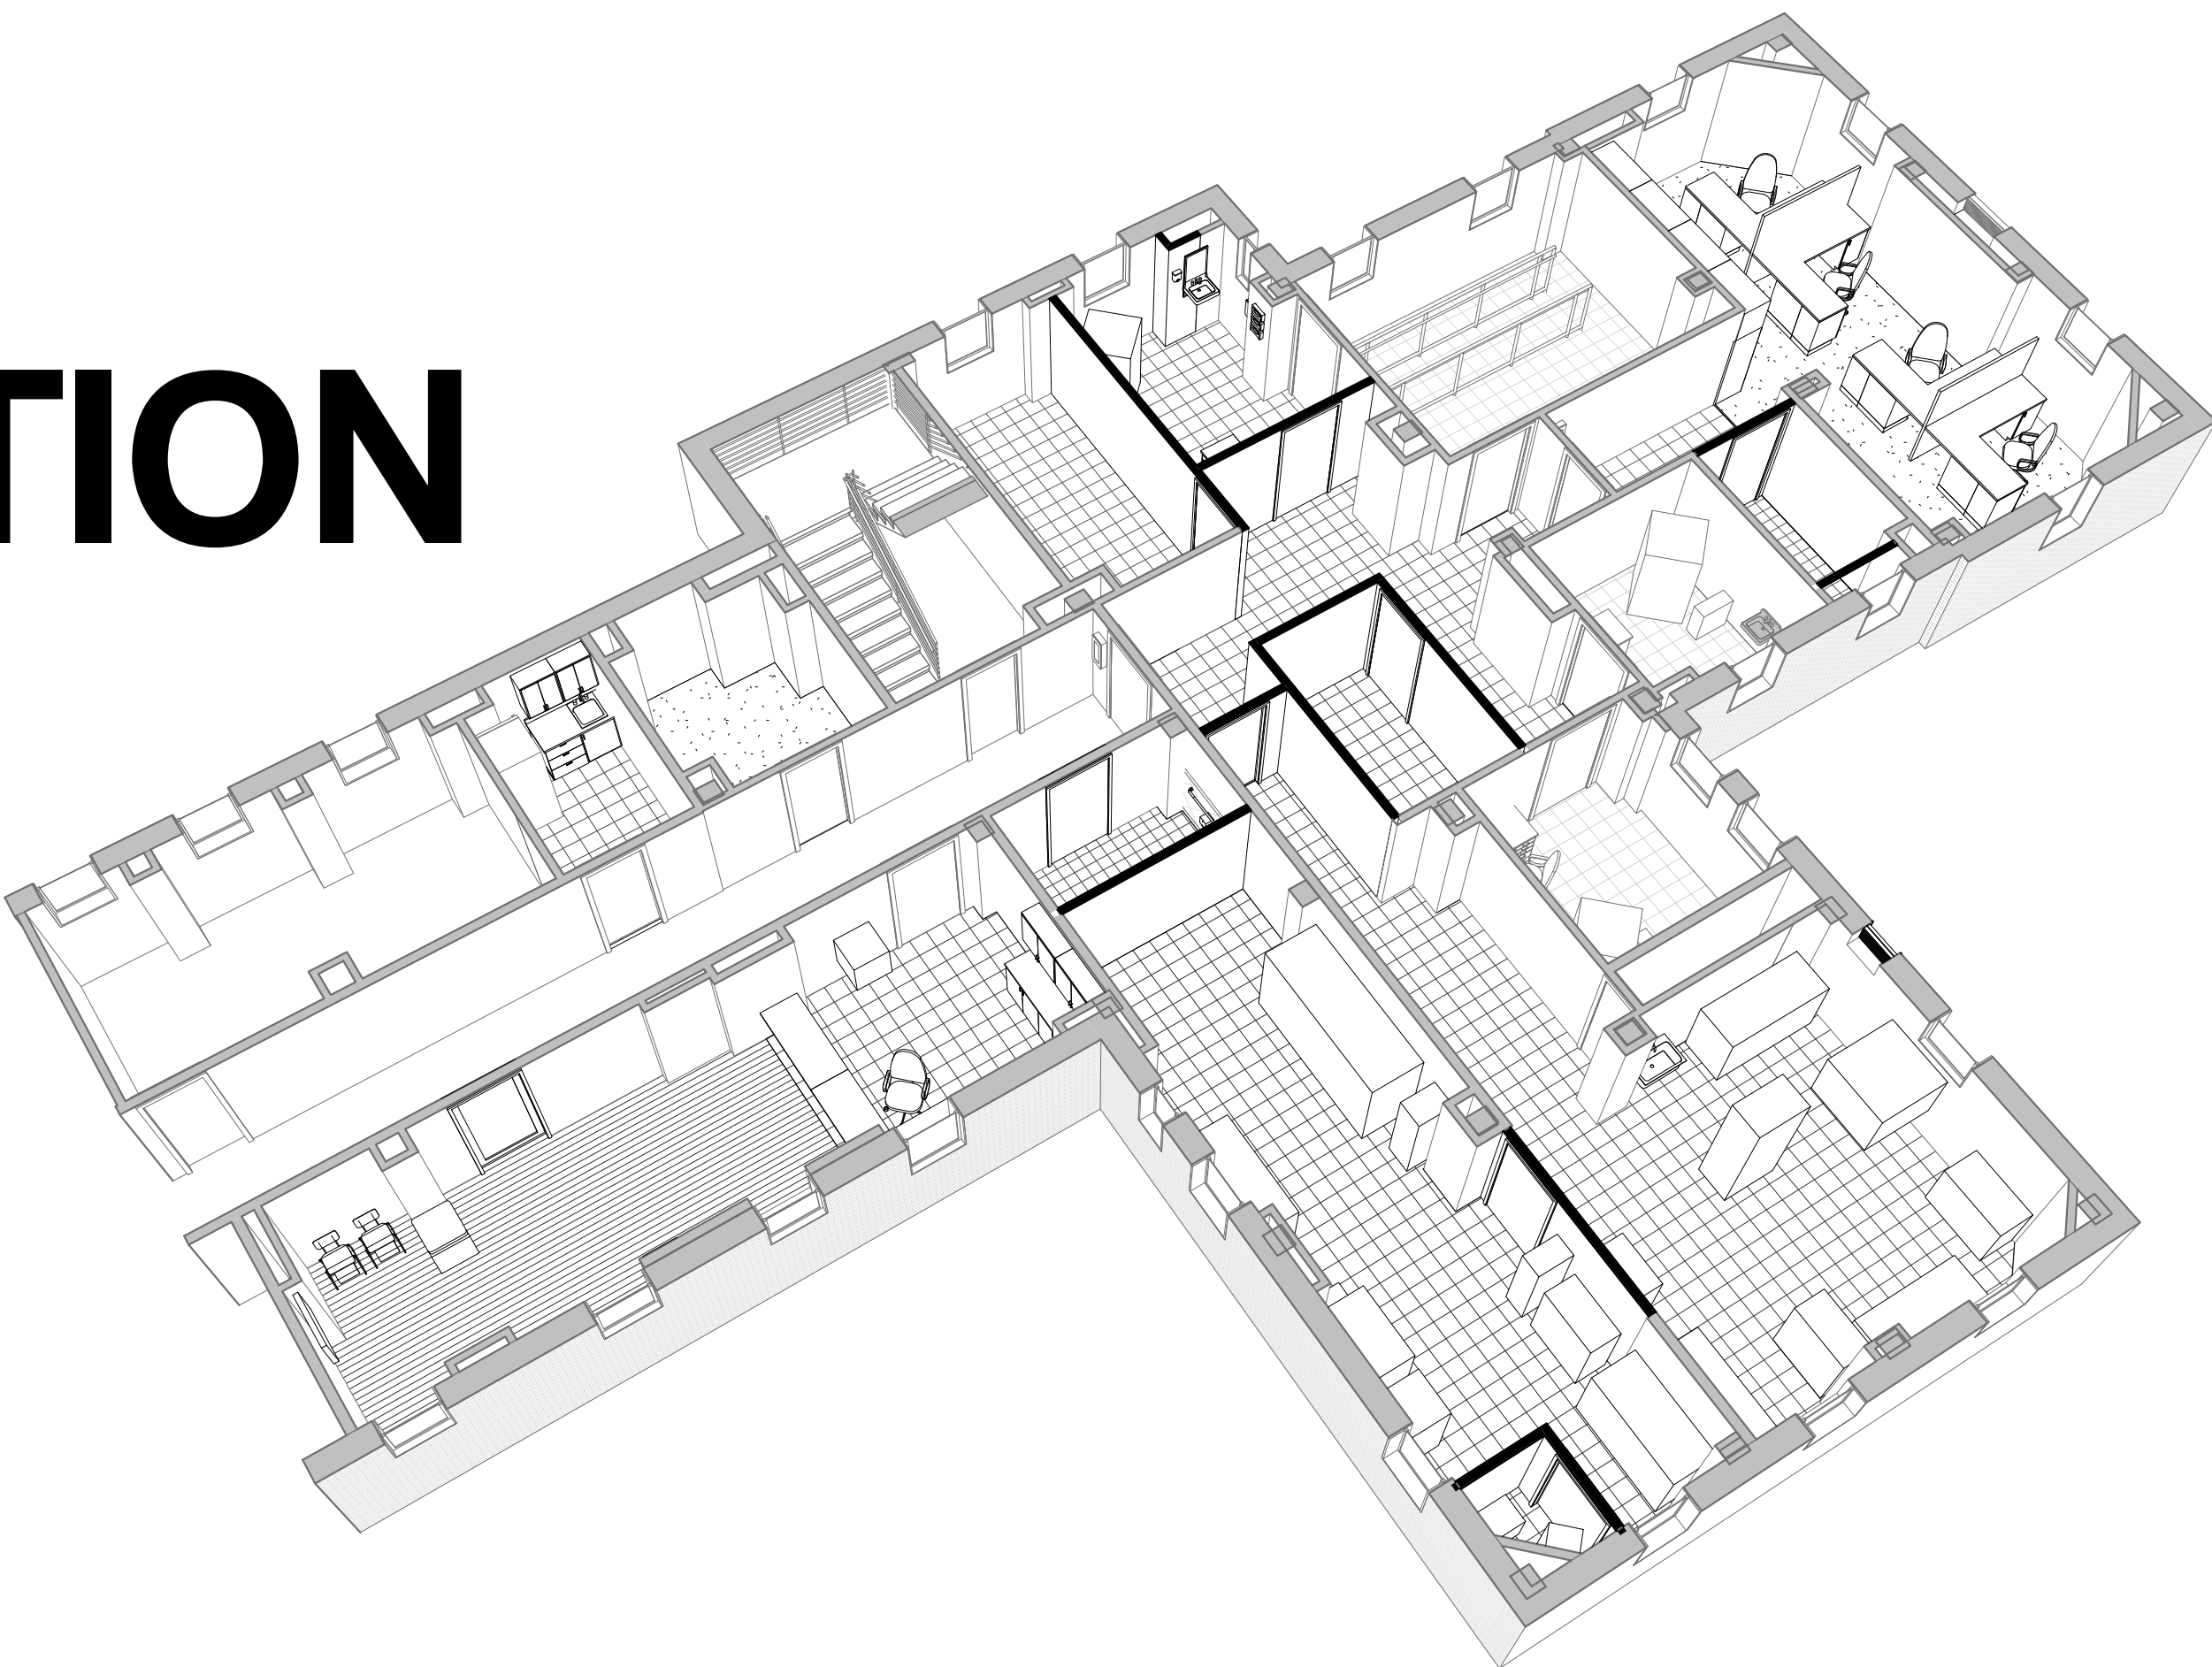

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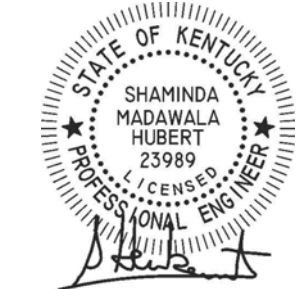
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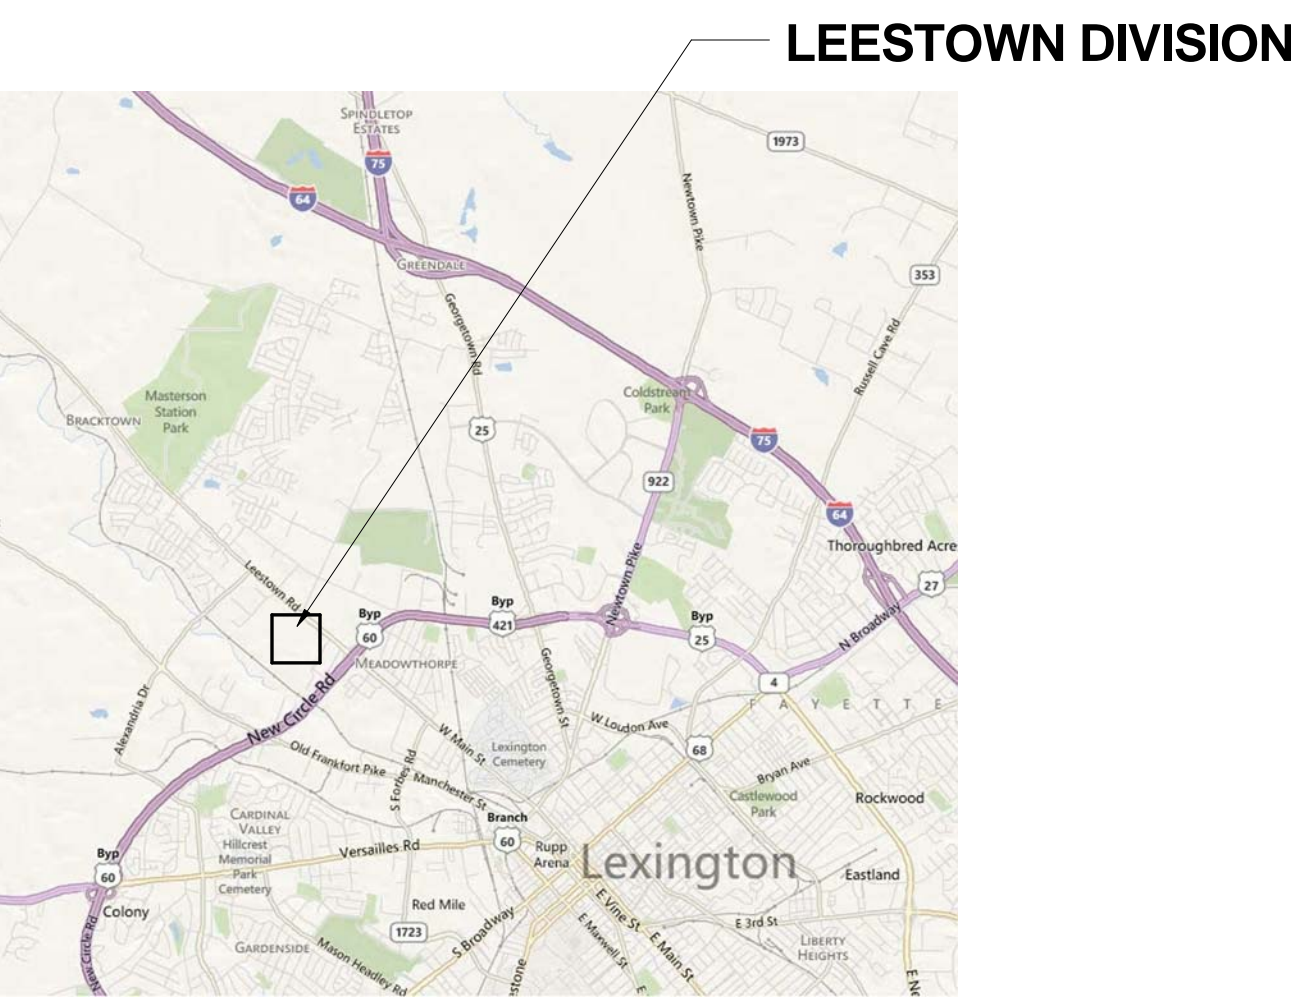
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DRAWING INDEX


Sheet Number	Sheet Name
GI001	TITLE SHEET
GI100	GENERAL INFORMATION
GI101	PHASING PLAN
HA101	ABATEMENT PLAN
AD101	DEMOLITION PLAN
AE100	LIFE SAFETY PLAN
AE101	FLOOR PLAN
AE201	REFLECTED CEILING PLAN
AF400	FINISHES FLOOR PLAN
AE501	SECTIONS AND DETAILS
MG001	MEP GENERAL INFORMATION
MD100	HVAC REMOVAL PLAN
MD101	HVAC PIPING REMOVAL PLAN
MH100	HVAC PLAN
MHP001	DETAILS
MHP002	DETAILS
MP100	HVAC PIPING PLAN
ED 100	ELECTRIC DEMOLITION PLAN
ED 101	ELECTRIC PHOTO SHEET
EL 100	GROUND LEVEL LIGHTING PLAN
EP 200	GROUND LEVEL POWER AND SYSTEMS PLAN
ES 300	ELECTRICAL SCHEDULE AND LEGEND
ES 301	GROUND LEVEL ELECTRIC PLAN AND DETAILS
PD101	GROUND LEVEL PLUMBING REMOVAL PLANS
PL001	PLUMBING SCHEDULES AND DETAILS
PL101	GROUND LEVEL PLUMBING PLANS
FX101	GROUND LEVEL FIRE PROTECTION PLAN




LOCATION MAP



ORIENTATION MAP

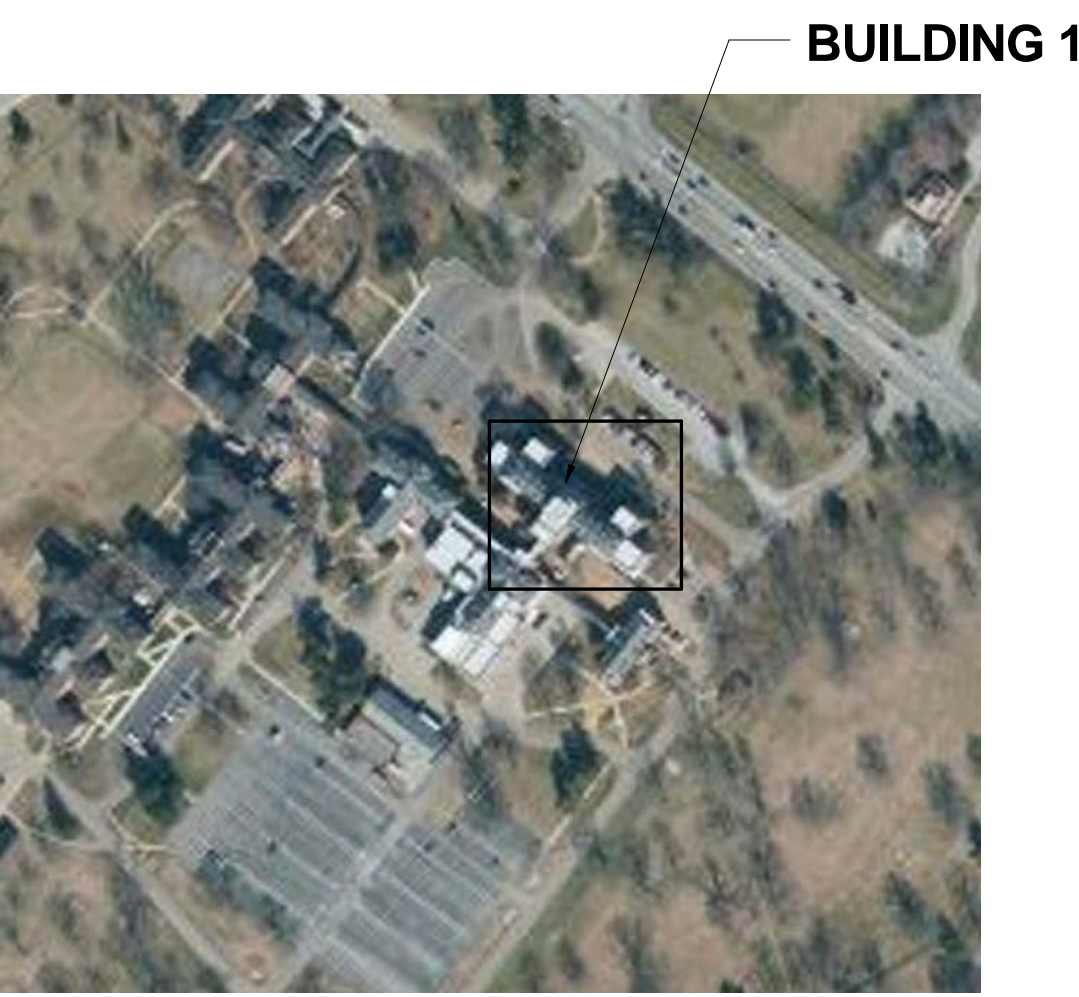

KEY MAP

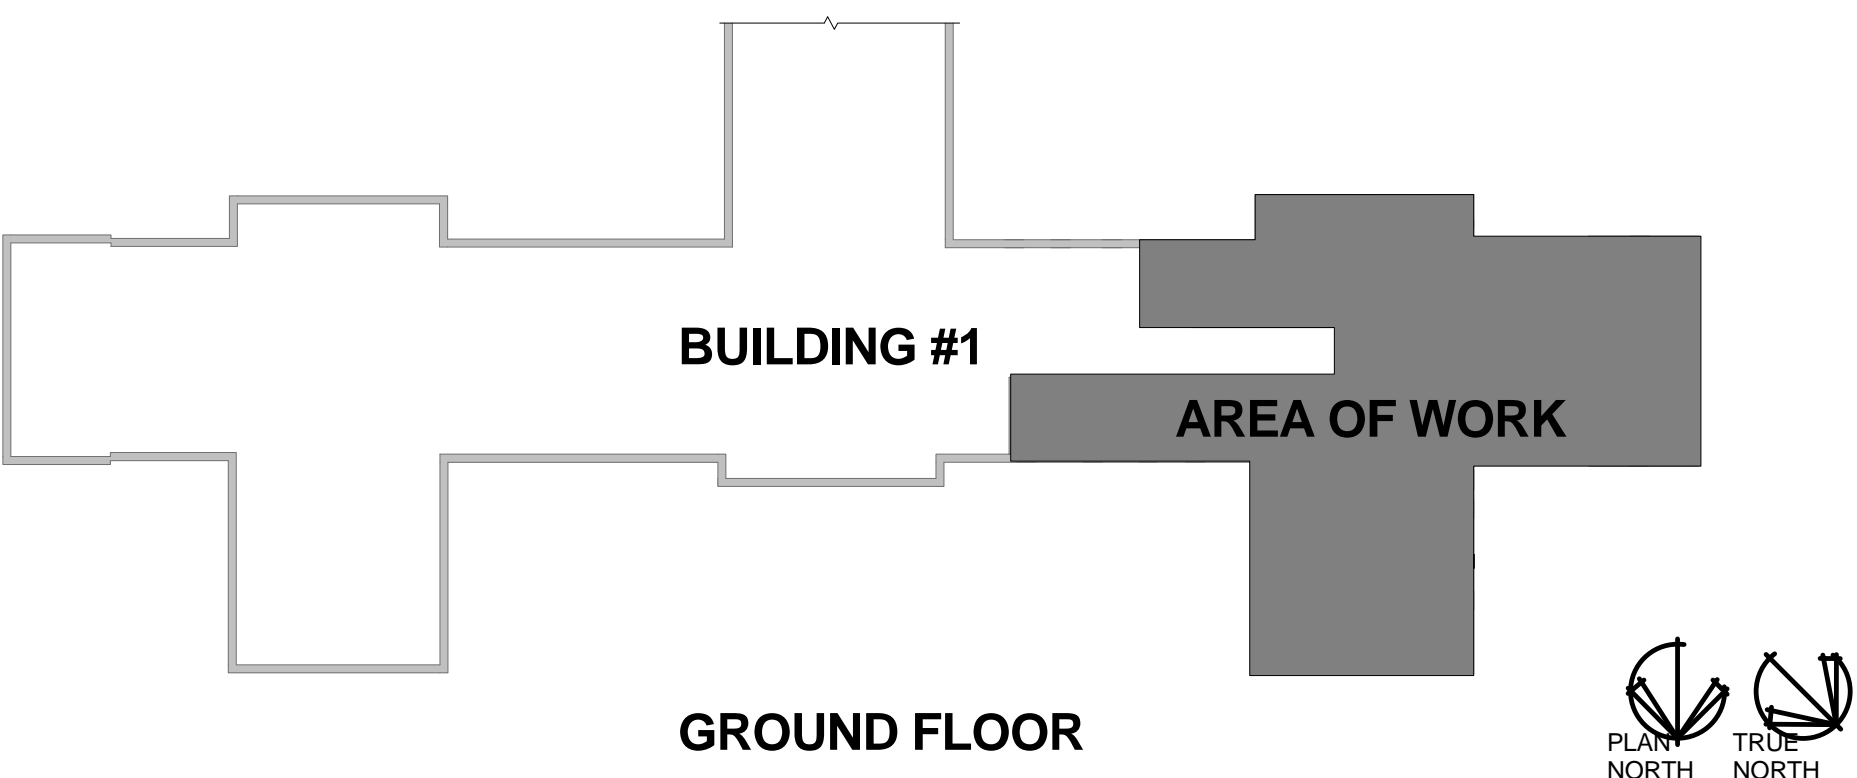

BID DOCUMENTS

Revisions:	MEP / HVAC DESIGN		PROJECT LEADER/ARCHITECT:	Drawing Title	Project Title		Project Number	VETERANS ADMINISTRATION MEDICAL CENTER
	BCCLT, Inc.		GUIDON DESIGN	TITLE SHEET	RENOVATE PROSTHETICS	596-12-103	Building Number	
	www.BCCLT.com		2453 N. DELAWARE ST., INDIANAPOLIS, IN. 46205 317.800.6388 WWW.GUIDONDESIGN.COM SUSTAINABLE ARCHITECTURE + ENGINEERING	Approved for Design Concept:	LEXINGTON VAMC LD	Location	Bldg-1	
					2/21/2013	Date	Checked By: STW	

ABBREVIATIONS

& AND	DISP DISPENSER	HDWR HARDWARE	PL PLATE	T TREAD
@ AT	DL DEAD LOAD	HGT HEIGHT	PLAM PLASTIC LAMINATE	T.O. TOP OF
C CENTERLINE	DMH DRAINAGE MANHOLE	HID HIGH INTENSITY DISCHARGE	PLAS PLASTER	T&G TONGUE AND GROOVE
# POUND, NUMBER	DN DOWN	HM HOLLOW METAL	PLBG PLUMBING	TEL TELEPHONE
A/C AIR CONDITIONING	DP DISTRIBUTION PANEL	DR DOOR	PLF POUNDS PER LINEAR FOOT	TEMP TEMPERATURE
ACCUS ACOUSTICAL	DS DOWNSPOUT	DRZ HORIZONTAL	PLYWD PLYWOOD	THK THICK
ACT ACOUSTIC CEILING TILE	DWG DRAWING	HVAC HEAT VENT. A/C	PNL PANEL	THRESHOLD
ADDN ADDITION	E EAST	HW HOT WATER	POL POLISHED	TP TOILET PARTITION
ADJ ADJACENT	EA EACH	ID INSIDE DIAMETER	PP POWER PANEL	TS TRANSITION STRIP
AFF ABOVE FINISHED FLOOR	EF EPOXY FLOORING	IN INCH	PR PAIR	TYP TYPICAL
AHU AIR HANDLING UNITS	EIFS EXTERIOR INSULATION	INCL INCLUDE (D) (ING)	PROJ PROJECT	TV TELEVISION
ALT ALTERNATE	FINSH FINISH SYSTEM	INSUL INSULATED(ION)	PRTN PARTITION	UG UNDERGROUND
AL ALUMINUM	INT INTERIOR	INV INVERT	PSF POUNDS PER SQUARE FOOT	UH UNIT HEATER
ANCH ANCHOR	EJ ELEVATION	JB JUNCTION BOX	PSI POUNDS PER SQUARE INCH	UNO UNLESS NOTED OTHERWISE
ANG ANGLE	EL ELEC	JT JOINT	PTD PAINTED	UNFN UNFINISHED
ANOD ANODIZED	EMERG EMERGENCY	K KIP (1,000 POUNDS)	PV PLUMBING VENT	UV ULTRA VIOLET
APPROX APPROXIMATE	ENCL ENCLOSURE	K-FT KIP FEET	PVC POLYVINYL CHLORIDE	VAMC VETERANS AFFAIRS MEDICAL
ARCH ARCHITECT	ENGR ENGINEER	KIP FEET	PVMT PAVEMENT	VT CENTER
ASSOC ASSOCIATED	EPDM EPDM	LAM LAMINATED	QT QUARRY TILE	VERT VERTICAL
BOT BOTTOM	EQ EQUIP	LAV LAVATORY	QTY QUANTITY	VCT VINYL COMPOSITION TILE
B.O. BOTTOM OF	EWC ELECTRIC WATER COOLER	LB(S) POUND(S)	R RADIUS	VENT VENTILATOR
BD BOARD	EWL ELECTRIC WATER HEATER	LCF LEAD COATED COPPER	RB RUBBER BASE	VFI VERIFY IN FIELD
BL BUILDING LINE	EXH EXHAUST	LF LINEAR FEET	RCB RESILIENT COVE BASE	VWC VINYL WALL COVERING
BLDG BUILDING	EXIST EXISTING	LH LEFT HAND	REF REFLECTED CEILING PLAN	W WEST
BLK'G BLOCKING	EXP EXPANSION	LL LIVE LOAD	RD ROOF DRAIN	W/ WITH
BM BEAM	EXT EXTERIOR	LLH LONG LEG HORIZONTAL	RE REFER	WO WITHOUT
BM BENCH MARK	FA FIRE ALARM	LLV LONG LEG VERTICAL	RECP RECEPTACLE	WC WATER CLOSET
BRG BEARING	FACP FIRE ALARM CONTROL PANEL	LP LIGHTING PANEL	REF REFERENCE	WD WOOD
BRK BRICK	FDN FOUNDATION	LTW LIGHTWEIGHT	RENF REINFORCE (D) (ING)	WH WATER HEATER
BSMT BASEMENT	FE FIRE EXTINGUISHER	MAS MASONRY	REQ REQUIRED	WP WATERPROOF
BUR BUILT-UP ROOFING	FEC FIRE EXTINGUISHER CABINET	MAX MAXIMUM	RESIL RESILIENT	WPT WORK POINT
CAB CABINET	FF FINISHED FLOOR	MCS MARMOLEUM COMPOSITE	REV REVISIONS, REVISED	WRK WATER RESISTANT
CB CATCH BASIN	FG FINISHED GRADE	MDP MECHANICAL DISTRIBUTION PANEL	RO ROUGH OPENING	WSTC WAINSCOT
CF CONTRACTOR FURNISHED	FHC FIRE HOSE CABINET	MECH MECHANICAL	ROW RIGHT OF WAY	S SANITARY
CEM CEMENT	FL FLOW LINE	MED MEDIUM	RTU ROOF TOP UNIT	SC SCHEDULE
CFM CUBIC FEET PER MINUTE	FLASH FLASHING	MEMB MEMBRANE	RWL RAIN WATER LEADER	SD STORM DRAIN
CG CORNER GUARD	FLR(G) FLOORING	MTL METAL	RV ROOF VENT	SECT SECTION
CI CONTRACTOR INSTALLED	FLUOR FLUORESCENT	MFR MANUFACTURER	S SOUTH	SERV SERVICE
CJ CONTROL JOINT	FO FACE OF	MH MANHOLE	SAN SANITARY	SF SQUARE FEET
CLG CEILING	FPR FIRE PROOF	MIN MINIMUM	SCHED SCHEDULE	SHT SHEET
CLR CLEAR	FR FIBER REINFORCED PANEL	MISC MISCELLANEOUS	SD STORM DRAIN	SIM SIMILAR
CMU CONCRETE MASONRY UNIT	FT FOOTING	MNO MASONRY OPENING	SECT SECTION	SOV SPRAY ON VINYL
CO CLEAN OUT	FURN FURNISH(ED)	MTD MOUNTED	SERV SERVICE	SPEC SPECIFICATIONS
COL COLUMN	FWC FABRIC WALL COVERING	N NORTH	SQ SQUARE FEET	SS SOLID SURFACE
CONC CONCRETE	GA GAUGE, GAGE	NIC NOT IN CONTRACT	SHIT SHEET	SSTL STAINLESS STEEL
CONN CONNECTION	GALV GALVANIZED	NO. NUMBER	SIM SIMILAR	STD STANDARD
CONST CONSTRUCTION	GC GENERAL CONTRACTOR	NOM NOMINAL	SOV SPRAY ON VINYL	STL STEEL
CONT CONTINUOUS	GFI GROUND FAULT INTERRUPTER	NTS NOT TO SCALE	SPEC SPECIFICATIONS	STOR STORAGE
CONTR CONTRACTOR	GYP GYPSUM	OC ON CENTER(S)	SS SOLID SURFACE	STRUC STRUCTURAL
COTR CONTRACTING OFFICER	HB HOSE BIBB	OD OUTSIDE DIAMETER	SSTL STAINLESS STEEL	SUSP SUSPENDED
CTP TECHNICAL REPRESENTATIVE	HC HOLLOW CORE	OF OWNER FURNISHED	STD STANDARD	SYM SYMMETRICAL
CR CARPET TILE	HDWD HARDWOOD	OPP OPPOSITE	STL STEEL	SYST SYSTEM
CR CERAMIC TILE		OZ OUNCE	STOR STORAGE	
CTR CENTER		PA PROJECT ARCHITECT	STRUC STRUCTURAL	
CU CONDENSING UNIT		PERF PERFORATED	SUSP SUSPENDED	
CUH CABINET UNIT HEATER*			SYST SYMMETRICAL	
CUSP CUPBOARD				
CW COLD WATER				
DBL DOUBLE				
DET DETAIL				
DF DRINKING FOUNTAIN				
DIA DIAMETER				
DIM DIMENSION				


GENERAL NOTES

- A. THE GENERAL CONTRACTOR SHALL BE RESPONSIBLE FOR ALL PROJECT COORDINATION AND FOR PROVIDING ALL MATERIAL AND LABOR REQUIRED FOR THE COMPLETION OF THE PROJECT.
- B. THE GENERAL CONTRACTOR SHALL FOLLOW AND OBEY ALL FEDERAL, STATE AND LOCAL CODES, LAWS, SAFETY REGULATIONS AND HAZARDOUS WASTE LAWS, ETC.
- C. CONTRACTORS SHALL VERIFY DIMENSIONS PRIOR TO INITATING CONSTRUCTION AND DEMOLITION
- D. DIMENSIONS ARE TAKEN TO FACE OF FINISH WALL, STONE, MASONRY, OR EXISTING WALL FINISH UNLESS NOTED OTHERWISE.
- E. CONTACT THE ARCHITECT FOR DETERMINATION OF A REQUIRED DIMENSION THAT IS NOT INDICATED ON THE DRAWINGS. DO NOT SCALE DRAWINGS.
- F. BUILDING GROUND FLOOR LEVEL FLOOR REFERENCE ELEVATION IS 0'-0"
- G. ALL WORK SHALL BE PERFORMED IN A SKILLED WORKMANSHIP TYPE MANNER ACCEPTABLE TO THE ARCHITECT AND RESIDENT ENGINEER.
- H. PROVIDE SEALANT JUNCTURES BETWEEN DIFFERENT MATERIALS, UNLESS NOTED OTHERWISE.
- J. ALL SURFACES AND SUBSTRATES SHALL BE PREPARED FOR INSTALLATION PER MANUFACTURERS RECOMMENDED INSTRUCTIONS, UNO.
- K. PROVIDE ALL LOCKING (WOOD OR 16 G.A. GALVANIZED SHEET METAL) AS REQUIRED FOR THE ATTACHMENT OF MISCELLANEOUS EQUIPMENT INCLUDING BUT NOT LIMITED TO: TOILET ACCESSORIES, DOOR HARDWARE, ELECTRICAL DEVICES, KITCHEN EQUIPMENT, GRAB BARS, HAND RAILS, AND CASEWORK.
- L. THE GENERAL CONTRACTOR SHALL BE RESPONSIBLE FOR FINAL CLEAN UP FOLLOWING EACH PHASE AND UPON COMPLETION.
- M. NO UTILITY SERVICE INTERRUPTION SHALL OCCUR WITHOUT THE PRIOR WRITTEN APPROVAL OF THE COTR. ALL REQUEST FOR UTILITY SERVICE INTERRUPTION SHALL INCLUDE A COMPLETED "UTILITY SYSTEMS SERVICE/OUTAGE NOTIFICATION" FORM. ALL UTILITY SERVICE INTERRUPTIONS SHALL OCCUR AFTER NORMAL HOURS OF MEDICAL CENTER OPERATION. ALL UTILITY SERVICE INTERRUPTION PROCEDURES SHALL COMPLY WITH THE GENERAL REQUIREMENTS SPECIFICATIONS.
- N. PROVIDE CONTROL JOINT IN ALL GYPSUM BOARD WALLS GREATER THAN 30' LONG. PLACE CONTROL JOINTS AT CORNERS OF DOORS OR WINDOWS.

GRAPHIC SYMBOLS

NOT ALL SYMBOLS ARE USED.

Room name		Room name & number
101		ROOM NAME & NUMBER
101A		DOOR NUMBER
A.0		PLAN NOTES
11		WINDOW NUMBER
0		COLUMN GRID
1		REVISION
ARC 1		FINISH CALLOUT
A		WALL TAG
1	Title	TITLE
A1.01	1/8" = 1'-0"	
DRAWING #	1	
SHEET #	A-201	BUILDING ELEVATION
DRAWING #	1/A101	INTERIOR ELEVATION
DRAWING #	1	SECTION
SHEET #	A101	LEVEL / FLOOR
	NAME	
	ELEVATION	

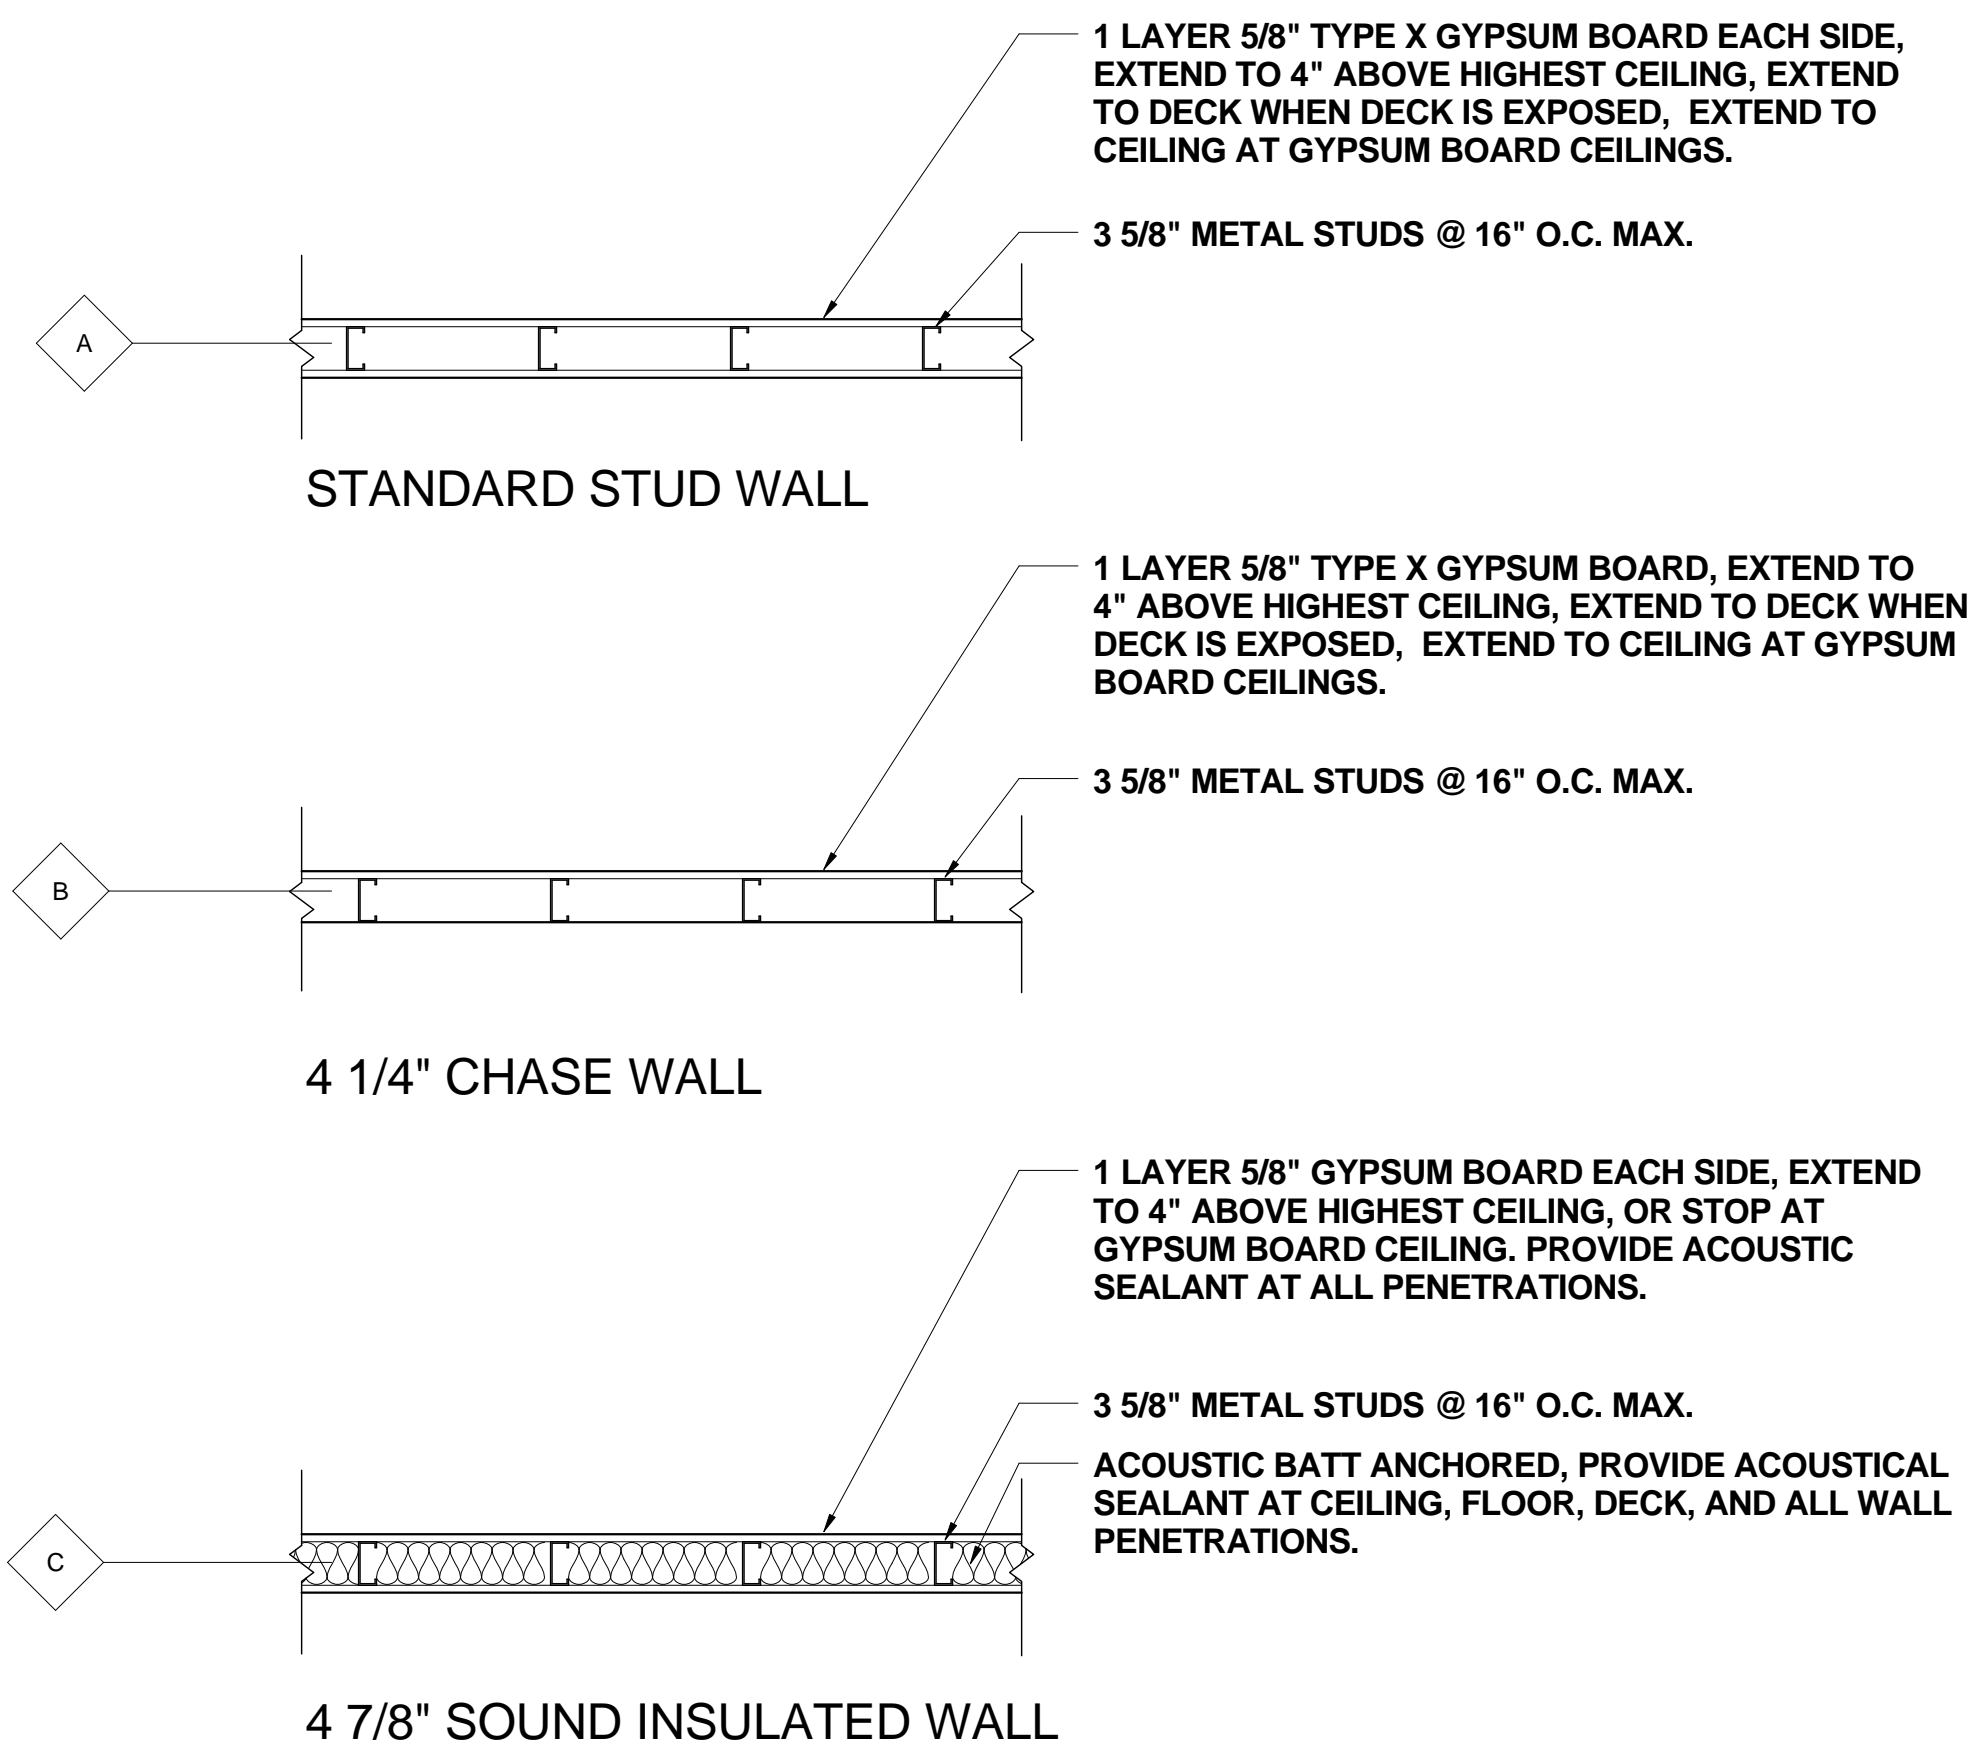


	POURED CONCRETE		BATT INSULATION
	PRE CAST CONCRETE		RIGID INSULATION
	BLOCK		EIFS
	BRICK		GRAVEL/FILL
	EARTH		CUT STONE
	GYPSUM BOARD		PLASTER
	ROUGH WOOD		PARTICAL BOARD
	PLYWOOD		STRUCTURAL STEEL
	FINISHED WOOD		
	NEW WALLS		


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BID DOCUMENTS


MEP / HVAC DESIGN	BCCLT, Inc.	MEP ENGINEERS 801 MAIN STREET SHELBYVILLE, KY 40065 T:502-633-1506	BCCLT Bligh, Chance, Cummins, London, Titzer CONSULTING ENGINEERS
Revisions:	Date:		
PROJECT LEADER/ARCHITECT:		GUIDON DESIGN	
2453 N. DELAWARE ST. INDIANAPOLIS, IN. 46205 317.800.6388 WWW.GUIDONDESIGN.COM		SUSTAINABLE ARCHITECTURE + ENGINEERING	
Drawing title GENERAL INFORMATION		Project title RENOVATE PROSTHETICS	
Approved for Design Concept: 		Location LEXINGTON VAMC LD	
Date 2/21/2013		Checked By: STW	
		Drawn By: ARO	
		Building Number Bldg-1	
		Drawing Number GI100	
		VETERANS ADMINISTRATION MEDICAL CENTER	
		Department of Veterans Affairs	

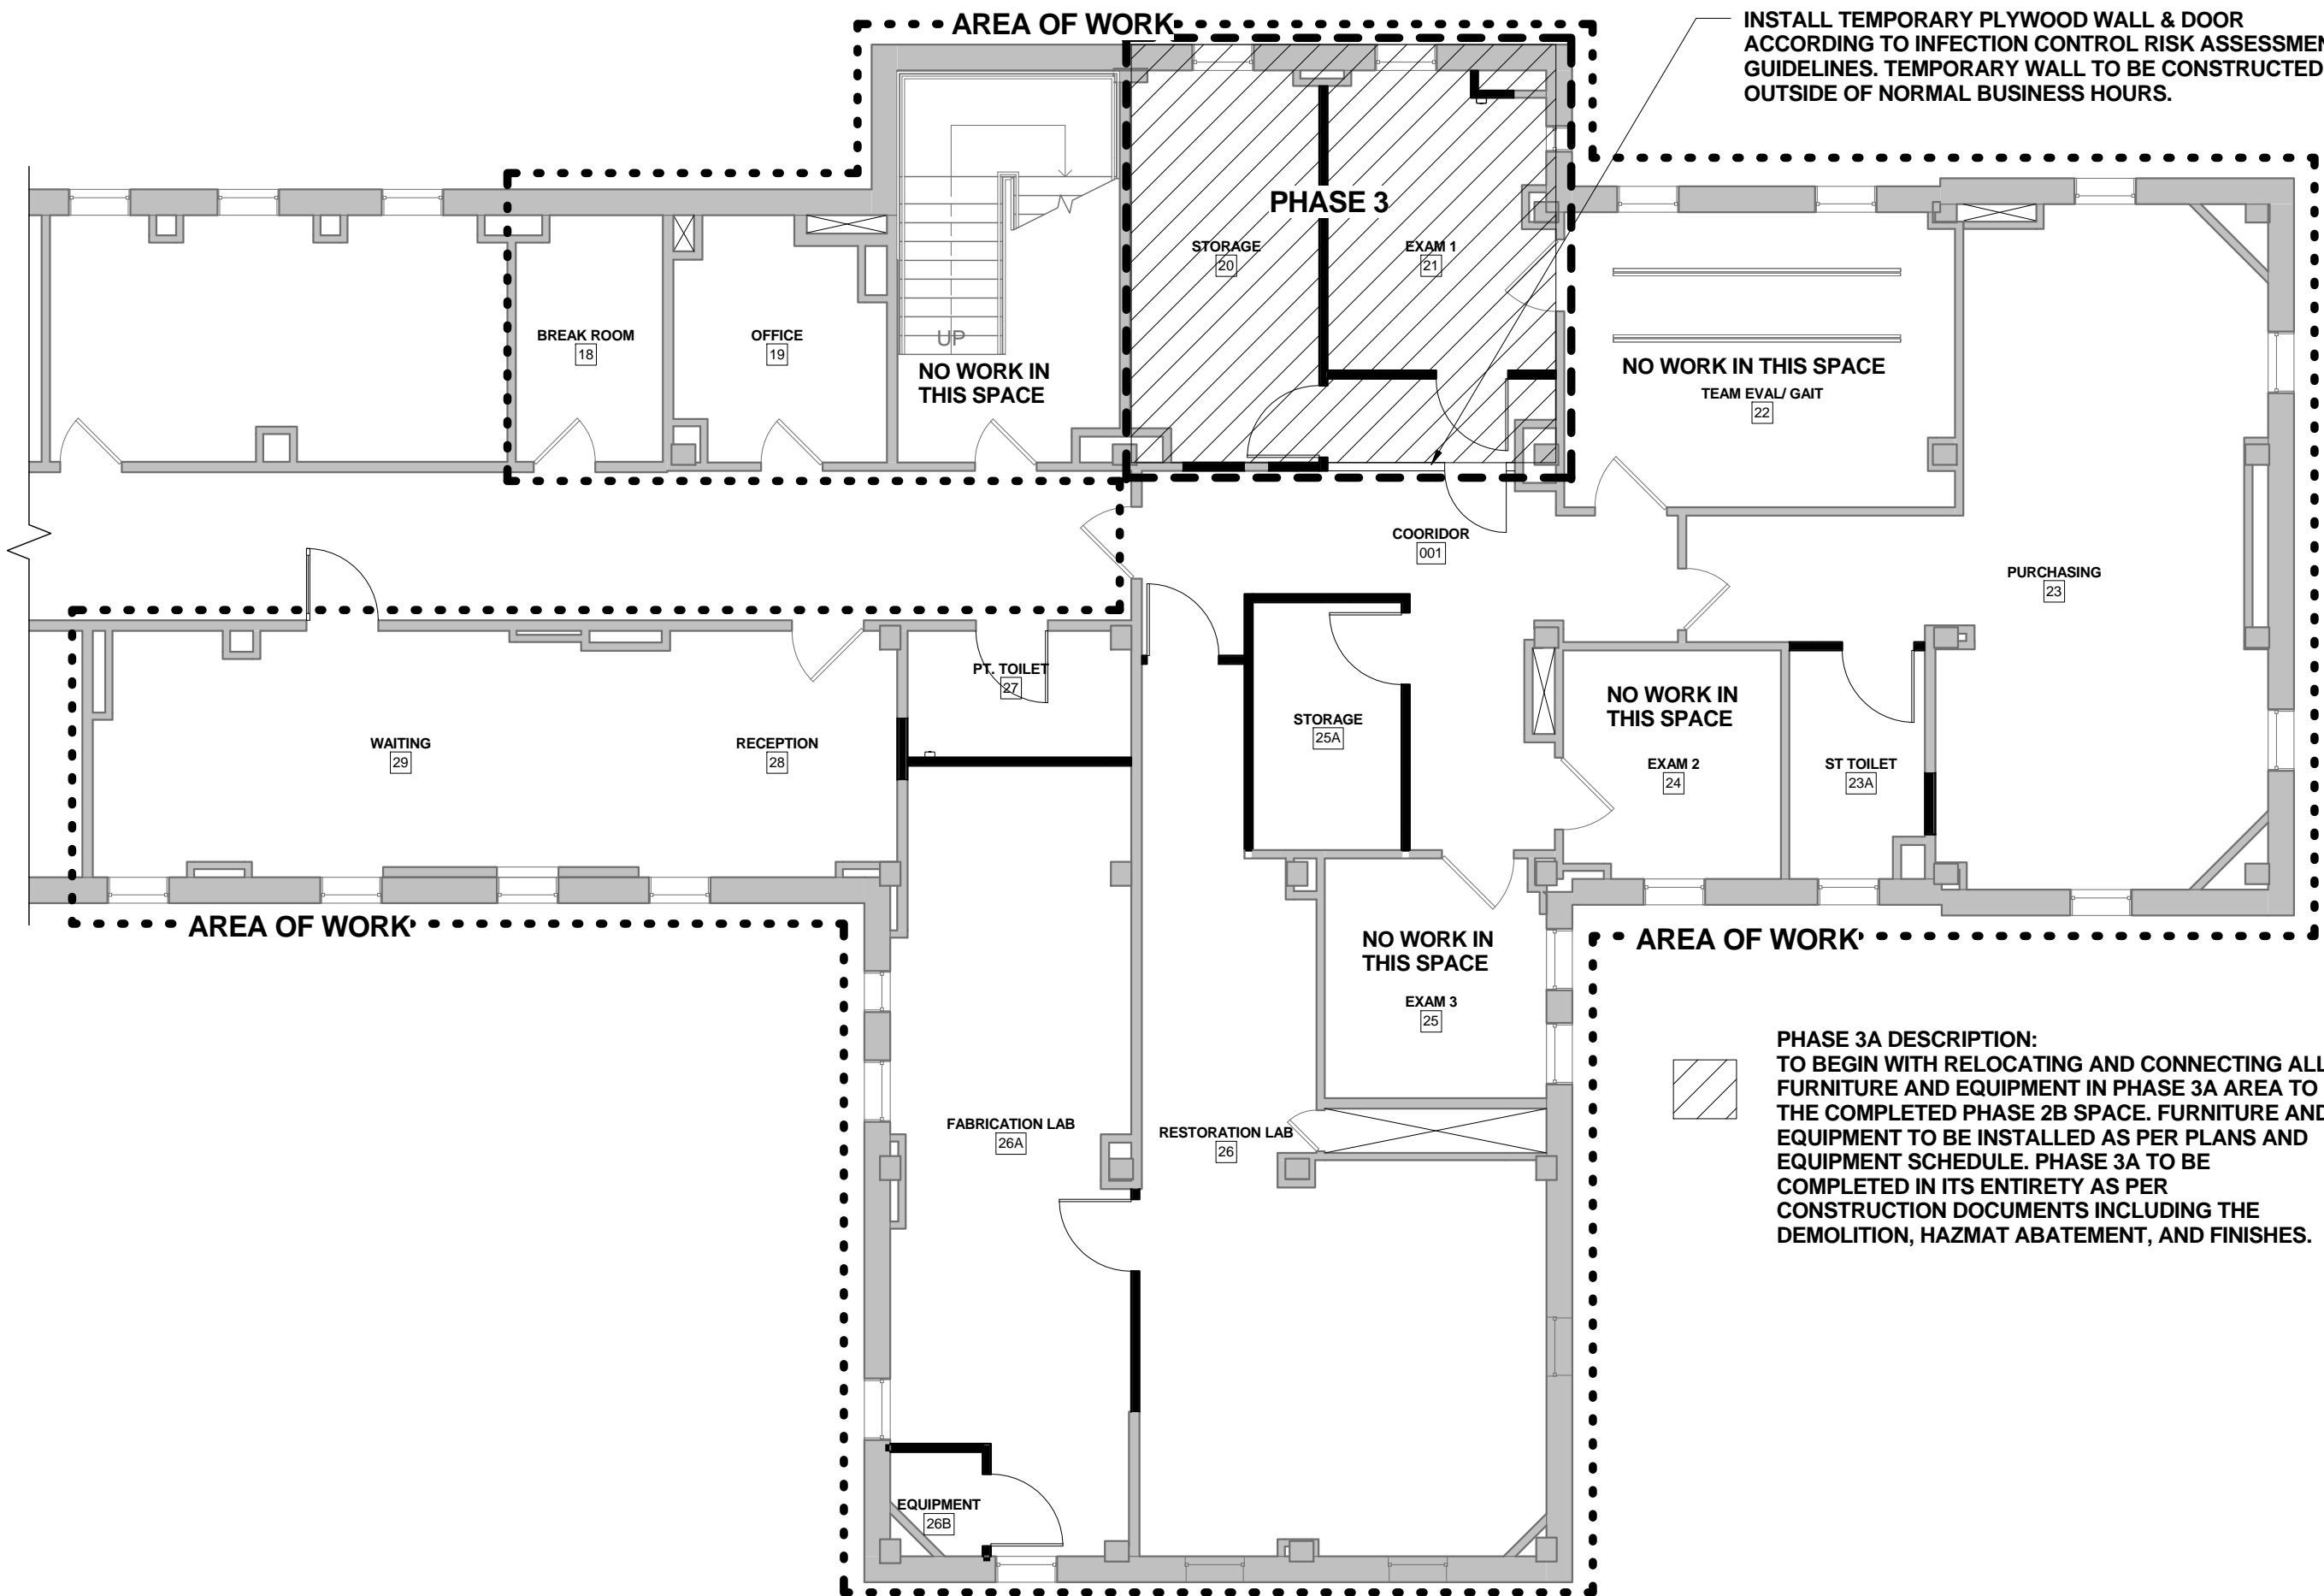


3 PHASE 3A PLAN
GI101 1/8" = 1'-0"

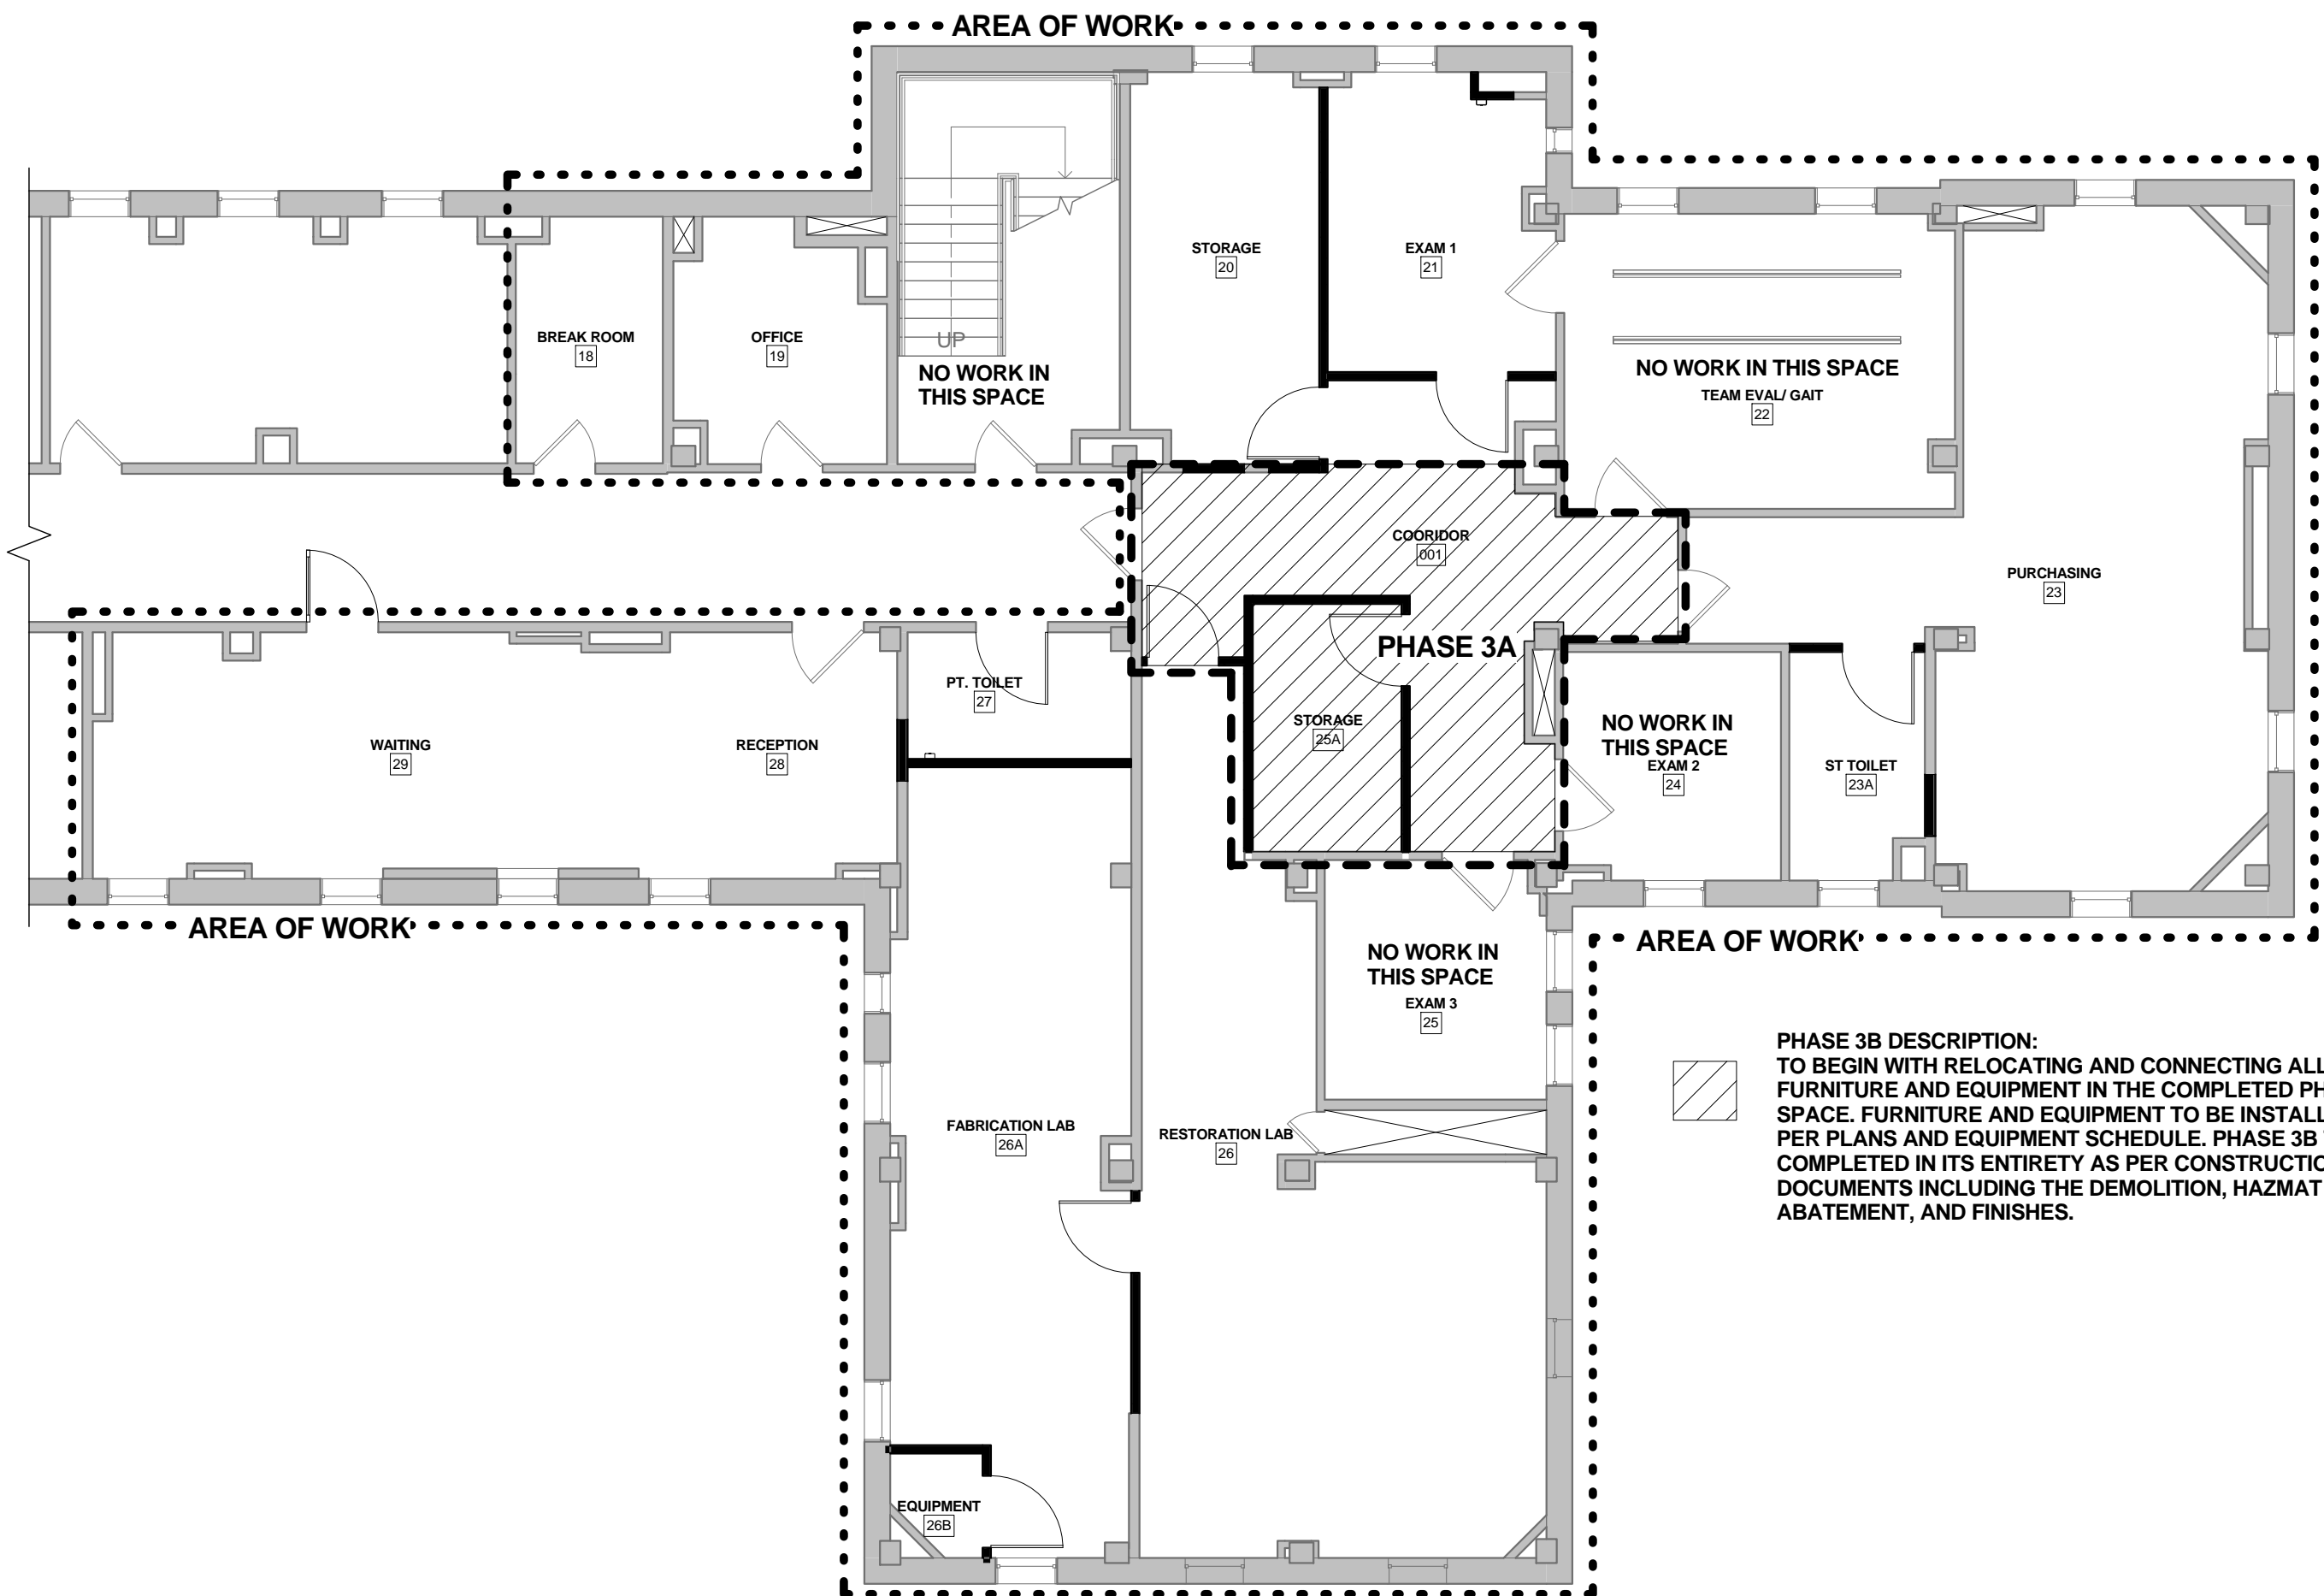

4 PHASE 3B PLAN
GI101 1/8" = 1'-0"

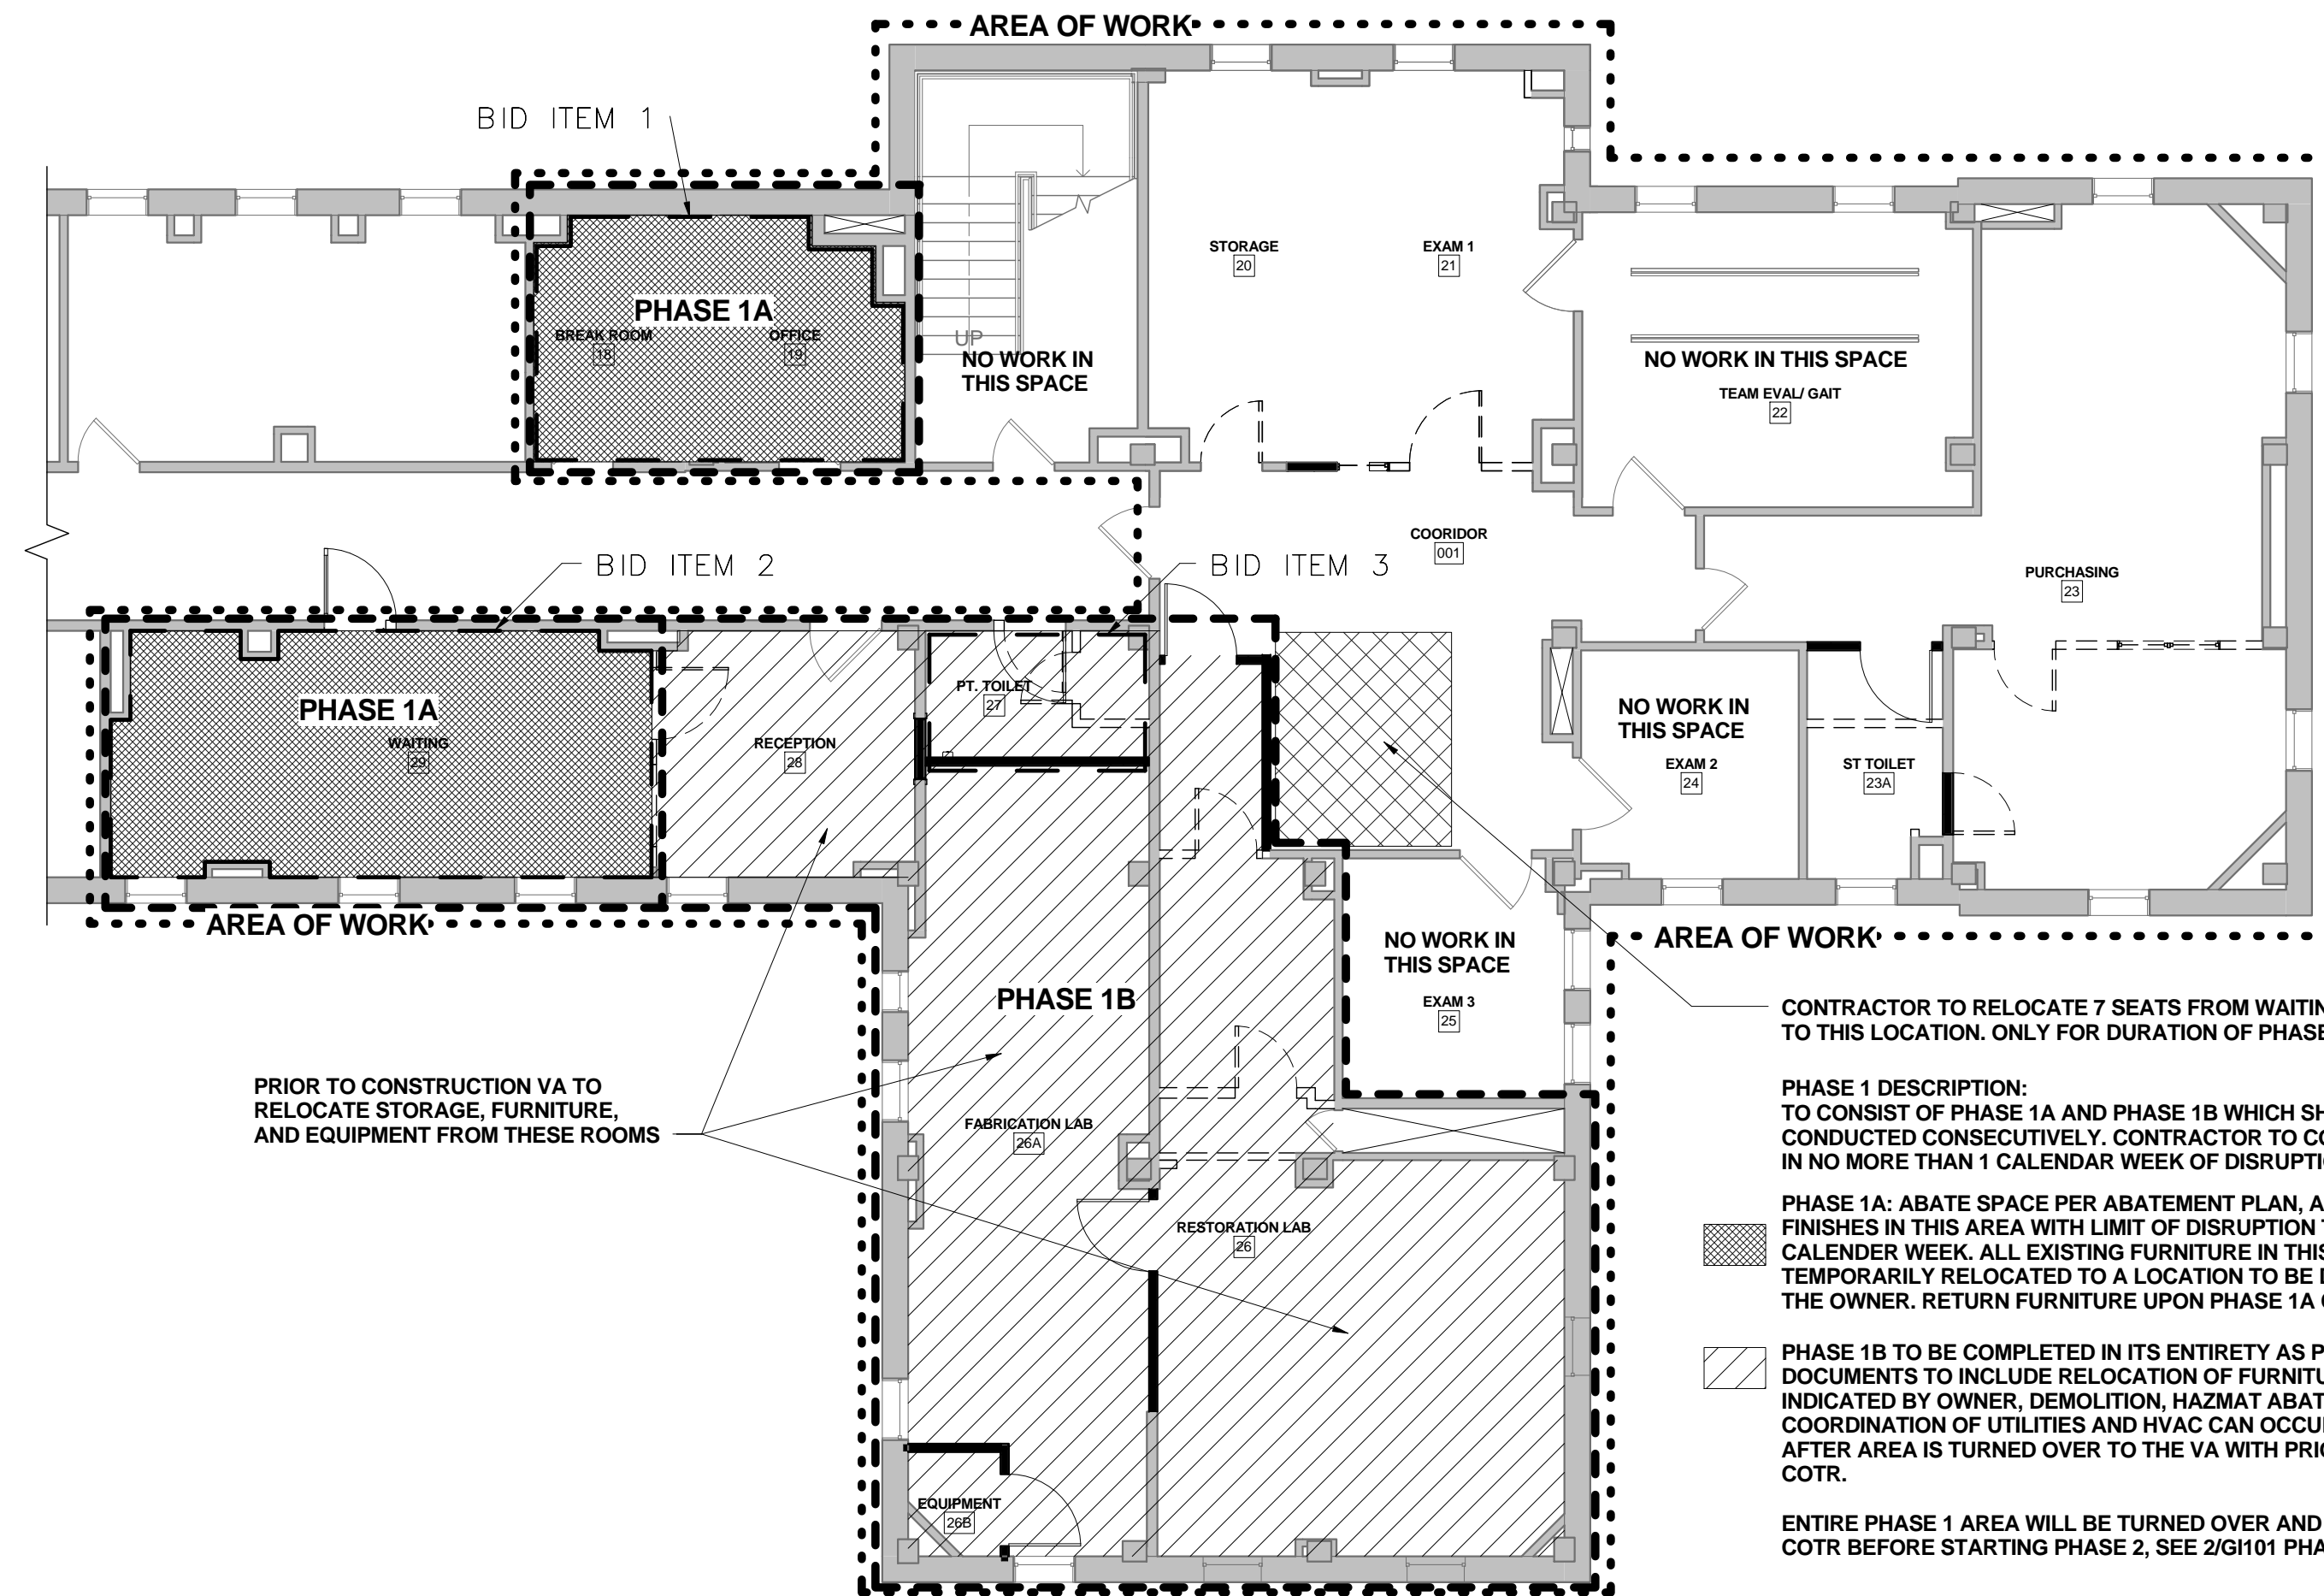

1 PHASE I A&B PLAN
GI101 1/8" = 1'-0"

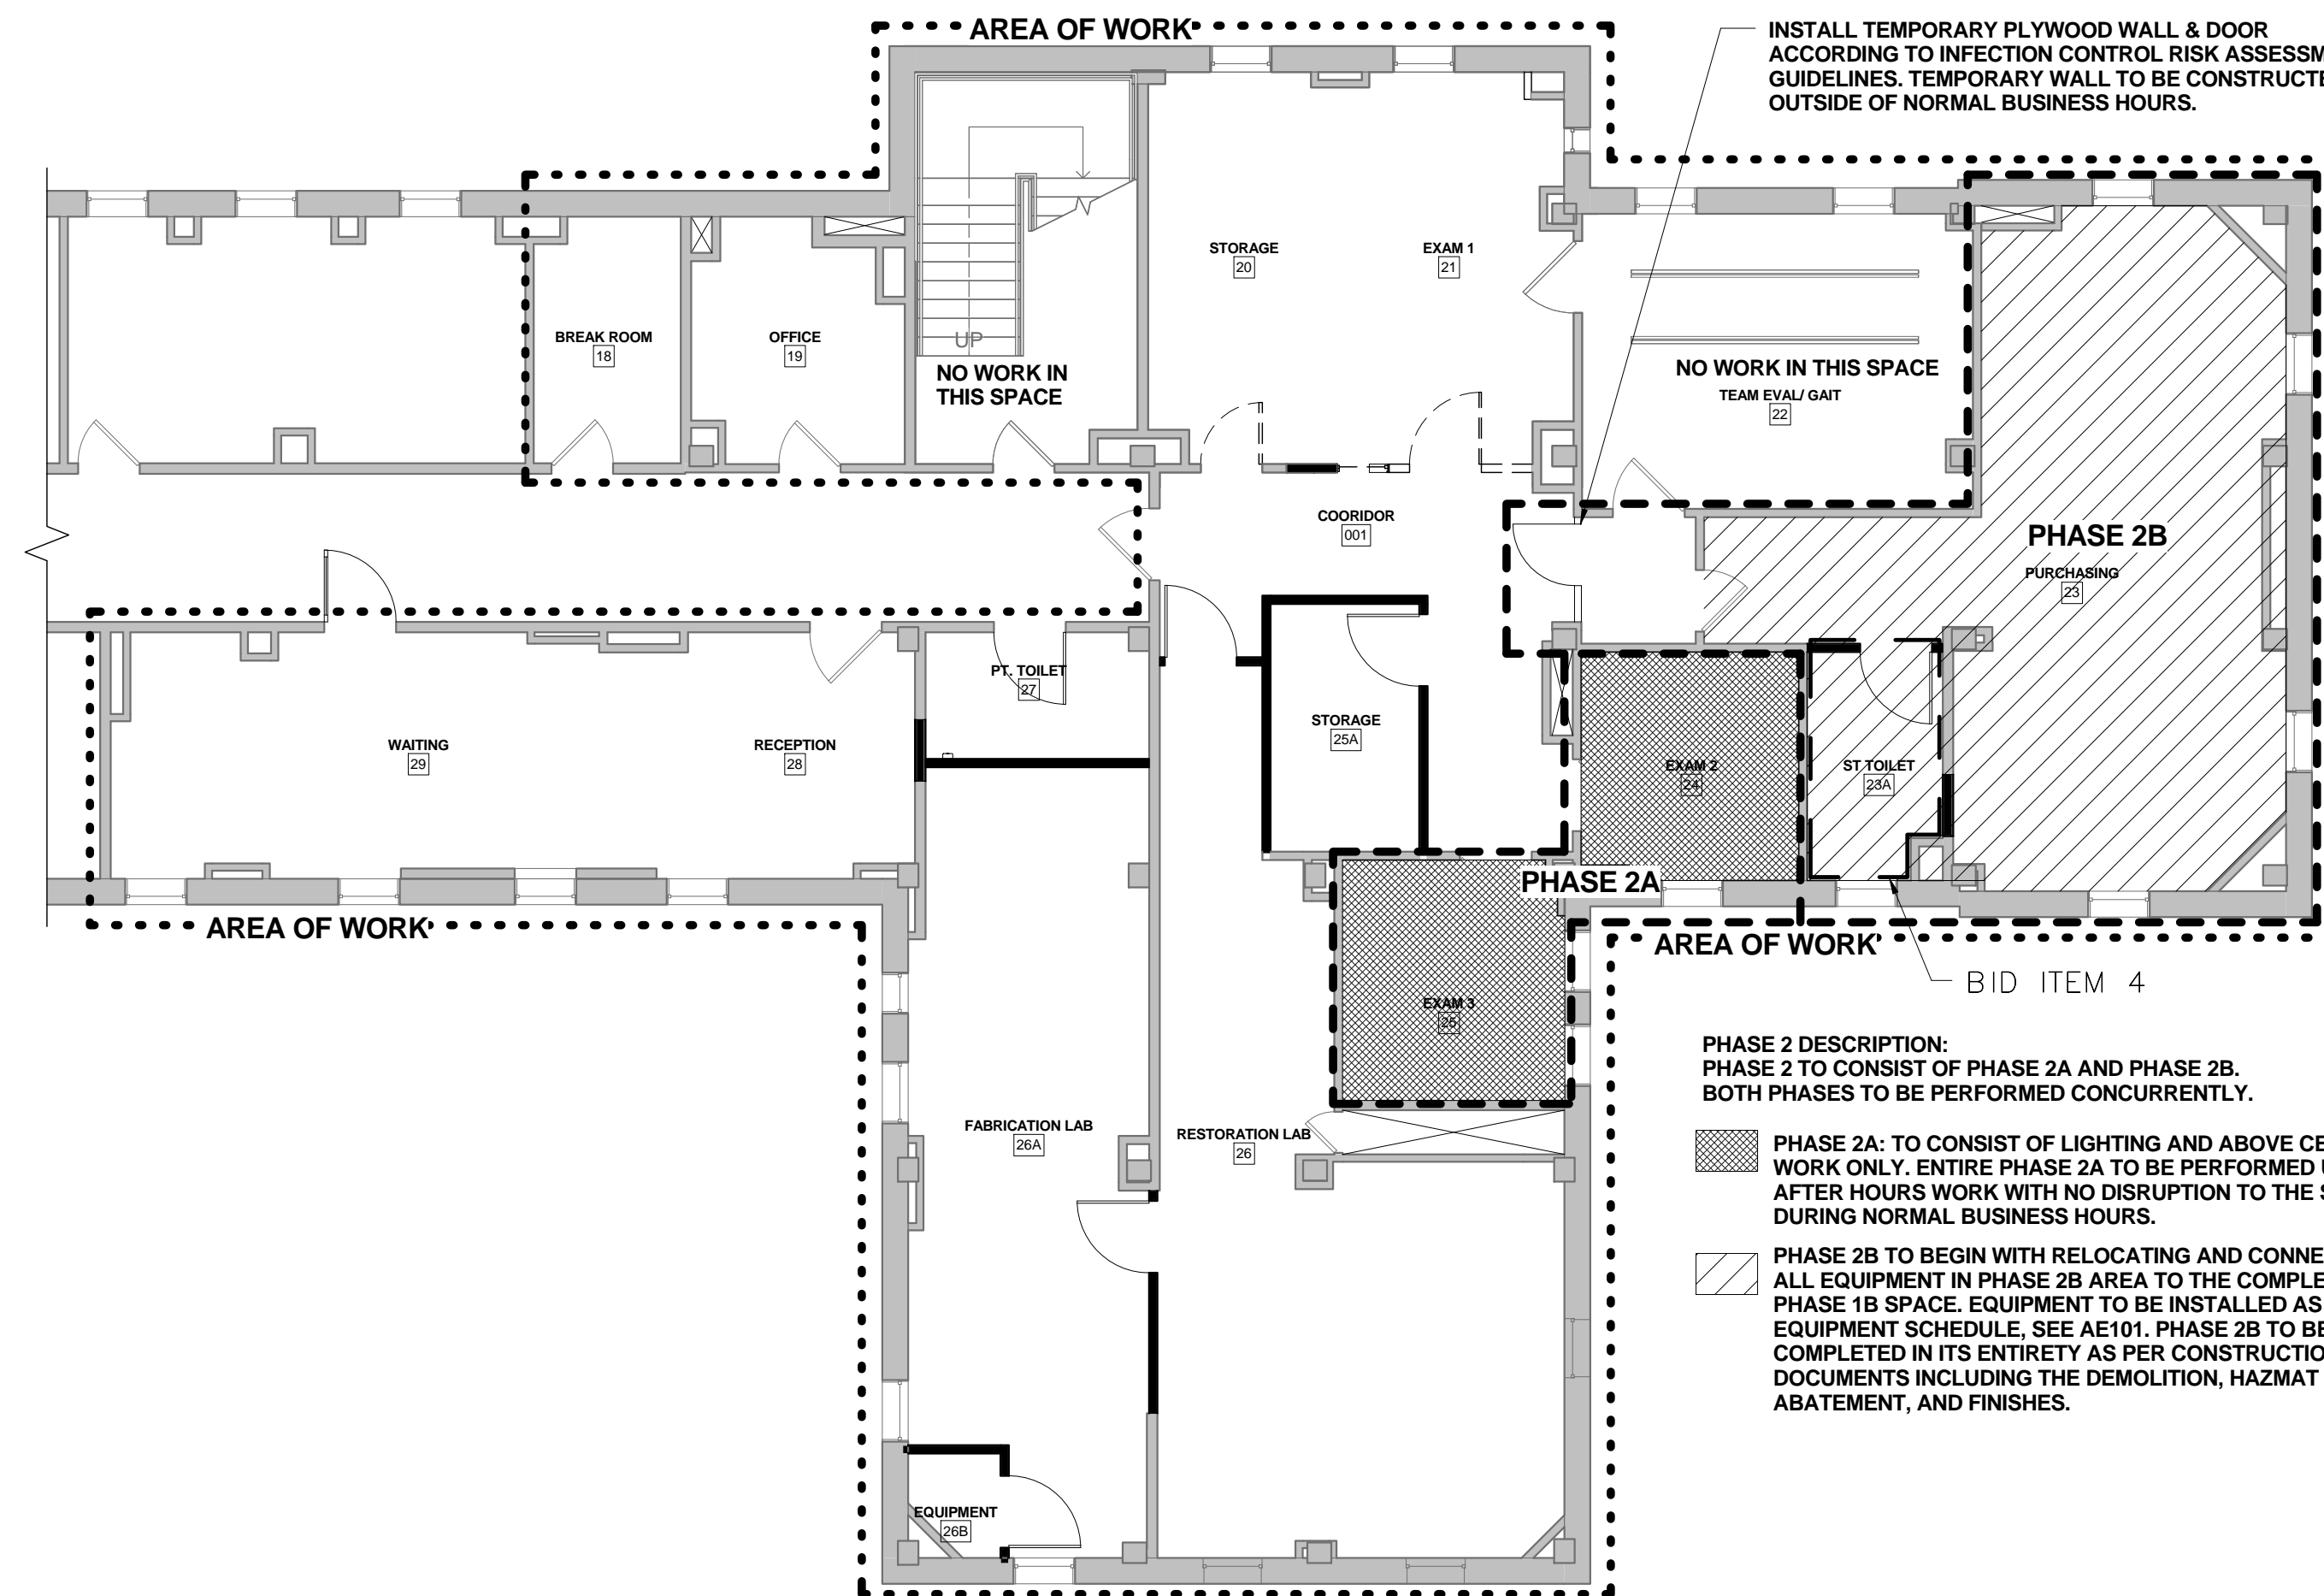

2 PHASE 2 A&B PLAN
GI101 1/8" = 1'-0"

BID ITEMS:

REF: TO SPECIFICATION SECTION 01 23 00 FOR COMPLETE DESCRIPTION OF BID ITEMS

PHASING LEGEND:

- PHASE
- SUPPLEMENTARY PHASE
- LIMITS OF WORK
- PHASE BOUNDARY
- DEMO WALLS, WINDOWS, DOORS, ETC.
- EXISTING WALLS TO REMAIN
- EXISTING WALLS TO REMAIN
- EXISTING DOOR TO REMAIN

FULLY SPRINKLERED

BID DOCUMENTS

MEP / HVAC DESIGN BCCLT, Inc. www.BCCLT.com MEP ENGINEERS 801 MAIN STREET SHELBYVILLE, KY 40065 T:502-633-1506 BCCLT Bligh, Chance, Cummins, London, Titze CONSULTING ENGINEERS			PROJECT LEADER/ARCHITECT: GUIDON DESIGN 2453 N. DELAWARE ST. INDIANAPOLIS, IN. 46205 317.800.6388 WWW.GUIDONDESIGN.COM SUSTAINABLE ARCHITECTURE + ENGINEERING	Drawing title PHASING PLAN Approved for Design Concept: 	Project title RENOVATE PROSTHETICS Location LEXINGTON VAMC LD Date 2/21/2013 Checked By: STW Drawn By: ARO	Project Number 596-12-103 Building Number Bldg-1 Drawing Number GI101	VETERANS ADMINISTRATION MEDICAL CENTER
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HA101

HAZMAT REMOVAL NOTES

NOTE

SCOPE OF ASBESTOS & HAZMAT REMOVAL:

H.1

ASBESTOS MASTIC UNDER NON-ACM FLOOR TILE OF THIS ROOM.

H.2

FLUORESCENT LIGHT TUBES AND BALLAST OF THIS ROOM.

NOTE:


HAZMAT REMOVAL NOTES APPLY TO ENTIRE ROOMS. CONTRACTOR SHALL IDENTIFY ALL MATERIALS DESCRIBED BY NOTE IN EACH ROOM AND REMOVE ACCORDING TO SAFETY STANDARDS.

HAZARDOUS MATERIALS SURVEY HAS BEEN PROVIDED FOR DEMOLITION AND CONSTRUCTION. ALL HAZARDOUS MATERIALS WILL BE REMOVED IN COMPLIANCE WITH APPLICABLE CODES AND LAWS. REF: SPECIFICATION 028211

THE CONTRACTOR IS RESPONSIBLE TO VERIFY THE HAZARD(S) AND LEVEL OF PROTECTION REQUIRED FOR ALL EMPLOYEES OR SUBCONTRACTORS TO COMPLETE THE CONSTRUCTION WORK.

COORDINATE WITH PHASING PLANS SHEET GH101.

ALL H.1 REMOVAL TO BE COMPLETED IN PHASE 1.

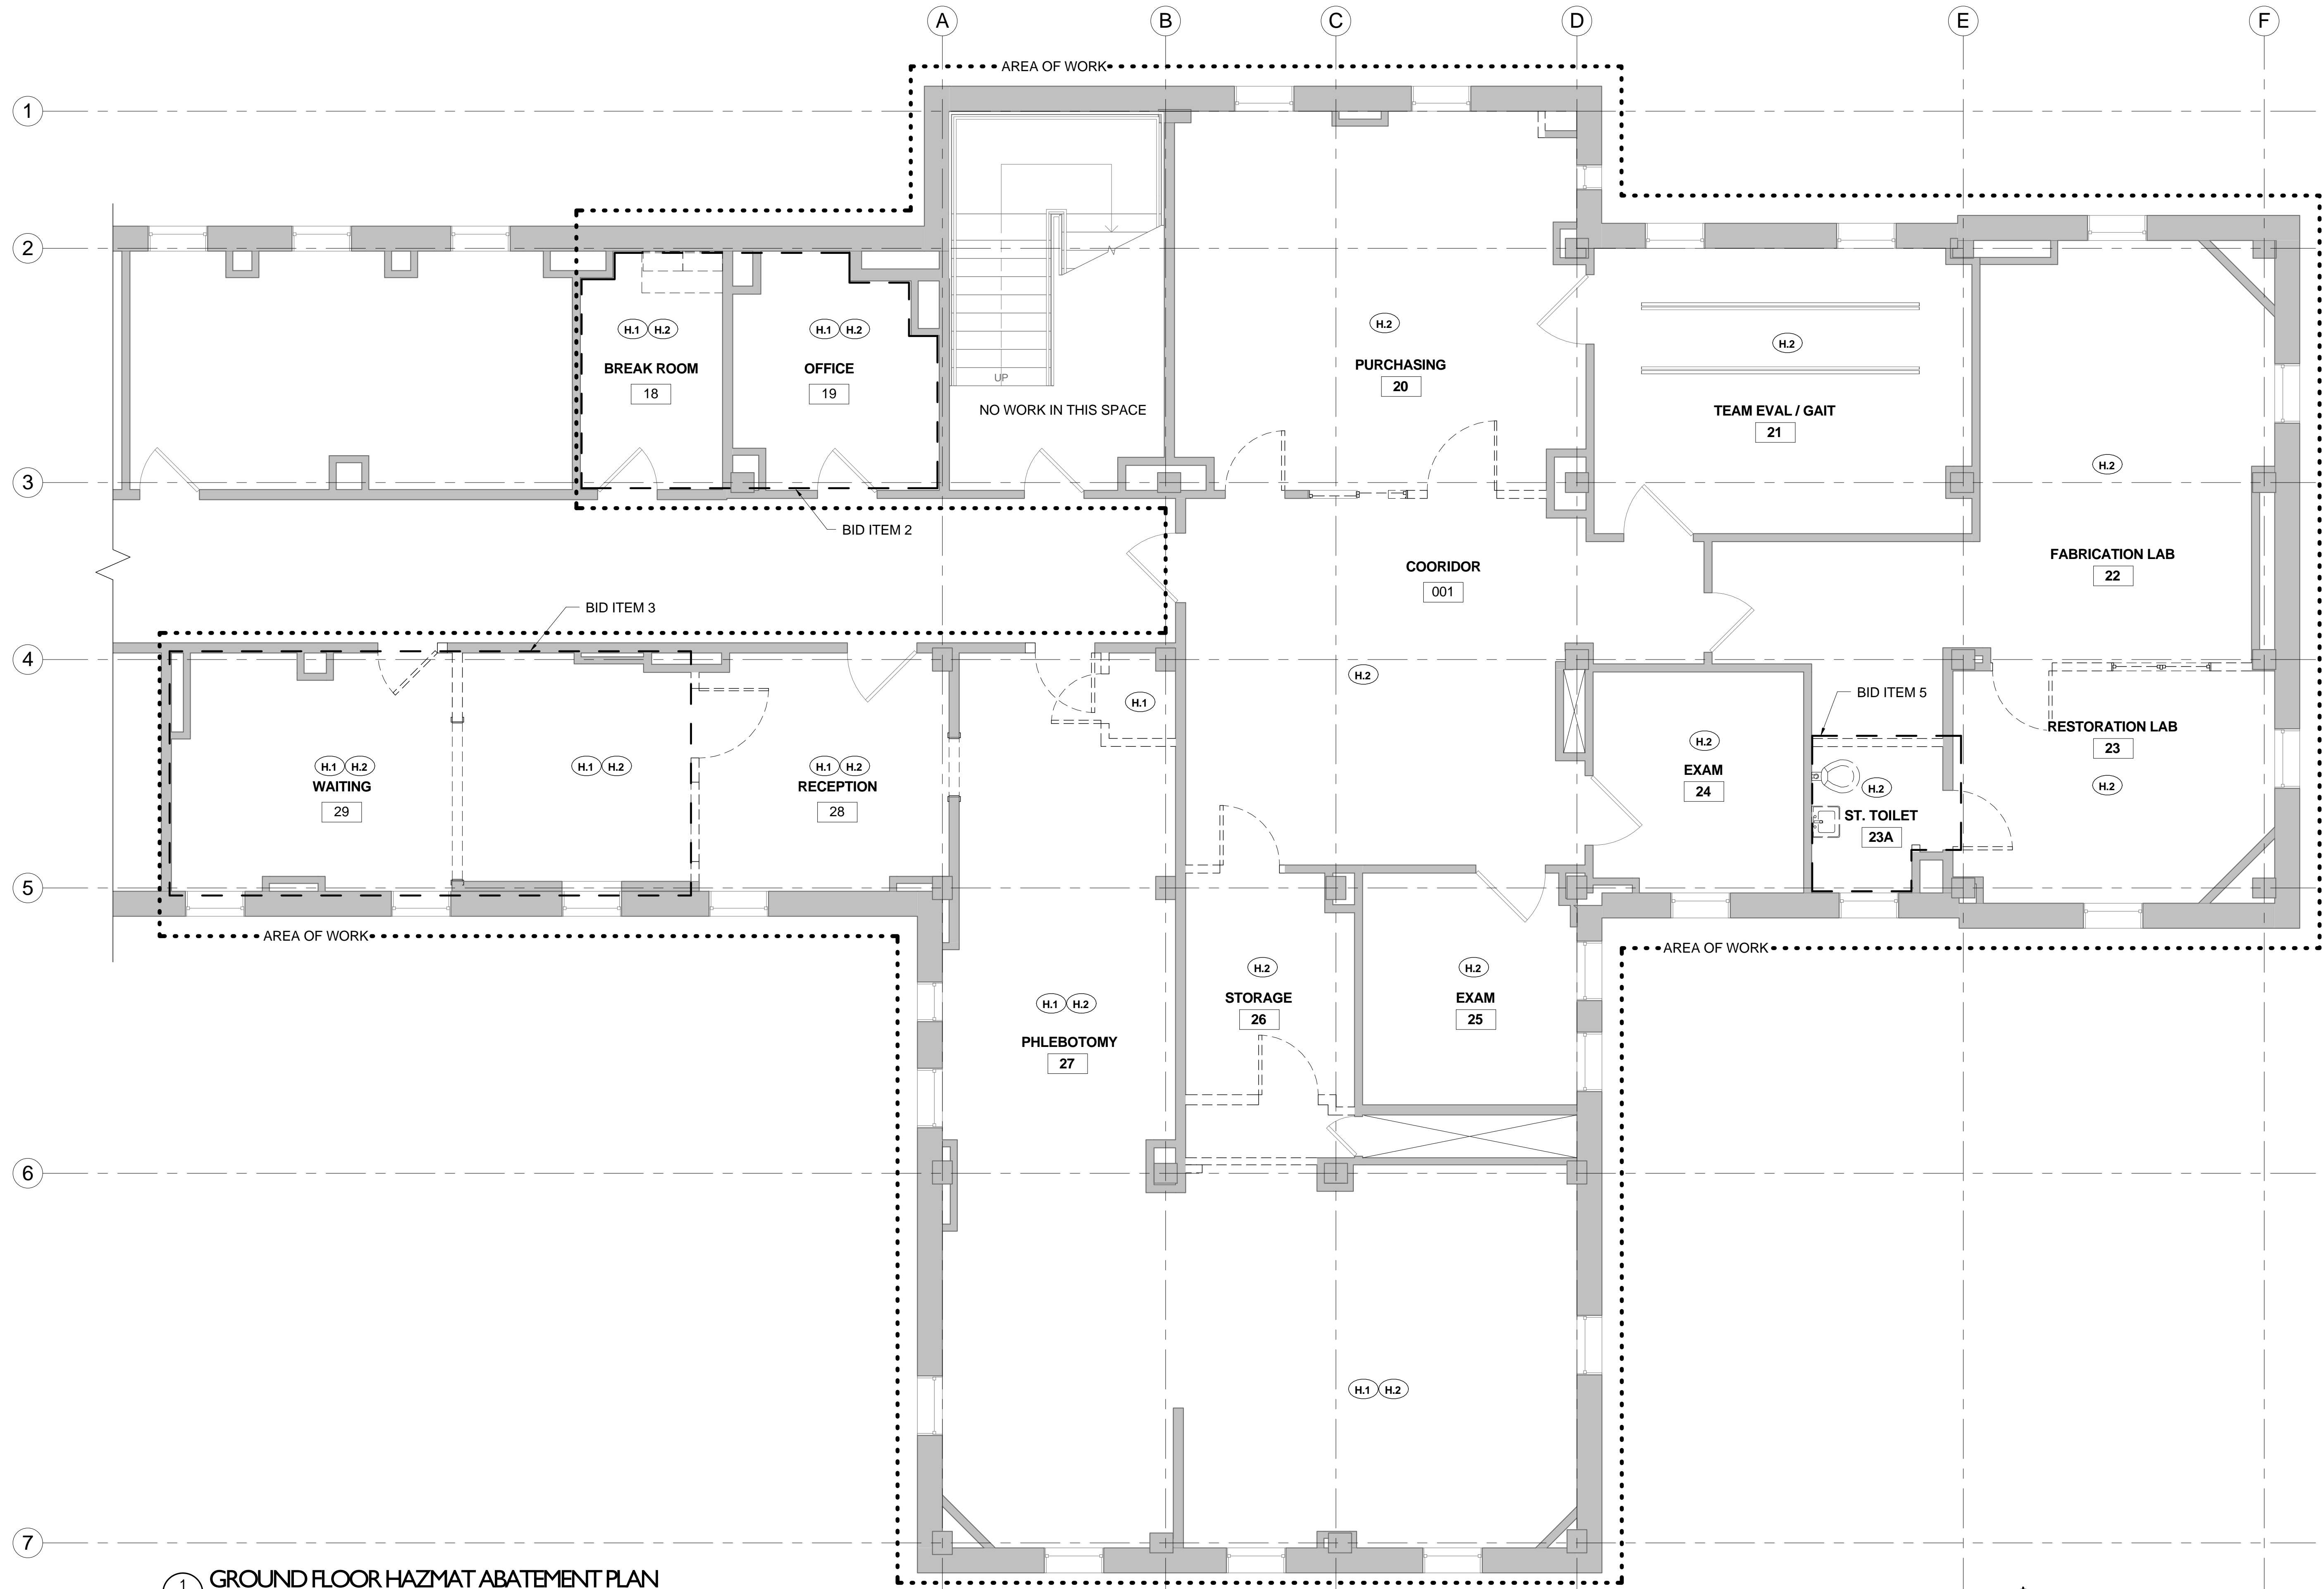

1
HA101
GROUND FLOOR HAZMAT ABATEMENT PLAN
1/4" = 1'-0"

BID ITEMS:

REF: TO SPECIFICATION SECTION 01 23 00 FOR COMPLETE DESCRIPTION OF BID ITEMS

BID 1: BASE BID

BID 2: DO NOT ABATE AREA INDICATED

BID 3: DO NOT ABATE AREA INDICATED

BID 4: NO CHANGE IN WORK INDICATED ON THIS SHEET

BID 5: DO NOT ABATE AREA INDICATED

ABATEMENT LEGEND

WALLS, WINDOWS, DOORS, ETC. REMOVED IN DEMOLITION

EXISTING WALLS TO REMAIN

EXISTING DOOR TO REMAIN

EXISTING WINDOW TO REMAIN

MEP / HVAC DESIGN

BCCLT, Inc.

www.BCCLT.com

INDUSTRIAL HYGIENISTS

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KENTUCKY ASBESTOS PROJECT
DESIGNER LICENSE D12-06-1371

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Bligh, Chance, Cummins, London, Titze
CONSULTING ENGINEERS

USFin

PROJECT LEADER/ARCHITECT:

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SUSTAINABLE ARCHITECTURE + ENGINEERING

APPROVED FOR DESIGN CONCEPT:

DRAWING TITLE

ABATEMENT PLAN

Project Title

RENOVATE PROSTHETICS

Project Number

596-12-103

Building Number

Bldg-1

Location

LEXINGTON VAMC LD

Date

2/21/2013

Checked By:

STW

Drawn By:

ARO


BID DOCUMENTS

HA101

VETERANS ADMINISTRATION MEDICAL CENTER

Department of Veterans Affairs

one eighth inch = one foot
one quarter inch = one foot
three eighths inch = one foot
one half inch = one foot
three quarters inch = one foot
one inch = one foot
one and one half inches = one foot
two inches = one foot
three inches = one foot

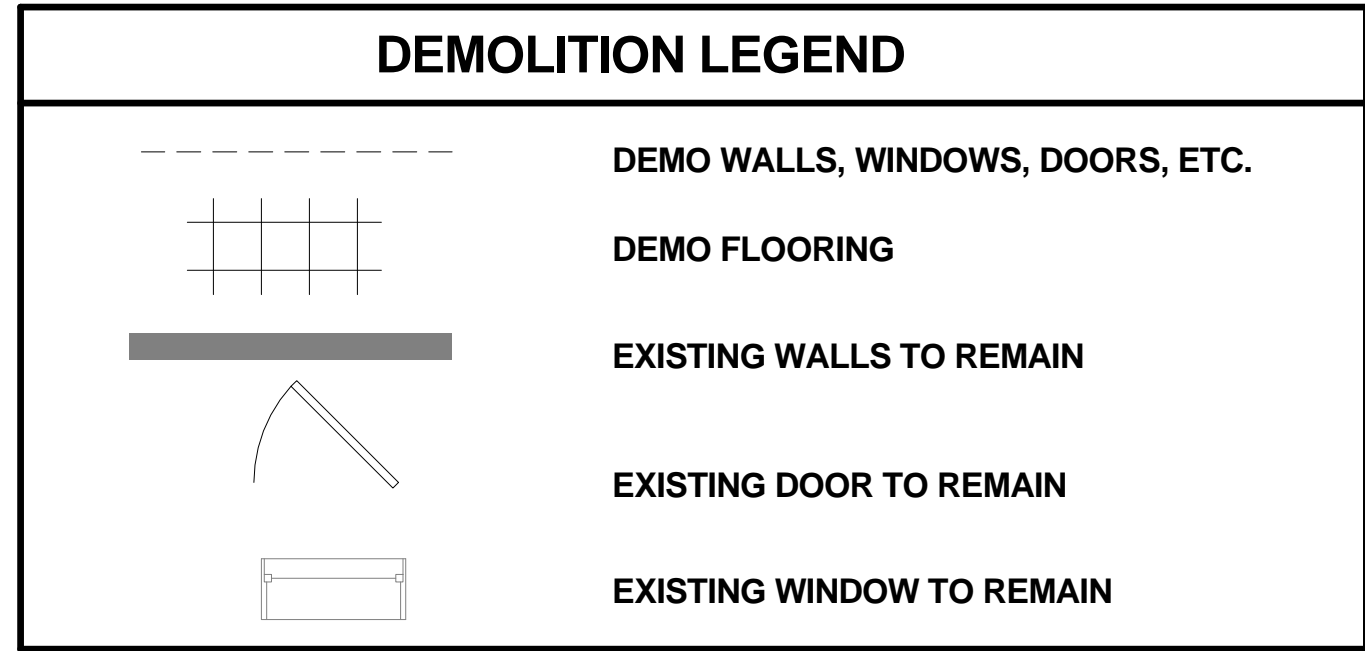

- DEMOLITION GENERAL NOTES**
- A DO NOT SCALE FROM DRAWINGS. REFER ANY DISCREPANCIES TO THE ARCHITECT FOR FINAL DECISIONS.
- B VISIT THE SITE TO BECOME FAMILIAR WITH EXISTING CONDITIONS. DEMOLITION DRAWINGS ARE FOR REFERENCE TO AID CONTRACTOR IN EVALUATION OF THE EXTENT OF THE DEMOLITION, BUT SHALL NOT BE CONSIDERED ALL-INCLUSIVE.
- C THE CONTRACTOR IS RESPONSIBLE FOR THE PROTECTION OF ALL EXISTING SURFACES, MATERIALS, COMPONENTS, ETC. TO REMAIN OR BE RELOCATED. ANY DAMAGE TO THESE RESULTING FROM PERFORMANCE OF WORK SHALL BE REPAIRED BY THE CONTRACTOR TO THE SATISFACTION OF THE OWNER AND ARCHITECT AT NO ADDITIONAL EXPENSE TO THE OWNER. CONTRACTOR TO MAINTAIN REQUIRED FIRE RATING IN ALL HORIZONTAL AND VERTICAL SURFACES DAMAGED DURING OR AS A RESULT OF DEMOLITION.
- D DEMOLITIONS SHOULD BE DONE IN ACCORDANCE TO THE CONSTRUCTION PHASING PLAN, ABATEMENT PLAN, AND COORDINATED WITH THE OWNER IN ADVANCE.
- E CONTRACTOR IS RESPONSIBLE TO RELOCATE EXISTING FURNITURE AT EACH PHASE AND RELOCATE FURNITURE AND EQUIPMENT AS INDICATED ON FLOOR PLAN AND EQUIPMENT SCHEDULE, SHEET AE101. CONTRACTOR WILL BE RESPONSIBLE FOR CONNECTING EQUIPMENT FOR OPERATION.
- F EACH TRADE CONTRACTOR IS RESPONSIBLE FOR ALL DEMOLITION WORK REQUIRED OR NOTED FOR THE INSTALLATION OF NEW WORK. COORDINATE DEMOLITION WITH ABATEMENT PLANS. DEMOLITION INCLUDES ASSOCIATED DISTRIBUTION SYSTEMS, APPURTENANCES, AND EQUIPMENT SUPPORTING CONTROLS, AND MISCELLANEOUS SUPPORTS UNLESS NOTED OTHERWISE.
- G CONTRACTOR SHALL COORDINATE CONSTRUCTION SEQUENCING AS PER PHASING PLANS WITH OWNER PRIOR TO COMMENCING ANY WORK IN EACH PHASE.
- H HAZARDOUS MATERIALS SURVEY HAS BEEN PROVIDED IN THE BID DOCUMENTS FOR DEMOLITION AND CONSTRUCTION. ALL HAZARDOUS MATERIALS WILL BE REMOVED IN COMPLIANCE WITH APPLICABLE CODES AND LAWS. REF: SHEET HA101 AND SPECIFICATION 028211
- J REMOVE AND/OR DEMOLISH ITEMS INDICATED. REMOVAL OF DEMOLISHED MATERIALS NO LONGER NEEDED BY THE OWNER SHALL BE THE RESPONSIBILITY OF THE CONTRACTOR AND SHALL BE REMOVED FROM SITE IMMEDIATELY FOLLOWING DEMOLITION, UNLESS NOTED OTHERWISE.
- K ALL UTILITY SHUTDOWNS TO OCCUR AFTER REGULAR BUSINESS HOURS AND WHEN REQUIRED BY THE COTR WILL HAVE TO BE SCHEDULED ON WEEKENDS.
- L WHEN CEILING SYSTEMS ARE REMOVED, M.E.P. TRADES SHALL COORDINATE REMOVAL OF ENGINEERING SYSTEMS WITH INSTALLATION OF NEW.
- M COMPLY WITH ALL APPLICABLE LOCAL, STATE AND FEDERAL CODES AND REGULATIONS. ALWAYS ABIDE BY THE MOST RESTRICTIVE CODE.
- N SOLID LINE INDICATES STRUCTURE AND/OR EQUIPMENT TO REMAIN. DASHED LINES INDICATE STRUCTURE AND/OR EQUIPMENT TO BE REMOVED.
- O NO UTILITY SERVICE INTERRUPTION SHALL OCCUR WITHOUT THE PRIOR WRITTEN APPROVAL OF THE COTR. ALL REQUEST FOR UTILITY SERVICE INTERRUPTION SHALL INCLUDE A COMPLETED "UTILITY SYSTEMS SERVICE/OUTAGE NOTIFICATION" FORM. ALL UTILITY SERVICE INTERRUPTIONS SHALL OCCUR AFTER NORMAL HOURS OF MEDICAL CENTER OPERATION. ALL UTILITY SERVICE INTERRUPTION PROCEDURES SHALL COMPLY WITH THE GENERAL REQUIREMENTS SPECIFICATIONS.
- P COORDINATE CONSTRUCTION COMMUNICATION AND POWER REQUIREMENTS WITH OWNER PRIOR TO CONSTRUCTION.
- Q COORDINATE DEMOLITION AND/OR RELOCATION OF FIRE PROTECTION AND LIFE SAFETY DEVICES WITH OWNER AND M.E.P. ENGINEERS.
- R REMOVE ALL ITEMS ASSOCIATED WITH DEMOLISHED WALL IF NOT NOTED OR SHOWN OTHERWISE.
- S REMOVE DUST AND DEBRIS FROM NEW EXPOSED SURFACES.
- T ALL ABOVE CEILING EQUIPMENT MUST BE MOUNTED TO STRUCTURE ABOVE PLASTER CEILING. REMOVE PLASTER CEILING AS REQUIRED.

- DEMOLITION PLAN NOTES**
- D.1 REMOVE DOOR AND FRAME
- D.2 REMOVE WALL FROM FLOOR TO FULL HEIGHT
- D.3 REMOVE WINDOW AND FRAME
- D.4 REMOVE CASED OPENING AND FRAME
- D.5 REMOVE CEILING AND CEILING ACCESSORIES
- D.6 REMOVE FINISH FLOOR AND RUBBER BASE, PREPARE SUBFLOOR TO RECEIVE NEW FINISHES. COORDINATE W/ ABATEMENT SCOPE.
- D.7 REMOVE TILE FROM FLOOR AND WALLS, REMOVE PLUMBING FIXTURES AND SALVAGE FOR REUSE. FLOOR DRAIN TO REMAIN COORDINATE WITH MEP PLANS AND ALIGN WITH NEW FLOOR FINISH.
- D.8 REMOVE PLASTER CEILING ABOVE ACT CEILING WITH THE EXCEPTION OF 2' - 0" MIN. STANDOFF FROM EXTERIOR WALLS. EXTERIOR PERIMETER CEILING IS TO REMAIN
- D.9 REMOVE MOISTURE DAMAGED PLASTER. INVESTIGATE SOURCE OF MOISTURE INFILTRATION OR LEAK AND REPORT TO ARCHITECT AND OWNER. COORDINATE FURTHER WORK WITH CONSENSUS SOLUTION.
- D.10 EXISTING CEILING TO REMAIN. REMOVE TILES AND PROTECT TO ACCESS ABOVE CEILING WORK, REPLACE ACT AT END OF PHASE WORK.
- D.11 REMOVE PLASTER CEILING ABOVE ACT CEILING WITH THE EXCEPTION OF 2' - 0" MIN. STANDOFF FROM EXTERIOR WALLS. EXTERIOR PERIMETER CEILING IS TO REMAIN PHASING AND BID OPTIONS.
- D.12 DEMOLISH CASEWORK AND PREPARE TO RECEIVE NEW CASEWORK. COORDINATE WITH PHASING AND BID OPTIONS.
- D.13 REMOVE PLUMBING FIXTURE AND ASSOCIATED PIPING COORDINATE WITH PLUMBING DEMOLITION SHEET PD101.
- D.14 DEMO EXTERIOR WALL TO INSTALL NEW EXHAUST LOUVER. REF: DETAIL 13/AE501
- D.15 DEMO METAL BOX IN WALL.

- BID ITEMS:**
- REF: TO SPECIFICATION SECTION 01 23 00 FOR COMPLETE DESCRIPTION OF BID ITEMS
- BID 1: BASE BID
- BID 2: DO NOT DEMO AREA INDICATED
- BID 3: DO NOT DEMO AREA INDICATED
- BID 4: DO NOT DEMOLISH DOOR INDICATED, EXISTING TO REMAIN.
- BID 5: DO NOT DEMO AREA INDICATED TO INCLUDE DOOR

GROUND FLOOR DEMOLITION PLAN
1/4" = 1'-0"

<p>MEP / HVAC DESIGN</p> <p>BCCLT, Inc.</p> <p>www.BCCLT.com</p>		<p>MEP ENGINEERS 801 MAIN STREET SHELBYVILLE, KY 40065 T:502-633-1506</p>		<p>BCCLT Bligh, Chance, Cummins, London, Titzer CONSULTING ENGINEERS</p>		<p>PROJECT LEADER/ARCHITECT:</p> <p>GUIDON DESIGN</p> <p>2453 N. DELAWARE ST. INDIANAPOLIS, IN. 46205 317.800.6388 WWW.GUIDONDESIGN.COM SUSTAINABLE ARCHITECTURE + ENGINEERING</p>		<p>Drawing Title</p> <p>DEMOLITION PLAN</p> <p>Approved for Design Concept:</p> <p><i>[Signature]</i></p>		<p>Project Title</p> <p>RENOVATE PROSTHETICS</p> <p>Location</p> <p>LEXINGTON VAMC LD</p> <p>Date</p> <p>2/21/2013</p>		<p>Project Number</p> <p>596-12-103</p> <p>Building Number</p> <p>Bldg-1</p> <p>Drawing Number</p> <p>AD101</p>		<p>VETERANS ADMINISTRATION MEDICAL CENTER</p> <p>Department of Veterans Affairs</p>	
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CODE REVIEW

1. THE 2009 EDITION OF THE LIFE SAFETY CODE, NFPA 101 AND THE FIFTH EDITION OF THE DEPARTMENT OF VETERANS AFFAIRS FIRE PROTECTION DESIGN MANUAL HAVE BEEN USED TO REVIEW THE ABOVE REFERENCED PROJECT FOR COMPLIANCE WITH THE FIRE AND LIFE SAFETY REQUIREMENTS. FOR FEATURES NOT ADDRESSED BY NFPA 101 AND THE REFERENCED NATIONAL FIRE CODES, THE 2009 EDITION OF THE INTERNATIONAL BUILDING CODE HAS BEEN USED.
2. THE EXISTING BUILDING IS UNDERGOING A REMODEL AND WILL BE USED AS A MEDICAL OUTPATIENT CLINIC. THE OCCUPANCY IS A GROUP B, BUSINESS OCCUPANCY.
3. THE CONSTRUCTION TYPE IS DETERMINED BASED UPON THE ALLOWABLE AREA AND HEIGHT REQUIREMENTS OF CHAPTER 5 OF THE 2009 IBC. TYPE II-(000) IS PERMITTED FOR THIS BUILDING. CONSTRUCTION TYPE AND MATERIALS SHALL BE PER CHAPTER 6 OF THE IBC FOR TYPE II-A CONSTRUCTION AS FOLLOWS:
- | | |
|------------------------------|---------------------------------------|
| FIRE RESISTIVE RATINGS: | II-A CONSTRUCTION: |
| EXTERIOR WALLS BEARING: | NONCOMBUSTIBLE, 0 HOUR FIRE RESISTIVE |
| EXTERIOR WALLS, NON-BEARING: | NONCOMBUSTIBLE, 0 HOUR FIRE-RESISTIVE |
| INTERIOR WALLS BEARING: | NONCOMBUSTIBLE, 0-HOUR FIRE RESISTIVE |
| STRUCTURAL FRAME: | NONCOMBUSTIBLE, 0-HOUR FIRE RESISTIVE |
| FLOOR-CEILING: | NONCOMBUSTIBLE, 0-HOUR FIRE RESISTIVE |
| ROOF-CEILING: | NONCOMBUSTIBLE, 0-HOUR FIRE RESISTIVE |

- STRUCTURAL DESIGN SHALL COMPLY WITH CHAPTER 16 OF THE IBC.
4. ALLOWABLE AREA: BASED UPON NON COMBUSTIBLE, UNPROTECTED CONSTRUCTION.
- | | |
|-----------------------------|-------------------------------|
| BASIC ALLOWABLE AREA: | 37,500 SF (IBC TABLE 503.5-1) |
| AUTOMATIC SPRINKLERS (200%) | 75,000 SF (IBC 506.3) |
| TOTAL ALLOWABLE AREA | 112,500 SF |
| AREA IMPACTED | 3,646 S.F |
5. ALLOWABLE HEIGHT: 5 STORIES PERMITTED (IBC TABLE 503)
75 FEET (IBC TABLE 503 PLUS SPRINKLER INCREASE OF SECTION 504.2)
ACTUAL BUILDING IS 5 STORIES.
ACTUAL HEIGHT IS 55 FEET.
6. SEPARATION OF BUILDINGS: 10 FEET MINIMUM (IBC TABLE 602)
7. OCCUPANCY SEPARATION: OCCUPANCY SEPARATION IS NOT REQUIRED.
8. HAZARDOUS ROOM SEPARATION: NONE REQUIRED
9. MEANS OF EGRESS REQUIREMENTS SHALL COMPLY WITH NFPA 101.
MAXIMUM TRAVEL DISTANCE: 300 FEET
COMMON PATH OF TRAVEL: TRAINING CENTER ASSEMBLY: 75 FEET IS PERMITTED EXCEPT THAT FOR ASSEMBLY ROOMS AREAS WITH AN OCCUPANT LOAD EXCEEDING 50, A 20 FOOT COMMON PATH OF TRAVEL IS PERMITTED.
- OCCUPANT IS PERMITTED.
- DEAD ENDS: 50 FEET
- NUMBER OF EXITS: NFPA 101 38.2.4.6. A SINGLE EXIT IS PERMITTED FROM A SINGLE TENANT BUILDING 2 OR FEWER STORIES IN HEIGHT PROTECTED BY AUTOMATIC SPRINKLERS WHERE THE TOTAL TRAVEL DISTANCE TO THE EXTERIOR DOES NOT EXCEED 100 FEET.
NO FIRE SEPARATION IS REQUIRED FOR EXIT STAIR.
- CLEAR WIDTH OF EXITS: DOORS - 34 INCHES CLEAR MIN.
CLEAR WIDTH OF CORRIDORS: 36 INCHES CLEAR MIN. (OCCUPANT LOAD LESS THAT 50)
- EXIT SIGNS: EXIT MARKING IS PROVIDED AS FOLLOWS: EXIT SIGNS ARE PROVIDED IN AREAS ACCESSIBLE TO THE PUBLIC IN ACCORDANCE WITH NFPA 101, AND SHALL BE OF THE LED TYPE. INCANDESCENT SIGNS ARE NOT PERMITTED.
12. INTERIOR FINISH:
WALLS AND CEILINGS: INTERIOR FINISH FLAME SPREAD SHALL BE LIMITED PER CHAPTER 8 OF THE NFPA 101 TO CLASS A, B AND C MATERIALS. INTERIOR WALL AND CEILING FINISH SHALL BE CLASS A OR CLASS B IN EXITS, CORRIDORS AND LOBBIES; AND CLASS A, CLASS B, OR CLASS C IN ALL OTHER AREAS.
CLASS A: FLAME SPREAD 0-25; SMOKE DEVELOPED 0-450
CLASS B: FLAME SPREAD 26-75; SMOKE DEVELOPED 0-450
CLASS C: FLAME SPREAD 76-200; SMOKE DEVELOPED 0-450
FLOORS: INTERIOR FLOOR FINISH SHALL BE CLASS I OR CLASS II IN CORRIDORS AND EXITS.
- UPHOLSTERED FURNITURE MUST ALSO MEET SPECIFIED REQUIREMENTS, BASED ON NFPA 260, NFPA 261, NFPA 266, 16 CFR 1632, ASTM E1537, AND ASTM E1590

BID ITEMS:

REF: TO SPECIFICATION SECTION 01 23 00 FOR COMPLETE DESCRIPTION OF BID ITEMS


LIFE SAFETY LEGEND

- | | |
|-----|---------------------------|
| --- | MAX TRAVEL DISTANCE |
| --- | 2 HR RATED WALL |
| Ⓜ | FIRE EXTINGUISHER CABINET |
| Ⓢ | EXIT SIGN |
| Ⓢ | AUTOMATIC DOOR CONTROL |
| Ⓢ | FIRE ALARM PULL STATION |
| ▲ | NEW EGRESS HARDWARE |
| ▲ | EXISTING EGRESS HARDWARE |

FULLY SPRINKLERED

BID DOCUMENTS

Project Title	Project Number	VETERANS ADMINISTRATION MEDICAL CENTER
RENOVATE PROSTHETICS	596-12-103	
Location	Building Number	
LEXINGTON VAMC LD	Bldg-1	
Date	Checked By:	Bldg Number
2/21/2013	STW	AE100
	Drawn By:	
	ARO	

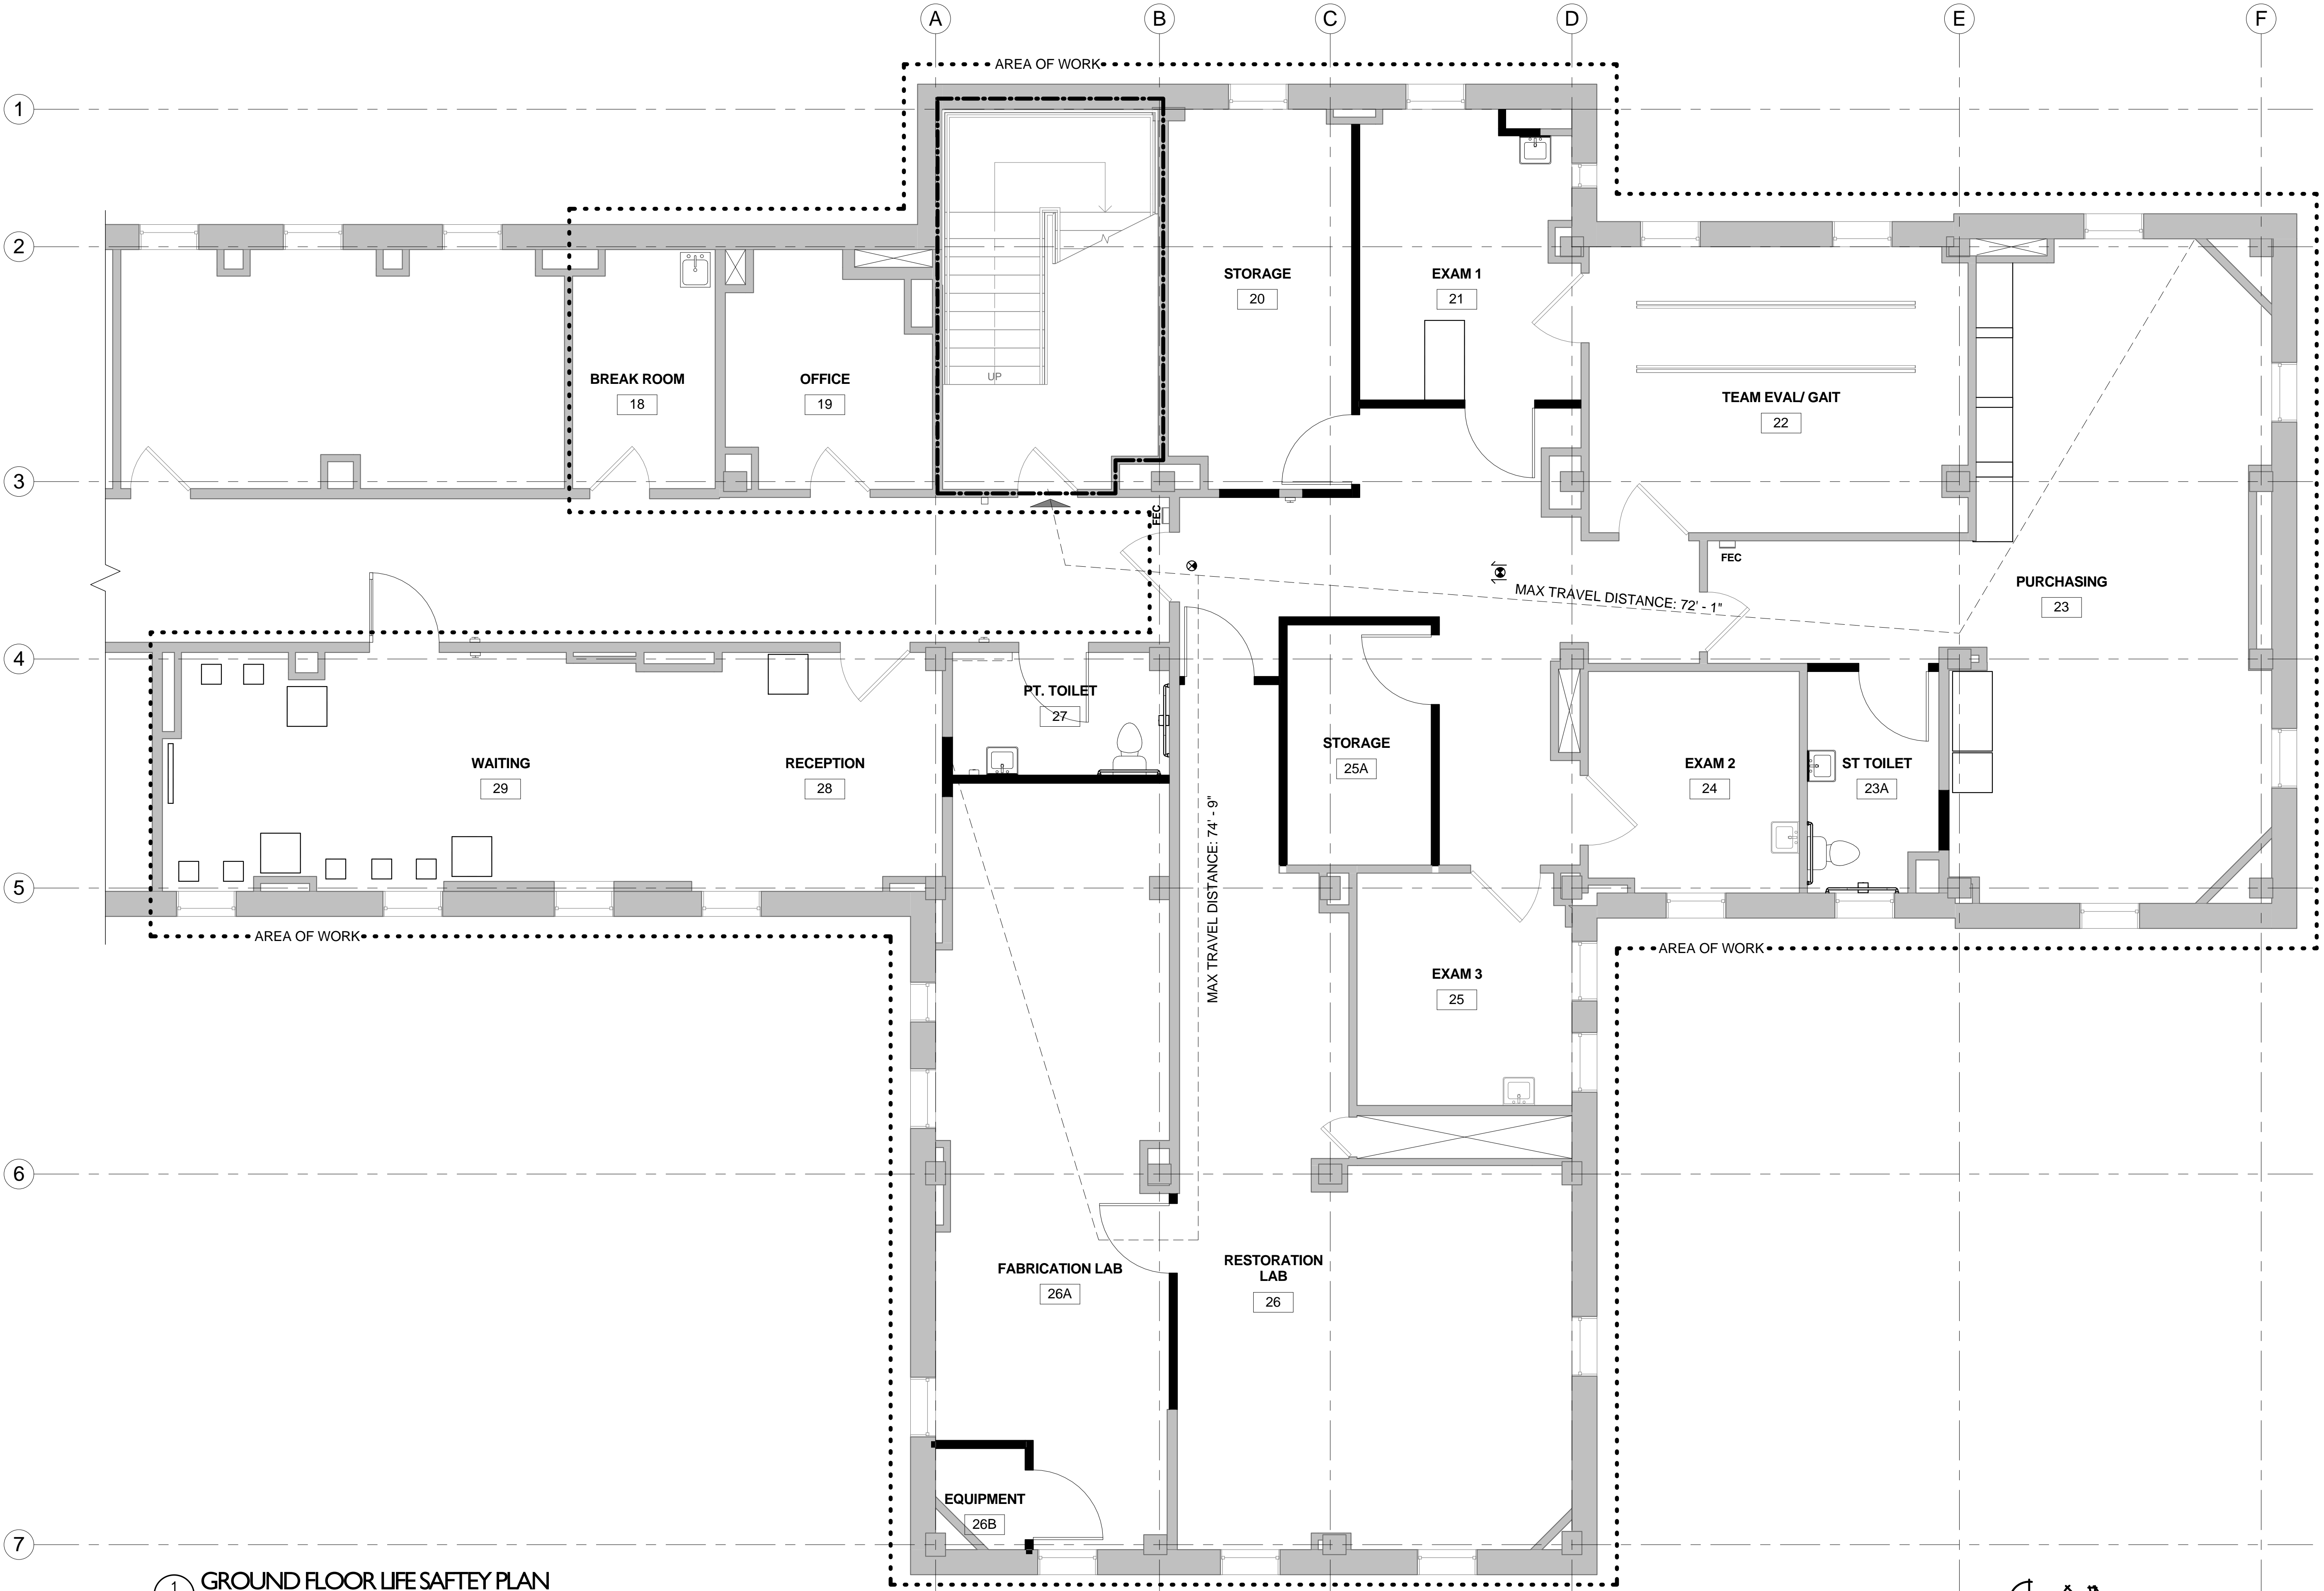

1 GROUND FLOOR LIFE SAFETY PLAN
1/4" = 1'-0"

MEP / HVAC DESIGN

BCCLT, Inc.

www.BCCLT.com

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BCCLT
Bligh, Chance, Cummins, London, Titzer
CONSULTING ENGINEERS



PROJECT LEADER/ARCHITECT:

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SUSTAINABLE ARCHITECTURE + ENGINEERING



Drawing Title
LIFE SAFETY PLAN

Approved for Design Concept:

[Signature]

Revisions: _____ Date: _____

Equipment Schedule					
DESCRIPTION	ID#	NEW/ EXISTING	FURNISHED	INSTALLED	Comments
Refrigerator	1850	EXISTING	OWNER	OWNER	
Exam chair	2110	EXISTING	OWNER	CONTRACTOR	
Fitting stool	2116	NEW	OWNER	CONTRACTOR	
Chair	2130	EXISTING	OWNER	OWNER	
Desk	2140	EXISTING	OWNER	OWNER	
Hand sink	2150	NEW	CONTRACTOR	CONTRACTOR	
Soap Dispenser	2160	NEW	CONTRACTOR	CONTRACTOR	
Mirror	2170	NEW	CONTRACTOR	CONTRACTOR	
Glove Dispenser	2180	NEW	CONTRACTOR	CONTRACTOR	
Paper Towel Dispenser	2190	NEW	CONTRACTOR	CONTRACTOR	
Chair	2330	EXISTING	OWNER	CONTRACTOR	
Desk	2340	EXISTING	OWNER	CONTRACTOR	
Cabinets	2350	EXISTING	OWNER	CONTRACTOR	

Equipment Schedule					
DESCRIPTION	ID#	NEW/ EXISTING	FURNISHED	INSTALLED	Comments
Xerox Copier/Printer	2360	EXISTING	OWNER	CONTRACTOR	
Fax	2361	EXISTING	OWNER	CONTRACTOR	
Work Bench	2620	EXISTING	OWNER	CONTRACTOR	
Work Bench	2621	EXISTING	OWNER	CONTRACTOR	
Work Bench	2622	EXISTING	OWNER	CONTRACTOR	
Work Bench	2623	EXISTING	OWNER	CONTRACTOR	
Rolling Cart	2628	EXISTING	OWNER	CONTRACTOR	
Rolling Cart	2629	EXISTING	OWNER	CONTRACTOR	
Anvil	2630	EXISTING	OWNER	CONTRACTOR	
Sewing table	2632	EXISTING	OWNER	CONTRACTOR	
Band Saw	2640	EXISTING	OWNER	CONTRACTOR	
Belt Sander	2641	EXISTING	OWNER	CONTRACTOR	
drill press	2642	EXISTING	OWNER	CONTRACTOR	


- FLOOR PLAN GENERAL NOTES**
- A DO NOT SCALE THE DRAWINGS. REFER DISCREPANCIES TO ARCHITECT FOR FINAL DECISIONS ON LAYOUT.
- B ALL WALLS TYPE A, UNLESS NOTED OTHERWISE
- C ALL DIMENSIONS SHOWN ARE TO FACE OF WALL FINISH UNLESS NOTED OTHERWISE.
- D PROVIDE SEALANT JOINTS BETWEEN DISSIMILAR MATERIALS.
- E PROVIDE BRACING AND FIRE-TREATED BLOCKING AS REQUIRED IN WALLS SUPPORTING CASEWORK, TACKBOARDS, MARKERBOARDS, RESTROOM ACCESSORIES, ETC.
- F VERIFY EXISTING FIELD CONDITIONS PRIOR TO BEGINNING WORK, AND REPORT DISCREPANCIES IMMEDIATELY TO ARCHITECT FOR CLARIFICATION.
- G UPPER CASEWORK MOUNTING HEIGHT TO BE 54" AFF. UNO. REFER QUESTIONABLE MOUNTING HEIGHT CHOICES TO ARCHITECT FOR FINAL DECISIONS.
- H ALL GYPSUM WALLBOARD IS 5/8" TYPE "X" UNLESS NOTED OTHERWISE.
- I CONFLICTS BETWEEN SPECIFICATIONS AND DRAWINGS SHALL BE COMMUNICATED TO THE ARCHITECT FOR RESOLUTION PRIOR TO COMMENCEMENT OF THE WORK.
- J PROVIDE WATER ROUGH-IN AND ELECTRICAL CONNECTIONS FOR OWNER-PROVIDED EQUIPMENT IN COMPLIANCE WITH MEP DRAWINGS.
- K DOORS TO BE INSTALLED 6" FROM CORNER TO INSIDE OF DOOR FRAME UNLESS NOTED OTHERWISE- TYPICAL
- L PROVIDE CONTROL JOINT IN ALL GYPSUM BOARD WALLS GREATER THAN 30' LONG. PLACE CONTROL JOINTS AT CORNERS OF DOORS OR WINDOWS.
- M PATCH EXISTING WALLS AT LIMITS OF DEMOLITION AND WHERE NEW WALLS MEET EXISTING WALLS ACCORDING TO DRAWINGS.
- N PATCH, REPAIR AND CLEAN EXISTING WALLS. REF. FINISH SCHEDULE FOR NEW WALL FINISH, BASE AND FLOOR FINISH
- O ALL UTILITY SHUTDOWNS TO OCCUR AFTER REGULAR BUSINESS HOURS AND WHEN REQUIRED BY THE COTR WILL HAVE TO BE SCHEDULED ON WEEKENDS.
- P THE CONTRACTOR IS RESPONSIBLE TO VERIFY THE HAZARD(S) AND LEVEL OF PROTECTION REQUIRED FOR ALL EMPLOYEES OR SUBCONTRACTORS TO COMPLETE THE CONSTRUCTION WORK.
- Q REFERENCE FINISH FLOOR PLAN FOR LOCATION OF SURFACE MOUNTED CORNER GUARDS.
- R VERIFY DATA OUTLET LOCATIONS WITH VA BEFORE ROUGH-IN.

- BID ITEMS:**
- REF: TO SPECIFICATION SECTION 01 23 00 FOR COMPLETE DESCRIPTION OF BID ITEMS
- BID 1: BASE BID
- BID 2: DO NOT PERFORM WORK IN AREA INDICATED
- BID 3: DO NOT PERFORM WORK IN AREA INDICATED
- BID 4: DO NOT INSTALL NEW WALL, SINK, TOILET, AND ASSOCIATED TOILET ITEMS. PROVIDE FINISHES CONTINUOUS TO MATCH FABRICATION LAB, ROOM 26A.
- BID 5: DO NOT CONSTRUCT STAFF TOILET, ROOM 23A. PROVIDE FINISHES IN PURCHASING, ROOM 23 SEAMLESS TO EXISTING WALLS.

Equipment Schedule					
DESCRIPTION	ID#	NEW/ EXISTING	FURNISHED	INSTALLED	Comments
Compressor	2643	EXISTING	OWNER	CONTRACTOR	
Sanding Hone	2644	EXISTING	OWNER	CONTRACTOR	
CNC	2650	EXISTING	OWNER	CONTRACTOR	
Molding Bench	2651	NEW	OWNER	CONTRACTOR	
Oven	2652	EXISTING	OWNER	CONTRACTOR	
Vacuum Center	2653	EXISTING	OWNER	CONTRACTOR	
Vacuum Pump	2654	EXISTING	OWNER	CONTRACTOR	
Work sink	2660	NEW	CONTRACTOR	CONTRACTOR	
Flammable case	2690	EXISTING	OWNER	CONTRACTOR	
Chair	2830	EXISTING	OWNER	CONTRACTOR	
Desk	2840	EXISTING	OWNER	OWNER	
Printer	2860	EXISTING	OWNER	OWNER	
Chair	2930	EXISTING	OWNER	OWNER	
End Table	2940	EXISTING	OWNER	OWNER	
Television	2950	EXISTING	OWNER	OWNER	

2 GROUND FLOOR PLAN
1/4" = 1'-0"

Revisions:	Date:	MEP / HVAC DESIGN BCCLT, Inc. www.BCCLT.com MEP ENGINEERS 801 MAIN STREET SHELBYVILLE, KY 40065 T:502-633-1506 BCCLT Bligh, Chance, Cummins, London, Titze CONSULTING ENGINEERS	 <p>PROJECT LEADER/ARCHITECT: GUIDON DESIGN 2453 N. DELAWARE ST. INDIANAPOLIS, IN. 46205 317.800.6388 WWW.GUIDONDESIGN.COM SUSTAINABLE ARCHITECTURE + ENGINEERING</p>	Drawing Title FLOOR PLAN Approved for Design Concept: 	Project Title RENOVATE PROSTHETICS Location LEXINGTON VAMC LD Date 2/21/2013 Checked By: STW Drawn By: ARO	Project Number 596-12-103 Building Number Bldg-1 Drawing Number AE101 VETERANS ADMINISTRATION MEDICAL CENTER 
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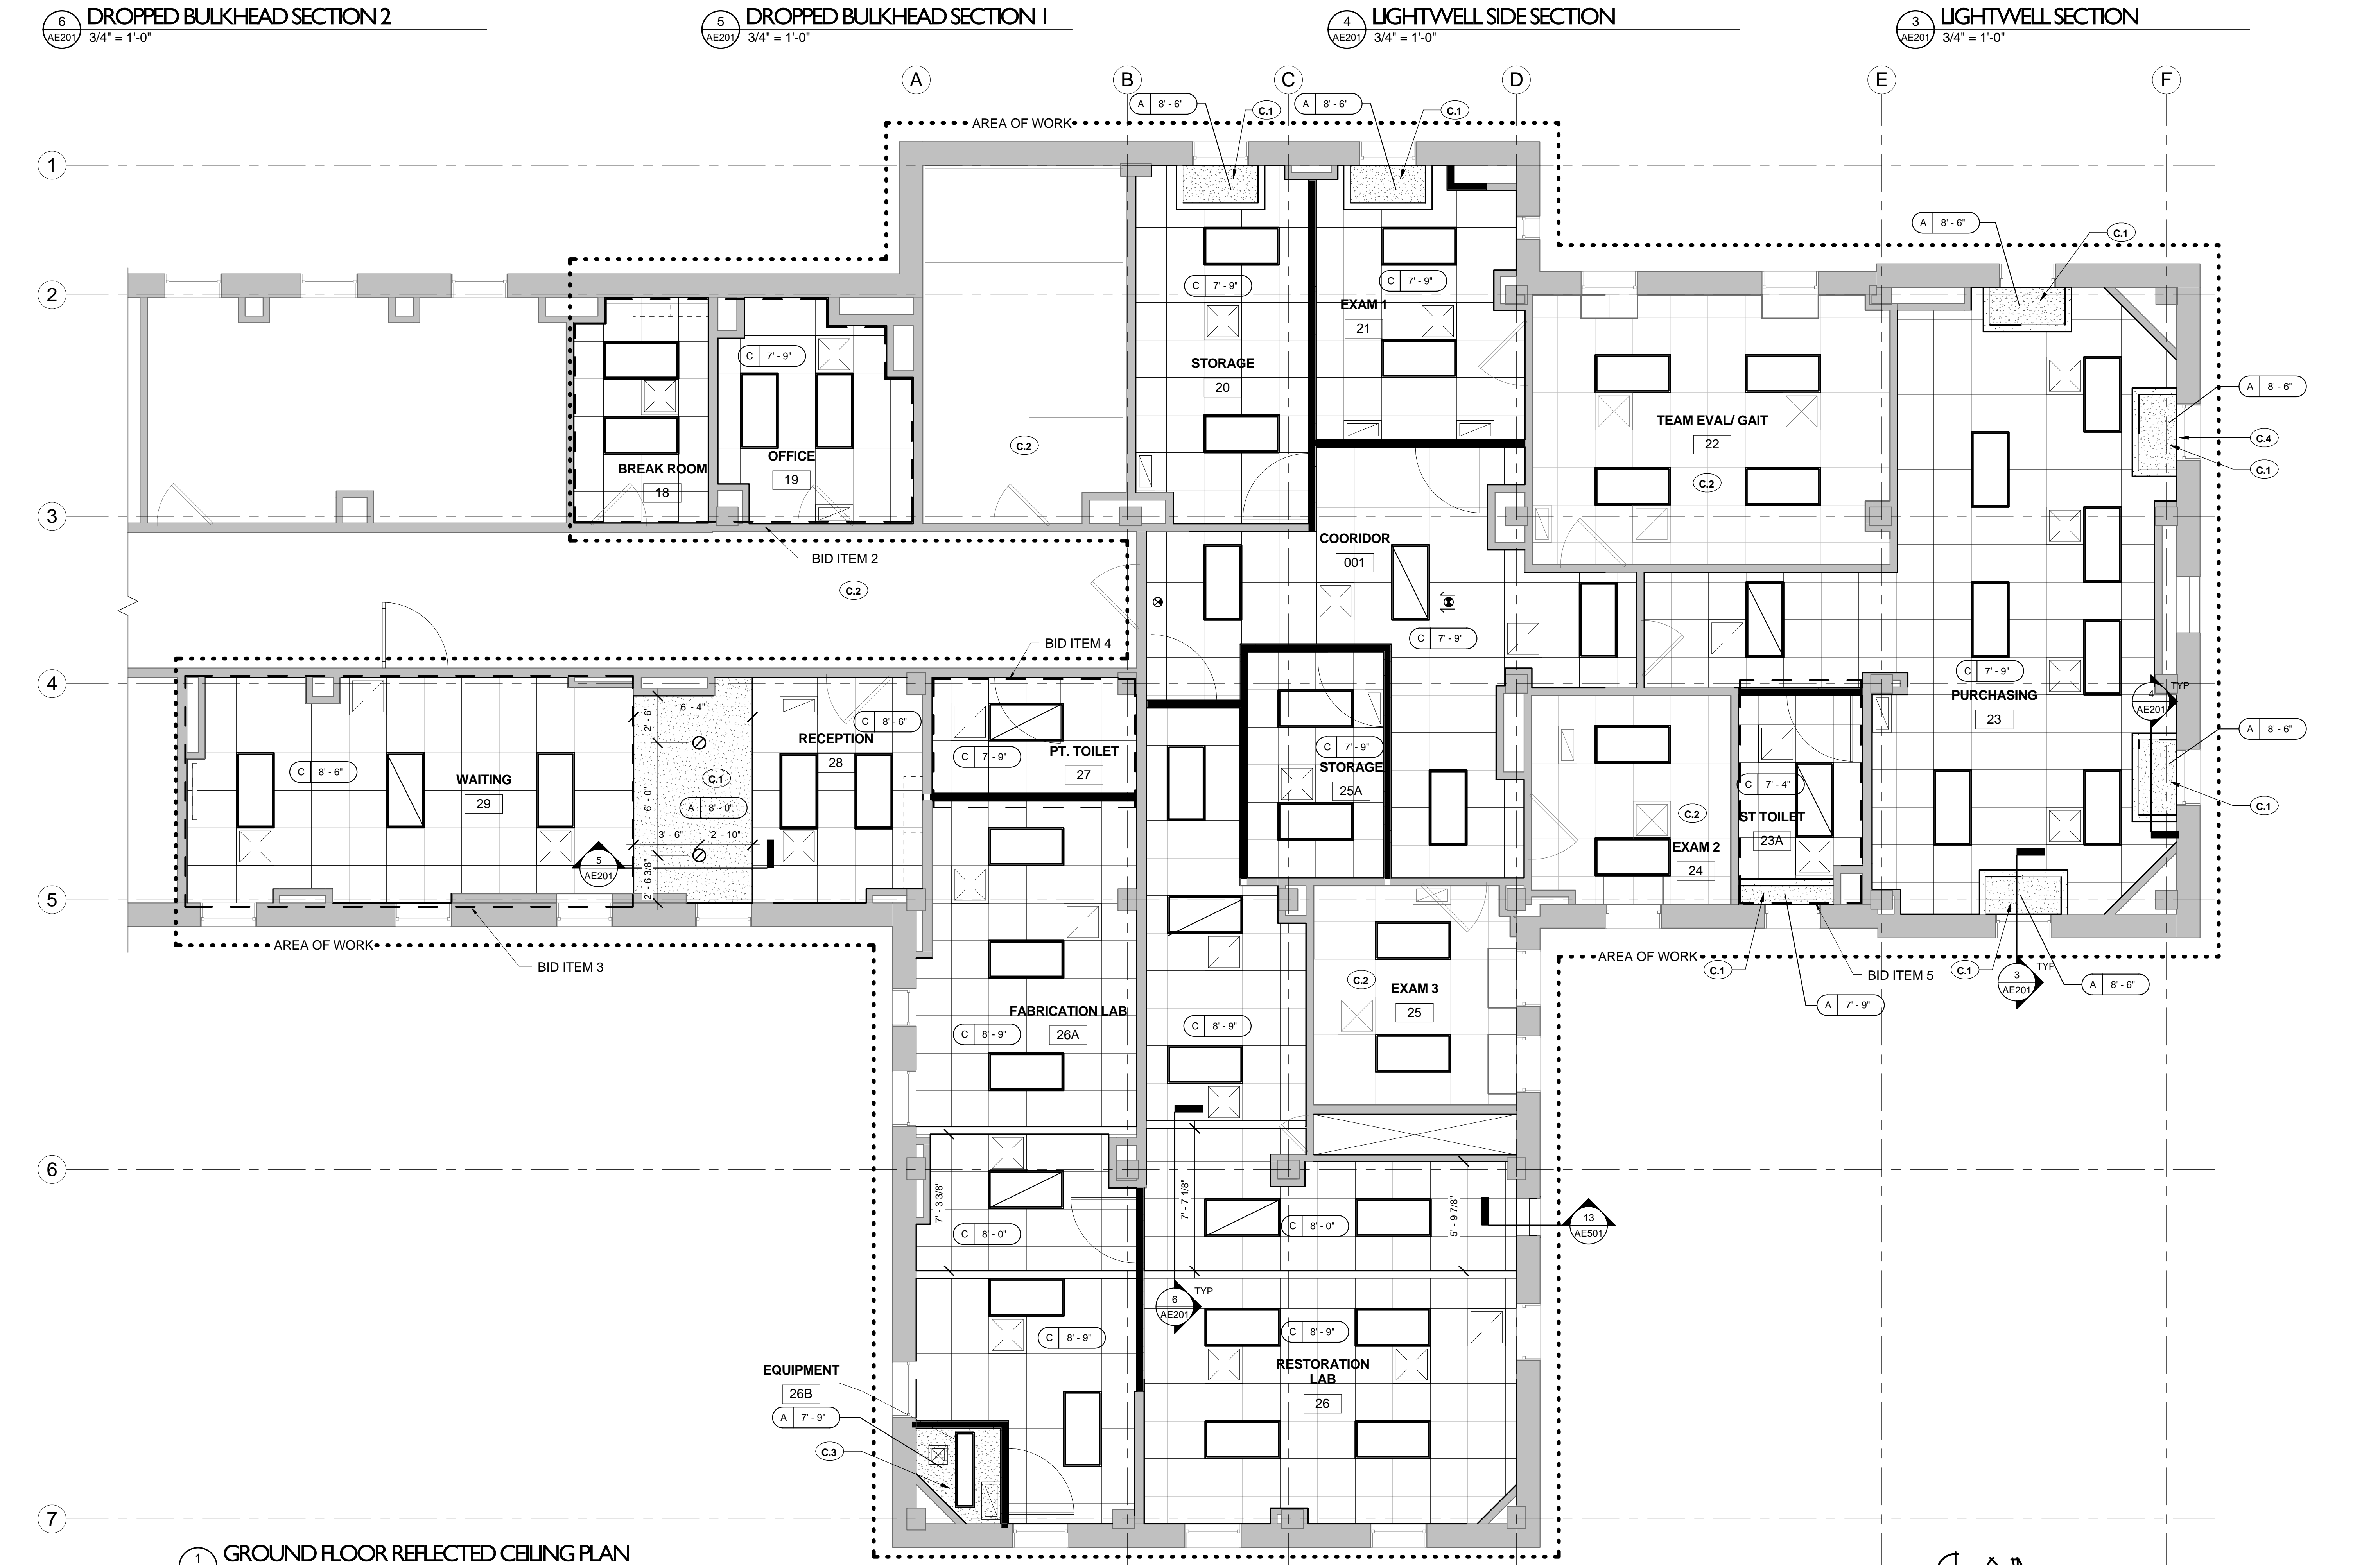


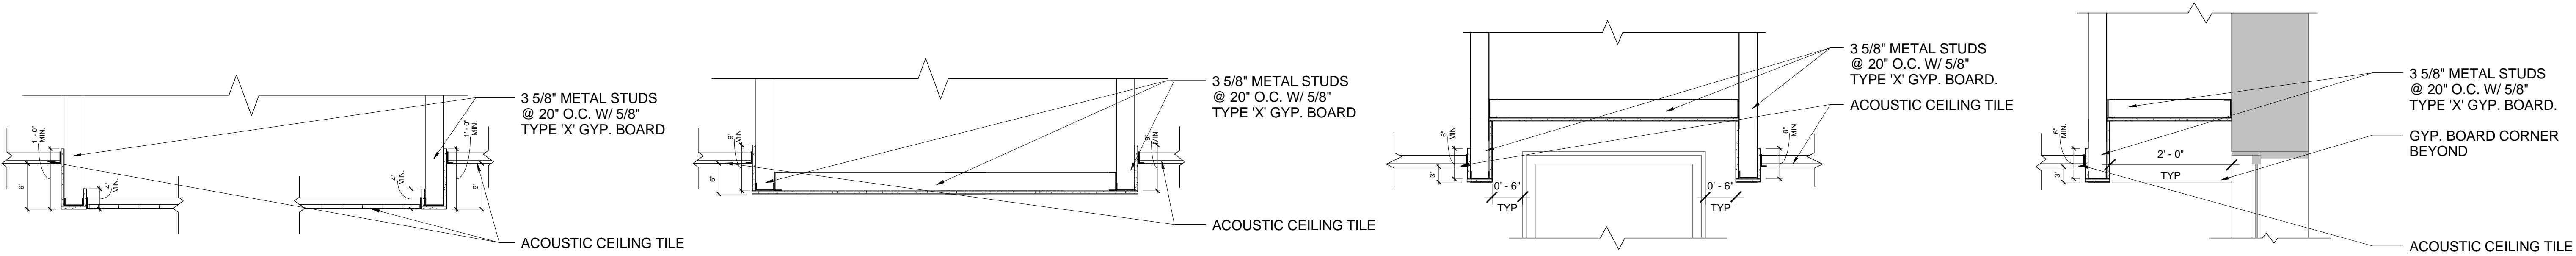- REFLECTED CEILING GENERAL NOTES**
- A. ALL ACOUSTICAL CEILING TILE CEILINGS TO BE 7'-9" A.F.F. UNLESS NOTED OTHERWISE
 - B. REFER TO REFLECTED CEILING PLAN FOR ADDITIONAL NOTES AND CEILING INFORMATION.
 - C. PROVIDE CONTROL JOINTS IN PLASTER & GYPSUM BOARD CEILINGS AND BULKHEADS WHERE RECOMMENDED/REQUIRED BY MANUFACTURERS OR INDUSTRY STANDARDS, OR WHERE INDICATED. COORDINATE LOCATION WITH ARCHITECT.
 - D. ALL CEILING HEIGHTS ARE FROM FINISHED FLOOR.
 - E. INSTALL SUSPENDED CEILING GRID WITH EQUAL SIZE PANELS AT EACH SIDE OR END OF THE INDIVIDUAL CEILING AREA UNLESS OTHERWISE DIMENSIONED. NO PANEL SHALL BE LESS THAN 4" WIDE.
 - F. THE ARCHITECTURAL REFLECTED CEILING PLAN SHALL GOVERN THE LAYOUT OF ALL CEILING ELEMENTS AND/OR PENETRATIONS. COORDINATE ANY FIELD VERIFIED OR AS-BUILT CONDITIONS THAT DIFFER FROM WHAT IS SHOWN ON THESE PLANS WITH THE ARCHITECT.
 - G. SIZES AND SHAPES OF LIGHTING FIXTURES AND OTHER MISCELLANEOUS ELECTRICAL EQUIPMENT (IF SHOWN) ARE FOR REFERENCE ONLY. COORDINATE ACTUAL SIZES AND TYPES WITH THE ELECTRICAL DRAWINGS/ENGINEER.
 - H. SIZES OF MECHANICAL EQUIPMENT (IF SHOWN) ARE FOR REFERENCE ONLY. COORDINATE ACTUAL SIZES AND TYPES WITH MECHANICAL DRAWINGS/ENGINEER.
 - J. COORDINATE CLEARANCES WITH M.E.P. DRAWINGS. NOTIFY ARCHITECT OF CONFLICTS PRIOR TO CONSTRUCTION.
 - K. ALL CEILING MOUNTED ITEMS (SPRINKLER HEADS, MOUNTING MECHANISMS, ETC.) SHALL BE CENTERED IN THE CEILING PANELS UNLESS OTHERWISE NOTED/INDICATED.
 - L. ALL UTILITY SHUTDOWNS TO OCCUR AFTER REGULAR BUSINESS HOURS AND WHEN REQUIRED BY THE COTR WILL HAVE TO BE SCHEDULED ON WEEKENDS.
 - M. THE CONTRACTOR IS RESPONSIBLE TO VERIFY THE HAZARD(S) AND LEVEL OF PROTECTION REQUIRED FOR ALL EMPLOYEES OR SUBCONTRACTORS TO COMPLETE THE CONSTRUCTION WORK.


- REFLECTED CEILING PLAN KEY NOTES**
- C.1 PAINT ALL GYP BOARD CEILINGS P-4. SEE FINISH LEGEND. PAINT VERTICAL BULKHEAD FACES WHITE.
 - C.2 EXISTING CEILING TO REMAIN, NO NEW CEILING FINISHES.
 - C.3 PROVIDE ACOUSTIC BATT INSULATION ABOVE CEILING, AND PROVIDE ACOUSTIC SEALANT AT ALL PENETRATIONS.
 - C.4 PROVIDE GYP BOARD, FURRING AND SEALANT TO REFINISH WINDOW HEADER.

- BID ITEMS:**
- REF: TO SPECIFICATION SECTION 01 23 00 FOR COMPLETE DESCRIPTION OF BID ITEMS
- BID 1: BASE BID
 - BID 2: DO NOT PERFORM WORK IN AREA INDICATED
 - BID 3: DO NOT PERFORM WORK IN AREA INDICATED
 - BID 4: DO NOT INSTALL NEW WALL, SINK, TOILET, AND ASSOCIATED TOILET ITEMS. PROVIDE FINISHES CONTINUOUS TO MATCH FABRICATION LAB, ROOM 26A.
 - BID 5: DO NOT CONSTRUCT STAFF TOILET, ROOM 23A. PROVIDE FINISHES IN PURCHASING, ROOM 23 SEAMLESS TO EXISTING WALLS.


REFLECTED CEILING PLAN LEGEND		
A		GYPSUM BOARD, PAINTED
B		2x4 SUSPENDED ACOUSTICAL CEILING TILE AND GRID SYSTEM
C		2x2 SUSPENDED ACOUSTICAL CEILING TILE AND GRID SYSTEM
D		EXPOSED STRUCTURAL DECK ABOVE
		LIGHT FIXTURES AND DIFFUSERS
CEILING TYPE		
		CEILING TAG
CEILING HEIGHT ABOVE FIN FLR AT LOWEST LEVEL		



1 GROUND FLOOR REFLECTED CEILING PLAN
1/4" = 1'-0"

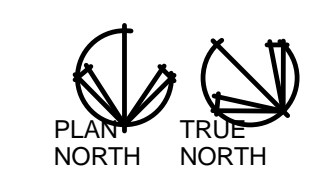


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SIGNAGE NOTES:
1. PROVIDE DEPARTMENT SIGN AS INDICATED ON FINISH FLOOR PLAN.
2. LOCATE SIGNS PER DIRECTION OF ARCHITECT.
3. SIGNAGE CONSTRUCTION TO MATCH EXISTING SIGNAGE ON CAMPUS, COORDINATE WITH OWNER.
4. ELEVATION IS FOR REFERENCE ONLY COORDINATE NEW SIGN WITH EXISTING.

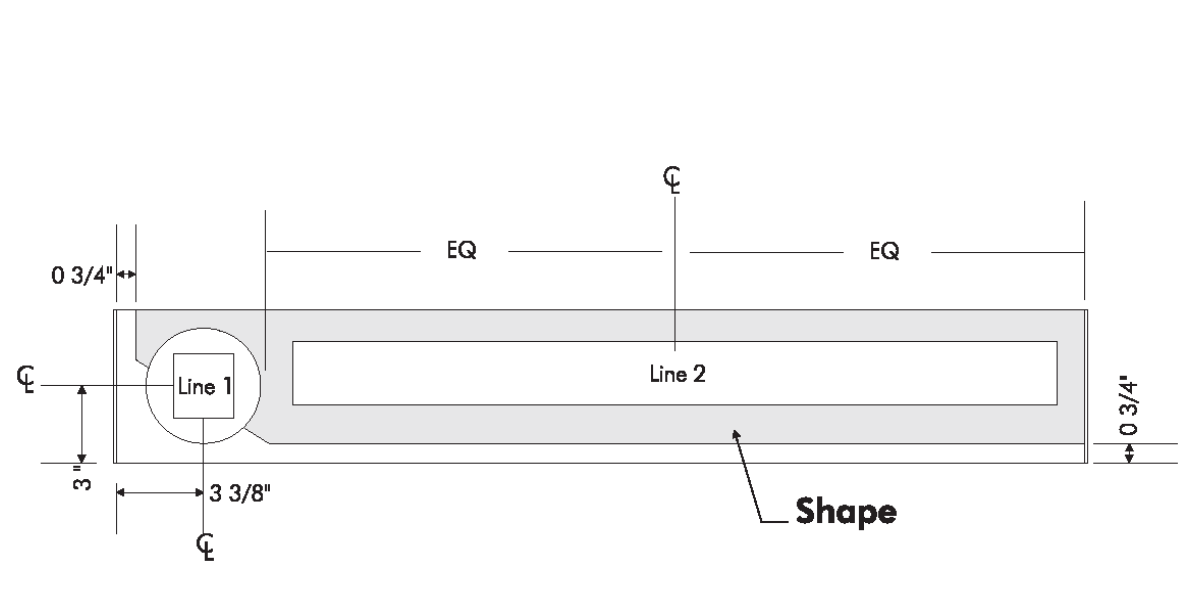
DEPARTMENT SIGN DETAIL
NOT TO SCALE



SIGNAGE NOTES:
1. PROVIDE ROOM SIGN FOR EACH SPACE INDICATED ON ROOM FINISH SCHEDULE.
2. LOCATE SIGNS PER DIRECTION OF ARCHITECT.
3. SIGNAGE CONSTRUCTION TO MATCH EXISTING SIGNAGE ON CAMPUS, COORDINATE WITH OWNER.
4. ELEVATION IS FOR REFERENCE ONLY COORDINATE NEW SIGNS WITH EXISTING.

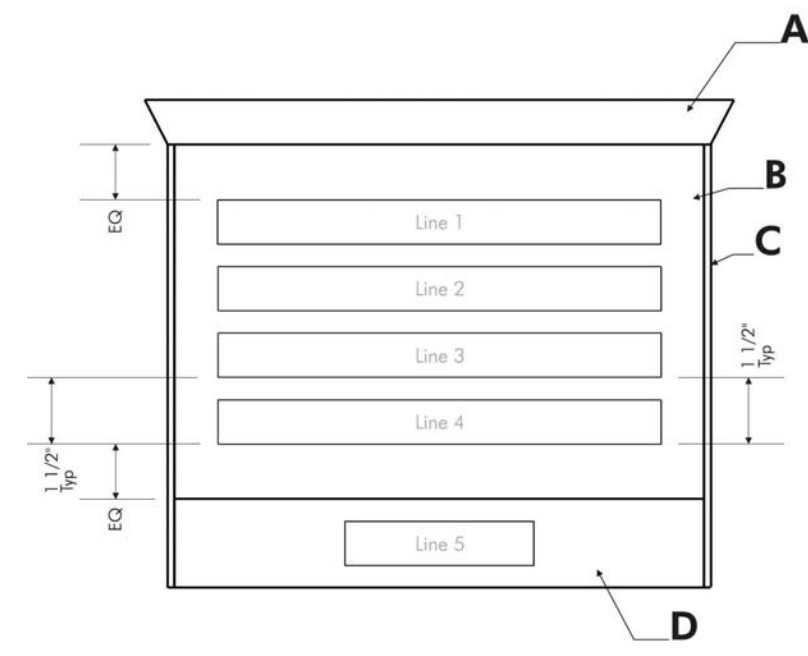ROOM SIGN DETAIL
NOT TO SCALE

DOOR SCHEDULE											
DOOR NUMBER	TYPE	WIDTH	HEIGHT	THICKNESS	MATERIAL	FINISH	Frame MATERIAL	FINISH	HARDWARE SET	COMMENTS	
20	A	3'-6"	7'-0"	0'-1 3/8"	WD, RED OAK	CLEAR	HM	PAINT	HW-2		
21	A	3'-6"	7'-0"	0'-1 3/8"	WD, RED OAK	CLEAR	HM	PAINT	HW-3		
23A	A	3'-6"	7'-0"	0'-1 3/8"	WD, RED OAK	CLEAR	HM	PAINT	HW-1		
25A	A	3'-6"	7'-0"	0'-1 3/8"	WD, RED OAK	CLEAR	HM	PAINT	HW-2		
26	B	3'-6"	7'-0"	0'-1 3/8"	WD, RED OAK	CLEAR	HM	PAINT	HW-3		
26A	B	3'-6"	7'-0"	0'-1 3/8"	WD, RED OAK	CLEAR	HM	PAINT	HW-3		
26B	A	3'-6"	7'-0"	0'-1 3/8"	WD, RED OAK	CLEAR	HM	PAINT	HW-4	SOUND TRANSMISSION CLASS 45	
27	A	3'-6"	7'-0"	0'-1 3/8"	WD, RED OAK	CLEAR	HM	PAINT	HW-1		
29	C	3'-6"	7'-0"	0'-2"	ANOD. ALUM.	CLEAR	ANOD. ALUM.	CLEAR	HW-5	PROVIDE AUTO. DOOR CONTROL PADDLES	

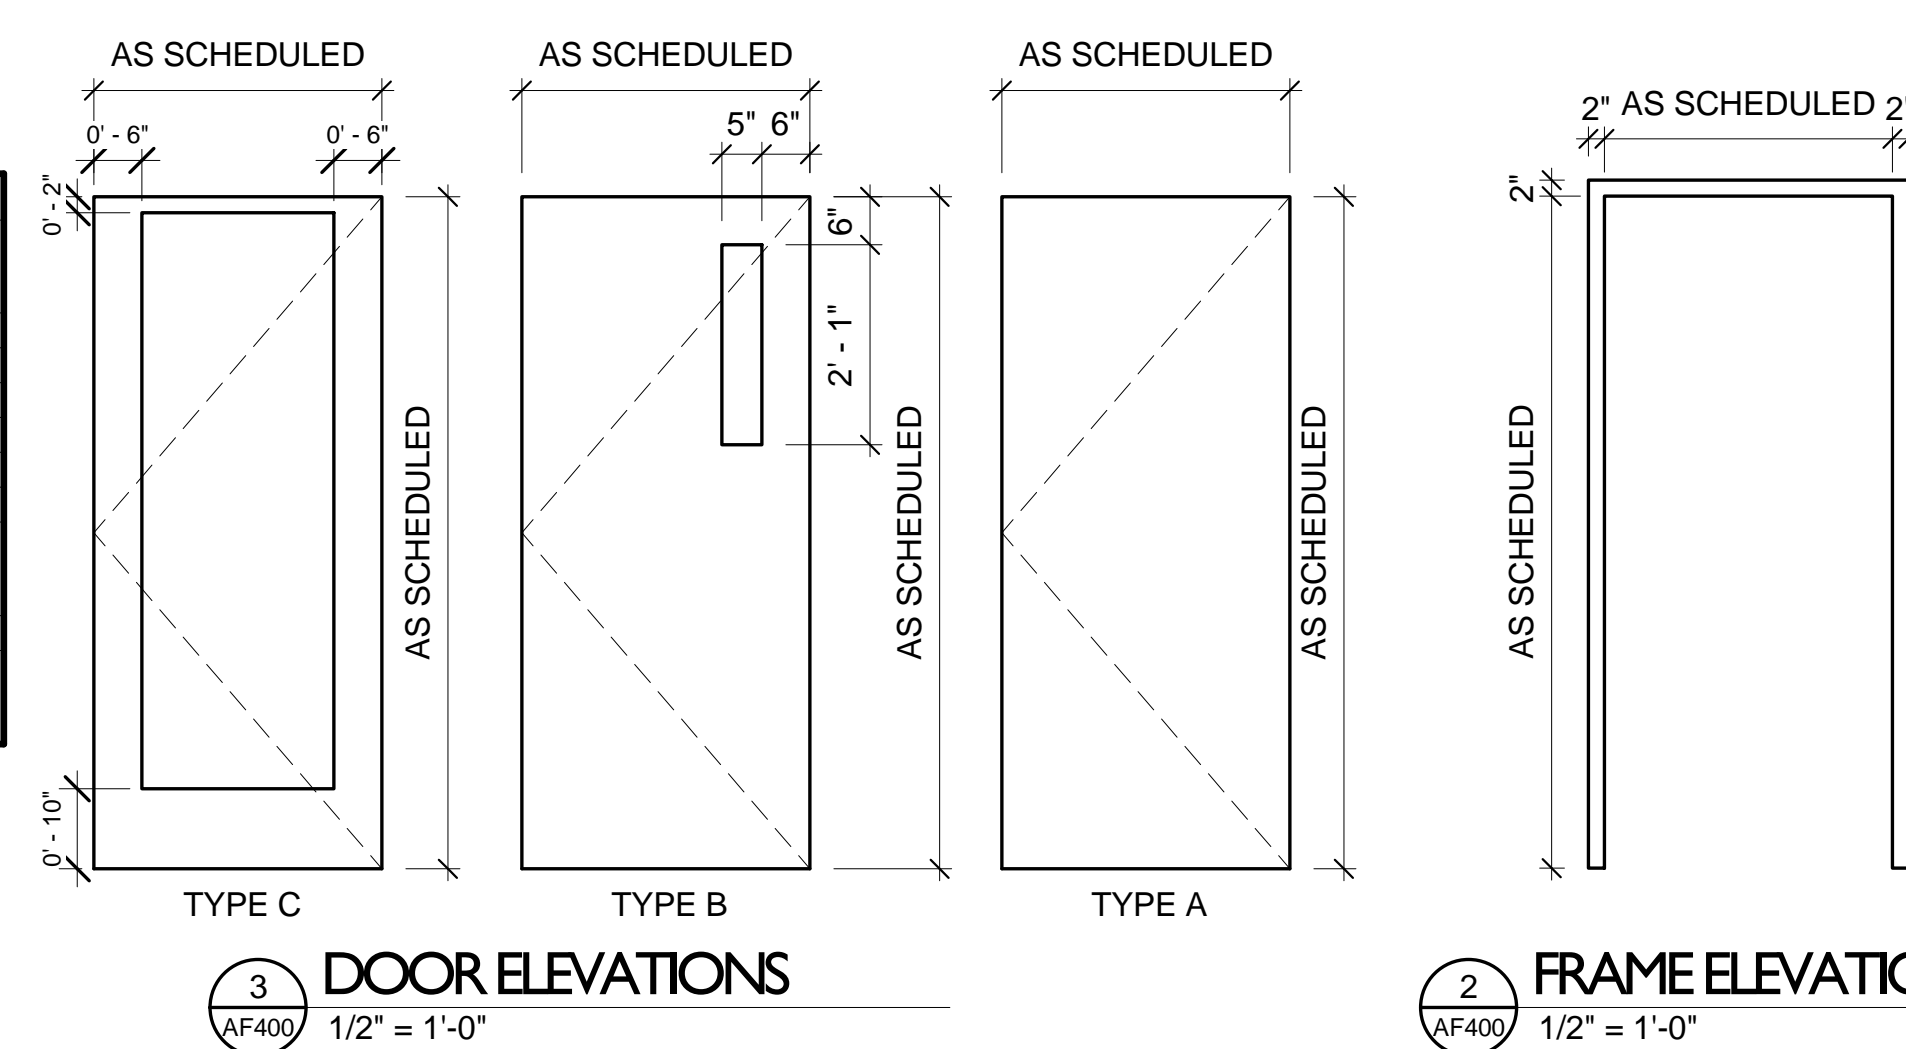


- INTERIOR GENERAL NOTES**
- CONTRACTOR SHALL FIELD VERIFY ALL DIMENSIONS, LOCATIONS, AND MATERIAL QUANTITIES PRIOR TO STARTING WORK AND PURCHASING MATERIALS. REPORT ANY DISCREPANCIES TO DESIGNER / ARCHITECT.
 - CONTRACTOR SHALL COMPLY WITH ALL MANUFACTURER'S INSTALLATION METHODS AND SHALL NOT EXECUTE WORK WITHOUT VERIFICATION OF FIELD CONDITIONS.
 - REFERENCE ROOM FINISH SPECIFICATIONS FOR MATERIAL TYPE AND ADDITIONAL INFORMATION.
 - REFERENCE REFLECTED CEILING PLAN FOR CEILING HEIGHTS, EXTENT OF BULKHEADS, AND ANY SPECIAL PAINT COLOR DESIGNATIONS.
 - REFERENCE FINISH FLOOR PLAN FOR LOCATION OF SURFACE MOUNTED CORNER GUARDS.
 - PROVIDE RESILIENT COVE BASE AT FIXED CASEWORK AND SUPPORTS UNLESS NOTED OTHERWISE.
 - CONTRACTOR IS TO PROVIDE FLOORING TRANSITION AT ALL FLOOR MATERIAL CHANGES REF: SPECIFICATION FOR COLORS, MATERIAL, ETC.
 - PAINT ALL HOLLOW METAL DOOR FRAMES PT-2, UNLESS NOTED OTHERWISE. FINISH: SEMI-GLOSS.
 - PROVIDE FLAT FINISH PAINT FOR CEILING. SATIN / EGGSHELL FINISH PAINT AT WALLS UNLESS NOTED OTHERWISE.
 - PAINT GRILLES, EXPOSED CONDUIT, AND LIKE PRODUCT TO MATCH ADJACENT WALL COLOR UNLESS NOTED OTHERWISE.
 - PAINT BULKHEADS AS NOTED ON REFLECTED CEILING PLAN.
 - LOOSE FURNITURE AND OTHER LOOSE EQUIPMENT ITEMS INDICATED ON SHEET: AE101 AND EQUIPMENT SCHEDULE ARE OWNER FURNISHED/PROVIDED, TO BE RELOCATED AND INSTALLED BY CONTRACTOR, UNLESS NOTED OTHERWISE.

- INTERIOR FINISH PLAN NOTES**
- F.1 PROVIDE VCT-1, 2, & 3 REFERENCE 13/AE501 FOR FLOOR PATTERN.
F.2 REFERENCE ELEVATIONS FOR WALL TILE LAYOUT PATTERN.
F.3 PROVIDE SELF LEVELING FLOORING COMPOUND. PREPARE FLOOR FOR NEW TILE FINISH.

- BID ITEMS:**
- REF: TO SPECIFICATION SECTION 01 23 00 FOR COMPLETE DESCRIPTION OF BID ITEMS
- BID 1: BASE BID
BID 2: DO NOT PERFORM WORK IN AREA INDICATED
BID 3: DO NOT PERFORM WORK IN AREA INDICATED
BID 4: DO NOT INSTALL NEW WALL, SINK, TOILET, AND ASSOCIATED TOILET ITEMS. PROVIDE FINISHES CONTINUOUS TO MATCH FABRICATION LAB, ROOM 26A.
BID 5: DO NOT CONSTRUCT STAFF TOILET, ROOM 23A. PROVIDE FINISHES IN PURCHASING, ROOM 23 SEAMLESS TO EXISTING WALLS.

FINISH LEGEND	
MARK	FINISH/MATERIAL
REF: 4/AF900 FOR SIGNAGE REQUIREMENTS	
REF: 5/AF900 FOR SIGNAGE REQUIREMENTS	
ACT	ACOUSTICAL PANEL CEILING AND TRIM
CG	VINYL CORNER GUARDS
CPT	CARPET TILE, 24" x 24"
CT-1	CERAMIC TILE, FLOOR
CT-2	CERAMIC TILE, WALL
CT-3	CERAMIC TILE, WALL TRIM
LVT	LUXURY VINYL TILE
PT-1	FIELD PAINT
PT-2	TRIM PAINT
PT-3	WALL ACCENT PAINT
PT-4	WALL ACCENT PAINT
PT-5	WHITE PAINT
RCB	RESILIENT COVE BASE
TR-1	FLOOR TRANSITION REF: 7/AE501
TR-2	FLOOR TRANSITION REF: 8/AE501
TR-3	FLOOR TRANSITION REF: 9/AE501
VCT-1	VINYL TILE FIELD
VCT-2	VINYL TILE ACCENT
VCT-3	VINYL TILE ACCENT

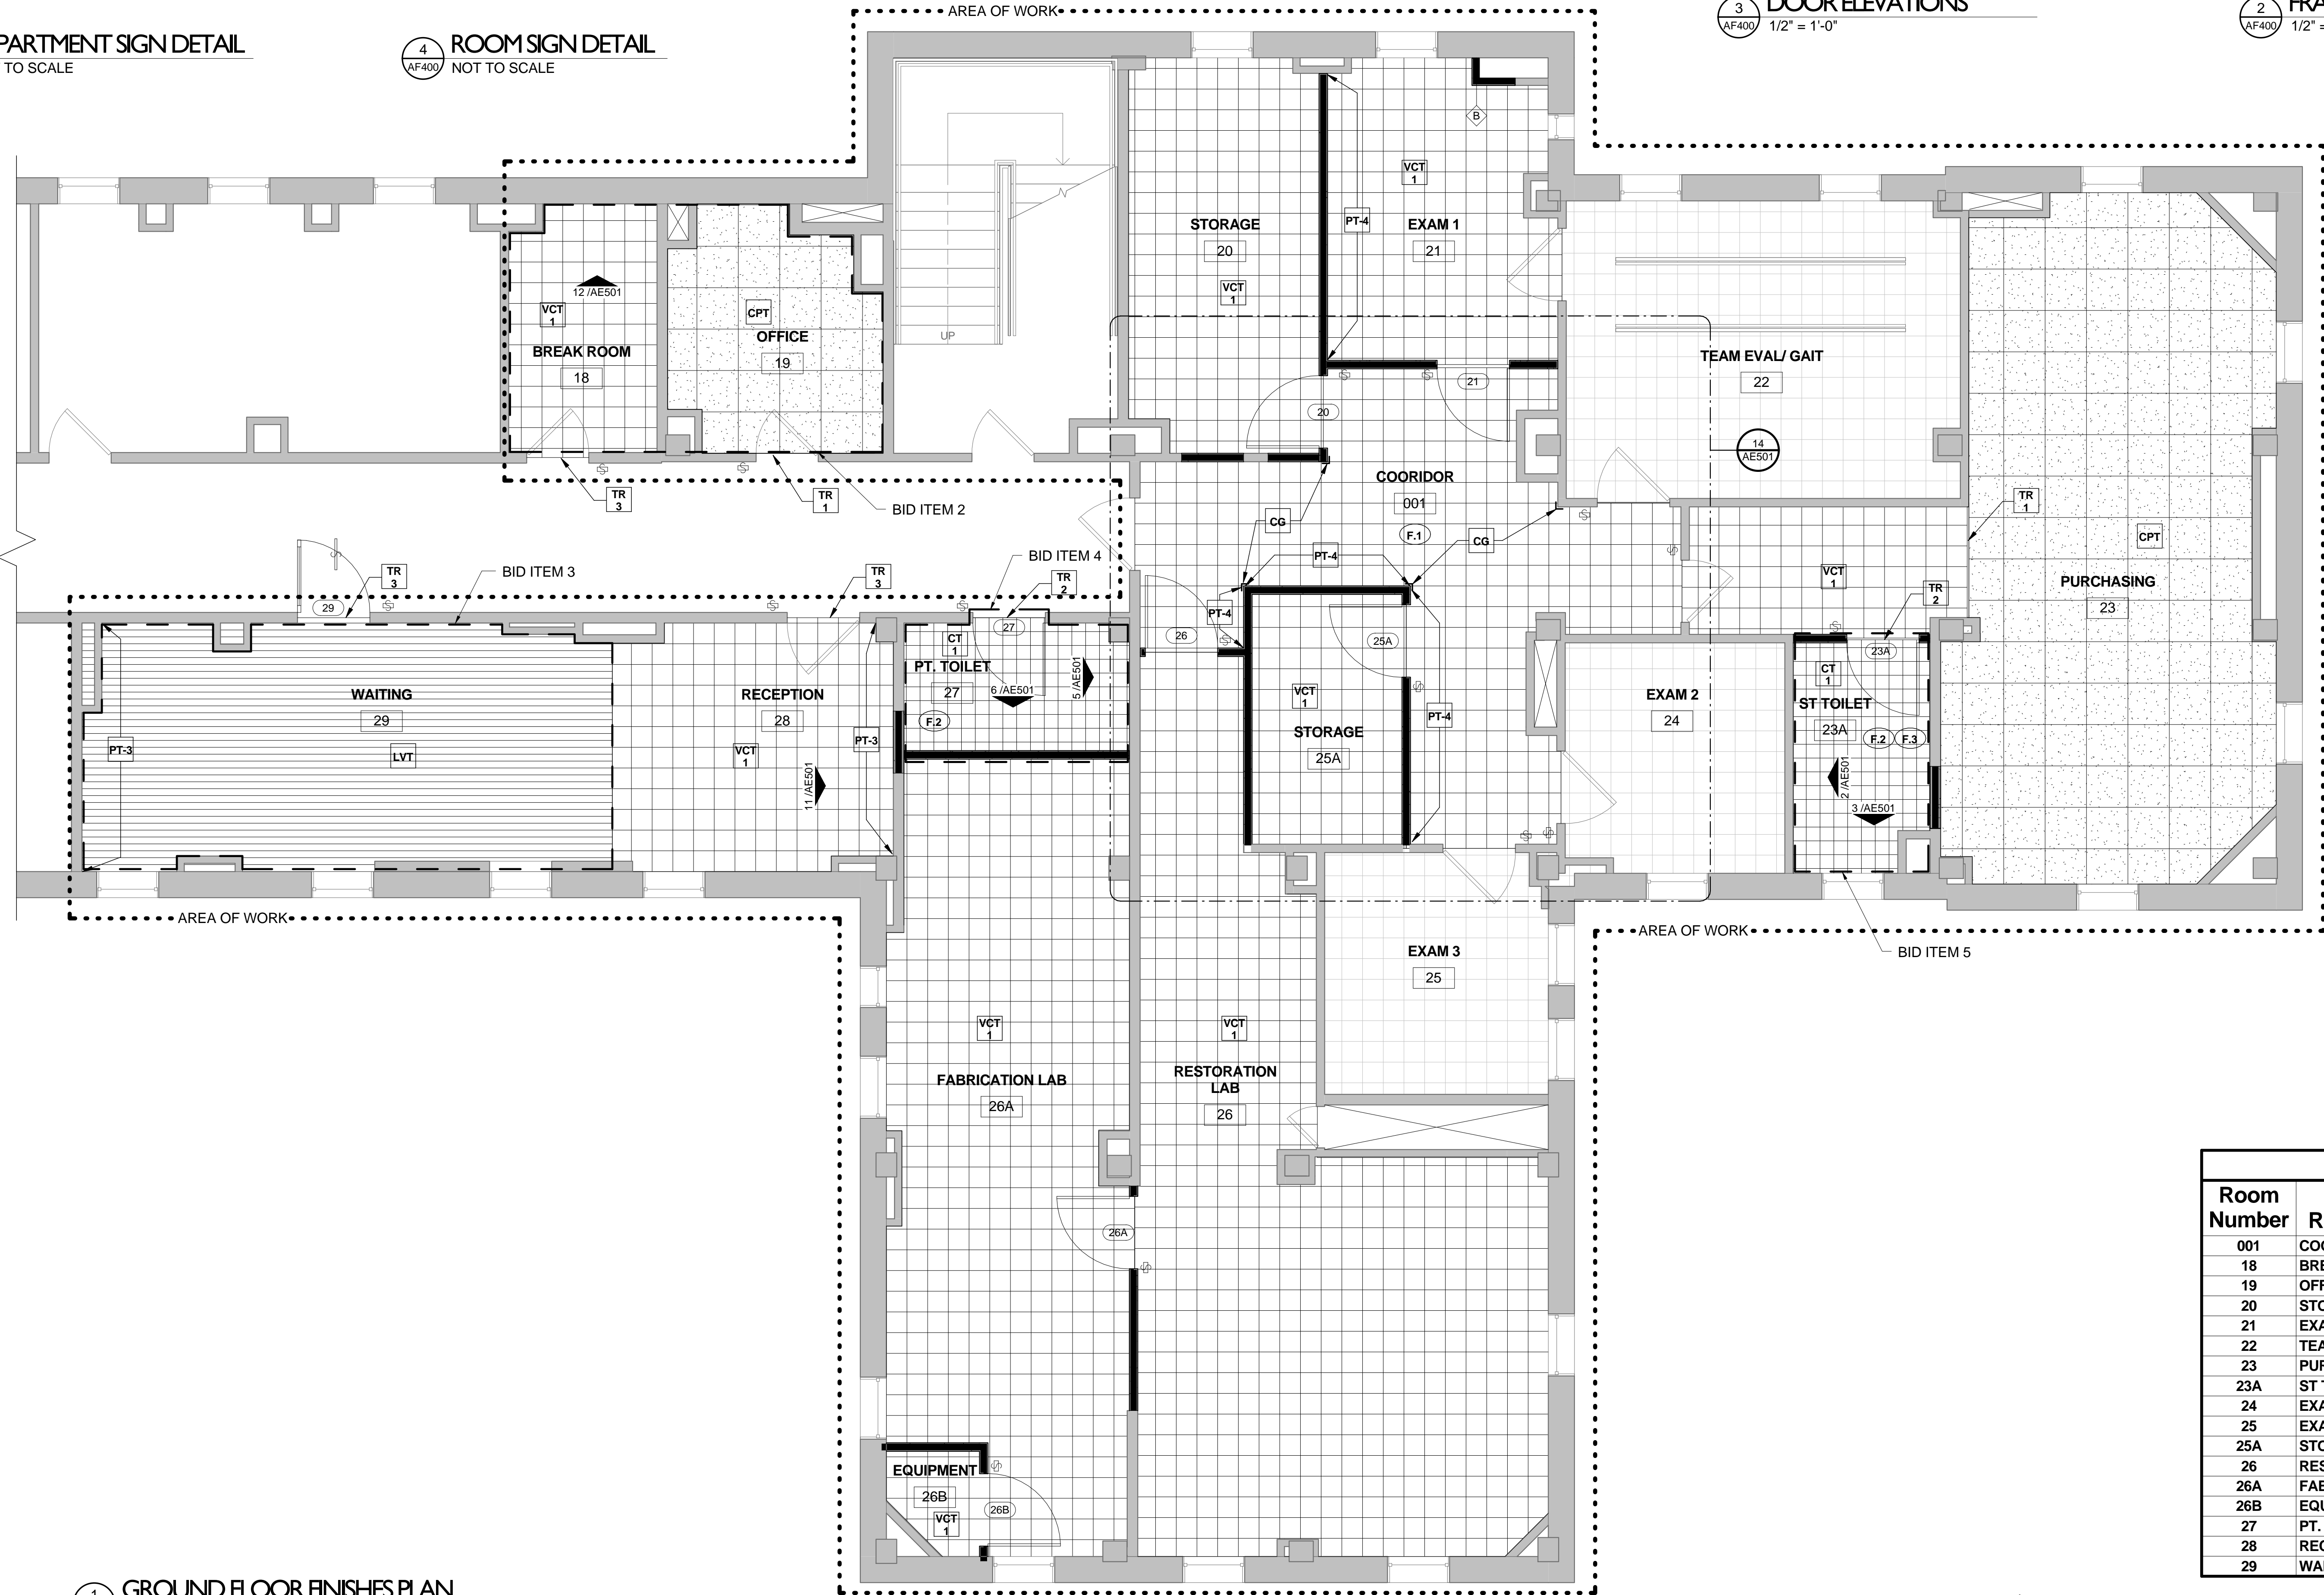

GROUND FLOOR FINISHES PLAN
1/4" = 1'-0"

ROOM FINISH SCHEDULE									
Room Number	Room Name	Floor	Base	Walls North	Walls East	Walls South	Walls West	Ceiling	REMARKS
001	COORDINATOR	VCT	RCB	PT 3	PT 3	PT 1	PT 3	ACT	
18	BREAK ROOM	VCT 1	RCB	PT 1	PT 1	PT 1	PT 1	ACT	
19	OFFICE	CPT	RCB	PT 1	PT 1	PT 1	PT 1	ACT	
20	STORAGE	VCT 1	RCB	PT 1	PT 1	PT 1	PT 1	ACT	
21	EXAM 1	VCT 1	RCB	PT 1	PT 3	PT 1	PT 1	ACT	
22	TEAM EVAL/ GAIT	ETR	ETR	ETR	ETR	ETR	ETR	ETR	
23	PURCHASING	CPT	RCB	PT 1	PT 1	PT 1	PT 1	ACT	
23A	ST TOILET	CT	CT	PT 1	PT 1	PT 1	PT 1	ACT	
24	EXAM 2	ETR	ETR	ETR	ETR	ETR	ETR	ETR	
25	EXAM 3	ETR	ETR	ETR	ETR	ETR	ETR	ETR	
25A	STORAGE	VCT 1	RCB	PT 1	PT 1	PT 1	PT 1	ACT	
26	RESTORATION LAB	VCT 1	RCB	PT 1	PT 1	PT 1	PT 1	ACT	
26A	FABRICATION LAB	VCT 1	RCB	PT 1	PT 1	PT 1	PT 1	ACT	
26B	EQUIPMENT	VCT 1	RCB	PT 1	PT 1	PT 1	PT 1	GYP	
27	PT. TOILET	CT	CT	PT 1	PT 1	PT 1	PT 1	ACT	
28	RECEPTION	VCT 1	RCB	PT 1	PT 1	PT 1	PT 3	ACT	
29	WAITING	LVT	RCB	PT 1	PT 3	PT 1	PT 1	ACT	

Revisions:

Date:

MEP / HVAC DESIGN

BCCLT, Inc.

www.BCCLT.com

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CONSULTING ENGINEERS

PROJECT LEADER/ARCHITECT:

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2453 N. DELAWARE ST. INDIANAPOLIS, IN. 46205
317.800.6388 WWW.GUIDONDESIGN.COM
SUSTAINABLE ARCHITECTURE + ENGINEERING

Drawing Title

FINISHES FLOOR PLAN

Approved for Design Concept:

Checked By: STW
Drawn By: ARO

Project Title

RENOVATE PROSTHETICS

Location
LEXINGTON VAMC LD

Date
2/21/2013

Project Number

596-12-103

Building Number


Bldg-1

Drawing Number

AF400

VETERANS ADMINISTRATION MEDICAL CENTER

Department of Veterans Affairs

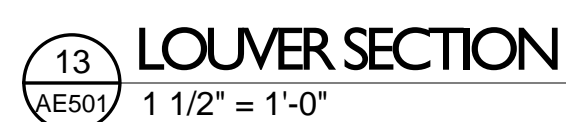


ELEVATION II - TOILET 23 B
 1/2" = 1'-0" **BID ITEM 5**

2 ELEVATION I - TOILET 23 B
AE501 1/2" = 1'-0" **BID ITEM 5**

1 ENLARGED TOILET PLAN
AE501 1/2" = 1'-0" **BID ITEM 5**


FULLY SPRINKLERED

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MEP / HVAC DESIGN		
BCCLT, Inc.	MEP ENGINEERS 601 MAIN STREET SHELBYVILLE, KY 40065 T:502-633-1506	BCCLT Bugli, Chance, Cummins, London, Titzer <hr/> <i>CONVULSING TRADITION</i>
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
SUSTAINABLE ARCHITECTURE + ENGINEERING

Drawing Title

SECTIONS AND
DETAILS

Approved for Design Concept:

John M. Dwyer

Project Title RENOVATE PROSTHETICS		Project Number 596-12-103		VETERANS ADMINISTRATION MEDICAL CENTER
		Building Number Bldg-1		
Location LEXINGTON VAMC LD		Drawing Number AE501		
Date 2/21/2013	Checked By: STW	Drawn By: ARO	 Department of Veterans Affairs	