

three inches = one foot  
one and one half inches = one foot  
one inch = one foot  
three quarters inch = one foot  
one half inch = one foot  
one quarter inch = one foot  
three eighths inch = one foot  
one eighth inch = one foot  
one sixteenth inch = one foot

### KEYNOTES

26.201 LIMITS OF ELECTRICAL RENOVATION.

26.401 PROVIDE LOCKABLE, THERMOPLASTIC, VENTED ENCLOSURE FOR (3) DIMMER SWITCHES.

26.403 MANUAL OVERRIDE SWITCH FOR CONTROL OF LIGHTING. LABEL "MASTER LIGHTING CONTROL". SEE LIGHTING CONTROL SCHEDULE FOR ADDITIONAL INFORMATION.


### ROOM SCHEDULE

RM. NO.	ROOM NAME	RM. NO.	ROOM NAME
153E	WOMEN'S TOILET		
153F	MEN'S TOILET		
154A	OPEN OFFICE		
154B	OFFICE		
154C	OFFICE		
154D	KITCHENETTE		
154E	CONFERENCE ROOM		
155	VESTIBULE		
155A	MAINTENANCE OFFICE AREA		
155B	MAINTENANCE WORKSHOP/STORAGE AREA		


### GENERAL NOTES

- REFER TO ARCHITECTURAL, MECHANICAL, PLUMBING, FIRE PROTECTION PLANS, SHOP DRAWINGS AND MANUFACTURERS INSTALLATION INSTRUCTIONS FOR ADDITIONAL INFORMATION ON EXACT POWER, WIRING & ROUGH-IN REQUIREMENTS AND LOCATIONS OF DEVICES.
- ROUTE ALL LIGHTING CIRCUITS TO PANEL "LB-3", UNLESS OTHERWISE NOTED.
- ROUTE ALL 120V POWER CIRCUITS TO PANEL "PB-3", UNLESS OTHERWISE NOTED.
- UNLESS NOTED OTHERWISE, ALL HOMERUNS SHALL CONSIST OF A MAXIMUM OF 3 CIRCUITS (PHASE A, B & C, NEUTRAL & GROUND) IN 3/4". MINIMUM WIRE SIZE SHALL BE #12 AWG. WIRE SIZE FOR RECEPTACLE HOMERUN CIRCUITS SHALL BE 3#12, 1#10N & 1#12G. PROVIDE LARGER SIZE WIRE FOR VOLTAGE DROP WHERE REQUIRED.
- ARROW LOCATED NEAR FIXTURE TYPES AND CIRCUIT NUMBERS DENOTES ALL FIXTURES IN DIRECTION OF ARROW SHALL BE THE SAME TYPE AND CIRCUIT NUMBER UNLESS NOTED OTHERWISE.
- ALL JUNCTION BOXES MUST BE SECURED TO BUILDING STRUCTURE PER NEC REQUIREMENTS.
- CONDUIT SHALL BE SECURED TO BUILDING STRUCTURE WITHIN 3" OF JUNCTION BOXES AND A MAXIMUM OF 10" ON CENTER.
- ALL NEW APPLICABLE ELECTRICAL, MECHANICAL AND ARCHITECTURAL COMPONENTS SHALL MEET THE SEISMIC DESIGN REQUIREMENTS FOR NONSTRUCTURAL COMPONENTS (CHAPTER 13, ASCE 7-05). REFER TO STRUCTURAL DRAWINGS FOR SEISMIC DESIGN CATEGORY AND ADDITIONAL INFORMATION REGARDING SEISMIC DESIGN CRITERIA.

### KEY PLAN

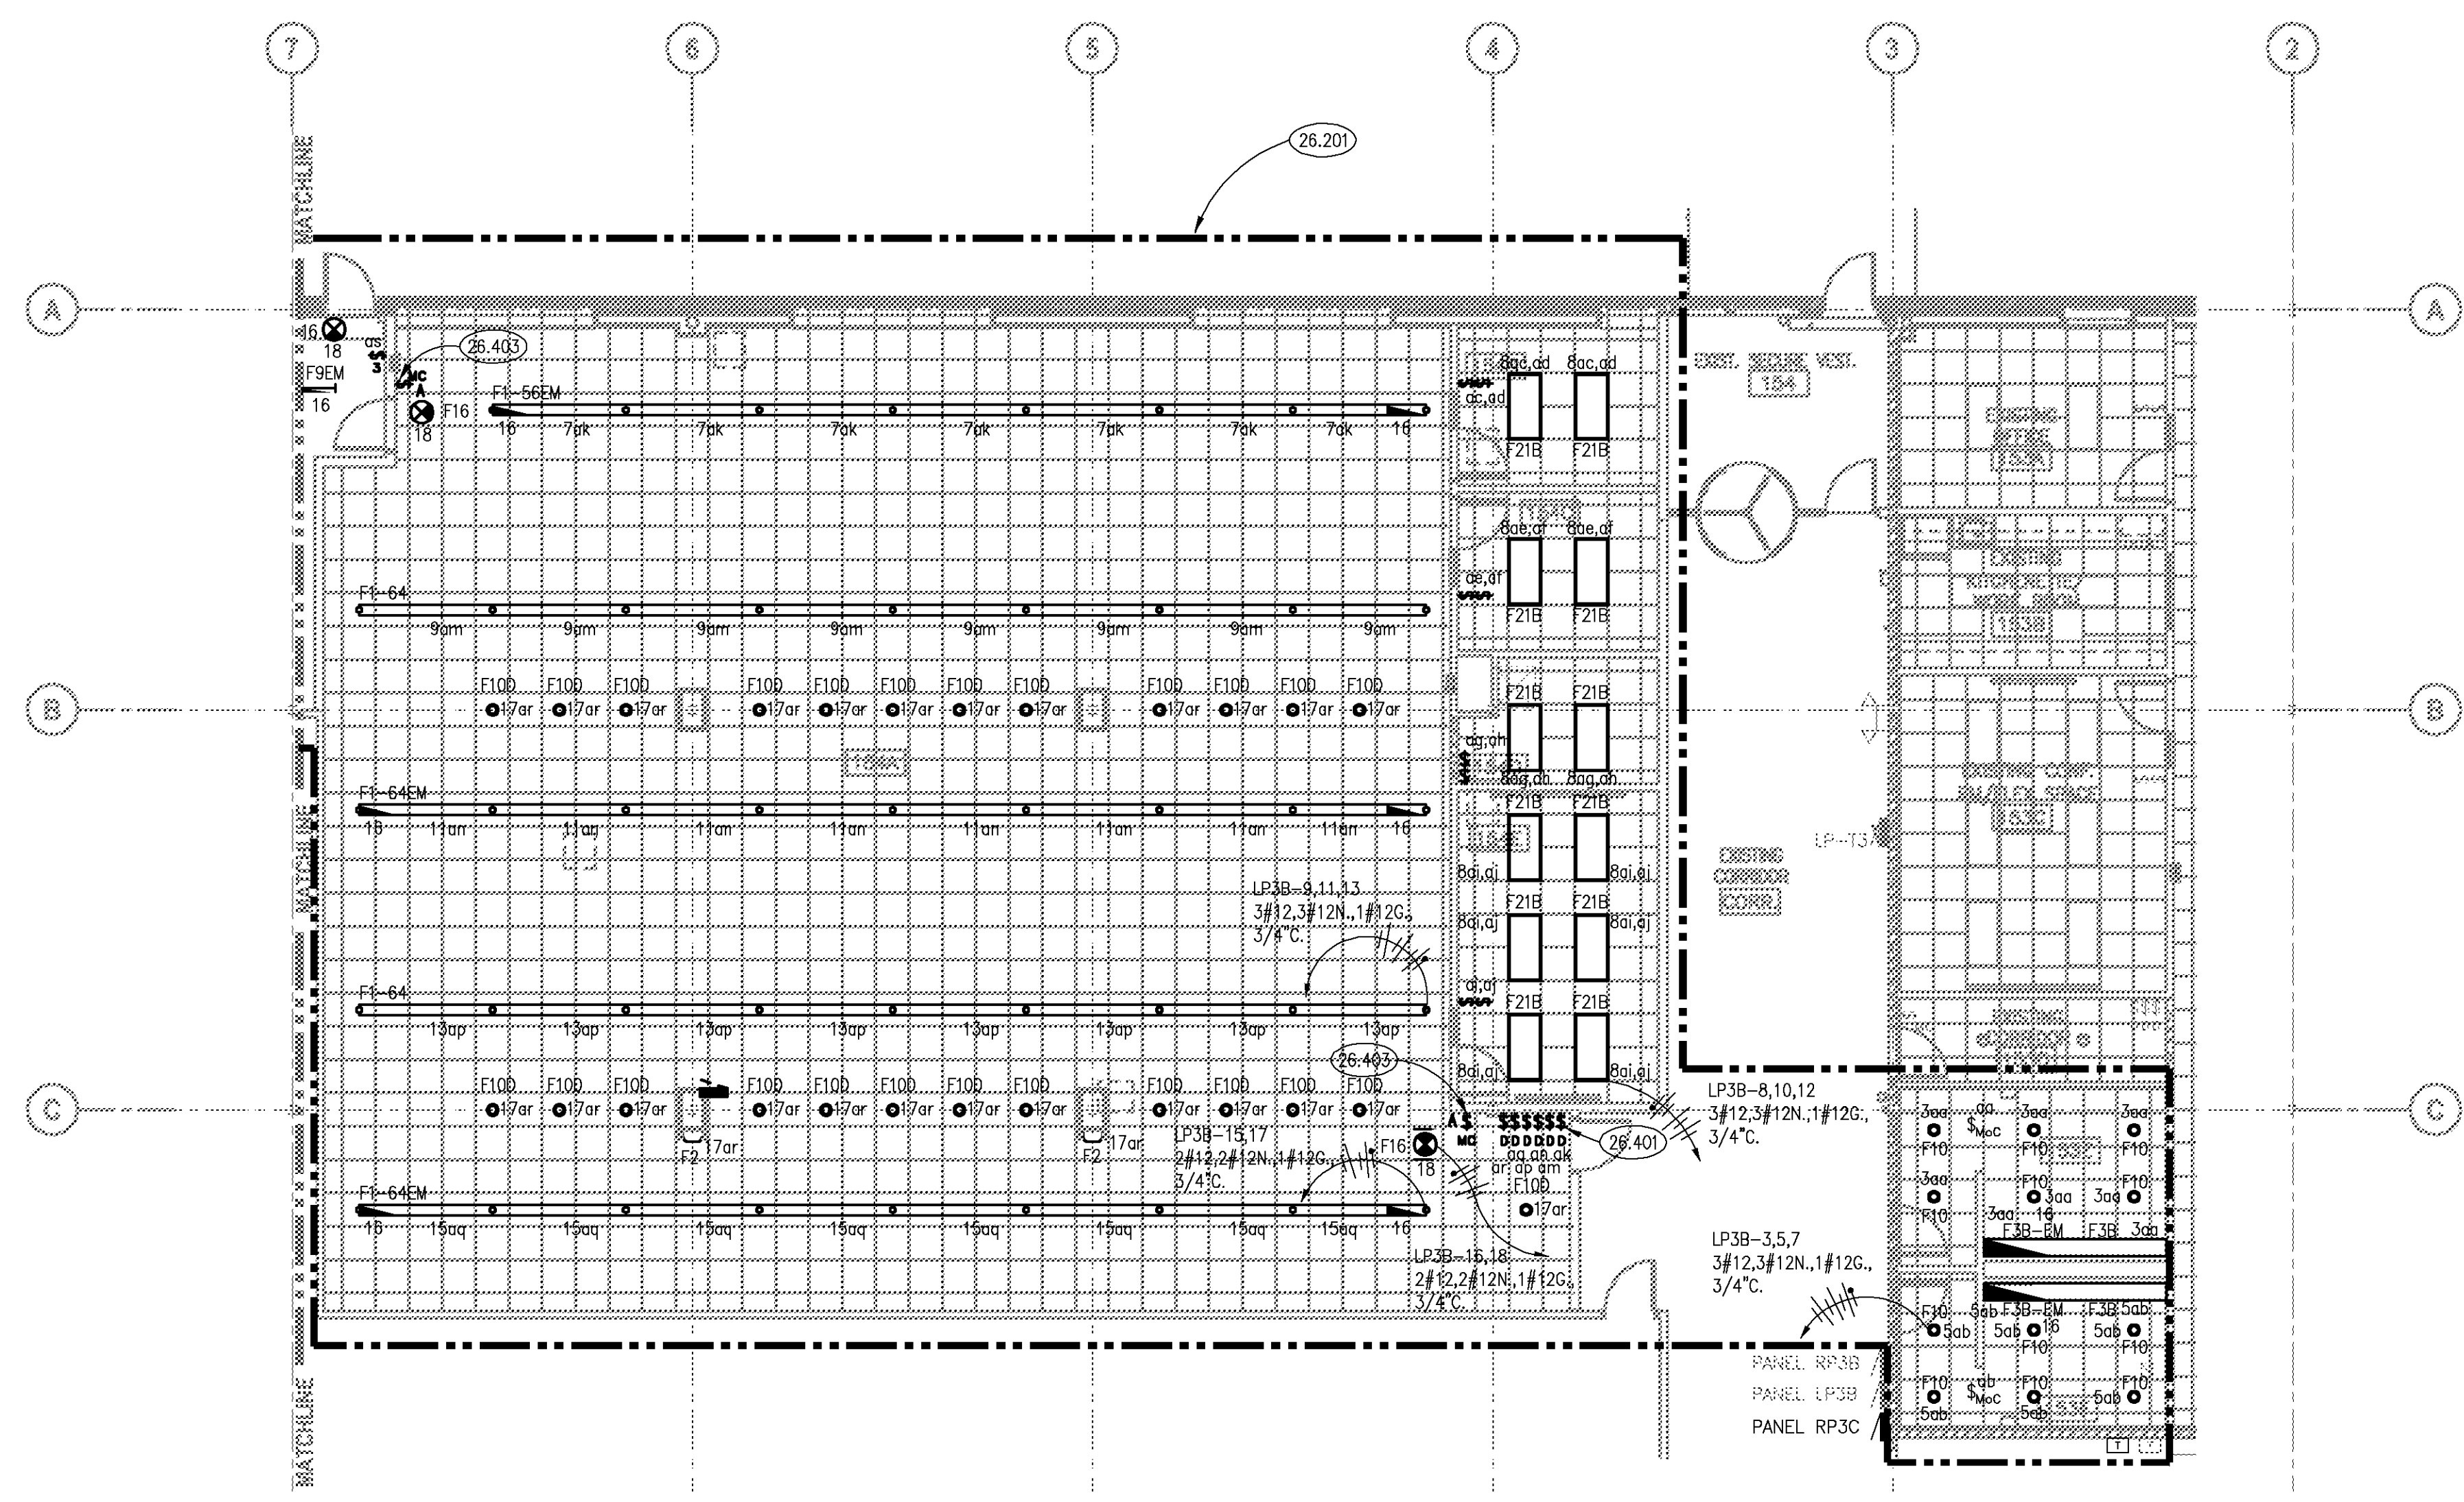

**1 PARTIAL FIRST FLOOR LIGHTING PLAN**  
SCALE: 1/8" = 1'-0"

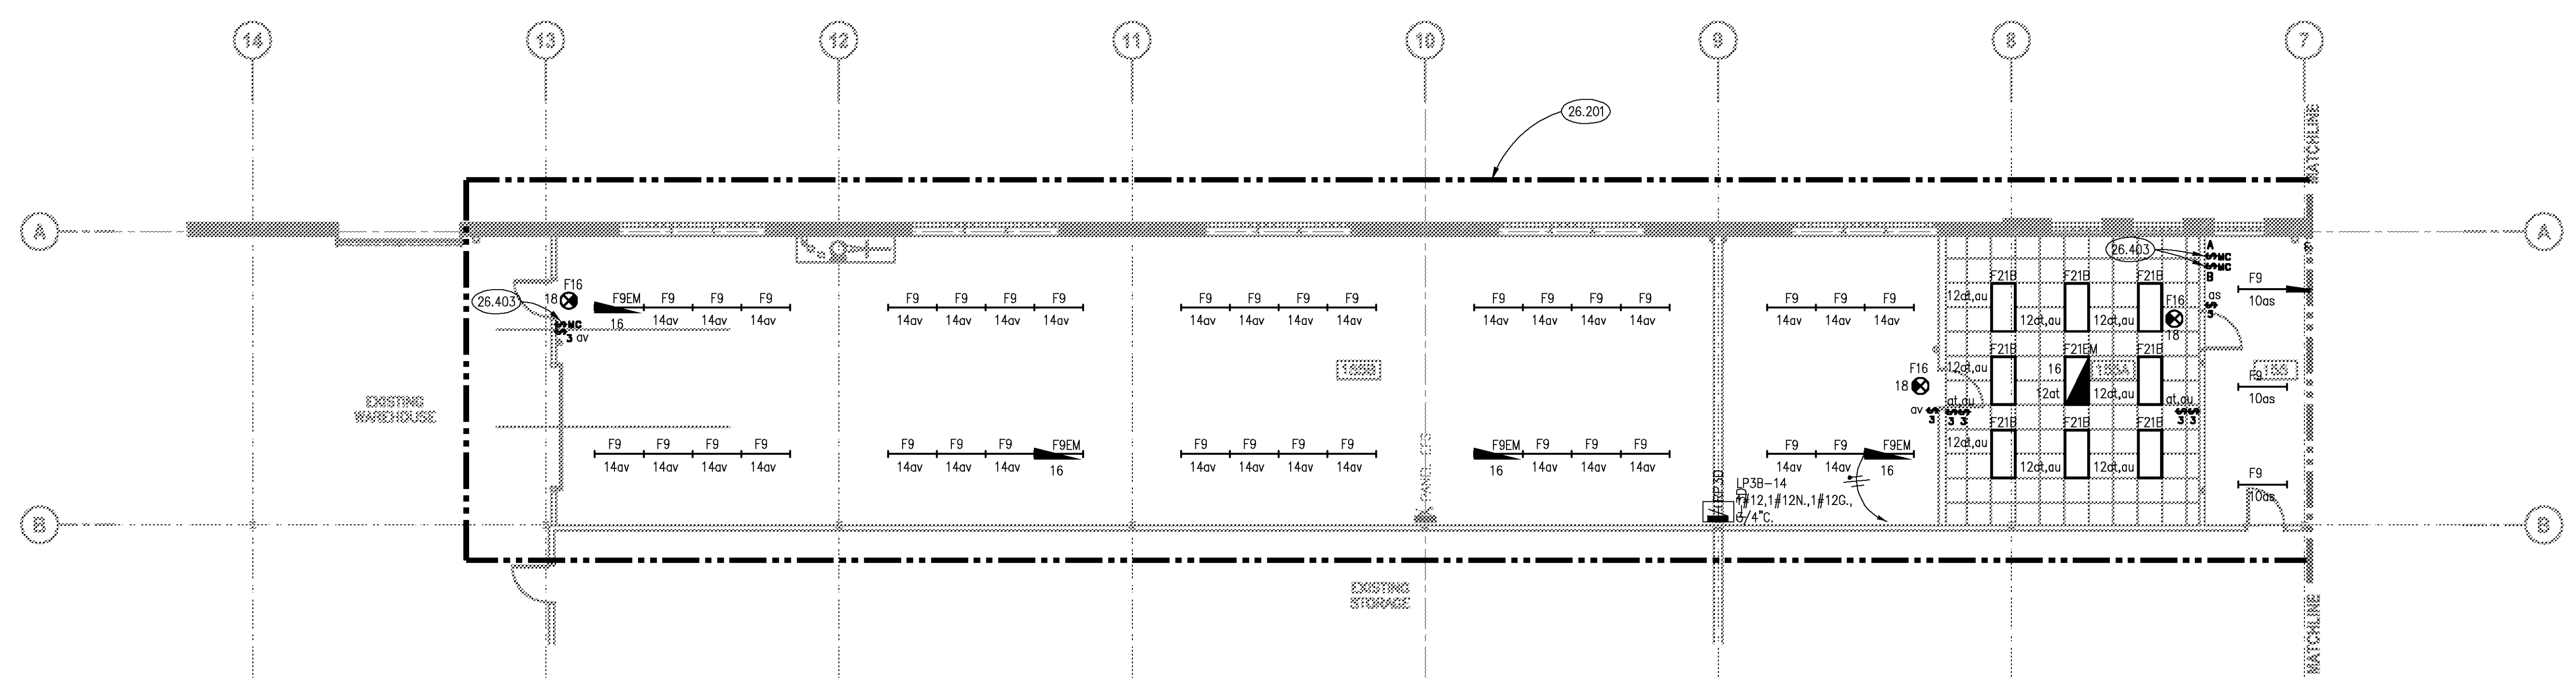

**2 PARTIAL FIRST FLOOR LIGHTING PLAN**  
SCALE: 1/8" = 1'-0"

<b>CONSULTANTS:</b>		<b>ARCHITECT/ENGINEERS:</b>		<b>Drawing Title</b>		<b>Project Title</b>		<b>Project Number</b>		<b>Office of Construction and Facilities Management</b> Department of Veterans Affairs	
				PARTIAL FIRST FLOOR LIGHTING PLANS		HINES BUILDING 37 O.I. AND T. FIELD OFFICES - PHASE 3 OFFICE AND RESTROOM RENOVATIONS		796-13-004			
				Approved: Project Director		Location VA OFFICE OF ACQUISITION AND LOGISTICS HINES, ILLINOIS		Building Number		<b>37 - E401</b> Dwg. 26 of 32	
						Date 04-12-13		Drawing Number			
						Checked MTK		Drawn JRW			

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100% CONSTRUCTION DOCUMENTS FOR BID 04-12-13

95% CONSTRUCTION DOCUMENTS SUBMITTAL 03-12-13

50% CONSTRUCTION DOCUMENTS SUBMITTAL 02-08-13

Revisions: Date