

ROOM	ROOM NAME	FLOOR FINISH	FINISH SCHEDULE			DOOR AND TRIM	COMMENTS
			BASIC FINISH	WALL FINISH	CEILING FINISH		
#1 FT	MEETING ROOM	EXISTING WOOD FLOOR	EXISTING PLASTER, PTD.	EXISTING PLASTER, PTD.	EXISTING PLASTER, PTD.	EXISTING WOOD, PTD.	
#2 OFFICE	LIBRARY	EXISTING WOOD FLOOR	EXISTING WOOD BASE, PTD.	EXISTING PLASTER, PTD.	EXISTING PLASTER, PTD.	EXISTING WOOD, PTD.	
#2 OFFICE	HALL	EXISTING WOOD FLOOR	EXISTING NEW WOOD BASE, PTD.	EXISTING PLASTER, PATCH PLASTER, PTD.	EXISTING NEW PLASTER, PTD.	EXISTING WOOD, PTD.	
#3		EXISTING WOOD FLOOR	EXISTING NEW WOOD BASE, PTD.	EXISTING PLASTER, ABOVE CHAIR RAIL, PTD.	EXISTING PLASTER, PTD.	EXISTING WOOD, PTD.	
#4 GA	HALL FRONT	EXISTING WOOD FLOOR	EXISTING WOOD BASE, PTD.	EXISTING PLASTER, NEW WALLPAPER, ABOVE CHAIR RAIL, PTD.	EXISTING PLASTER, NEW G伟B, PTD.	EXISTING NEW WOOD, PTD.	EAST PORTION OF HALL TO BE FULL HEIGHT WALLPAPER
#5 BSB	HALL 2ND FLOOR	EXISTING NEW WOOD FLOOR	EXISTING NEW WOOD BASE, PTD.	EXISTING PLASTER, CHAIR RAIL, PTD.	EXISTING PLASTER, PTD.	EXISTING NEW WOOD, PTD.	
#6	BREAK OUT ROOM	EXISTING WOOD PARQUET FLOOR	EXISTING WOOD BASE, PTD.	EXISTING PLASTER, PTD.	EXISTING PLASTER, STAINED	EXISTING WOOD, PTD.	
#6	DANCE ROOM	EXISTING WOOD FLOOR	EXISTING WOOD BASE, PTD.	EXISTING PLASTER, PTD.	EXISTING PLASTER, PTD.	EXISTING WOOD, PTD.	
#6	OFFICE	EXISTING NEW WOOD FLOOR	EXISTING NEW WOOD BASE, PTD.	EXISTING PLASTER, NEW WALLPAPER	EXISTING PLASTER, PTD.	EXISTING NEW WOOD, PTD.	
#6	HALL ADDITION	REFINISHED WOOD FLOOR	EXISTING NEW WOOD BASE, PTD.	EXISTING PLASTER, PATCH PLASTER, NEW WALLPAPER	EXISTING PLASTER, PTD.	EXISTING NEW WOOD, PTD.	
#7 PORCH	NEWWOOD FLOOR	EXISTING WOOD BASE, PTD.	EXISTING WOOD BASE, PTD.	EXISTING WOOD, PTD.	EXISTING WOOD, PTD.	EXISTING NEW WOOD, PTD.	
#7 #8 OFFICE	CATERING KITCHEN	EXISTING NEW WOOD FLOOR	EXISTING PLASTER, PATCH PLASTER, PTD.	EXISTING PLASTER, PATCH PLASTER, PTD.	EXISTING PLASTER, PTD.	EXISTING NEW WOOD, PTD.	
#8	OFFICE	NEW INNOLUM CERAMIC TILE	EXISTING CERAMIC TILE	EXISTING PLASTER, NEW G伟B, PTD.	EXISTING PLASTER, NEW G伟B, PTD.	EXISTING NEW WOOD, PTD.	
#10	MAIL ROOM	NEW CERAMIC TILE	EXISTING CERAMIC TILE	EXISTING PLASTER, NEW G伟B, PTD.	EXISTING PLASTER, NEW G伟B, PTD.	EXISTING NEW WOOD, PTD.	
#10	MAIL ROOM AUDITION	NEW CERAMIC TILE	EXISTING CERAMIC TILE	EXISTING PLASTER, NEW G伟B, PTD.	EXISTING PLASTER, NEW G伟B, PTD.	EXISTING NEW WOOD, PTD.	
#10	WORK ROOM 1	NEW CARPET	EXISTING NEW WOOD BASE	EXISTING PLASTER, NEW G伟B, PTD.	EXISTING PLASTER, NEW G伟B, PTD.	EXISTING NEW WOOD, PTD.	
#14	WORK ROOM 2	NEW CARPET	EXISTING NEW WOOD BASE	EXISTING PLASTER, NEW G伟B, PTD.	EXISTING PLASTER, NEW G伟B, PTD.	EXISTING NEW WOOD, PTD.	
#15	MEMBERS RESTROOM	NEW #7 X 2" CERAMIC TILE	NEW CERAMIC TILE	EXISTING PLASTER, NEW G伟B, PTD.	EXISTING PLASTER, NEW G伟B, PTD.	EXISTING NEW WOOD, PTD.	
#15	MEMBERS RESTROOM	NEW #7 X 2" CERAMIC TILE	NEW CERAMIC TILE	EXISTING PLASTER, NEW G伟B, PTD.	EXISTING PLASTER, NEW G伟B, PTD.	EXISTING NEW WOOD, PTD.	
#15	UNCOUPLED	WAX	WAX	WAX	WAX	WAX	
#15	UNCOUPLED	WAX	WAX	WAX	WAX	WAX	
#15	UNCOUPLED	WAX	WAX	WAX	WAX	WAX	
#22	UNCOUPLED	WAX	WAX	WAX	WAX	WAX	
#22	LAUNDRY ROOM	WAX	WAX	WAX	WAX	WAX	
#A-1	UNCOUPLED	WAX	WAX	WAX	WAX	WAX	
#A-2	UNCOUPLED	WAX	WAX	WAX	WAX	WAX	
#A-3	WORK SHOP	WAX	WAX	WAX	WAX	WAX	
#A-4	WORK SHOP	WAX	WAX	WAX	WAX	WAX	


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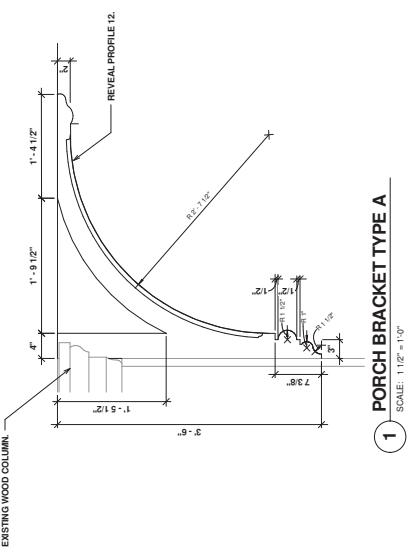
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***RESTROOM ACCESSORIES ARE AN ADD ALTERNATE**


RESTROOM ACCESSORY SCHEDULE					
MARK	DESCRIPTION	MODEL	FINISH		
A	BOBRICK 12765123 TWO-WALL TOILET COMPT. GRAB BAR	B-6807	SATIN STAINLESS STEEL		
B	TM LINE SERIES RECESSED PAPER TOWEL DISPENSER AND WASTE RECEPACLE	B-39003	SATIN STAINLESS STEEL		
C	NOT USED				
D	BOBRICK 12765122 DOUBLE E-ROLL TOILET TISSUE DISPENSER WITH CONTROLLED DEFLECTED BEVEL	B-265	POLISHED CHROME PLATED STEEL		
E	BOBRICK 12765123 COAT HOOK	B-542	SATIN STAINLESS STEEL		
F	BOBRICK 12765123 MIRROR WITH STAINLESS STEEL CHANNEL FRAME	B-165	POLISHED STAINLESS STEEL - FRAME		
G	BOBRICK 12765123 LAVATORY MOUNTED SOAP DISPENSER	B-821	POLISHED STAINLESS STEEL		
H	NOT USED				
I	NOT USED				
J	TRASH CAN				
K	1 1/2" STAINLESS STEEL GRAB BAR WITH SNAP FLANGE	D-5806	SATIN STAINLESS STEEL		
L	KYSON LINER ARM AND HAND DRYER				

FINISH SCHEDULE		RENOVATE MILLHOUSE AND GRISTMILL CENTER VA MEDICAL CENTER		DEPARTMENT OF HEALTH AND HUMAN SERVICES	
Approved Associate Chief for Maintenance and Operations, Perry Point	Project No. 501AE6.03	Building No. 501	Checklist: LM DB	Date: Ding 23 01 33	Building No. 501AE6.03
Approved Associate Director of Operations,					
Approved Director, Medical Center					




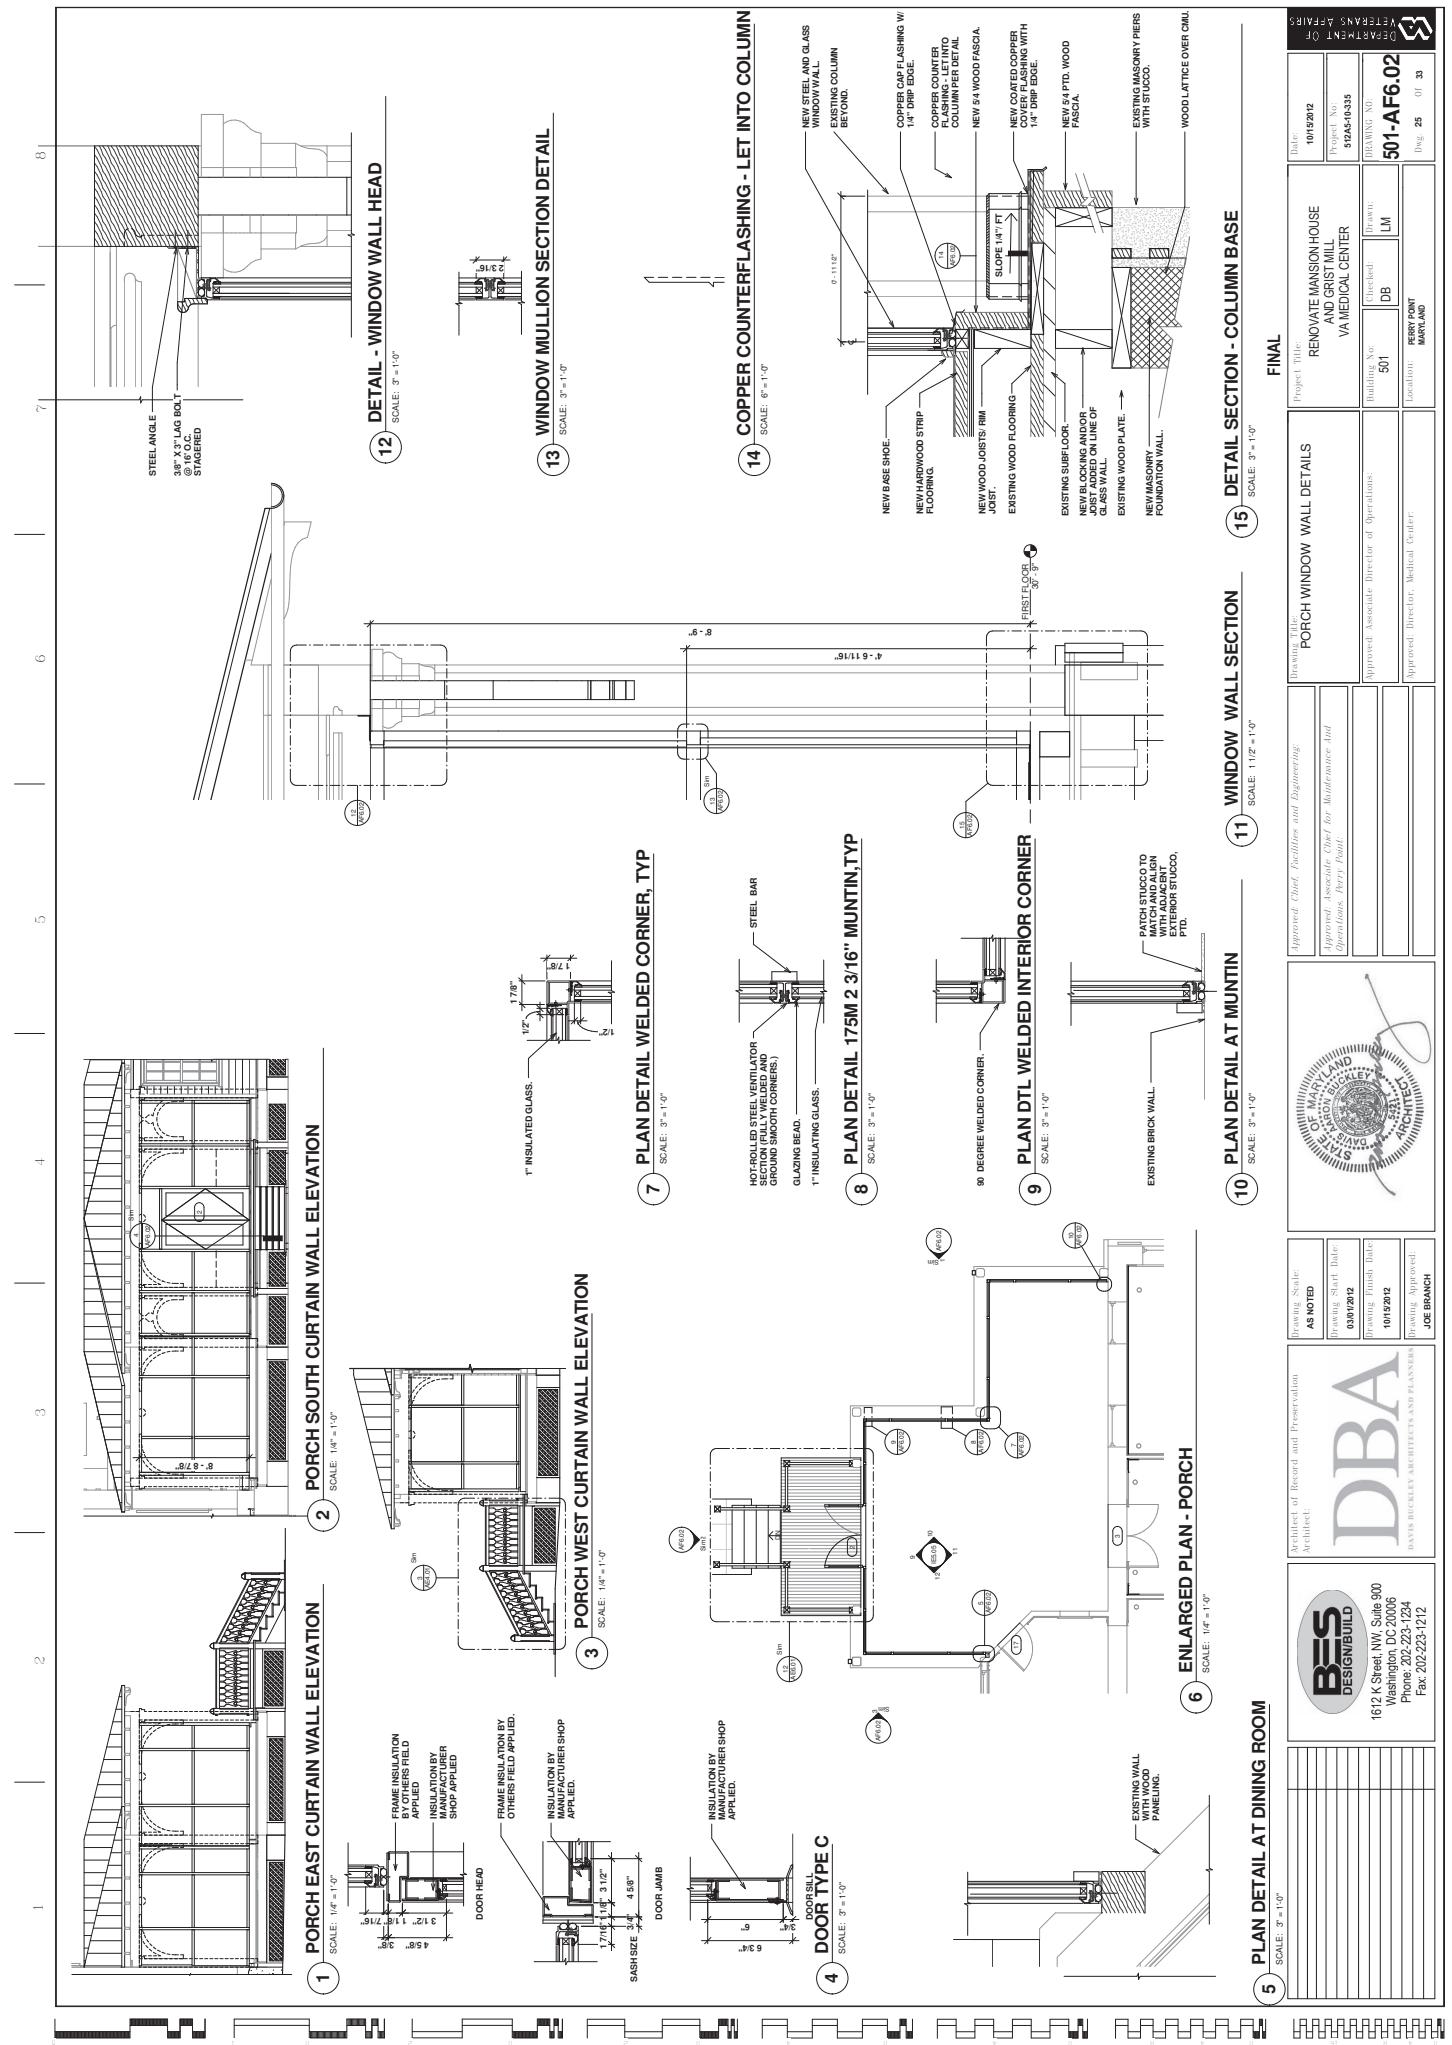

PORCH BRACKET TYPE A

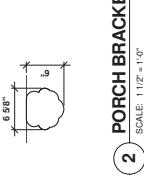


PORCH BRACKET TYPE B

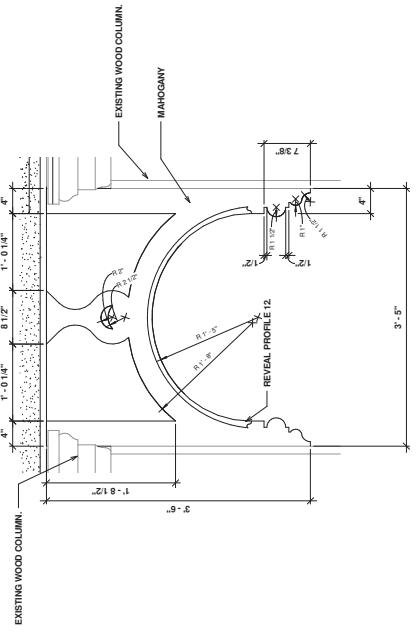


PORCH BRACKET TYPE C

	
1612 K Street, NW, Suite 900 Washington, DC 20006 Phone: 202-223-1234 Fax: 202-223-1212	
<p>DBA <small>DAVIS BUCKLEY ARCHITECTS AND PLANNERS</small></p>	
<p>Architect of Record and Preservation Architect:</p>	
<p>AS NOTED</p>	
<p>Drawing Scale:</p>	
<p>Drawing Start Date: 10/13/2012</p>	
<p>Drawing Finish Date: 10/13/2012</p>	
<p>Drawing Approved: JOE BRANCH</p>	
	
<p>PORCH BRACKET DETAILS</p>	
<p>Approved <i>Chief Facilities and Engineering</i> Approved <i>Associate Chief for Maintenance and Operations, Perry Point</i></p>	
<p>Approved: Associate Director of Operations 10/13/2012</p>	
<p>Approved: Director, Medical Center 10/13/2012</p>	
<p>Drawing Title:</p>	
<p>RENOVATE MANSION HOUSE AND GRIST MILL VA MEDICAL CENTER</p>	
<p>Project Title:</p>	
<p>501-AF6.03</p>	
<p>Date:</p>	
<p>10/13/2012</p>	
<p>Printed Name:</p>	
<p>5245-0335</p>	
<p>Building No:</p>	
<p>501</p>	
<p>Building No:</p>	
<p>LM</p>	
<p>Created:</p>	
<p>LM</p>	
<p>Drawn:</p>	
<p>LM</p>	
<p>Location:</p>	
<p>PERY POINT MARYLAND</p>	
<p>Date:</p>	
<p>10/ 26 / 13</p>	

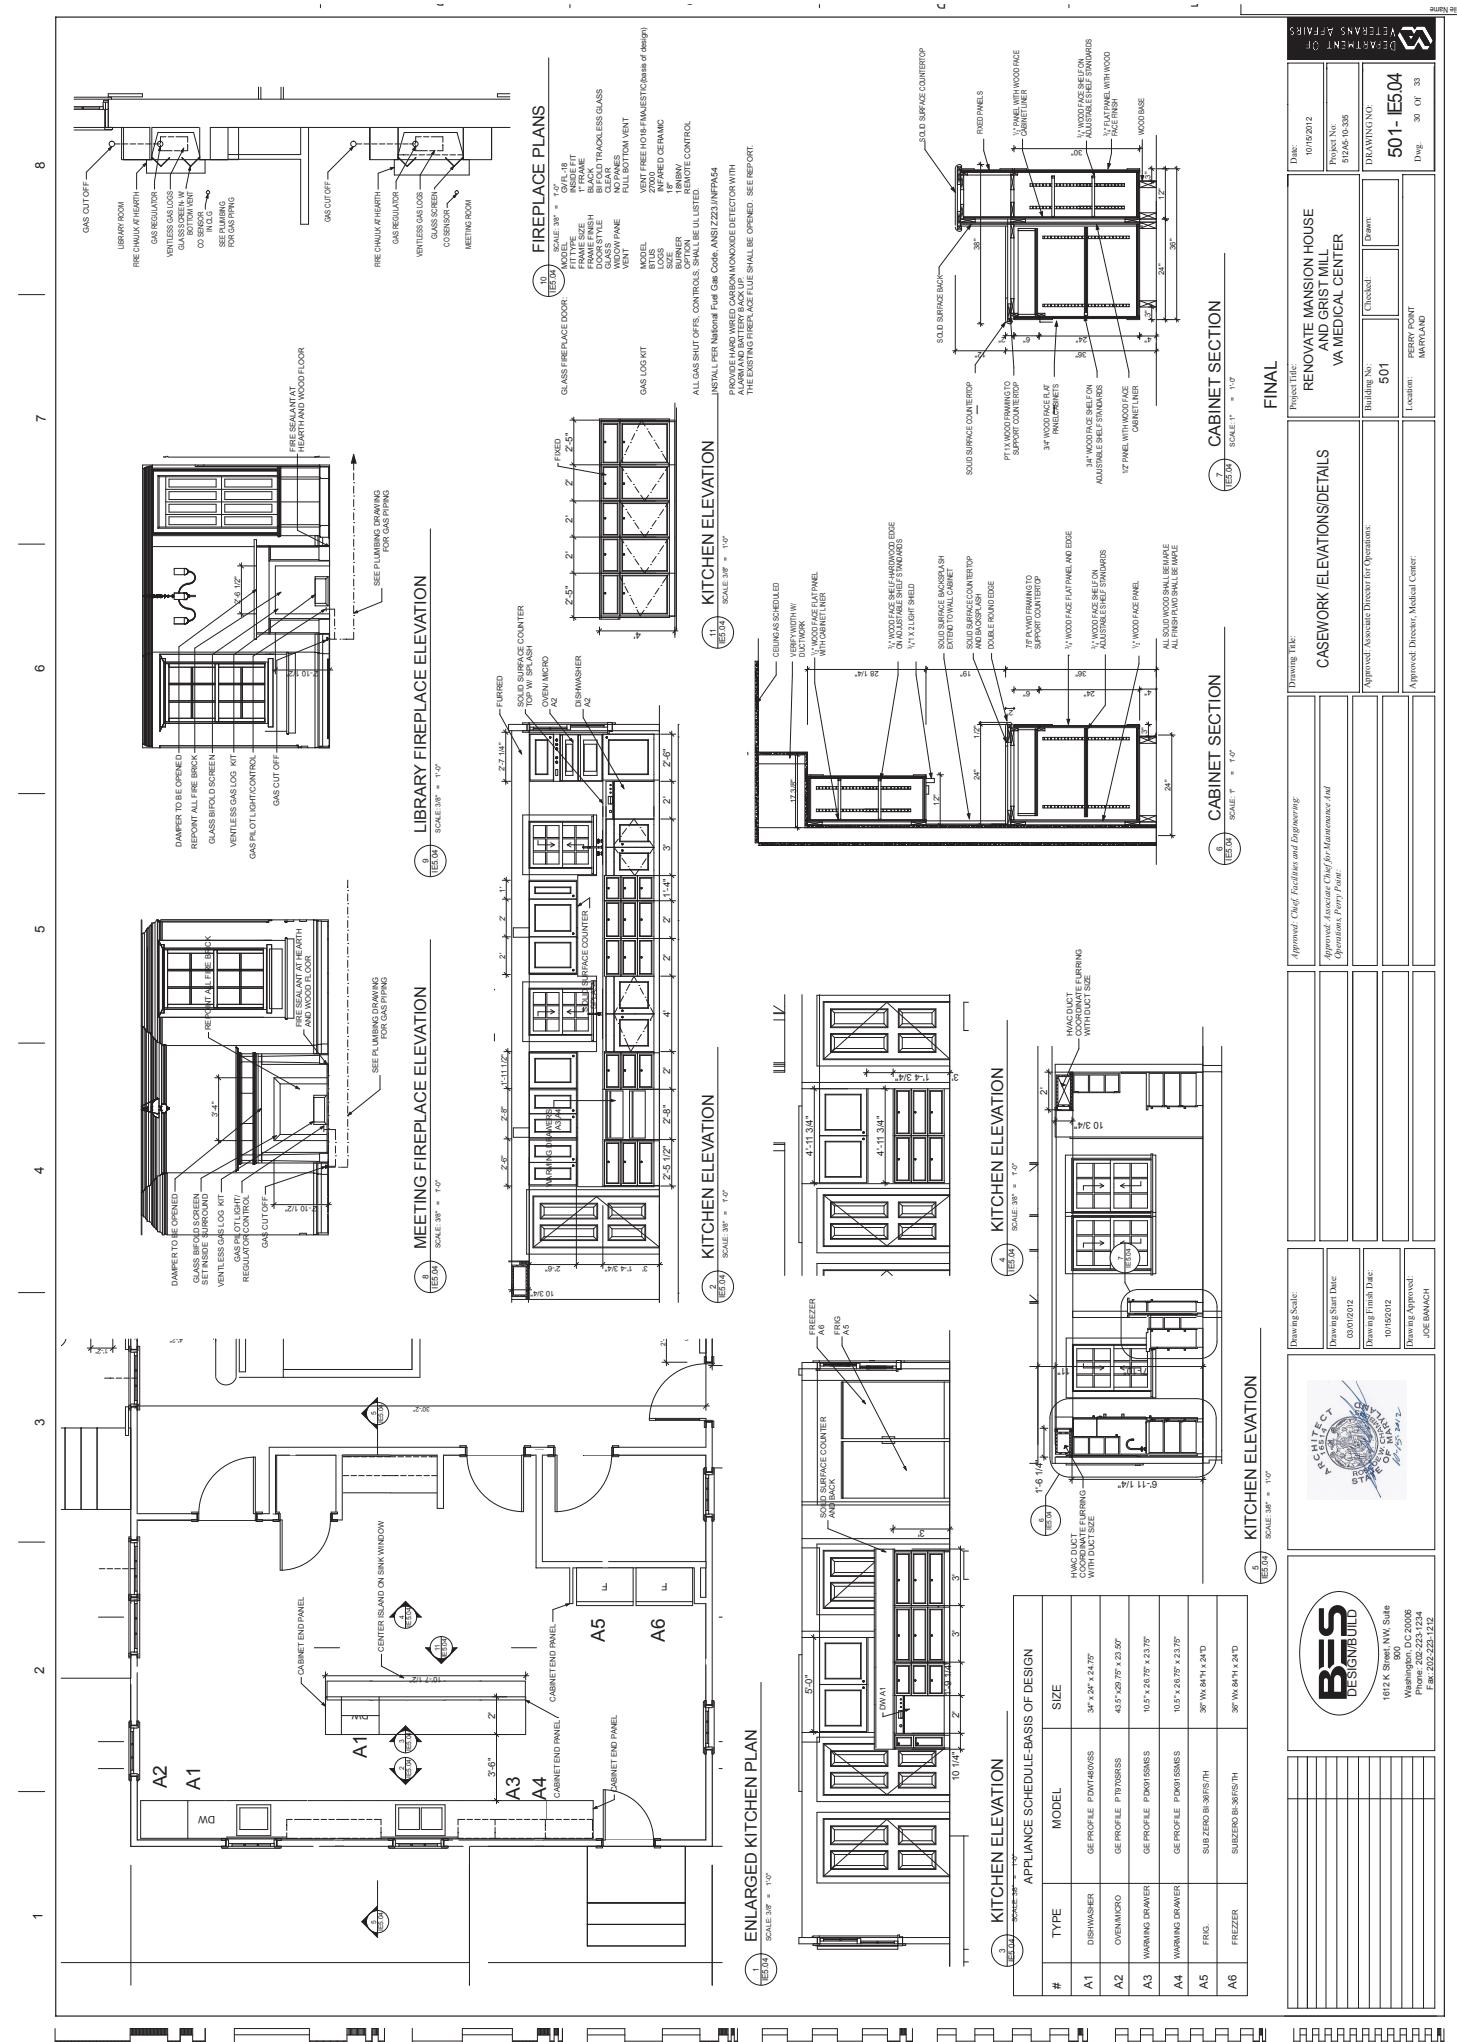

KEYNOTE LEGEND		KEYNOTE TEXT	
NUMBER		(N) NEW (E) EXISTING	
60		(N) BASE MOULDING TO MATCH ADJACENT PROFILE (P-A), SEE SHEET 591-A#5-A1.	
61		(N) CROWN MOULDING TO MATCH IN CROWN PROFILE (P-A), SEE SHEET 591-A#5-A1.	
62		(N) REPAIR PLASTER WALL TO MATCH AND ALIGN WITH ADJACENT MOULDING TO MATCH SHEET 591-A#5-A1.	
63		(N) REPAIR PLASTER WALL TO MATCH AND ALIGN WITH ADJACENT MOULDING TO MATCH SHEET 591-A#5-A1.	
64		(N) REPAIR PLASTER WALL TO MATCH AND ALIGN WITH ADJACENT MOULDING TO MATCH SHEET 591-A#5-A1.	
65		(N) REPAIR PLASTER WALL TO MATCH AND ALIGN WITH ADJACENT MOULDING TO MATCH SHEET 591-A#5-A1.	
66		(N) REPAIR PLASTER WALL TO MATCH AND ALIGN WITH ADJACENT MOULDING TO MATCH SHEET 591-A#5-A1.	
		DETAILSHEET NO. A#5-A1	
		REPAIRS TO EXISTING	
		WALLS	
		CROWN MOULDING	
		BASE MOULDING	
		PLASTER REPAIRS	

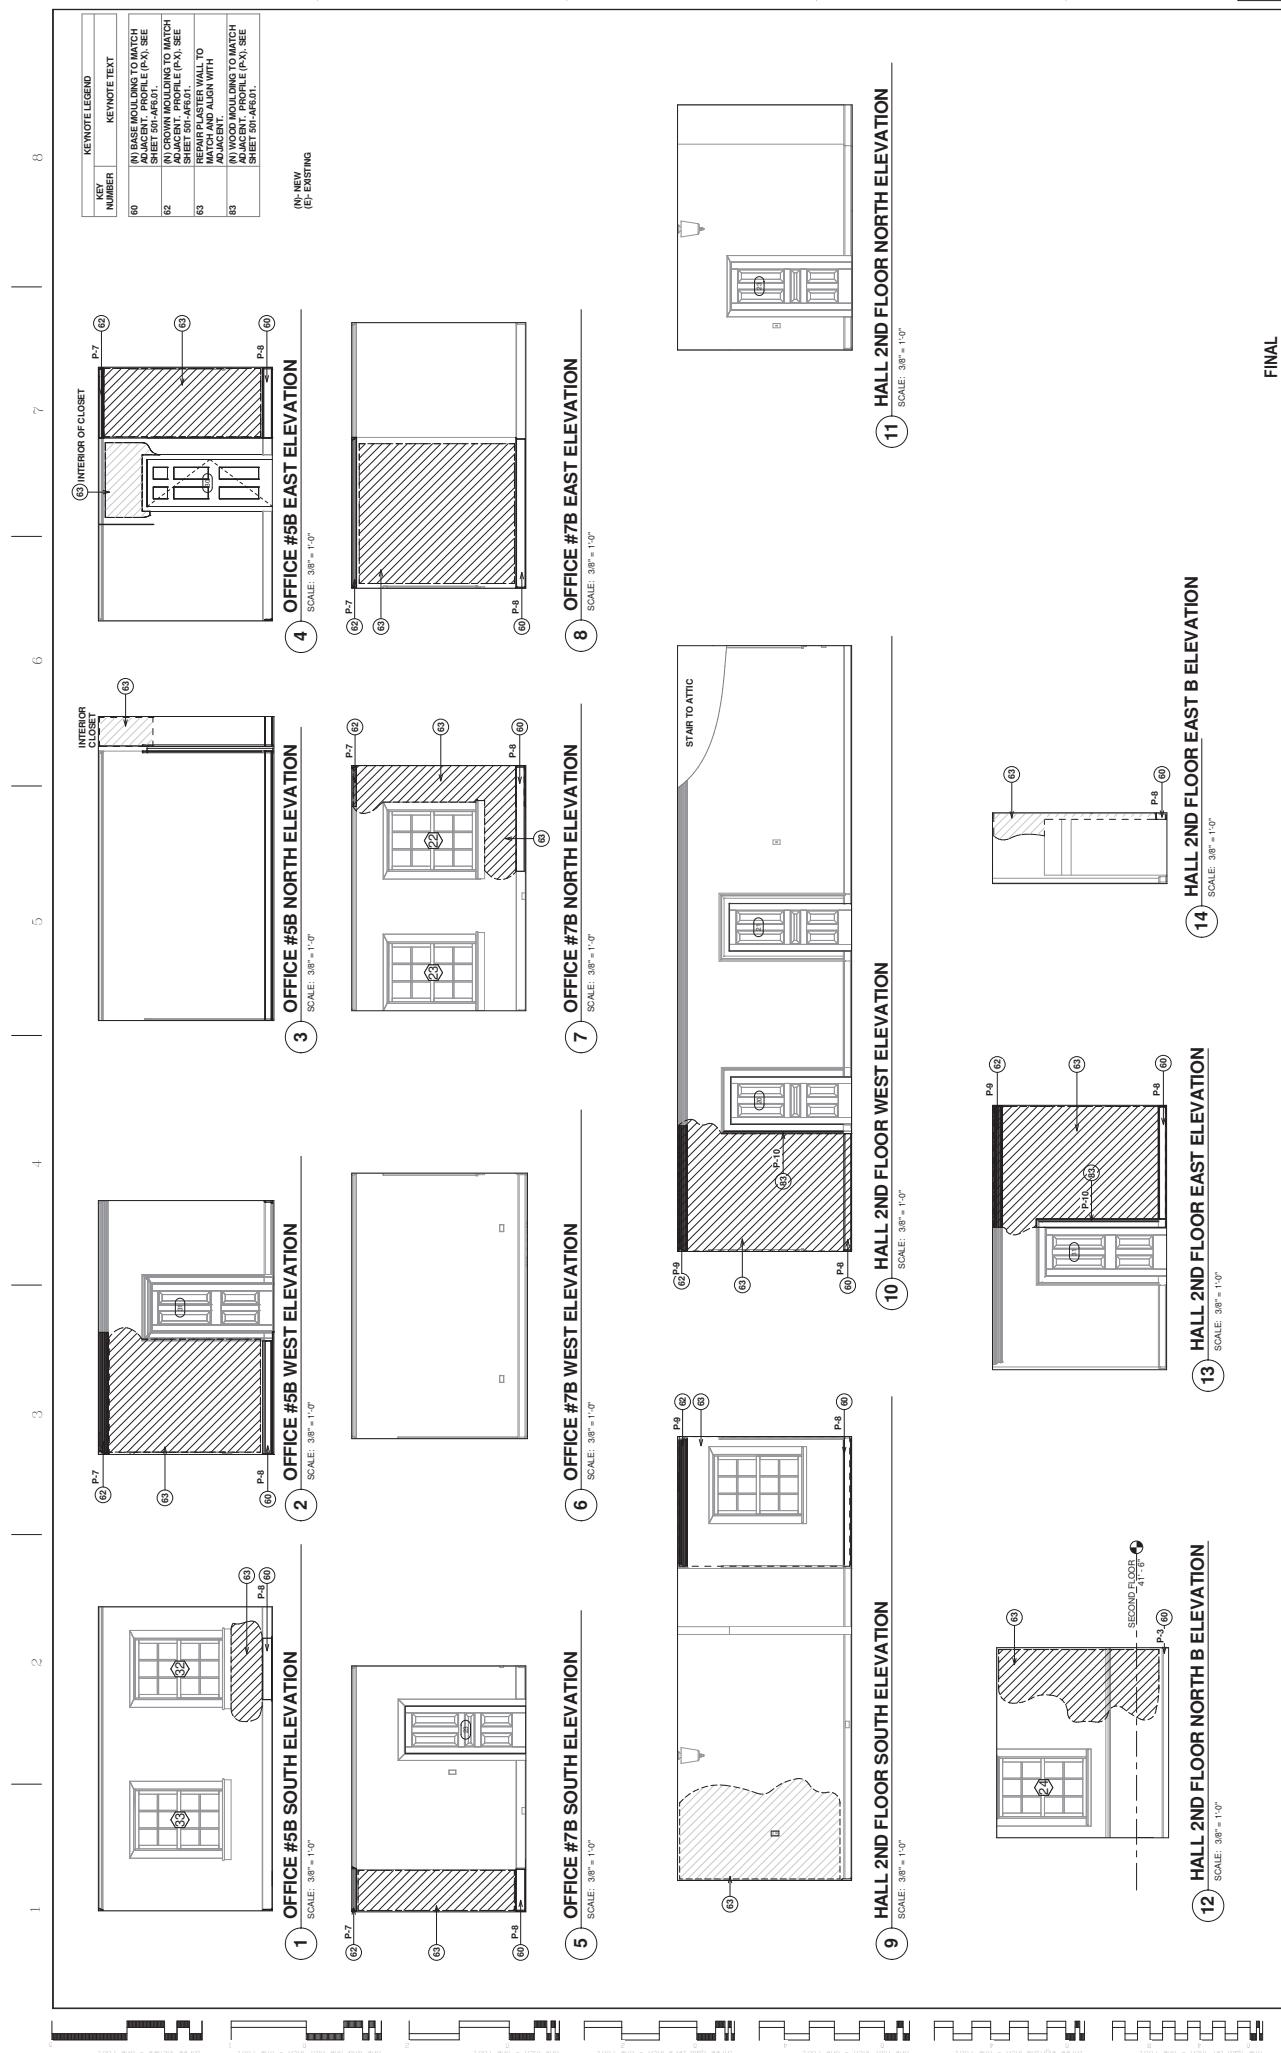


FINAL		DRAWING NUMBER	
		Project Title: RENOVATE MANSION HOUSE AND GRIST MILL VAMEDICAL CENTER	
		Date: 10/15/2012	Project No.: 552A-0435
		Drawing Start Date: 03/01/2012	Drawing End Date: 10/15/2012
		Approved: Associate Director of Operations	Approved: Director, Medical Center
		Approved: Director, Medical Center	Brown, LM
		Approved: Director, Medical Center	Location: PERRY POINT, MARYLAND




Approved Chief Facilities and Engineering:	
Approved: Associate Director for Maintenance and Operations, Perry Point	
Approved: Director of Operations	
Approved: Director, Medical Center	

DBA
DAVIS BUCKLEY ARCHITECTS AND PLANNERS
1612 K Street, NW, Suite 300
Washington, DC 20006
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Architect of Record and Preservation	Drawing Scale: AS NOTED
Architect:	Drawing Start Date: 03/01/2012
	Drawing End Date: 10/15/2012
	Approved: Director of Operations
	Approved: Director, Medical Center

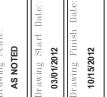

GENERAL DEMOLITION NOTES:

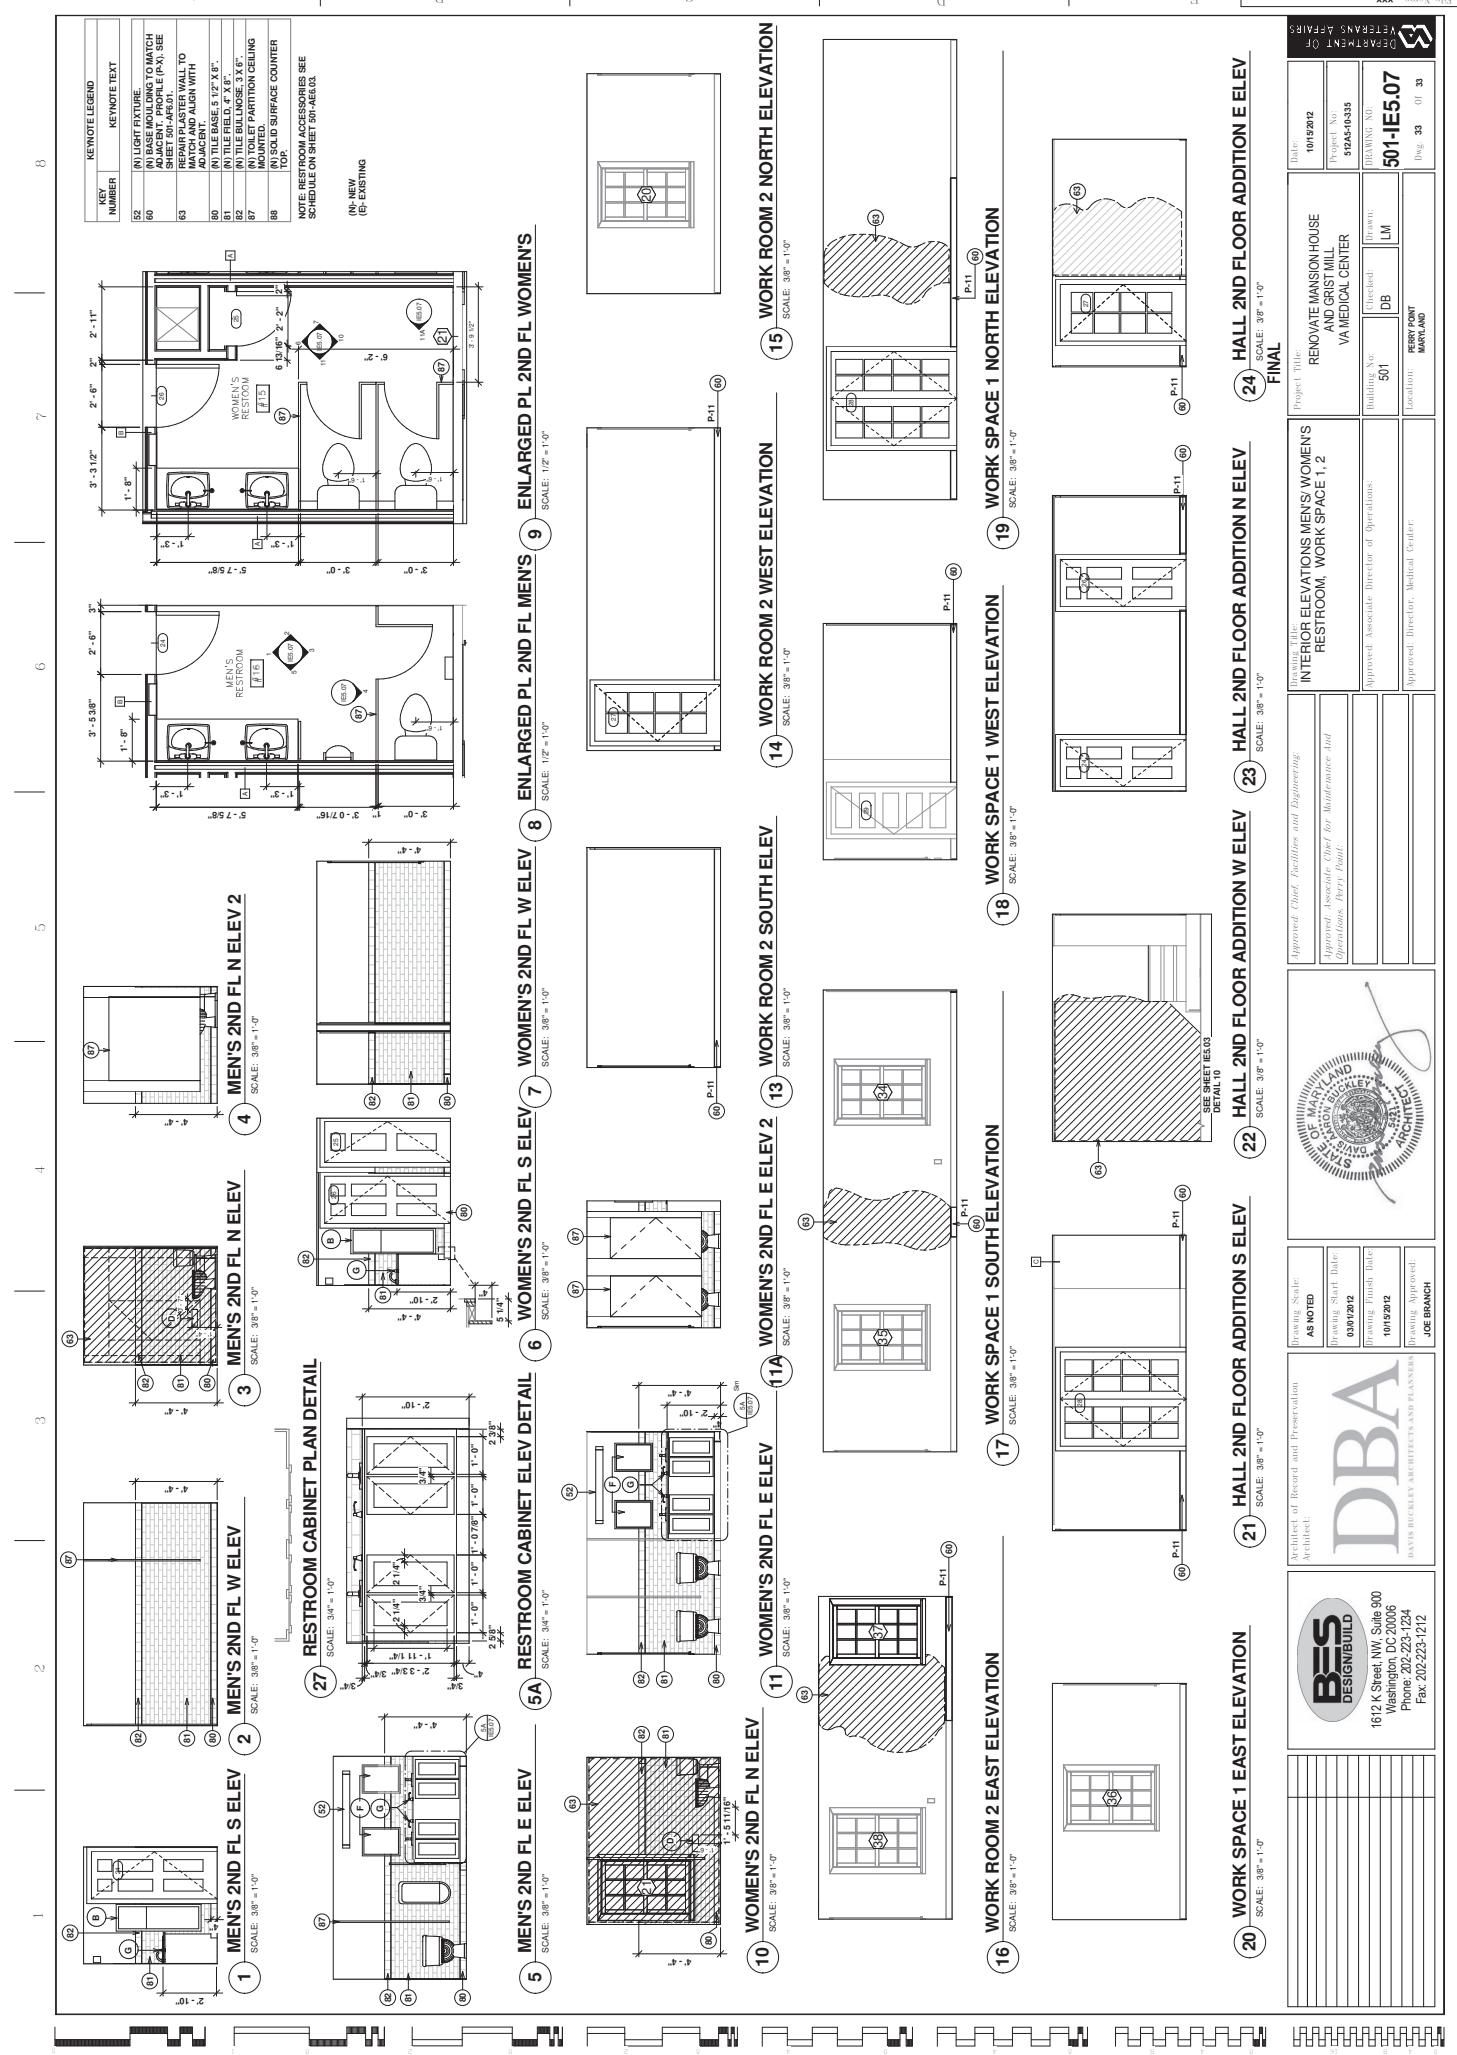- An architectural drawing showing a detailed view of a wall connection. The drawing includes a foundation slab at the bottom, a vertical wall, and a horizontal beam. Various parts are labeled with numbers 1 through 10, which correspond to callouts in the adjacent text block. The labels point to items such as concrete blocks, bolts, washers, and the interface between the wall and the beam.

KEYED NOTES:

- The floor plan illustrates a single-story residential structure with the following dimensions and features:

 - Overall Dimensions:** The main rectangular area is approximately 30'-0" wide by 39'-0" deep.
 - Rooms:**
 - Main Living Area: 12'-0" wide by 14'-0" deep.
 - Kitchen: 10'-0" wide by 10'-0" deep.
 - Dining Room: 10'-0" wide by 10'-0" deep.
 - Bathroom: 6'-0" wide by 7'-0" deep.
 - Bedroom 1: 12'-0" wide by 12'-0" deep.
 - Bedroom 2: 12'-0" wide by 12'-0" deep.
 - Bedroom 3: 12'-0" wide by 12'-0" deep.
 - Exterior Features:**
 - A small front porch is located on the left side.
 - A rear porch is located on the right side.
 - Multiple windows are distributed throughout the rooms.
 - Doors provide access to the interior rooms and porches.
 - Structural Details:**
 - Walls are indicated by thick black lines.
 - Floor joists are shown as horizontal lines with a 24-inch span between them.
 - Crawl spaces are indicated by hatched areas under the foundation walls.
 - Brick piers are shown as vertical columns supporting the exterior walls.
 - Foundation lines are shown as dashed lines at the base of the walls.

FOUNDATION FLAT-DEMOLITION SCALE: 1:4" = 1'-0"



SCALE: 1
SU101




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GENERAL DEMOLITION NOTES

- A. ALL NECESSARY ITEMS TO PROVIDE THE REQUIRED DISTRIBUTION OF UTILITIES THROUGHOUT THE STRUCTURE SHALL BE THE RESPONSIBILITY OF THE CONTRACTOR. THIS INCLUDES ALL UTILITIES AND THE STANDARD STRUCTURAL DETAILS AND NOTES FOR ANY ADDITIONAL REQUIREMENTS AS EQUATED TO THIS DESIGN BASED UPON THE COMPLETED CONDITION OF CONSTRUCTION. TEMPORARY BRACING, SHORING OR SUPPORTING OF THE STRUCTURE OR PARTS WHICH ARE REQUIRED TO MAINTAIN STABILITY PRIOR TO COMPLETION SHALL BE REFER TO THE DRAWINGS FOR COMPLETE INSTALLATION AND REQUIREMENTS OF ANY EMBEDDED DRAWINGS.
- B. THE CONTRACTOR IS RESPONSIBLE FOR THE DRAWINGS FOR THE STRUCTURE AND LOCATIONS OF ALL UTILITIES AND THE STANDARD STRUCTURAL DETAILS AND NOTES FOR ANY ADDITIONAL REQUIREMENTS AS EQUATED TO THIS DESIGN BASED UPON THE COMPLETED CONDITION OF CONSTRUCTION. TEMPORARY BRACING, SHORING OR SUPPORTING OF THE STRUCTURE OR PARTS WHICH ARE REQUIRED TO MAINTAIN STABILITY PRIOR TO COMPLETION SHALL BE REFERRED TO THE DRAWINGS FOR COMPLETE INSTALLATION AND REQUIREMENTS OF ANY EMBEDDED DRAWINGS.
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- O. REFER TO ARCHITECTURAL DRAWINGS FOR WALL AND DOOR OPENINGS, LOCATIONS OF PAWS AND CRITICAL ARCHITECTURAL FEATURES.
- P. REFER TO DRAWINGS FOR EXISTING SUEFLOOR, ROOF, DOORS, WINDOWS, ETC. FOR SIZE AND LOCATION OF ALL OPENING IN EXISTING CONCRETE SLAB. ENSURE THAT THERE IS ENOUGH ROOM TO SWING DOORS AND OPENINGS. MONITOR VERTICAL ALIGNMENT OF EXISTING WALL DURING DEMOLITION.
- Q. NEW WALLS ARE SHOWN FOR CLARITY.
- R. INSPECT AND REPLACE TIMBERS, WINDOWS, AND DOOR HEADERS AS SCHEDULED BY ARCHITECT.
- S. NEW WALLS ARE SHOWN FOR CLARITY.
- T. COORDINATE WITH ARCHITECTURAL DEMOLITION PLANS.

KEY NOTES:

1. REMOVE EXISTING FOOTINGS REINFORCING
2. REMOVE EXISTING FOUNDATION WALL AND PIERS.
3. REMOVE EXISTING LOUVERS AND VENTS.
4. PROTECT EXISTING HISTORIC FOUNDATION.
5. REMOVE EXISTING HISTORIC FOUNDATION- PROVIDE OPENINGS FOR NEWCORE EAST SIDE SHEAR.
6. REMOVE EXISTING G - STEEL COLUMNS AND T X WOOD PLATE.
7. SUPPORT EXISTING FRAMING.
8. REMOVE EXISTING CRAWL WALLS. REFER TO ORIGINAL BRICK FOUNDATION.
9. PROTECT EXISTING HISTORIC BRICK AND STONE FOUNDATION.
10. REMOVE EXISTING NON BEARING ELECTRICAL CHASE.
11. SHORE EXISTING FIREPLACES DURING DEMOLITION.
12. EXISTING BRICK CONDUITS REFER TO DRAWS FOR ADJACENT POSTS.
13. EXISTING BRICK CONDUITS REFER TO DRAWS FOR ADJACENT POSTS.
14. LEVEL GRADE UNDER ALL CRAWL SPACES.
15. REMOVE EXISTING LOAD BEARING WALL.
16. PROJECT EXTERIOR OF EXISTING DURING DEMOLITION.
17. DURING DEMOLITION.
18. REMOVE CHIMNEY VERIFY CONDITION.
19. REMOVE EXISTING CHIMNEY WALL, WINDOWS, SUEFLOOR, INSPECT JOIST FOR WATER DAMAGE.
20. REMOVE ROOF AND DECKING. REFER TO DRAWS FOR ADJACENT ROOF, REPAIR ROOF, REPLACE ROOF, DECKING WHERE THE IN OCCURRED.
21. REMOVE EXISTING SLEEPING PORCH ROOF, REPLACE ROOF, DECKING WHERE THE IN OCCURRED.
22. REMOVE EXISTING SUEFLOOR (THE AREA).
23. SEE ARCHITECTURAL FOR POST PRESERVATION.

**FIRST FLOOR STRUCTURAL PLAN DEMOLITION**

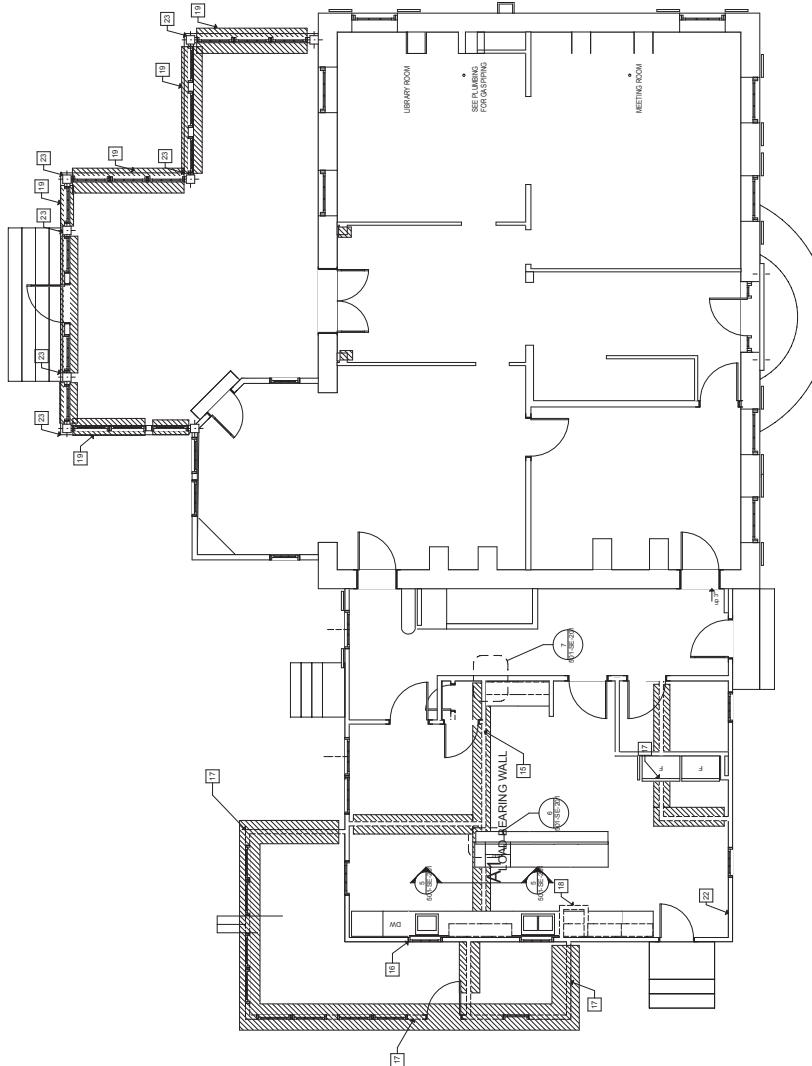Scale: 1/8"

Drawing Scale:		
Drawing Start Date	03/01/2012	
Drawing Finish Date	10/05/2012	
Drawn By:	JOE BANACH	
Drawn Approved:		

BESS DESIGNBUILD
1612 K Street NW Suite 900
Washington DC 20006
Phone: 202.222.1534
Fax: 202.222.1212

Approved: Chief, Facilities and Engineering		
Approved: Associate Chief for Maintenance and Operations, Perry Pohl		
Approved: Associate Director for Operations		
Approved: Director, Medical Center		
Building No:	501	Drawn:
Checked:		
Location:	FERRY POINT MARYLAND	

VETERRAN'S AFFAIRS	
DEPARTMENT OF	
Date:	10/15/2012
Print No:	51262-10-305
Drawing No:	501-SD102
Drawg.:	2 Of 7

GENERAL DEMOLITION NOTES:

- A. ALL NECESSARY STARS TO PROVIDE THE REQUIRED DISTRIBUTION OF UTILITIES THROUGHOUT THE STRUCTURE SHALL BE RESPONSIBLE FOR THIS CONTRACT, OR, THIS INCLUDES ALL NON-STRUCTURAL ITEMS, HANGERS, OR CIPS.

B. REFER TO THE DRAWINGS OF OTHER DISCIPLINES FOR THE SIZES AND LOCATIONS OF THE EXISTENCE OF UTILITIES MAY NOT BE SHOWN ON THE STRUCTURAL DRAWINGS.

C. REFER TO THE DRAWINGS OF OTHER DISCIPLINES FOR STRUCTURAL DETAILS AND NOTES FOR ADDITIONAL REQUIREMENTS AND AS-BUILT DRAWINGS.

D. THE STRUCTURAL INTEGRITY OF THIS DESIGN IS BASED UPON THE COMPLETED CONDITION OF CONSTRUCTION. TEMPORARY BRACING, SHARING OR SUPPORTING OF THE STRUCTURE OR PARTS WHICH ARE REQUIRED TO MAINTAIN STABILITY PRIOR TO COMPLETION OF THE STRUCTURE, SHALL NOT BE PROVIDED BY THE CONTRACTOR.

E. THE CONTRACTOR SHALL MAINTAIN A RECORD OF THE LOCATION AND REQUIREMENTS OF ANY EMBEDDED CONCRETE PITS, HOLES, TRENCHES, ETC., IN THE FOUNDATION, OR OTHER TRADES VENDORS FROM THEIR RESPECTIVE DRAWINGS. REQUIREMENTS OF THESE TRADES, VENDOR DRAWINGS FOR COMPLETE INSTALLATION OF THE STRUCTURAL DRAWINGS, BUT SHALL BE INCLUDED IN THE WORK.

F. MAY NOT BE USED TO DETERMINE THE HORIZONTAL SPANS AND DEFLECTIONS OF THE STRUCTURAL DRAWINGS. THESE O.H.D. ELEVATIONS SHALL BE REFERRED TO THE ENGINEER'S PROOF OF SUBMISSION OF THE SHOP DRAWINGS. THE STRUCTURAL DESIGN DRAWINGS SHALL BE COORDINATED BY THE CONTRACTOR TO ENSURE THAT THE ARCHITECTURAL DRAWINGS ARE REFERENCED FROM FIRST FLOOR ELEVATION ON AS INDICATED ON THE DRAWINGS.

G. ALL ELEVATIONS ARE REFERENCED FROM FIRST FLOOR ELEVATION AS OF "O" DATUM.

H. DURING CONSTRUCTION, PROTECTION OF ANY EXISTING OR ADDED STRUCTURES DURING THE CONSTRUCTION PHASE SHALL BE PROVIDED BY THE CONTRACTOR PRIOR TO STARTING ANY WORK.

I. ALL SHOP DRAWINGS SHALL BE REBEGINED AND ACCEPTED BY THE CONTRACTOR PRIOR TO SUBMISSION TO THE ENGINEER. ANY DISCREPANCIES, INTERFERENCE, OR CONFLICTS BETWEEN THE STRUCTURAL DRAWINGS AND THOSE OF OTHER DISCIPLINES SHALL BE REPORTED TO THE ENGINEER PRIOR TO SUBMISSION OF THE SHOP DRAWINGS. THE STRUCTURAL DESIGN DRAWINGS SHALL BE COORDINATED BY THE CONTRACTOR TO ENSURE THAT THE ARCHITECTURAL DRAWINGS ARE REFERENCED FROM FIRST FLOOR ELEVATION AS OF "O" DATUM.

J. ALL REFERENCES TO CODES, STANDARDS, OR SPECIFICATIONS SHALL BE MADE TO THE LATEST EDITION AT THE TIME OF THE PERMITTING.

K. ALL REQUIRED DRAWINGS SHALL BE PROVIDED TO THE CONTRACTOR FOR APPROVAL, COORDINATED BY THE CONTRACTOR FOR EFFECTIVENESS.

L. ALL WORK SHALL BE IN ACCORDANCE WITH STANDARDS AND INTERNATIONAL BUILDING CODE, LATEST EDITION.

M. CONTRACTOR TO VERIFY DIMENSIONS AND CONDITIONS AT THE PROJECT SITE PRIOR TO STARTING WORK AND SHALL MAKE UP THE DIFFERENCES.

N. THE CONTRACTOR SHALL BE RESPONSIBLE FOR ANY DISCREPANCIES IN THE CONTRACTOR'S SUBMISSION TO THE ENGINEER, WHICH ARE ANTI TO CONDITIONS THAT ARE NOT CONSISTENT WITH THE CONTRACTOR'S SUBMISSION.


O. REFER TO ARCHITECTURAL DRAWINGS FOR ALL WALL AND DOOR OPENINGS. LOCATIONS OF PARTITION WALLS, AND CRITICAL ARCHITECTURAL FEATURES.

P. REFER TO ELECTRICAL AND MECHANICAL DRAWINGS FOR SIZE AND LOCATION OF ALL OPENINGS FOR MONITORING AND RECORDING OF EARTHQUAKE, HURRICANE, AND CYCLONE LOADS.

Q. INSPECT AND REPAIR DAMAGE TO EXTERIOR MASONRY AND DOOR HEADS AS SCHEDULED BY ARCHITECT.

KEYED NOTES

1. REMOVE EXISTING COATINGS, REINFORCING PERS, REMOVAL EXISTING LOUVERS AND VENTS.
 2. PROTECT EXISTING HISTORIC FOUNDATION.
 3. PRESERVE EXISTING BRICK FOUNDATION; PROVIDE OPENINGS FOR NEW WORK WHERE NEEDED.
 4. PRESERVE ORIGINAL BRICK FOUNDATION SUPPORTING EXISTING FRAMING.
 5. REMOVE EXISTING COLUMNS AND 1 X WOOD PLATE.
 6. PRESERVE EXISTING CAW WALLS - PRESERVE ORIGINAL BRICK FOUNDATION.
 7. REMOVE EXISTING CAW WALLS - REMOVE EXISTING LOAD BEARING WALL.
 8. REMOVE EXISTING HISTORIC BRICK AND STONE FOUNDATION.
 9. REMOVE EXISTING ROOFING, DRAWDROPS AND GUTTER SYSTEM.
 10. REMOVE EXISTING REPAIRS DURING DEMOLITION.
 11. REMOVE EXISTING ROOFING POSTS - PRESERVE ADJACENT POSTS.
 12. REMOVE EXISTING BRICK FOUNDATION TO BE RE-BUILT.
 13. EXISTING LEVEL UNDER EXISTING SPACES AND NON LOAD BEARING WALLS.
 14. REMOVE EXISTING ROOFING, DRAWDROPS AND GUTTER SYSTEM.
 15. REMOVE EXISTING LOAD BEARING WALL.
 16. REMOVE EXISTING ROOFING, DRAWDROPS AND GUTTER SYSTEM.
 17. REMOVE EXISTING WALL, WINDOW, DOOR, SHORE EXISTING BUILDING
 18. REMOVE EXISTING ROOFING, DRAWDROPS AND GUTTER SYSTEM.
 19. REMOVE EXISTING ROOFING, DRAWDROPS AND GUTTER SYSTEM.
 20. REMOVE ROOF AND REPLACE DAMAGED ROOF HEATING.
 21. REMOVE EXISTING SLEEPING PORCH ROOF - REPLACE ROOF DECKING WHERE REQUIRED.

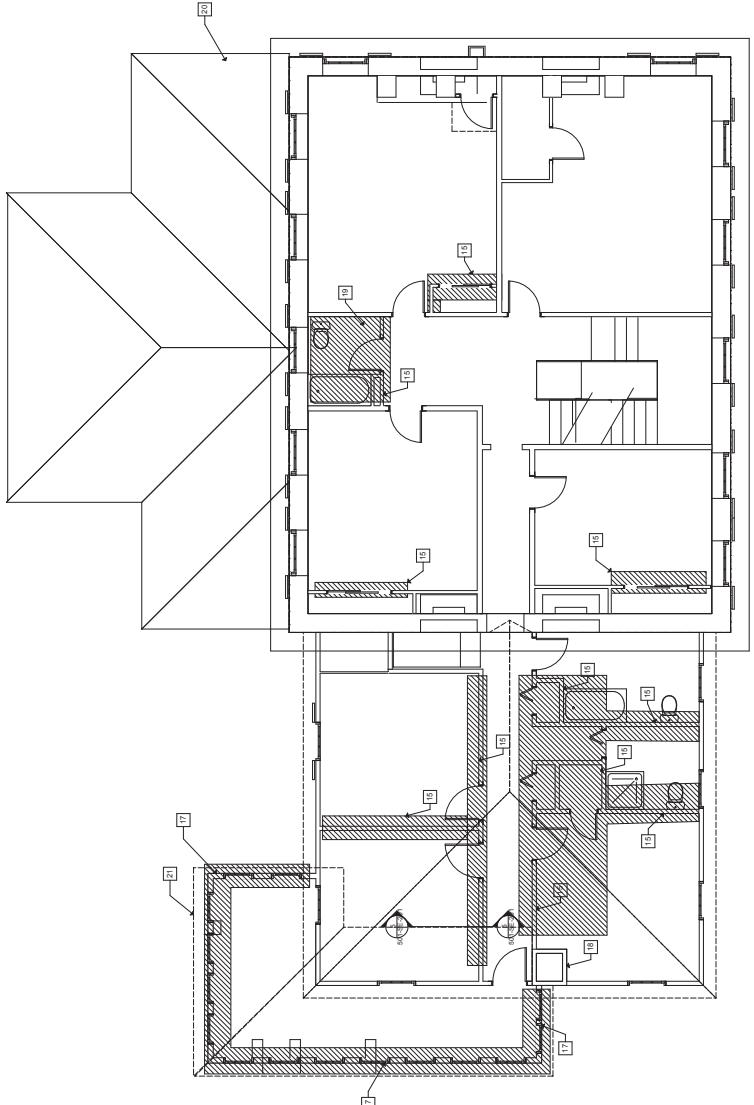

SECOND FLOOR STRUCTURAL PLAN-DEMOLITION



SCALE: 1/4" = 1'-0"



The logo consists of the letters 'B&S' in a large, bold, sans-serif font, with a horizontal line through the ampersand. Below this, the words 'DESIGN/BUILD' are written in a smaller, all-caps, sans-serif font.

1

1

SECOND FLOOR STRUCTURAL PLAN DEMOLITION		Approved/ Associate Director for Operations:		Approved Director: Dixie Medical Center	
Project Title: RENOVATE MANSION HOUSE AND GRIST MILL VA MEDICAL CENTER		Building No: 501		Location: PO BOX 1000 MARTINSBURG, WV 26101-1000	
Drawing No.: 501-SD-103		Checked _____ Drawn: _____ Date: 10/12/2012		Dwg. 3 of 7 Drawing No: 512A&5-1035	
Approved/ Associate Director for Operations:				Approved Director: Dixie Medical Center	

<i>Drawing Scale:</i>	<i>Approved Chief Radiator and Engineering</i>
<i>Drawing Start Date:</i>	<i>Approved Associate Chief for Maintenance and Operations, Perry Point</i>
<i>Drawing Finish Date:</i>	
<i>Drawing Revision Date:</i>	
<i>Drawing Approval:</i>	<i>Joe Baranich</i>

The seal of the State of Maryland, featuring a circular design with a central shield containing a plow, a sheaf of wheat, and a scroll, surrounded by the words "THE STATE OF MARYLAND" and "1776".

The logo for B2B Design Build features a large, bold 'B' and 'S' intertwined, with a smaller '2' positioned between them. The word 'DESIGNBUILD' is written in a smaller, sans-serif font directly below the 'B' and 'S'. A thin oval surrounds the entire logo.

GENERAL DEMOLITION NOTES:

- A. ALL NECESSARY ITEMS TO PROVIDE THE REQUIRED DISTRIBUTION OF UTILITIES THROUGHOUT THE STRUCTURE SHALL BE THE RESPONSIBILITY OF THE CONTRACTOR. THIS INCLUDES ALL UTILITY ITEMS, HANGLERS, OR CLIPS.

B. THE EXISTENCE OF UTILITIES MAY NOT BE SHOWN ON THE STRUCTURAL DRAWINGS.

C. THE CONTRACTOR IS RESPONSIBLE FOR DESIGNING, FABRICATING, AND INSTALLATION OF ALL REINFORCING STRUCTURES, STANCHIONS, SPOTS, AND ADDITIONAL SUPPORTS AS REQUIRED.

D. THE STRUCTURAL INTEGRITY OF THIS DESIGN IS BASED UPON THE COMPLETED CONDITION OF CONSTRUCTION. TEMPORARY BRACING, SHORING, OR SUPPORTING OF THE STRUCTURE BY THE CONTRACTOR IS THE CONTRACTOR'S RESPONSIBILITY.

E. THE CONTRACTOR SHALL NOTE AND VERIFY THE LOCATION AND REQUIREMENTS OF ANY EMBEDS, RECESSES, PITS, OR OPENINGS MADE BY OTHER TRADES. VENDORS FROM THEIR RESPECTIVE DRAWINGS, REQUIREMENT OF THESE TRADES, VENDOR DRAWINGS FOR COMPLETE INSTALLATION OF THESE TRADES, AND THE CONTRACTOR'S DRAWINGS FOR THE CONTRACTOR'S PART OF THE PROJECT.

F. ANY FLAT OR DEFORMED SURFACES, LINES, OR LOCATIONS WHICH ARE REQUIRED FOR THIS PROJECT SHALL BE COORDINATED BY THE CONTRACTOR WITH THE ARCHITECTURAL DRAWINGS PROVIDED.

G. ALL LEVELS ARE REFERENCED FROM FIRST FLOOR FINISHED ELEVATION OR AS INDICATED ON THE DRAWINGS. FIRST FLOOR ELEVATION SHALL BE REFERENCED TO GROUND.

H. ALL SHOP DRAWINGS SHALL BE THE RESPONSIBILITY OF THE CONTRACTOR.

I. ALL SHOP DRAWINGS SHALL BE REVIEWED AND ACCEPTED BY THE CONTRACTOR PRIOR TO SUBMISSION TO THE ENGINEER. ANY DISCREPANCIES OR INTERFERENCE, OR CONFLICTS BETWEEN THE STRUCTURAL DRAWINGS AND THOSE OF OTHER TRADES SHALL BE REPORTED TO THE CONTRACTOR.

J. ALL DRAWINGS SHALL BE KEPT BY THE CONTRACTOR FOR A PERIOD OF ONE YEAR FROM THE DATE OF SUBMISSION. NO DRAWINGS SHALL BE USED FOR REJECTION OR FABRICATION DRAWINGS.

K. ALL REFERENCES TO CODES, STANDARDS, OR SPECIFICATIONS ARE TO BE THE LATEST ISSUED EDITIONS AT THE TIME OF PERMITTING.

L. ALL RELATED SHOP DRAWINGS SHALL BE APPROVED BY THE CONTRACTOR FOR APPROVAL.

M. COORDINATE WORK WITH OTHER TRADES.

N. ALL WORK SHALL BE IN ACCORDANCE WITH STANDARDS AND INTERNATIONAL BUILDING CODE, LAT. N. M. CONTRACTOR TO VERIFY ALL DIMENSIONS AND CONDITIONS AT THE PROJECT SITE PRIOR TO STARTING WORK. SPAFFORD WILL NOT BE HELD LIABLE FOR ANY DISPARANCES IN THE CONTRACTOR'S DESIGN DOCUMENTS.



O. REFER TO ARCHITECTURAL DRAWINGS FOR ALL WALL AND DOOR OPENINGS. LOCATIONS OF PARTITION WALLS AND CRITICAL ARCHITECTURAL FEATURES.

P. REFER TO ARCHITECTURAL DRAWINGS FOR ALL CANAL DRAWINGS.

Q. REFER TO ARCHITECTURAL DRAWINGS FOR ALL VENT ALIGNMENT OF EXISTING WINDOW AND DOOR HEADERS AS SCHEDULED BY ARCHITECT.

SEYED NOTES:

1. REMOVE EXISTING FOUNDINGS, REINFORCING, ETC.
 2. REMOVE EXISTING FOUNDATION WALL AND PIERS.
 3. REMOVE EXISTING GROUNDSVENTS.
 4. PROTECT EXISTING HISTORIC FOUNDATION, PROVIDE OPENINGS FOR NEW WORK WHERE SHOWN.
 5. REMOVE EXISTING FRAMING, STEEL COLUMNS AND I X WOOD PLATE.
 6. REMOVE EXISTING FRAMING, S. PRESERVE ORIGINAL BRICK FOUNDATION.
 7. REMOVE EXISTING LOAD BEARING WALL, PRESERVE ORIGINAL BRICK AND STONE CHAISE.
 8. PROTECT EXISTING HISTORIC ELECTRICAL CHASE.
 9. REMOVE EXISTING NON-BEARING ELECTRICAL CHASE.
 10. REMOVE EXISTING NON-BEARING STONE CHASE.
 11. REMOVE EXISTING HISTORIC DOORS, TRIM, BASEBOARD, POSTS, ETC.
 12. REMOVE EXISTING HISTORIC DOORS, TRIM, BASEBOARD, POSTS, ETC.
 13. REMOVE EXISTING BRICK FOUNDATION TO BE RE-BUILT.
 14. LEVEL GRADE UNDER EXISTING GROUND SPACES.
 15. REMOVE EXISTING DOOR SWING CLEARANCE, REMOVE EXISTING DOOR SWING CLEARANCE, REMOVE EXISTING DOOR SWING CLEARANCE, REMOVE EXISTING DOOR SWING CLEARANCE.
 16. REMOVE EXISTING CHAIN, GEAR, CORD, ETC.
 17. REMOVE EXISTING ROOF, SHORE EXISTING BUILDING DURING DEMOLITION.
 18. EASING CHANNEL, GEAR, CORD, ETC.
 19. REMOVE EXISTING ROOF, REPAIR HOLE, REPAIR SHEATHING.
 20. REMOVE ROOF AND REPLACE ROOF, ETC.
 21. REMOVE EXISTING PROTEC, FIXING ROOF, DECKING WHERE THE INS OCCURRED.
 22. REMOVE EXISTING ROOF, ETC. WHERE NEEDED.

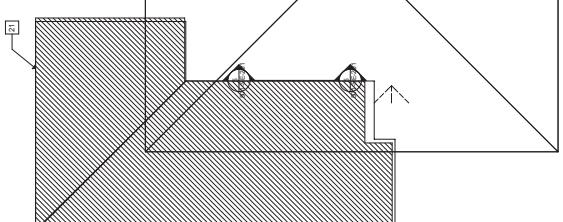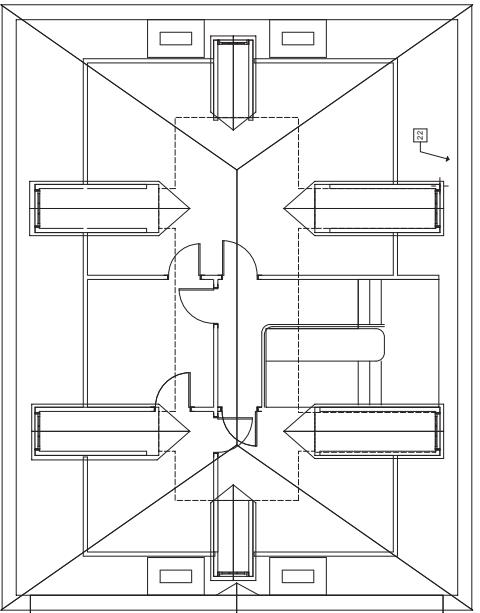

THIRD FLOOR STRUCTURAL PLAN-DEMOLITION SCALE: 1/4" = 1'-0"

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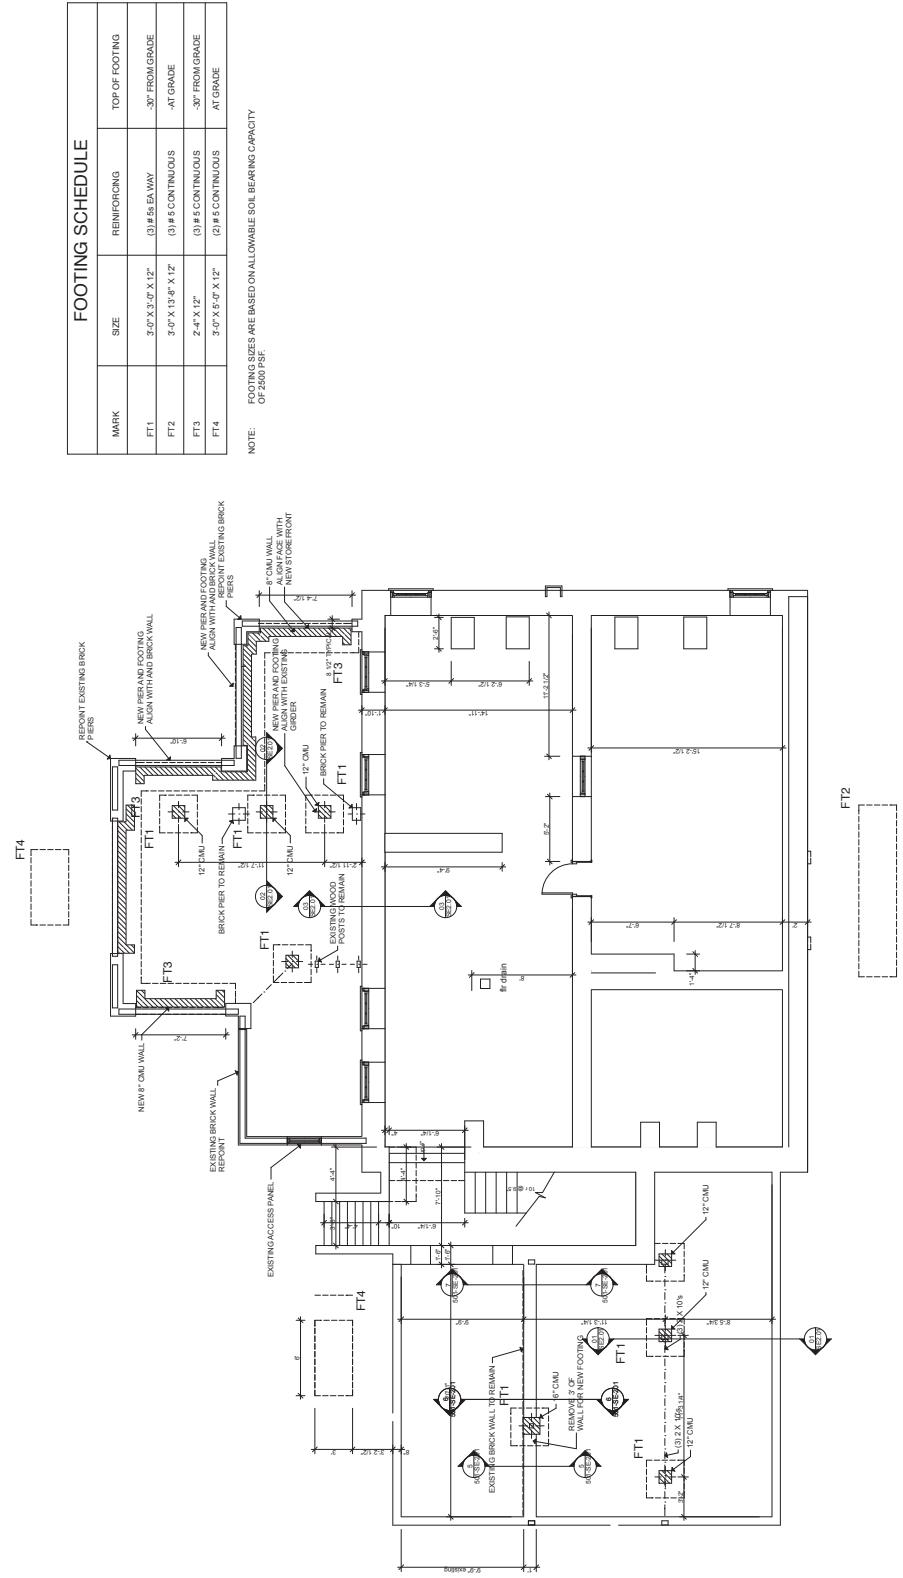
5

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2

1



1 FOUNDATION PLAN-NEW WORK
Scale: 1' = 1/8"

FINAL

Drawing No.: 501-SE101
Project Title: RENOVATE MANSION HOUSE
AND GRIST MILL
VA MEDICAL CENTER

Approved: Chief Engineer and
Operations, Ferry Point:

Approved: Associate Director for Operations:

Approved: Director, Medical Center:

Approved: Director, Ferry Point:


Approved: Associate Director for Operations:


Approved: Director, Ferry Point:

Drawing Scale:	1:500
Drawing Start Date:	03/01/2012
Drawing Finish Date:	10/01/2012
Drawn By:	JOE BANACH
Approved/Drawn:	JOE BANACH
Approved/Checked:	
Approved/Operated:	
Approved/Engineering:	
Approved/Associate Chief for Maintenance and Operations, Ferry Point:	
Approved: Associate Director for Operations:	
Approved: Director, Medical Center:	
Approved: Director, Ferry Point:	
Approved: Associate Director for Operations:	
Approved: Director, Ferry Point:	
Approved: Associate Director for Operations:	
Approved: Director, Ferry Point:	

BES DESIGNBUILD
1612 1/2 Street NW Suite 900
Washington, DC 20006
Phone: (202) 223-1234
Fax: (202) 223-1212

Date:	10/15/2012
Print No.:	51245-10-305
DRAWING NO.:	501-SE101
Drawn:	5 Of 7
Location:	FERRY POINT MARYLAND

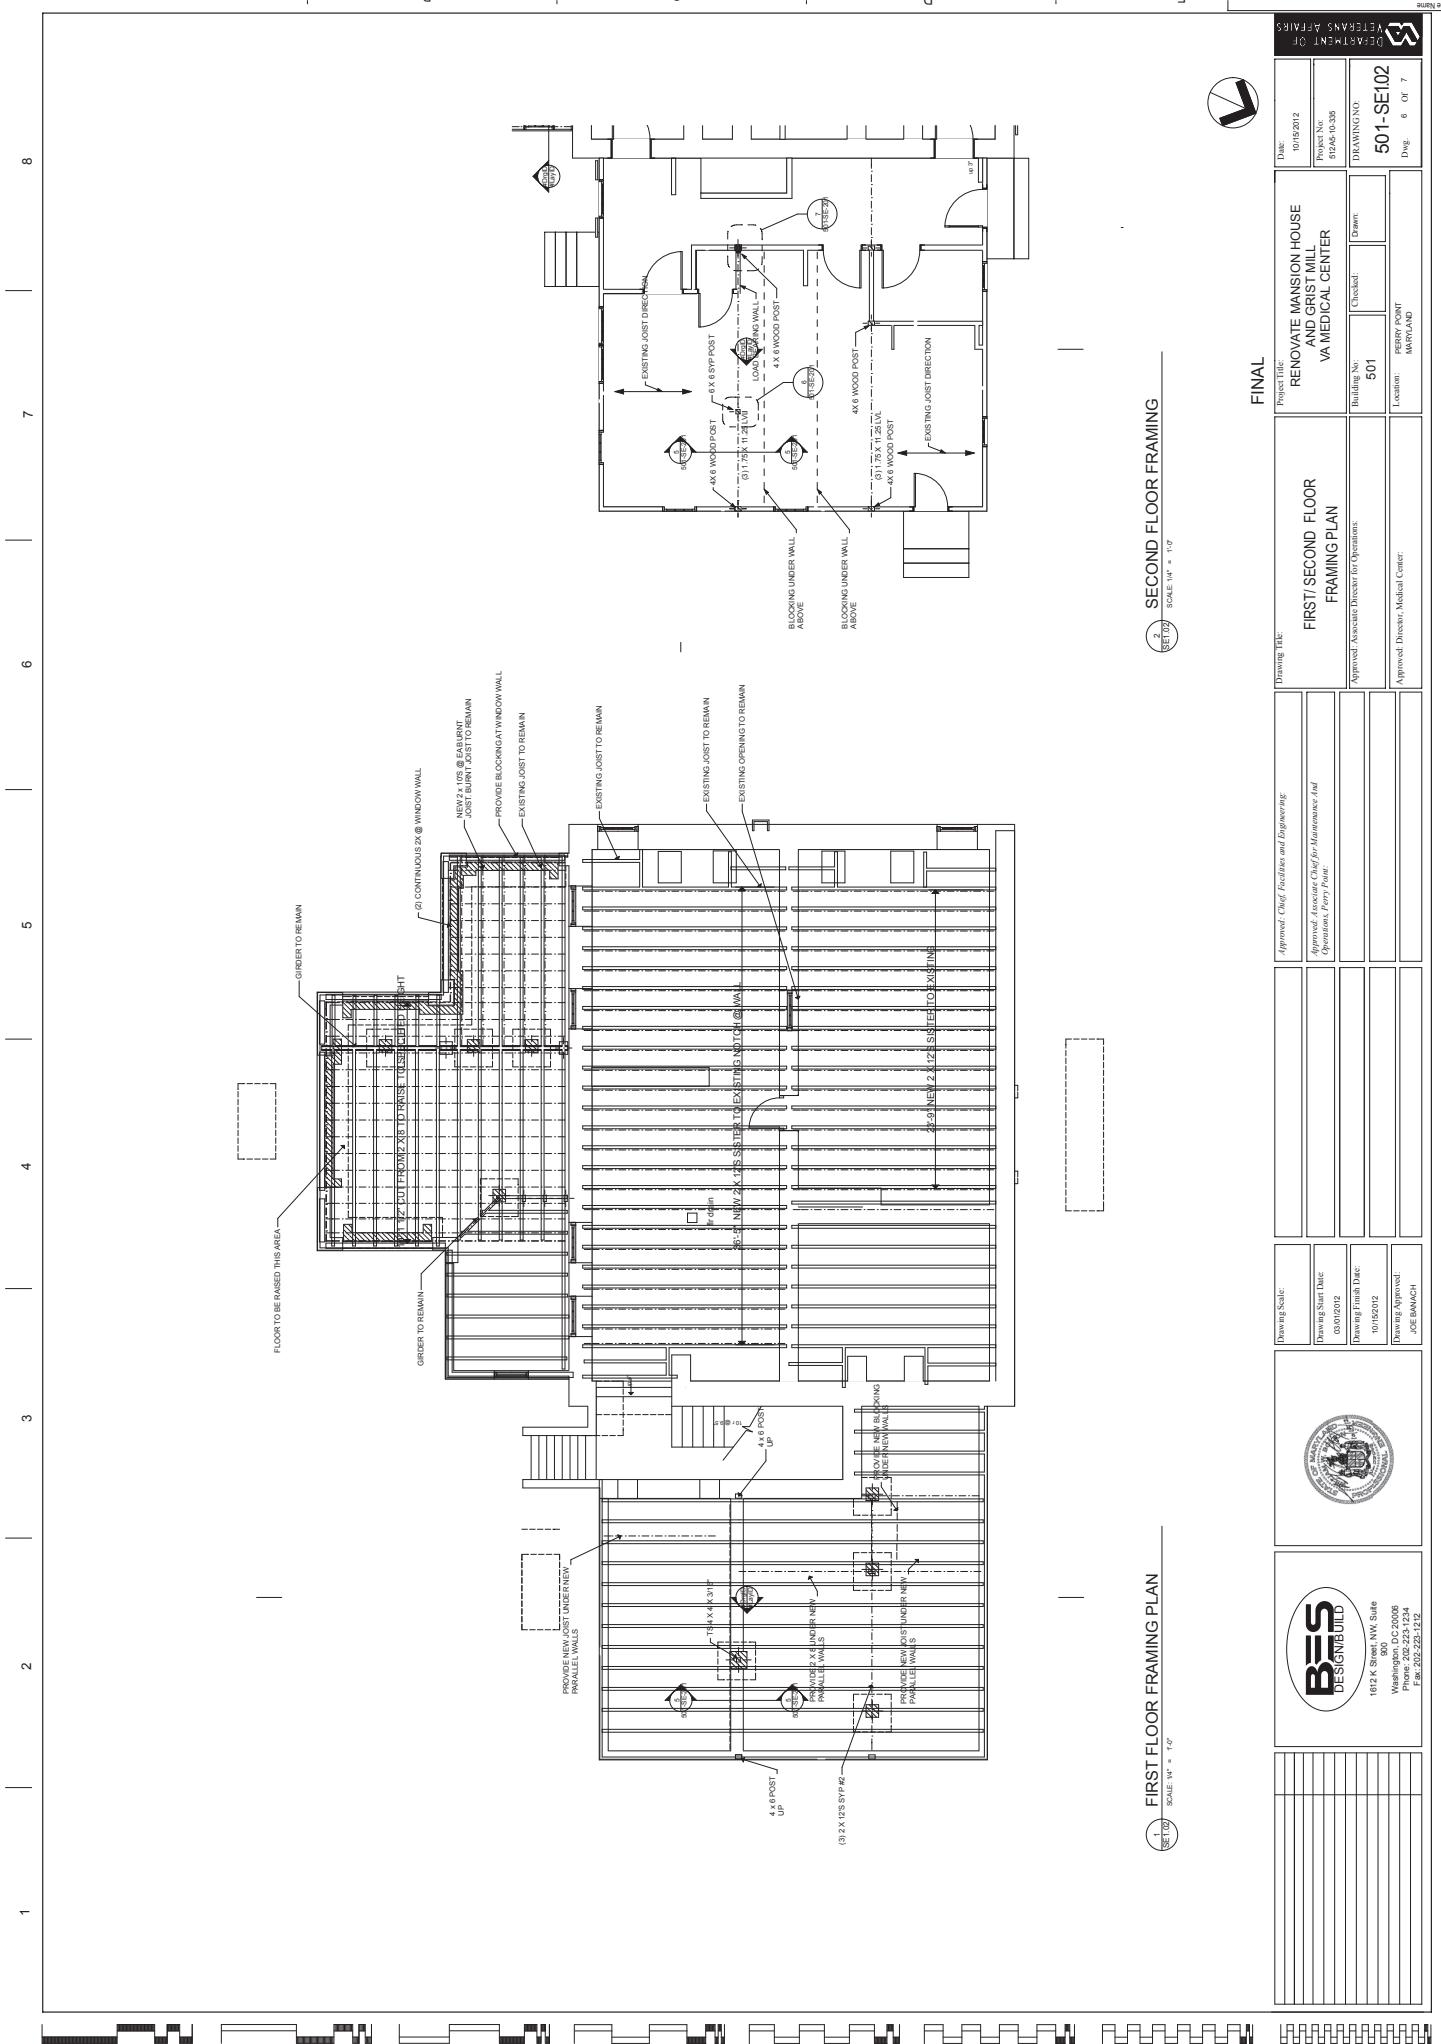

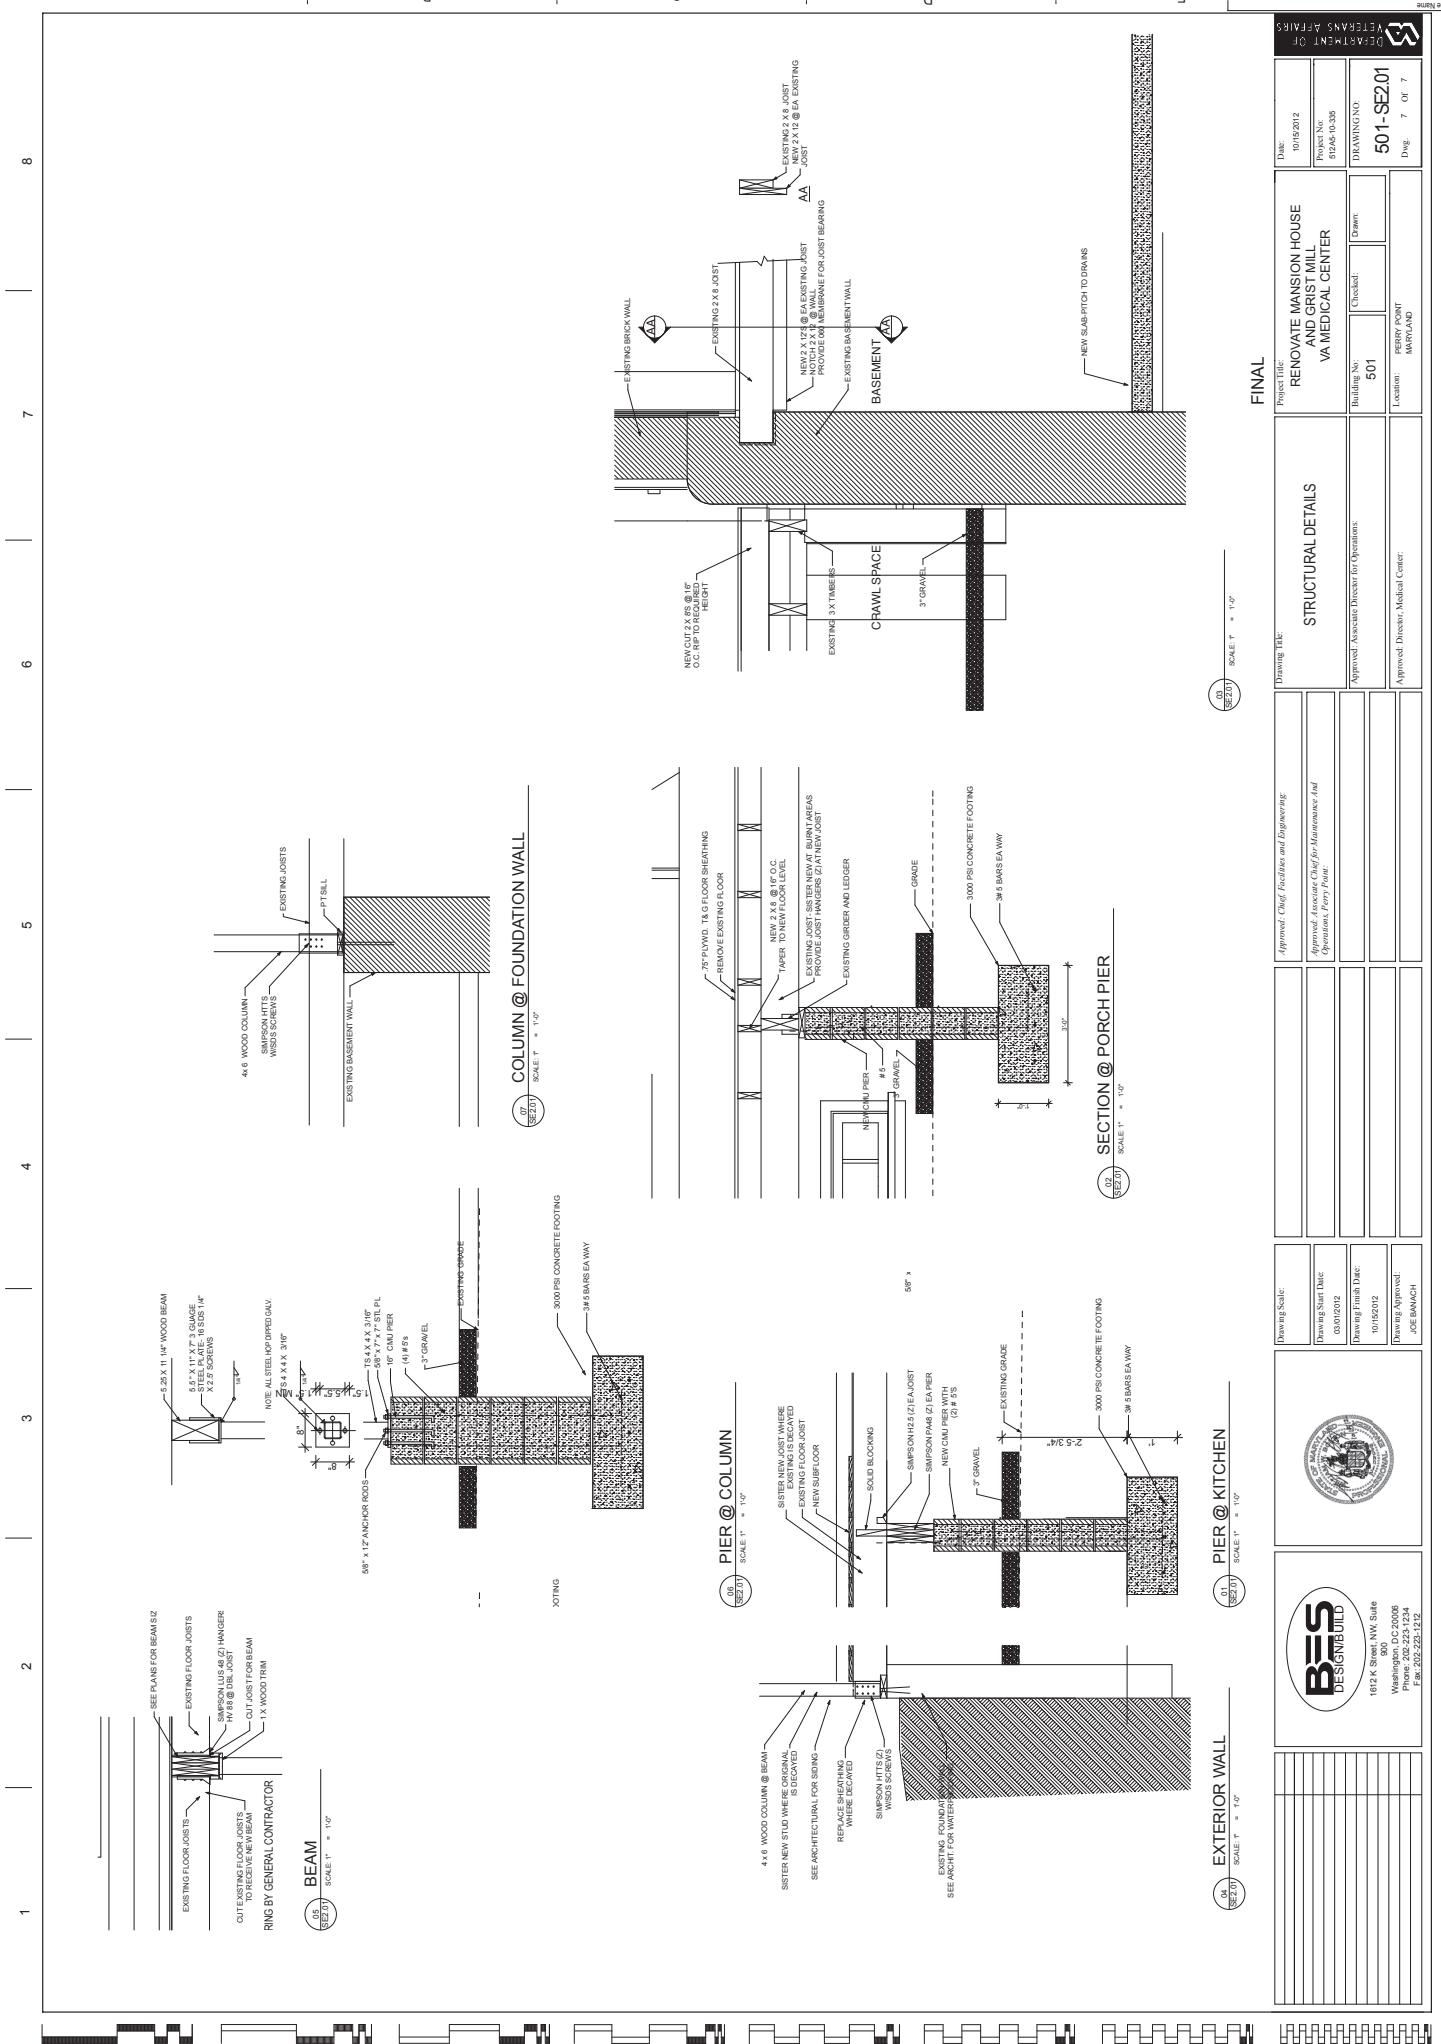

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7

6


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**BUILDING 501
BASEMENT - MECHANICAL DEMOLITION**

SCALE: $1/4'' = 1'-0''$

GENERAL DEMOLITION NOTES

- ALL ITEMS SHOWN WITH HATCHED LINES INDICATE ITEMS TO BE DEMOLISHED. SEE ARCHITECTURAL DRAWINGS AND COORDINATE LINE NUMBER FOR REFERENCE.
- LOCATION OF EXISTING EQUIPMENT, DUCTWORK, AIR OUTLETS, CONTROLS AND ALL CONCEALED WORKS, ETC., ARE FOR INFORMATION ONLY. CONTRACTOR SHALL DETERMINE THE SIZE, PROPORTION AND OTHER REQUIREMENTS FOR THE REMOVAL OF THESE ITEMS.
- THE CONTRACTOR SHALL MAKE ADJUSTMENTS AND/OR ALTERATIONS AS NECESSARY TO INSTALL COMPLETE AND OPERABLE SYSTEMS IN ACCORDANCE WITH THE CODES HAVING JURISDICTION AT NO ADDITIONAL COST TO THE CONTRACTOR.
- ALL OPENINGS AND SURFACES MADE BARE BY DEMOLITION AND/OR REPAIRS SHALL BE REPAIRED TO MATCH ADJACENT FINISH. PREVIOUS SURFACES TO RECEIVE NEW FINISH SEE ARCHITECTURAL DRAWINGS FOR NEW FINISH SCHEDULE. ALL REPAIRS AND NEW FINISH SHALL BE BY TRADES SKILLED IN FINISH WORKS UNDER EMPLOY OF THE GENERAL CONTRACTOR.
- NOT ALL CONTROL CIRCUITS AND DEVICES ARE INDICATED. FOR EACH CONTROL AND DEVICE THERE IS A CHANCE OR FLUIDS MAY SPILL OR DAMAGE THE ORIGINAL WALLS, CEILINGS OR FLOOR. IT IS THE CONTRACTOR'S RESPONSIBILITY TO DETERMINE THE LOCATION OF THESE ITEMS AND TAKE APPROPRIATE MEASURES TO ELIMINATE THE RISK OF DAMAGE. THE CONTRACTOR SHALL BE REQUIRED TO REPAIR ANY DAMAGE CAUSED BY THESE ITEMS.
- SEE ARCHITECTURAL DRAWINGS AND SPECIFICATION FOR ADDITIONAL INFORMATION. COORDINATE ALL DEMOLITION WITH ALL TRADES INVOLVED.
- EXISTING PIPING AND/OR CONDUIT RUN CONCEALED UNDERNEATH FLOOR AS WELL AS IN BASEMENT AREA AND NOT DOCUMENTED OR SPECIFIED FOR REUSE IN NEW WORK SHALL BE ABANDONED UNLESS NOTED OTHERWISE IN PIPING AND/OR CONDUIT ON FLOOR AND MINIMUM 12' BELOW GRADE. PATCH TO MATCH ADJACENT FINISH.
- ITEMS THAT REQUIRE ACCESS, SUCH AS FOR OPERATING, CLEANING, SERVICING, MAINTENANCE AND INSPECTION, SHALL BE LEFT UNCONCEALED. CONTRACTOR SHALL PROVIDE ACCESS TO ALL CONDUITS, VALVES, FILTERS AND STRANGLERS, PIPING SUPPORTS, THERMOCOUPLES, CONTROL DEVICES, AND OTHER EQUIPMENT AS REQUIRED.
- DEMOLISH EXISTING STEAM AND CONDENSATE LINES.
- DEMOLISH EXISTING BOILER COMPLETE, INCLUDING PIPING SUPPORTS, ELECTRICAL POWER AND CONTROLS.

DEMOLITION NOTES

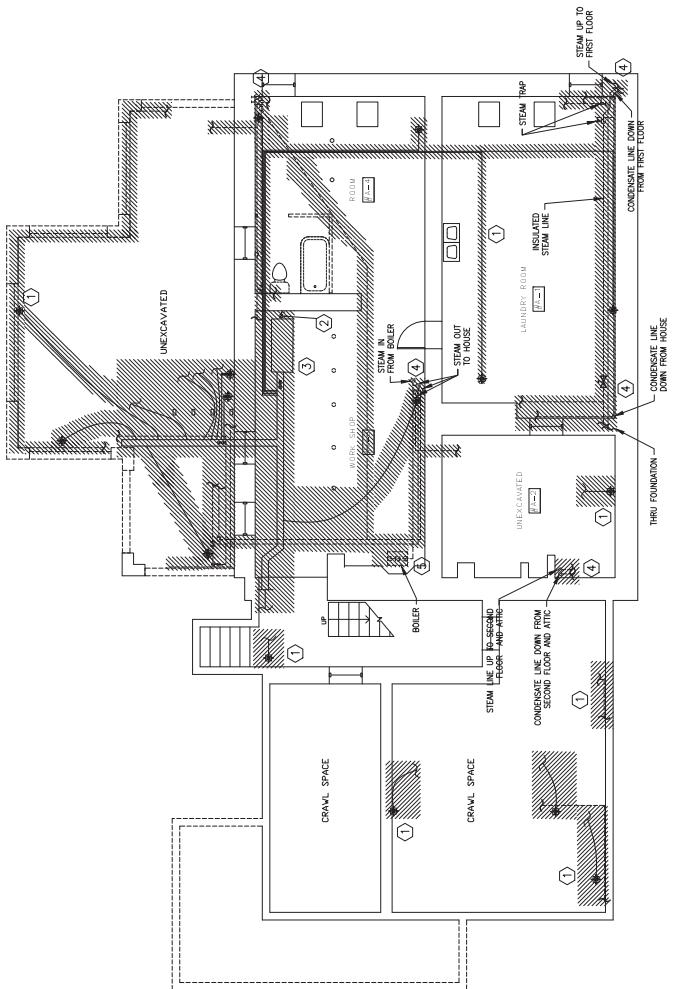- ① DEMOLISH EXISTING SUPPLY AIR OUTLET COMPLETELY INCLUDING SUPPORTS AND DUCT RUNOUT TO BRANCH SUPPLY TRUNK DUCT
- ② DEMOLISH EXISTING RETURN AIR OUTLET COMPLETELY INCLUDING SUPPORTS AND DUCT RUNOUT TO BRANCH RETURN DUCT TO ROOF TOP VAV AIR HANDLING UNIT
- ③ DEMOLISH "SPARE" CENTRAL AIR CONDITIONING / HEAT PUMP SYSTEM COMPLETELY. DEMOLISH ALL COMPONENTS ASSOCIATED WITH THE SYSTEM NOT INDICATED.
- ④ DEMOLISH EXISTING STEAM AND CONDENSATE LINES.
- ⑤ DEMOLISH EXISTING BOILER COMPLETE, INCLUDING PIPING SUPPORTS, ELECTRICAL POWER AND CONTROLS.

FINAL

Approved: <i>[Signature]</i>	Facilities and Engineering:	Drawing Title: MECHANICAL PLAN DEMOLITION BASEMENT	Project Name: RENOVATE MANSION HOUSE AND GRIST MILL VA MEDICAL CENTER
Approved: <i>[Signature]</i>	Associate Chief for Maintenance and Operations, Party Point:	Approved: Associate Director for Operations:	Building No: 501 Drawn: T/JF
Approved: <i>[Signature]</i>	Drawing Start Date: 03/15/2012	Checklist: RLD	Location: FERRY POINT MARYLAND
Approved: <i>[Signature]</i>	Drawing Finish Date: 10/15/2012		
Approved: <i>[Signature]</i>	Drawing Approved: JOE BUCH		

Drawing Scale: AS VOTED
Drawing Start Date: 03/15/2012
Drawing Finish Date: 10/15/2012
Drawing Approved: JOE BUCH



Approved: <i>[Signature]</i>	Facilities and Engineering:	Drawing Title: MECHANICAL PLAN DEMOLITION BASEMENT	Project Name: RENOVATE MANSION HOUSE AND GRIST MILL VA MEDICAL CENTER
Approved: <i>[Signature]</i>	Associate Chief for Maintenance and Operations, Party Point:	Approved: Associate Director for Operations:	Building No: 501 Drawn: T/JF
Approved: <i>[Signature]</i>	Drawing Start Date: 03/15/2012	Checklist: RLD	Location: FERRY POINT MARYLAND
Approved: <i>[Signature]</i>	Drawing Finish Date: 10/15/2012		
Approved: <i>[Signature]</i>	Drawing Approved: JOE BUCH		


Approved: <i>[Signature]</i>	Facilities and Engineering:	Drawing Title: MECHANICAL PLAN DEMOLITION BASEMENT	Project Name: RENOVATE MANSION HOUSE AND GRIST MILL VA MEDICAL CENTER
Approved: <i>[Signature]</i>	Associate Chief for Maintenance and Operations, Party Point:	Approved: Associate Director for Operations:	Building No: 501 Drawn: T/JF
Approved: <i>[Signature]</i>	Drawing Start Date: 03/15/2012	Checklist: RLD	Location: FERRY POINT MARYLAND
Approved: <i>[Signature]</i>	Drawing Finish Date: 10/15/2012		
Approved: <i>[Signature]</i>	Drawing Approved: JOE BUCH		

File # 501-MD100 Drawing Date: 10/15/2012 Sheet No. 1 of 13

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DEMOLITION NOTES

- ① DEMOLISH EXISTING WALL/WINDOW MOUNTED AIR CONDITIONING UNIT.
 - ② DEMOLISH EXISTING SUPPLY AIR DUCTLET.
 - ③ DEMOLISH EXISTING PREDICTIVE THERMOSTAT AND TUBING BACK TO CONTROL CENTER.
 - ④ DEMOLISH EXISTING RADIATOR AND ASSOCIATED PIPING.
 - ⑤ DEMOLISH EXISTING STEAM AND CONDENSATE LINES.

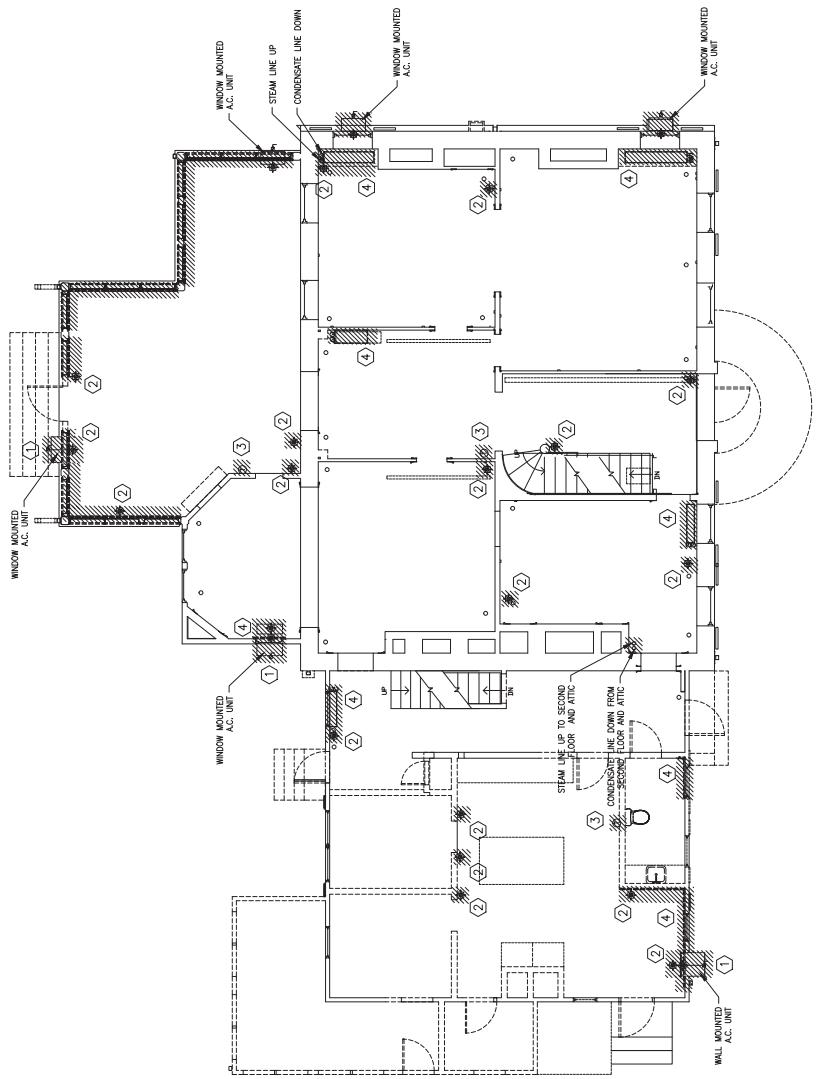

BUILDING 501
FIRST FLOOR - MECHANICAL DEMOLITION

SCALE: $1/4'' = 1'-0''$

SCALE: 1/



BES DESIGNBUILD		1035 K Street, NW, Suite 900 Washington, DC 20006 Phone: 202-222-1834 Fax: 202-222-1822		DEPARTMENT OF GENERAL AFFAIRS	
Drawing Scale: AS NOTED	Approved: Chief Facilities and Engineering	Drawing Start Date: 03/01/2012	Approved: Associate Chief for Maintenance And Operations, Perry Point	Project Title: RENOVATE MANSION HOUSE AND GRIST MILL V MEDICAL CENTER	Date: 10/15/2012 Project No.: 51245-10-325
Drawing Finish Date: 10/15/2012				Building No.: 501 Checked: RLD Drawn: T.J.F.	DRAWING NO.: 501-MD101 Dwg. 2 of 13
Drawing Approved: JOE BAUCH				Location: PERRY POINT MARYLAND	