


SITE PLAN KEY NOTES

- 1 UNDERGROUND PVC CONDUIT (QTY AND SIZES AS INDICATED), SCHEDULE 40, RUN UNDERGROUND CONCRETE ENCASED, TYPICAL MINIMUM BURIAL DEPTH 36" BELOW FINISHED GRADE. PROVIDE CONTINUOUS WARNING TAPE OVER ALL BURIED CONDUIT AT 18" BELOW FINISH GRADE. INSTALL 3/8" MARKED PULL TAPE ALONG WITH REQUIRED CABLES.
- 2 TURN SCHED 40 PVC CONDUIT UP, SLEEVE AND SEAL FLOOR PENETRATION PER SPECIFICATIONS. TERMINATE CONDUIT AT 12" A.F.F. WITH END BELL. PLUG UNUSED CONDUITS AND SLEEVE AROUND CABLES IN OTHERS.
- 3 CONDUIT SHALL BE STUBBED TO 5' FROM BUILDING ENVELOPE. WORK OUTSIDE 5' PERIMETER PROVIDED BY OTHERS, UNDER SEPARATE CONTRACT.

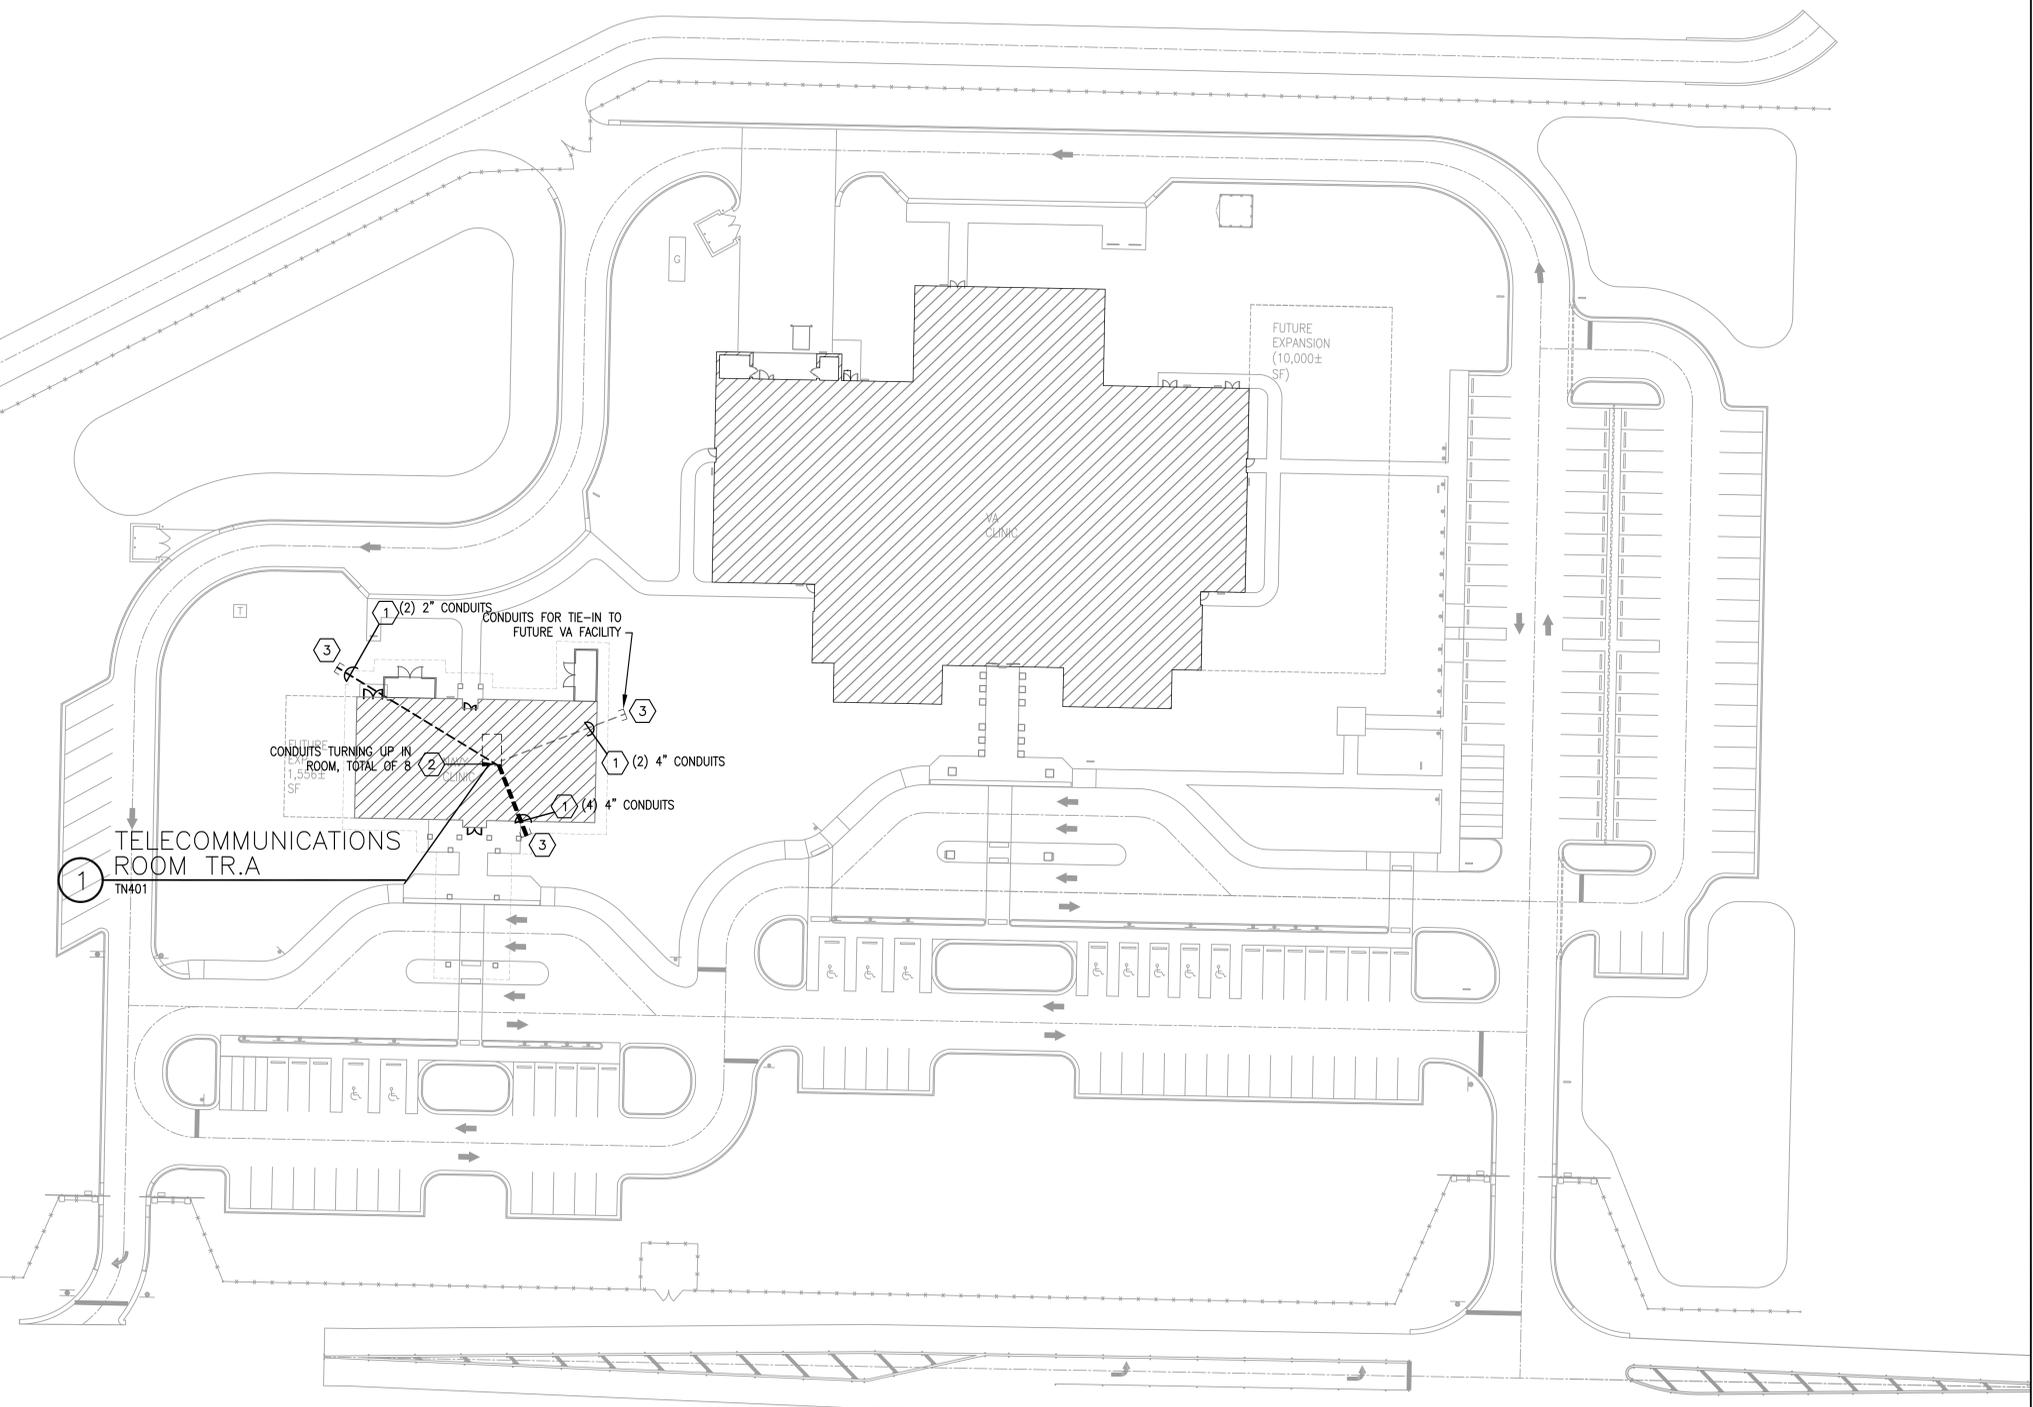

TELECOMMUNICATIONS SITE PLAN
 TN101
 SCALE: 1"=30'-0"

FINAL SUBMISSION
 APRIL 9, 2013

IF SHEET IS LESS THAN (30"x42") IT IS A REDUCED PRINT; SCALE ACCORDINGLY

TN101

 3766 MIDDLE ST., FARMHOPE, AL 36532 251-990-5778 ARCH. & ENGR. SEAL 	NATURAL RESOURCES & ENVIRONMENTAL AFFAIRS	P.W. DWG. NO.	DEPARTMENT OF THE NAVY
	SAFETY DEPARTMENT	DRAWN BY CEC	NAVAL SUPPORT ACTIVITY
	FIRE DEPARTMENT	CHECKED BY CEC	PANAMA CITY, FLORIDA
	PUBLIC WORKS SUPERVISOR	SUPERVISOR TAN	CONSTRUCT NAVAL BRANCH CLINIC, PANAMA CITY
	APPROVED	DATE 02/15/2013	TELECOMMUNICATIONS SITE PLAN
			SIZE F
			CODE IDENT. NO. N/A
			CONSTR. CONTR. NO. N/A
			SCALE AS NOTED
			MACC.
			T.O.#
			SHEET 2 OF 12