

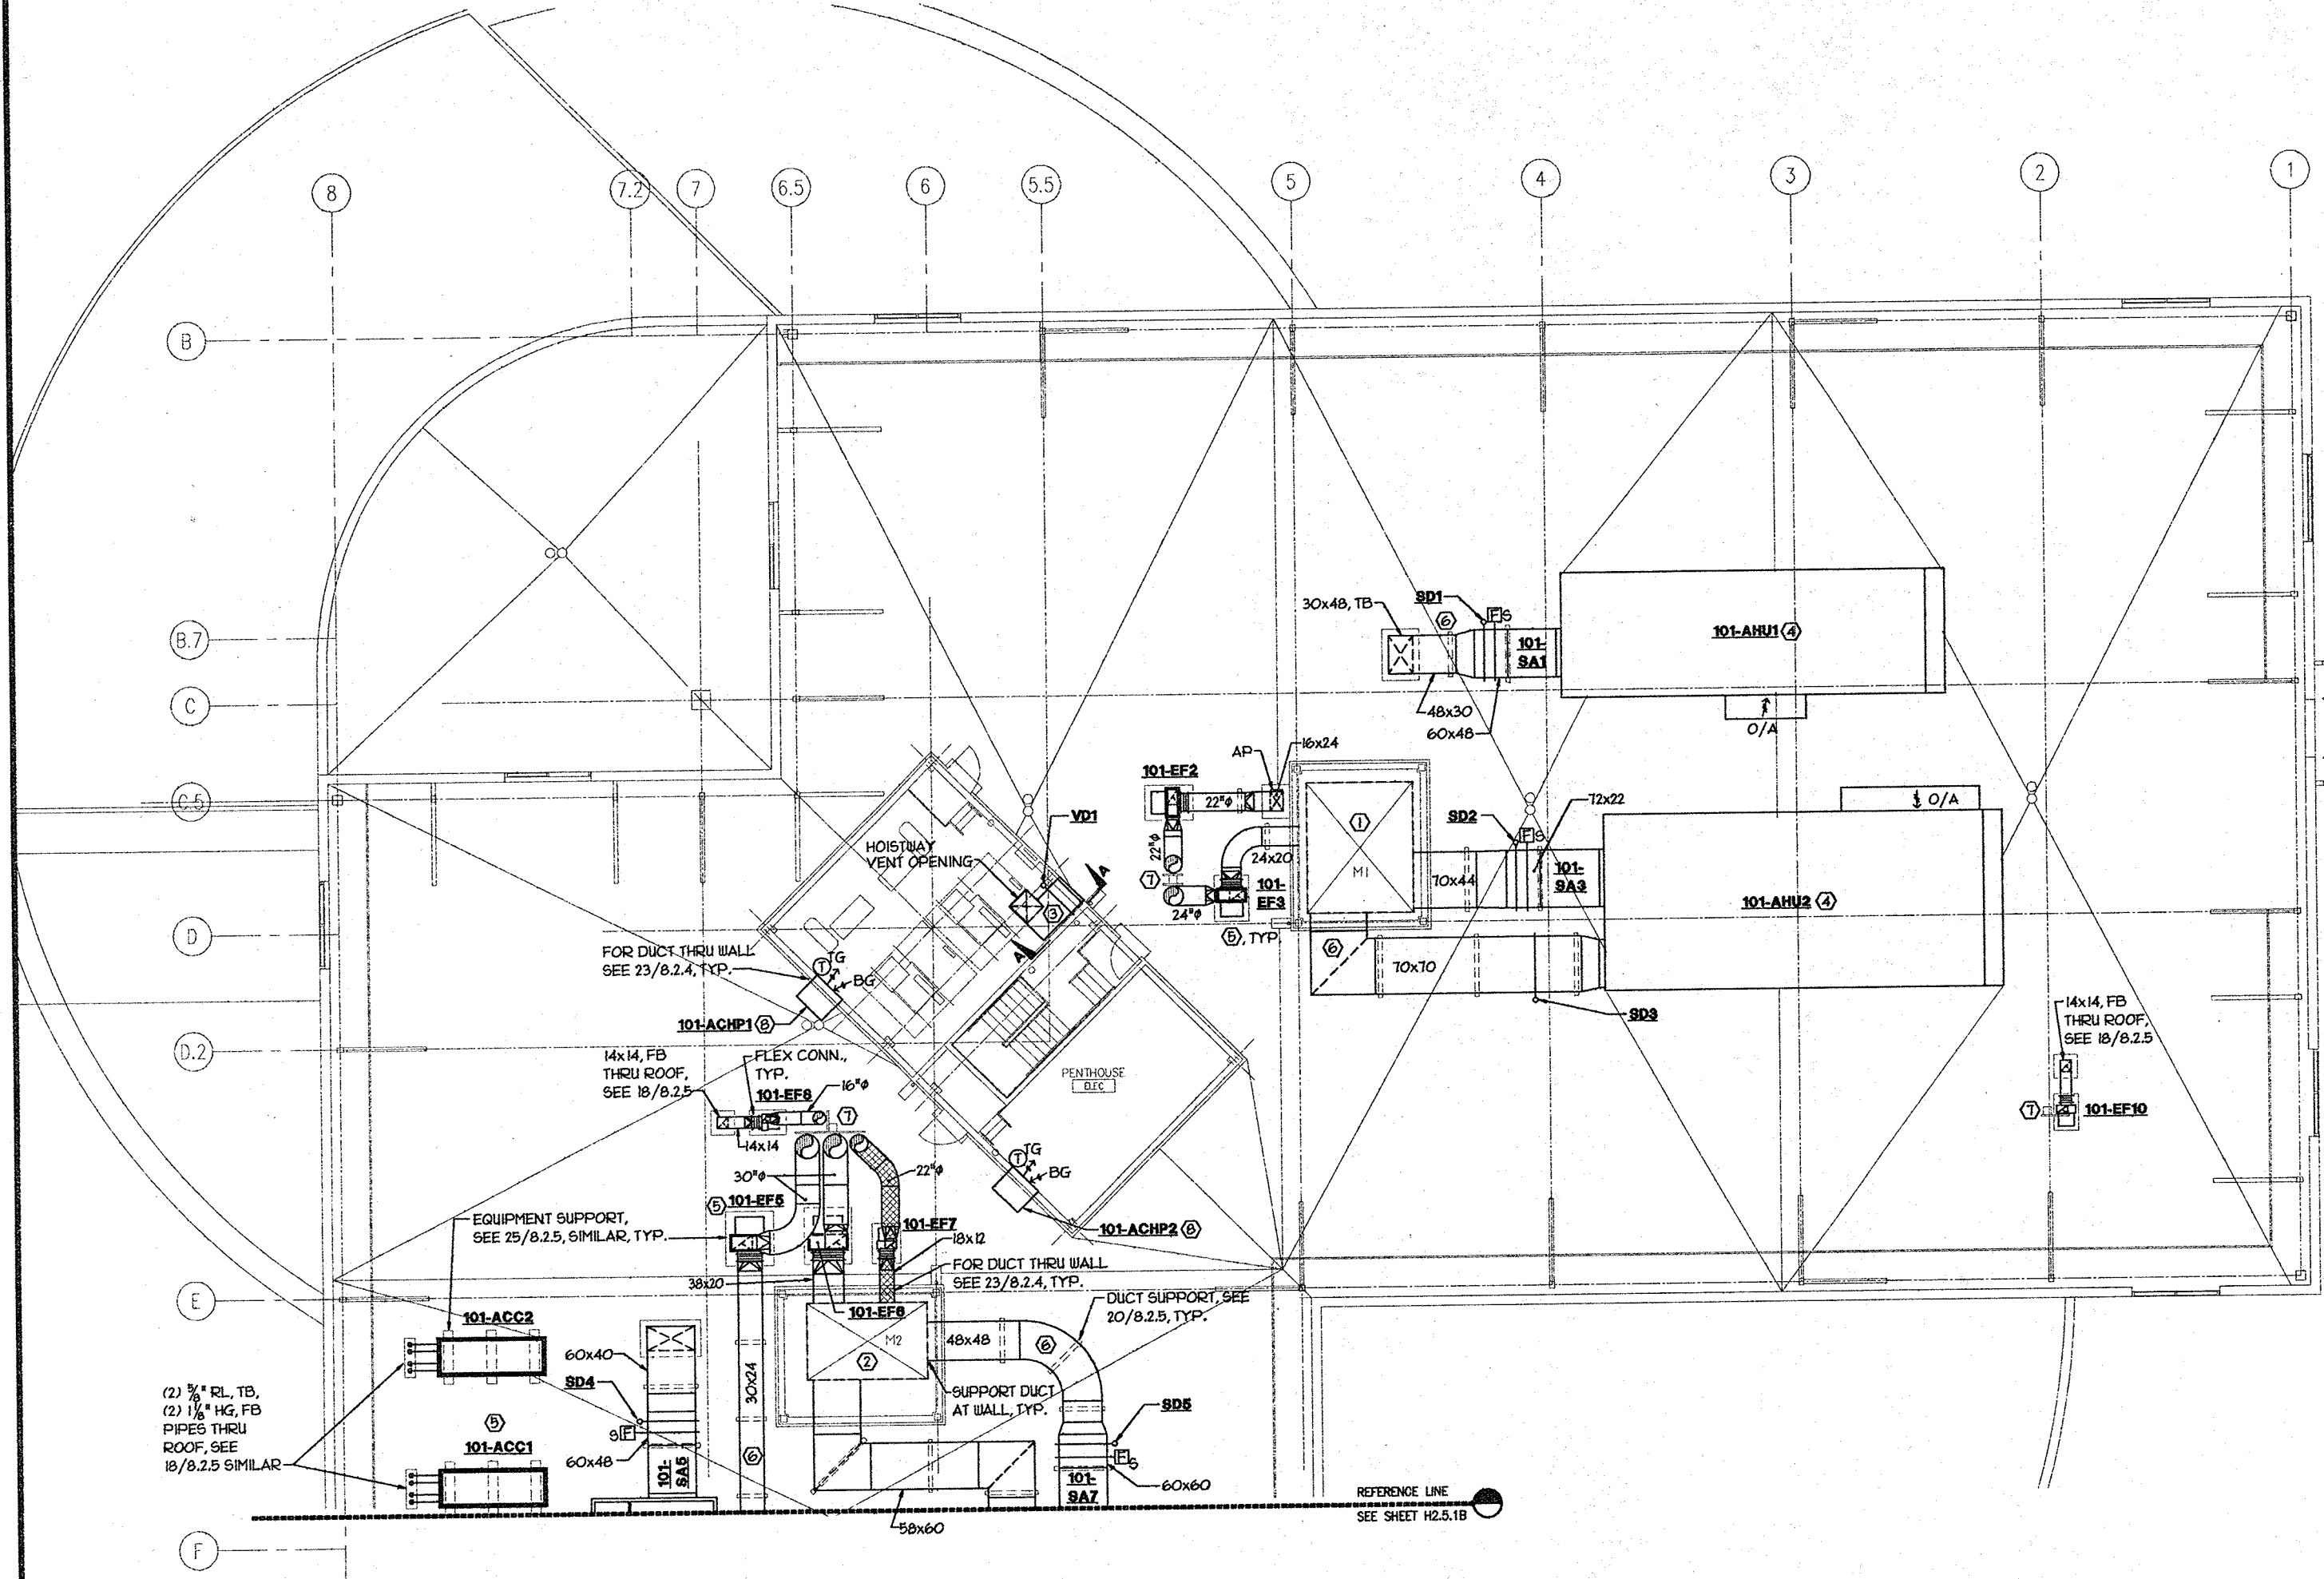


three inches = one foot
one and one-half inches = one foot
one inch = one foot
three-quarters inch = one foot
one-half inch = one foot
three-eighths inch = one foot
one-quarter inch = one foot
one-eighth inch = one foot

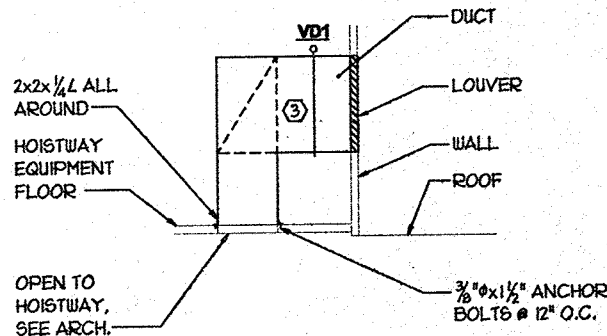

- SHEET NOTES:**
- ① FOR DUCT CONTINUATION IN SHAFT SEE 5/H3.1.1.
 - ② FOR DUCT CONTINUATION IN SHAFT SEE 5/H3.1.2.
 - ③ CONNECT DUCT FROM HOISTWAY VENT OPENING (2'-6"x2'-6") TO LOUVER (3'-0" WIDE x 4'-0" HIGH)
 - ④ FOR AHU SUPPORT CURB DETAIL SEE 7/55.3.0.
 - ⑤ FOR PIPE/EQUIPMENT SUPPORT CURB DETAIL SEE 8/55.3.0.
 - ⑥ FOR DUCT SUPPORT CURB DETAIL SEE 8/55.3.0.
 - ⑦ PROVIDE FULL SIZE DUCT (OR EQUAL ROUND DUCT) FROM FAN DISCHARGE TO WITHIN 4'-0" OF THE DUCT DISCHARGE (AT 15'-0" ABOVE ROOF), THEN REDUCE DUCT SIZE TO ABOUT 3000 FPM OUTLET VELOCITY TO DISCHARGE, SEE 3/H4.1.5.
 - ⑧ SUPPLY AND RETURN REGISTERS AND THERMOSTAT FURNISHED WITH UNIT.

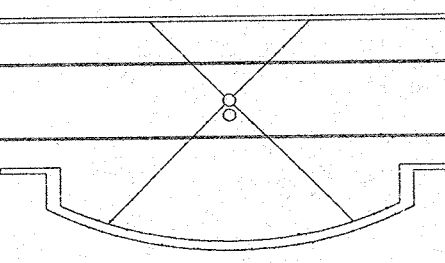

SECTION A-A
SCALE: NONE

FOR BASIC FIRE PROTECTION DIAGRAMS, SEE FIRE PROTECTION PLANS, FP PREFIX DRAWINGS. FOR SPECIFIC PARTITION TYPES SEE ARCHITECTURAL DIMENSION PLANS.

Office of Facilities

Western Team Director

Approved Project Director

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DESIGNER/DRAWER PROJECT NO.

KEY PLAN

Location	VA Medical Center Palo Alto, CA
Project Title	REPLACE CLINICAL/ BED TOWER FOR SEISMIC CORRECTIONS
FULLY SPRINKLERED	
TRA Project No.	93007
Checked	TGJ
Drawn	DA
Drawing Title	FIFTH FLOOR/ROOF PLAN, AREA A - MECHANICAL
Scale	1/8" = 1'-0"
VA Project No.	640-042G
Building Number	101
Date	2 MAY 1994
Drawing No.	H2.5.1A
Dwg	of