




*The Price of Freedom
is Visible Here*



JACK C. MONTGOMERY VETERANS AFFAIRS

MEDICAL CENTER

REPLACE WINDOWS BUILDING 1 PROJECT NO: 623-12-102

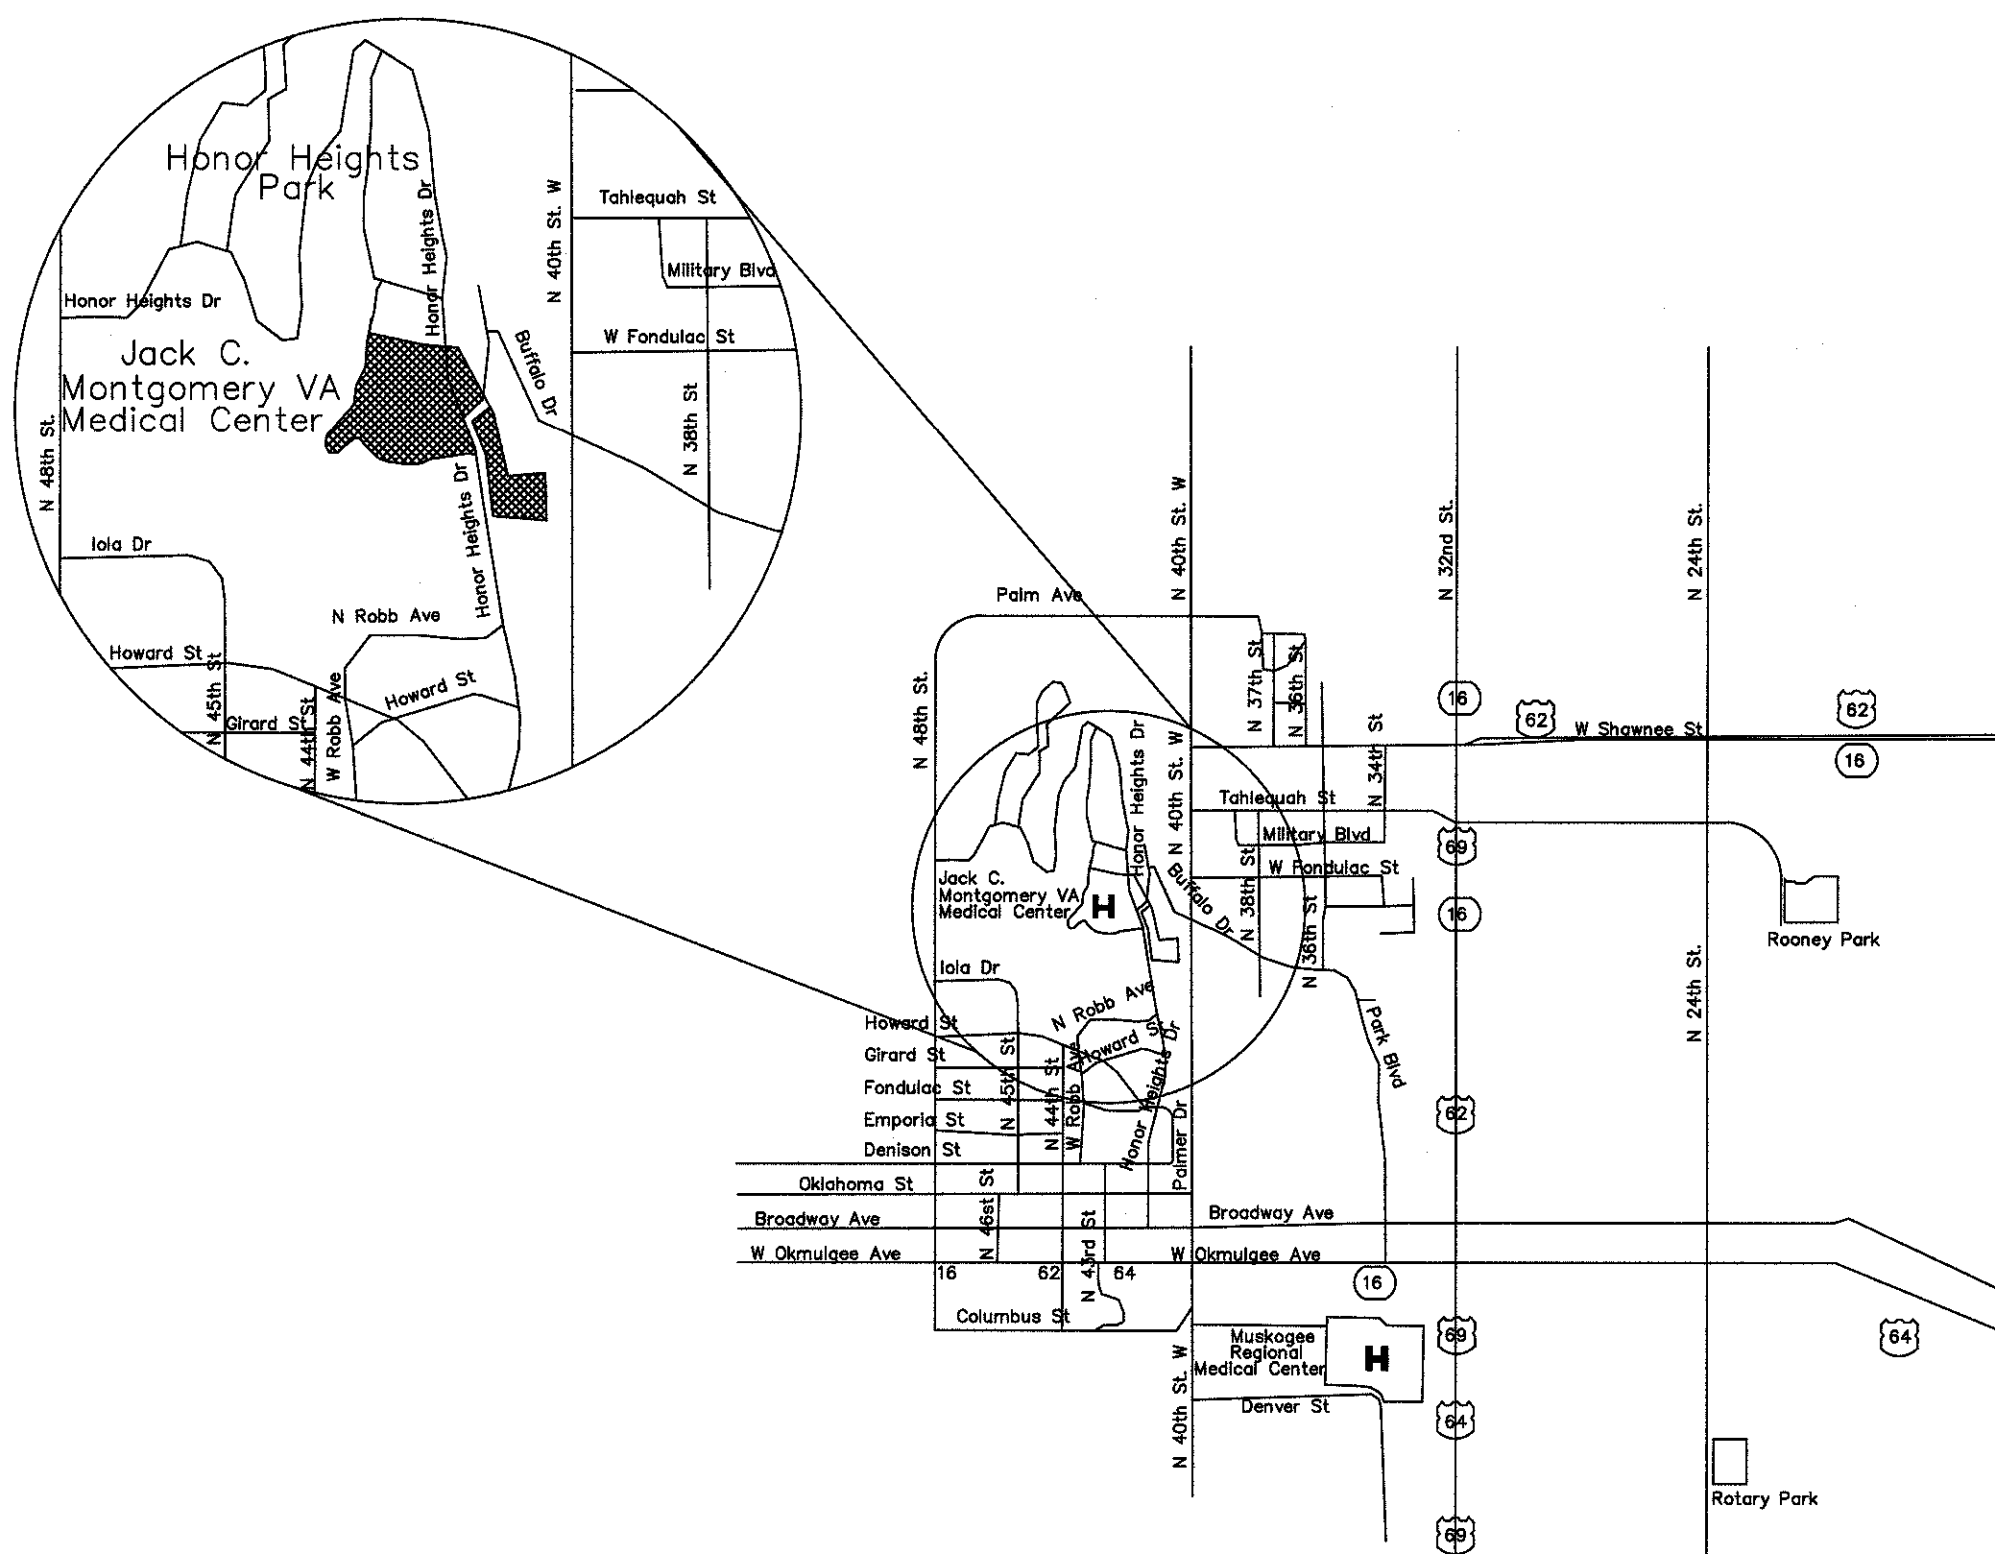

VICINITY MAP

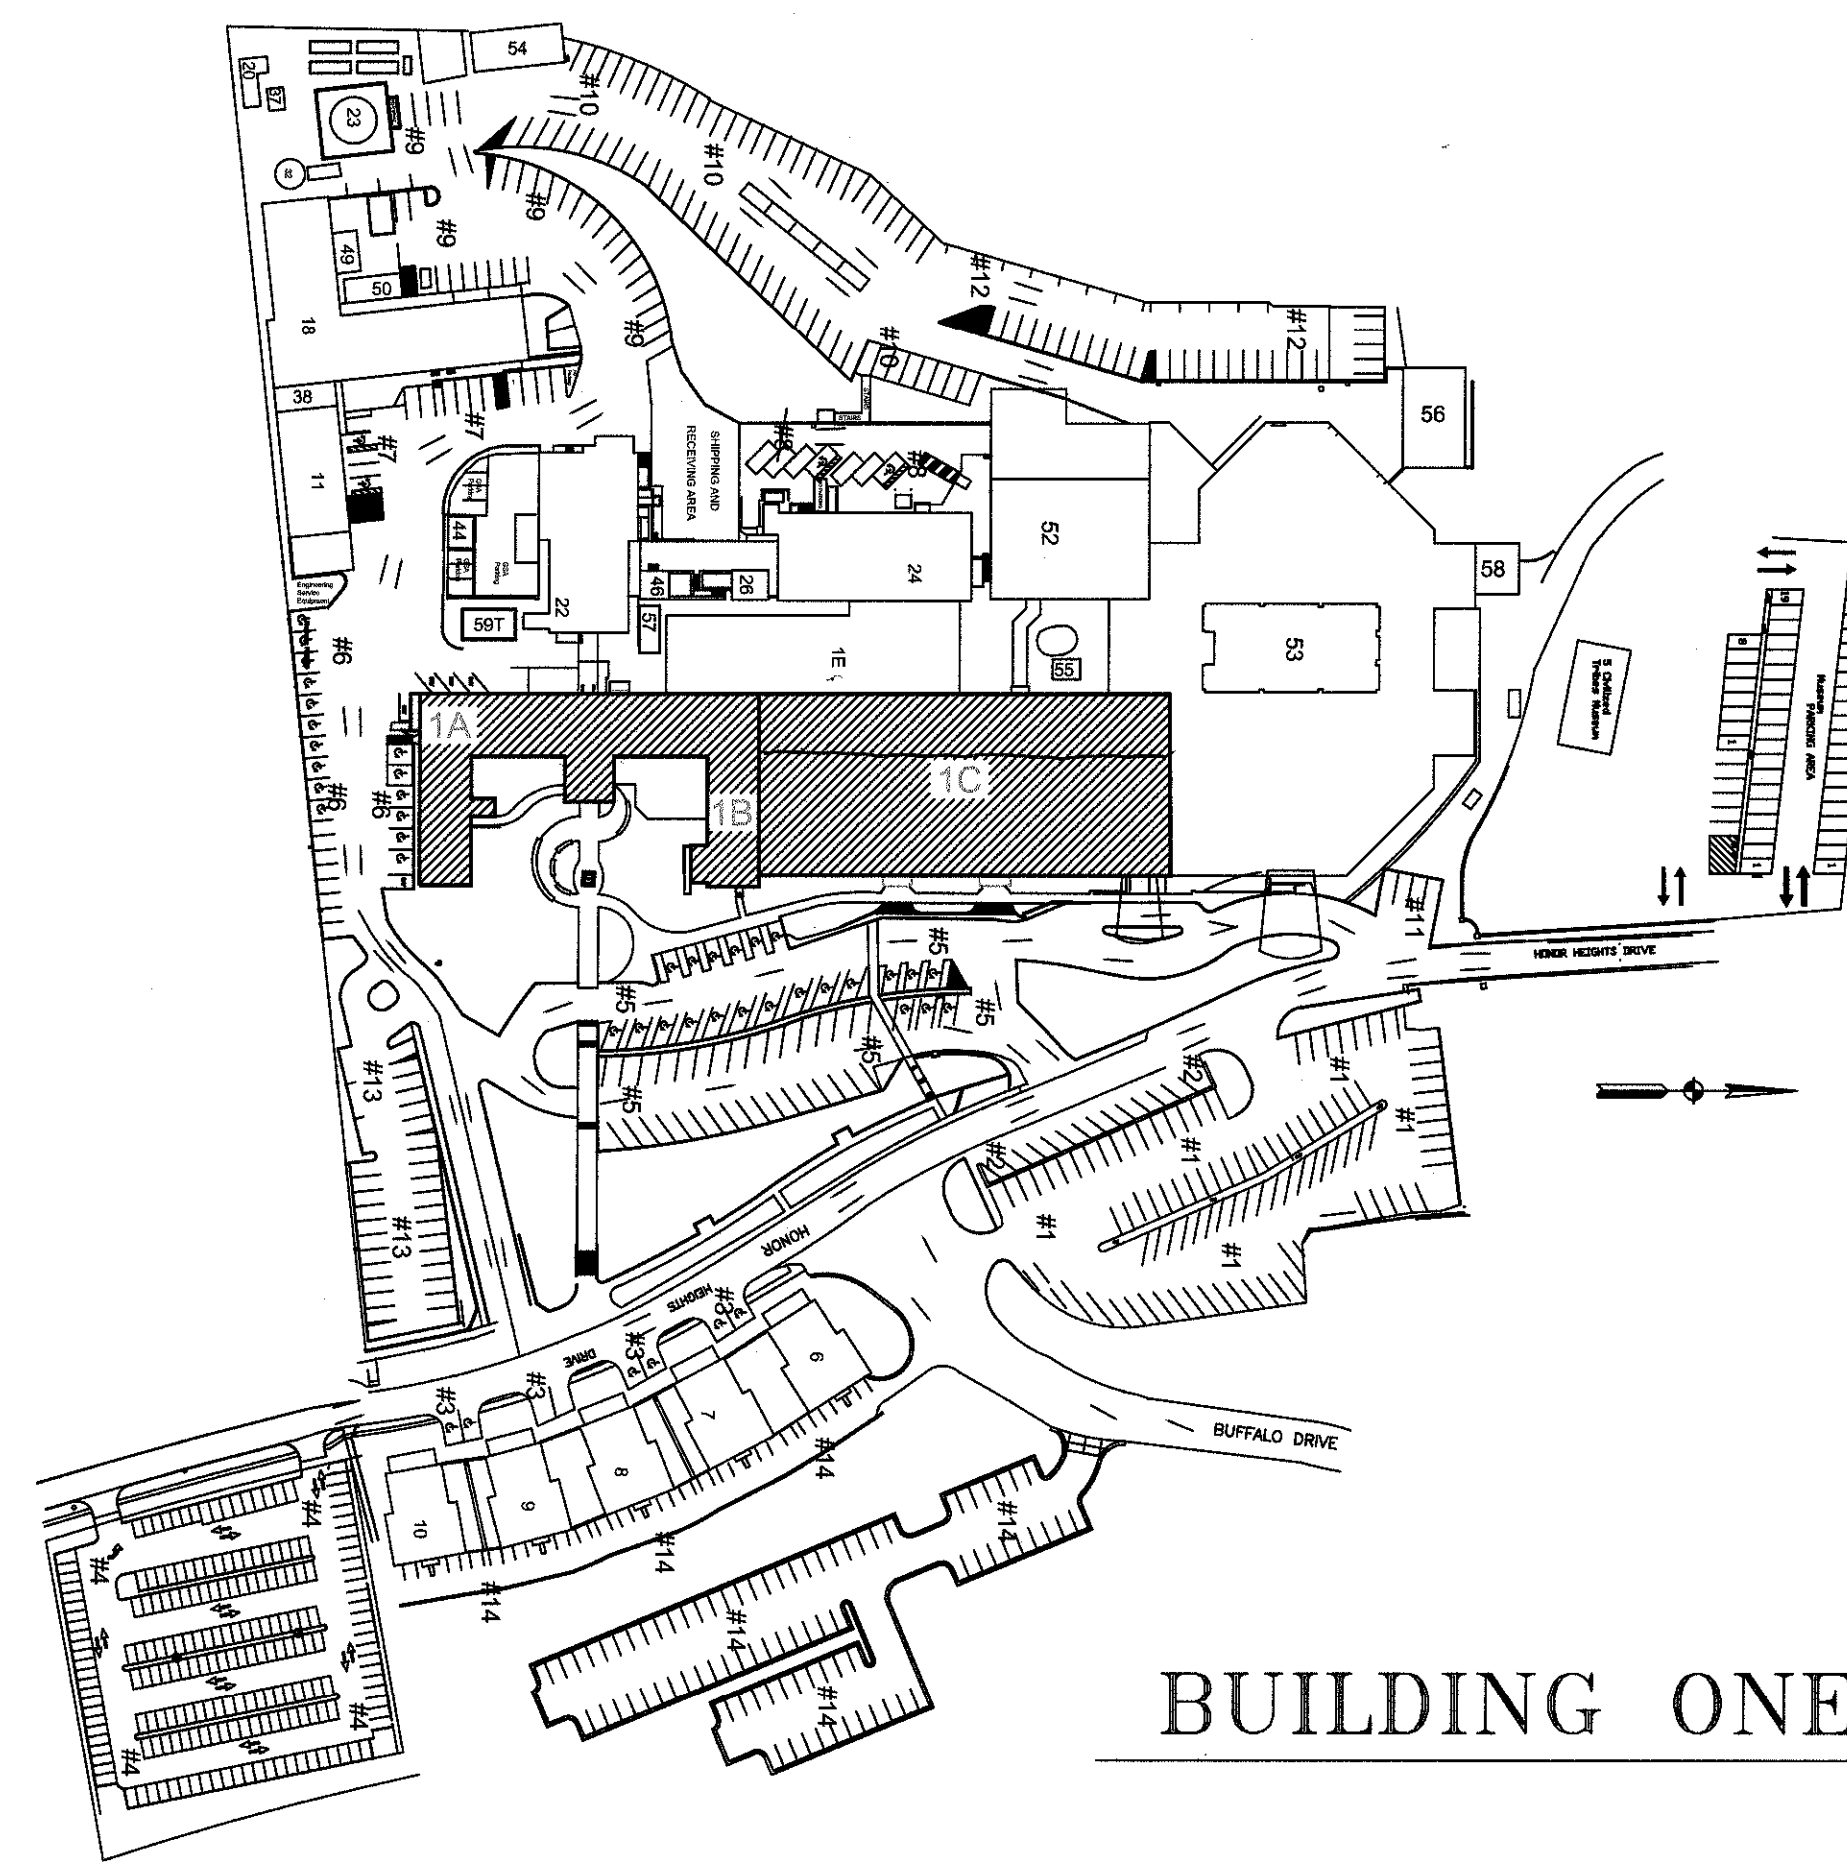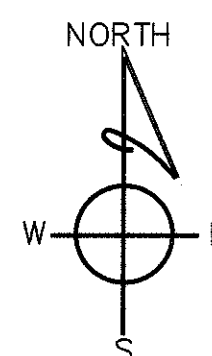

BUILDING ONE SITE

SHEET INDEX


PAGE	SHEET	DESCRIPTION
1	T1	TITLE SHEET
2	SP1.1	SITE PLAN
3	A1.1	A & B WING EAST ELEVATION AND PHOTOGRAPHS
4	A1.2	A & B WING SOUTH ELEVATIONS AND PHOTOGRAPHS
5	A1.3	A & B WING NORTH ELEVATIONS AND PHOTOGRAPHS
6	A1.4	A & B WING WEST ELEVATION AND PHOTOGRAPHS
7	A1.5 A	C WING EAST ELEVATION AND PHOTOGRAPHS
8	A1.6	C WING WEST ELEVATIONS AND PHOTOGRAPHS
9	A2.1	A & B WING FIRST FLOOR PLAN
10	A2.2	C WING FIRST FLOOR PLAN
11	A2.3	DEMOLITION SPREADSHEET FIRST FLOOR AB&C
12	A3.1	A & B WING SECOND FLOOR PLAN
13	A3.2	C WING SECOND FLOOR PLAN
14	A3.3	DEMOLITION SPREADSHEET SECOND FLOOR AB&C
15	A4.1	A & B WING THIRD FLOOR PLAN
16	A4.2	C WING THIRD FLOOR PLAN
17	A4.3	DEMOLITION SPREADSHEET THIRD FLOOR AB&C
18	A5.1	A & B WING FOURTH FLOOR PLAN
19	A5.2	C WING FOURTH FLOOR PLAN
20	A5.3	DEMOLITION SPREADSHEET FOURTH FLOOR AB&C
21	A6.1	A & B WING FIFTH FLOOR PLAN
22	A6.2	DEMOLITION SPREADSHEET FIFTH AND SIXTH FLOOR A&B
23	A7.1	A & B WING PENTHOUSE FLOOR PLAN
24	A8.1	STOREFRONT DEMOLITION BUILDING A & B
25	A8.2	STOREFRONT DEMOLITION BUILDING C
26	A8.3 B	STOREFRONT DESIGN BUILDING A&B
27	A8.4 B	STOREFRONT DESIGN BUILDING C
28	A9.1 B	BUILDING CROSS SECTIONS & DETAILS
29	A9.2	EXISTING WINDOW DETAILS
30	A9.3 B	NEW WINDOW DETAILS
31	M1.1	MECHANICAL/ELECTRICAL DETAILS

APPLICABLE CODES

INTERNATIONAL BUILDING CODE 2012
NFPA-101 LIFE SAFETY CODE, 2012 EDITION
INTERNATIONAL FIRE CODE, 2009 EDITION
UNIFORM MECHANICAL CODE 2009 EDITION
NATIONAL ELECTRIC CODE 2011 EDITION


REVISIONS:	DATE:		Dept. of Veterans Affairs Jack C. Montgomery Medical Center 1011 Honor Height Drive Muskogee, Oklahoma 74401		APPROVED:	APPROVED: President A.F.G.E. 2250	APPROVED: Energy Engineer	APPROVED: Medical Center Director	DRAWING TITLE	PROJECT TITLE	DATE
					APPROVED:	APPROVED:	APPROVED: Safety Manager	APPROVED: Associate Director	TITLE PAGE	REPLACE WINDOWS BUILDING #1	14 NOVEMBER 2012
					APPROVED:	APPROVED:	APPROVED: Infection Control Nurse	APPROVED: Chief of Staff	PROJECT NO.	CONTRACT NO.	SCALE
					APPROVED:	APPROVED:	APPROVED: Industrial Hygienist	APPROVED: Chief of Engineering Service	623-12-102	VA25612C0232	AS SHOWN
									Building #1	62312102T1	DWG. 1 of 31

Department of
Veterans Affairs

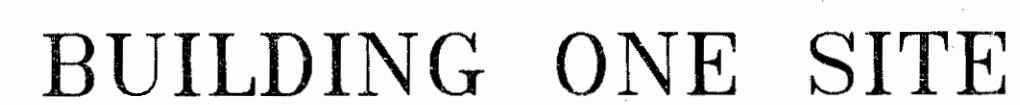

1. ALL SEALANTS ARE TO BE APPLIED IN STRICT ACCORDANCE WITH THE MANUFACTURER'S PRINTED INSTRUCTIONS. THE COMPATIBILITY OF SEALANTS, AND OTHER MATERIALS SHALL BE CHECKED WITH THE SEALANT MANUFACTURER.
2. SEALANTS SHALL BE APPLIED WHERE SHOWN PER APPROVED SHOP DRAWINGS.
3. ALL ANCHOR BOLTS, NUTS, AND WASHERS ARE TO BE ZINC PLATED STEEL OR STAINLESS STEEL UNLESS OTHERWISE SPECIFIED.
4. ALL NEOPRENE AND/OR EPDM GLAZING GASKETS ARE TO BE SHIPPED FOR FIELD INSTALLATION UNLESS OTHERWISE SPECIFIED
5. FIELD VERIFY ALL DIMENSIONS AND SPECIFICALLY ALL WINDOW DIMENSIONS.
6. ALL SHOP DRAWINGS ARE TO BE RETURNED "APPROVED" BY ARCHITECT, GENERAL CONTRACTOR, AND/OR SUBCONTRACTOR.
7. STOREFRONT ERECTION AND GLAZING PROCEDURES ARE TO BE IN ACCORDANCE WITH PROCEDURES IN THE YK4 AP. STANLEY OR APPROVED EQUAL INSTALLATION INSTRUCTIONS.
8. ERECTION OF MATERIALS SHALL NOT COMMENCE UNTIL THE ERECTOR HAS RECEIVED A COPY(S) OF MANUFACTURERS FINAL AND ARCHITECTS "CODED" APPROVED SHOP DRAWINGS AND ELEVATION SHEETS. THREE (3) SETS OF "CODED" SHOP DRAWING ELEVATION SHEETS WILL BE FURNISHED TO THE ERECTOR(S) AND/OR GLAZIER(S).
9. ALL WALLS ARE TO BE ERECTED PLUMB AND LEVEL IN VERTICAL AND HORIZONTAL DIRECTIONS.
10. ALL CLIPS, MISCELLANEOUS ATTACHMENTS, NUTS, BOLTS, SCREWS, ETC., MUST BE FURNISHED AS DESCRIBED AND INSTALLED AS DETAILED ON THE APPROVED DRAWINGS.
- II. ON BUILDING ONE C WING EAST SIDE REMOVE EXISTING FACE BRICK ABOVE FIVE WINDOWS TO EXPOSE EXISTING LINTEL AND TO AN ELEVATION BELOW HALF BRICK DECORATIVE BAND. REMOVE RUST AND CAULKING FROM EXISTING LINTEL AND TREAT WITH RUST PROHIBITED PAINT. AT INTERIOR SIDE, PAINT LINTEL TO MATCH EXISTING WALL COLOR. REPLACE NEW WINDOW AS PER TYPICAL DETAIL TO INCLUDE FLASHING, WEEP HOLES AND CAULKING. REMOVE DAMAGE FACE BRICK AS NECESSARY WITH NEW FACE BRICK THAT MATCHES EXISTING BRICK IN COLOR AND TEXTURE.

R.O.	ROUGH OPENING
D.O.	DOOR OPENING
D.L.O.	DAYLIGHT OPENING
F.H.	FRAME HEIGHT
F.W.	FRAME WIDTH
TYP	TYPICAL
F.F.	FINISH FLOOR
CL	CENTER LINE
OPP	OPPOSITE HAND
SIM	SIMILAR



A

1. ALL WORK SHALL BE DONE IN ACCORDANCE WITH ALL LOCAL, STATE, AND FEDERAL CODES AND REGULATIONS, MANUFACTURER'S RECOMMENDATIONS, AND STANDARD INDUSTRY PRACTICES.
2. BIDDERS MUST VISIT THE PROJECT LOCATION TO FIELD VERIFY THE EXISTING CONDITIONS AND THE EXTENT OF ALL OBSTACLES AND/OR CONDITIONS AFFECTING THE WORK. SITE VISITS SHALL BE SCHEDULED IN ADVANCE WITH THE CONTRACTING OFFICER.
3. CONTRACTOR SHALL FURNISH ALL NECESSARY LIFT EQUIPMENT, LABOR, MATERIALS, TEMPORARY SCAFFOLDING, TOOLS SPECIALITY SERVICES, CONTAINERS DUMPSTERS AND SUPERVISION TO PERFORM PROJECT 623-12-102. THIS INCLUDES COMPLETE WINDOW REPLACEMENT IN BUILDING ONE A, B, & C OVER 4.0 WINDOWS, 4 COMPLETE STOREFRONTS, INSTALLING MYLAR ON REAR STOREFRONT, REPLACING WINDOW EXHAUSTERS, INSTALLING LOUVERS, BRICK LINTEL AND BRICK REPAIR FOR 5 WINDOWS IN C WING, PAINTING OF STEEL DOORS, RAILINGS AND STEPS A,B,C, INSTALLING DECORATOR CEMENT PLAGUE IN EXTERIOR FIRST FLOOR BUILDING B EAST ELEVATION.
4. BLAST RESISTANT PRODUCT REQUIREMENT, THERE IS NO GOVERNMENT PROVIDED EQUIPMENT.
5. SPACE ON THE HOSPITAL CAMPUS IS EXTREMELY LIMITED. CONTRACTOR WILL BE EXPECTED TO HAVE STORAGE OFF CAMPUS. ONLY TWO DUMPSTERS AND ONE CONTAINER WILL BE ALLOWED ON CAMPUS COORDINATE WITH CONTRACTING OFFICER TECHNICAL REPRESENTATIVE. CONTRACTOR SHALL MAINTAIN PORTPOTITIE NEXT TO STORAGE CONTAINER FOR ITS OWN WORKERS AND WILL KEEP ITS EXTERIOR ASSIGNED AREA CLEAN.
6. THE CONTRACTOR SHALL COORDINATE WORKING SCHEDULES AND HOURS WITH THE CONTRACTING OFFICER REPRESENTATIVE PRIOR TO DEVELOPING A WORK PLAN FOR APPROVAL. CONTRACTOR WILL PROVIDE A SCHEDULE FOR INSTALLATION, CONSTRUCTION AND PAINTING DATES APPROVAL WHICH INCLUDES SUBMITTALS, SAMPLES SHOP DRAWINGS, AS BUILT DRAWINGS AND WARRANTY INFORMATION.
7. THE CONTRACTOR SHALL COORDINATE WITH THE CONTRACTING OFFICER REPRESENTATIVE PROJECT MANAGER FOR SPECIAL VA ENTRY REQUIREMENTS.
8. CONTRACTOR SHALL PROVIDE WORK SIGN AND WORK SAFETY SIGN SEE SECTION 0-01-00 NEAR MAIN ENTRANCE OF A AND B WING.
9. ALL DIMENSIONS AND CONDITIONS AFFECTING THE WORK SHALL BE FIELD VERIFIED BY THE CONTRACTOR. IT IS THE RESPONSIBILITY OF THE INSTALLATION CONTRACTOR TO MAKE HIS PRODUCT FIT INTO OPENINGS FOR WATER TIGHT ENERGY EFFICIENT APPLICATION.
10. CONTRACTOR SHALL FOLLOW HOSPITAL INFECTIOUS CONTROL PROCEDURES WHEN INSTALLING WINDOW AND STOREFRONT AND PERFORMING CONSTRUCTION OPERATIONS INSURE TO USE HEPA FILTRATION AND KEEP FACILITIES TO SMOKE BARRIER PROTECTION LEVELS USING WALK OFF ADHESIVE FLOOR MATS.
11. REFER TO REFERENCE DRAWING SHEETS FOR ADDITIONAL INFORMATION ON EXISTING BUILDING SYSTEMS. NOTE THESE DRAWINGS MAY NOT NECESSARILY REFLECT AS-BUILT OR CURRENT CONDITIONS.
12. THE PROJECTS DOES HAVE NON FRIABLE ASBESTOS TRANSIT PANEL (UPPER 1/3rd OF THE EXSTG WINDOW) TO BE REMOVED AND THE ORIGINAL WOOD AROUND THE WINDOW CONTAINS LEAD BASED PAINT THE INTENT IS TO NOT GRIND, SAND OR SAW CUT THESE ITEMS BUT TO UNSCREW OR PRY THEM LOOSE AND REMOVE IN ONE PIECE OR PRIMARILY COVER AS MUCH AS POSSIBLE. FOLLOW ENVIRONMENTAL AND DEMOLITION SPECIFICATIONS 02-41-00, 02-82-13, 02-93-33.
13. THE CONTRACTOR SHALL STOP WORK IMMEDIATELY AND CONTACT THE CONTRACTING OFFICER REPRESENTATIVE IF ANY SUSPECTED ASBESTOS CONTAINING MATERIAL OR LEAD PAINT IS DISCOVERED DURING THE PROJECT WHICH IS NOT COVERED IN THE SPECIFICATIONS OR DRAWINGS. HANDLING AND DISPOSAL OF ALL ASBESTOS CONTAINING MATERIALS AND LEAD PAINT SHALL BE IN ACCORDANCE WITH APPLICABLE FEDERAL, STATE, AND LOCAL LAWS.
14. THE CONTRACTOR SHALL SUBMIT PAY DRAW REQUESTS THROUGH THE CONTRACTING OFFICER TECHNICAL REPRESENTATIVE TO THE CONTRACTING OFFICER.

A 1-5/16" INSULATED, LAMINATED, LOW-E GLASS:
1/4" LOW-E SOLARBAN 60 BRONZE-PPG TEMP
1/2" AIR SPACE
9/16" CLEAR LAMINATED
(1/4" CLEAR + 0.060 PVB + 1/4" CLEAR)

B 9/16" LAMINATED LOW-E GLASS
1/4" LOW-E SOLARBAN 60 BRONZE-PPG TEMP
0.060 PVB
1/4" CLEAR

SLIDER WITH PANIC EXITING
AUTOMATIC DOOR OPENER TO BE HEAVY GAGE EXTRA DUTY
ADA THRESHOLD

20 YR PAINT FINISH
UCII5244 DURANAR SANDSTONE COLOR

Department of
Veterans Affairs




AREA WEST OF STAIRWELL

REMOVE COMPLETELY

EXSTG WINDOW TO GROUND LEVEL
CHANGE ADD 1 BLOCK HIGH
ADD SOLDIER COURSE FACE BRICK

LEGEND

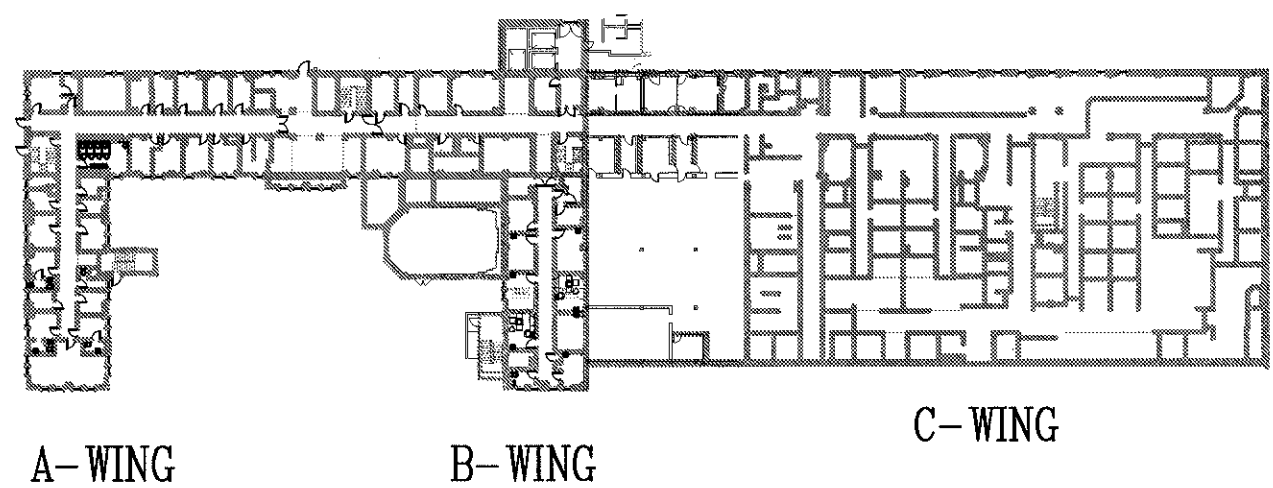

BLDG. 1 A & B WING EXISTING EAST ELEVATION

SCALE: 1/8" = 1'-0"

12 WINDOWS

A-WING

B-WING

C-WING

A-WING

A-WING

A-WING

A-WING

A-WING

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BRICK FACADE

STAIRWELL

CHAPEL

PLAQUE

99 WINDOWS

BLDG. 1 A & B WING EAST ELEVATION

SCALE: 1/8" = 1'-0"

A - WING

B - WING



A WING SOUTHEAST VIEW



B WING NORTH EAST VIEW




REMOVE EXHAUSTERS INSTALL LOUVER



BLDG 1 A&B WING MAIN ENTRY



ELECTRIC CONDUIT THROUGH WINDOW JAMB

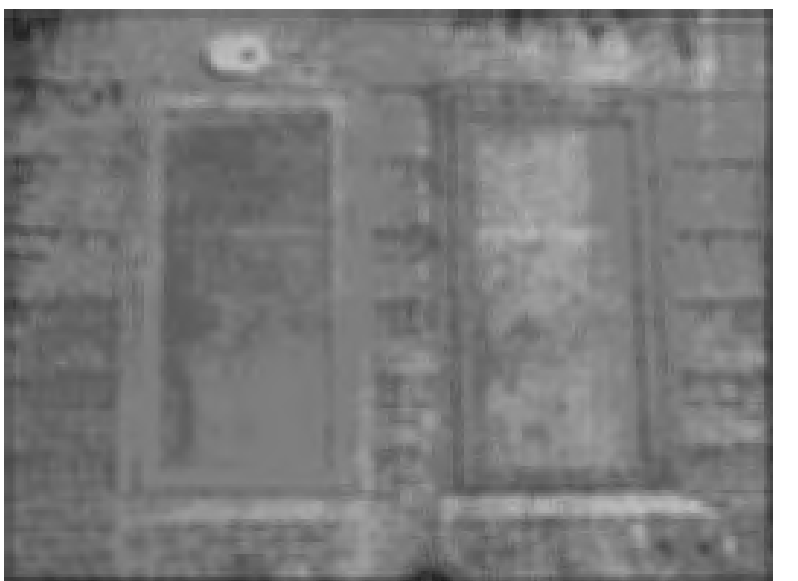


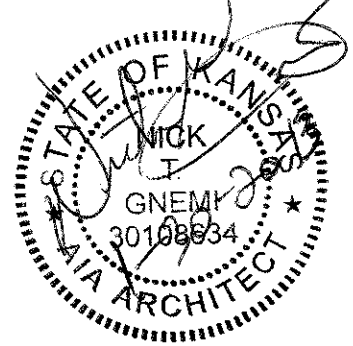
REMOVE WINDOWS INSTALL PLAQUE

ENVIRONMENTAL CONSIDERATIONS


- REMOVE ALUMINUM WINDOW BUT LEAVE HEAD JAMB AND SILL IN PLACE FOR ALL WINDOWS..
- REMOVE & DISPOSE THE TRANSIT PANEL, WHICH IS FREE FROM ANY FRIABLE ASBESTOS.
- TAKE CAUTION OF ORIGINAL WOOD WINDOWS & INTERIOR TRIM. THE WOOD HAS BEEN PAINTED WITH LEAD BASED PAINT. CAREFULLY DISPOSE THE WOOD IN A DOUBLE BAG.
- KEEP WINDOW FRAMES THAT ARE COVERED WITH ALUMINUM IN PLACE & WRAP THOSE INTERIOR WOOD MOLDINGS WITH ALUMINUM PANNING WHEN POSSIBLE FOR ALL WINDOWS.
- THE BUILDING WILL REMAIN FULLY FUNCTIONING AS A HOSPITAL DURING CONSTRUCTION.
- CONTRACTOR NEEDS TO OPERATE A SMOKE BARRIER PROTECTION FOR ALL LEVELS.
- CONTRACTOR NEED TO PROVIDE BINS FOR RECYCLABLES, DISPOSE DEBRIS DAILY OFF OF PROPERTY, & PROTECT PLANTS & VEGETATION FROM DAMAGE.
- CONTRACTOR NEEDS TO FILE HAZARDS LOG DAILY.

CONSTRUCTION NOTES


- REMOVE RUST, CLEAN, PRIME, AND PAINT STEEL WINDOW LINTELS
- INSTALL NEW BLAST-RESISTANT ENERGY EFFICIENT .30 U VALUE PAINTED ALUMINUM WINDOWS.
- INSTALL NEW WATER RESISTANT SHEETROCK FROM WALL TO WINDOW. FINISH COMPLETELY WITH LATEX PRIME & SHERWIN WILLIAMS PROM MAR 200 LATEX PAINT & INSTALL BLAST CLIP & TRIM.
- DISPOSE OF EXISTING WINDOW BLINDS OR SHADES & INSTALL NEW WINDOW TREATMENTS FOR ALL WINDOW TYPES EXCEPT STAIRWELLS.
- REMOVE WALL EXHAUSTER. INSTALL NEW WINDOW WITH INTEGRATED LOUVER. INSTALL CEILING EXHAUSTER INSTALL DUCT FROM EXHAUSTER TO INTEGRATED WINDOW LOUVER.
- INSTALL A NEW BLAST-RESISTANT THERMAL PANE .37 U VALUE PAINTED ALUMINUM WINDOWS IN PENTHOUSE MECHANICAL ROOM.
- REMOVE RUST PRIMER & ALKYD PAINT STEEL DOOR, STAIRS & HAND RAILINGS.
- IN B-WING REMOVE TWO WINDOWS COMPLETELY & INSTALL CONCRETE PLAQUE WITH VETERAN DESIGN.
- FOR THE RESTROOM, KEEP DUCT THROUGH SPANDREL & GALVANIZE THE DUCT. THE DUCT REQUIRES A UNIQUE FIT THROUGH THE NEW PAINTED ALUMINUM WINDOW.
- REMOVE EXSTG. SMALL STEEL WINDOW REPLACE WITH ALUMINUM FIXED WINDOW.
- REMOVE HEAVY GAGE STEEL FRAME & INSTALL NEW ALUMINUM WINDOWS WITH 3" PANNING THE PANNING SHOULD MATCH THE WINDOWS.
- INSTALL NEW BLAST-RESISTANT LAMINATE COATING ON BUILDING 1 A WING REAR STOREFRONT.

REVISIONS:	DATE:	 Dept. of Veterans Affairs Jack C. Montgomery Medical Center 1011 Honor Height Drive Muskogee, Oklahoma 74401		APPROVED:	APPROVED: President A.F.G.E. 2250	APPROVED: Energy Engineer	APPROVED: Medical Center Director	DRAWING TITLE	PROJECT TITLE	DATE
				APPROVED:	APPROVED:	APPROVED: Safety Manager	APPROVED: Associate Director	BUILDING A & B EAST ELEVATION	REPLACE WINDOWS BUILDING #1	27 DECEMBER 2012
				APPROVED: Infection Control Nurse	APPROVED: Chief of Staff	PROJECT NO. 623-12-102	CONTRACT NO. VA25612C0232	DESIGNED BY PROUD VETERANS	DRAWN BY JA	CHECKED BY NTG
				APPROVED: Industrial Hygienist	APPROVED: Chief of Engineering Service	BUILDING NO. Building #1	AUTOCAD FILE NAME 62312102A1.1	LOCATION Jack C. Montgomery VA Medical Center		
										DWG. 3 OF 31

Department of
Veterans Affairs

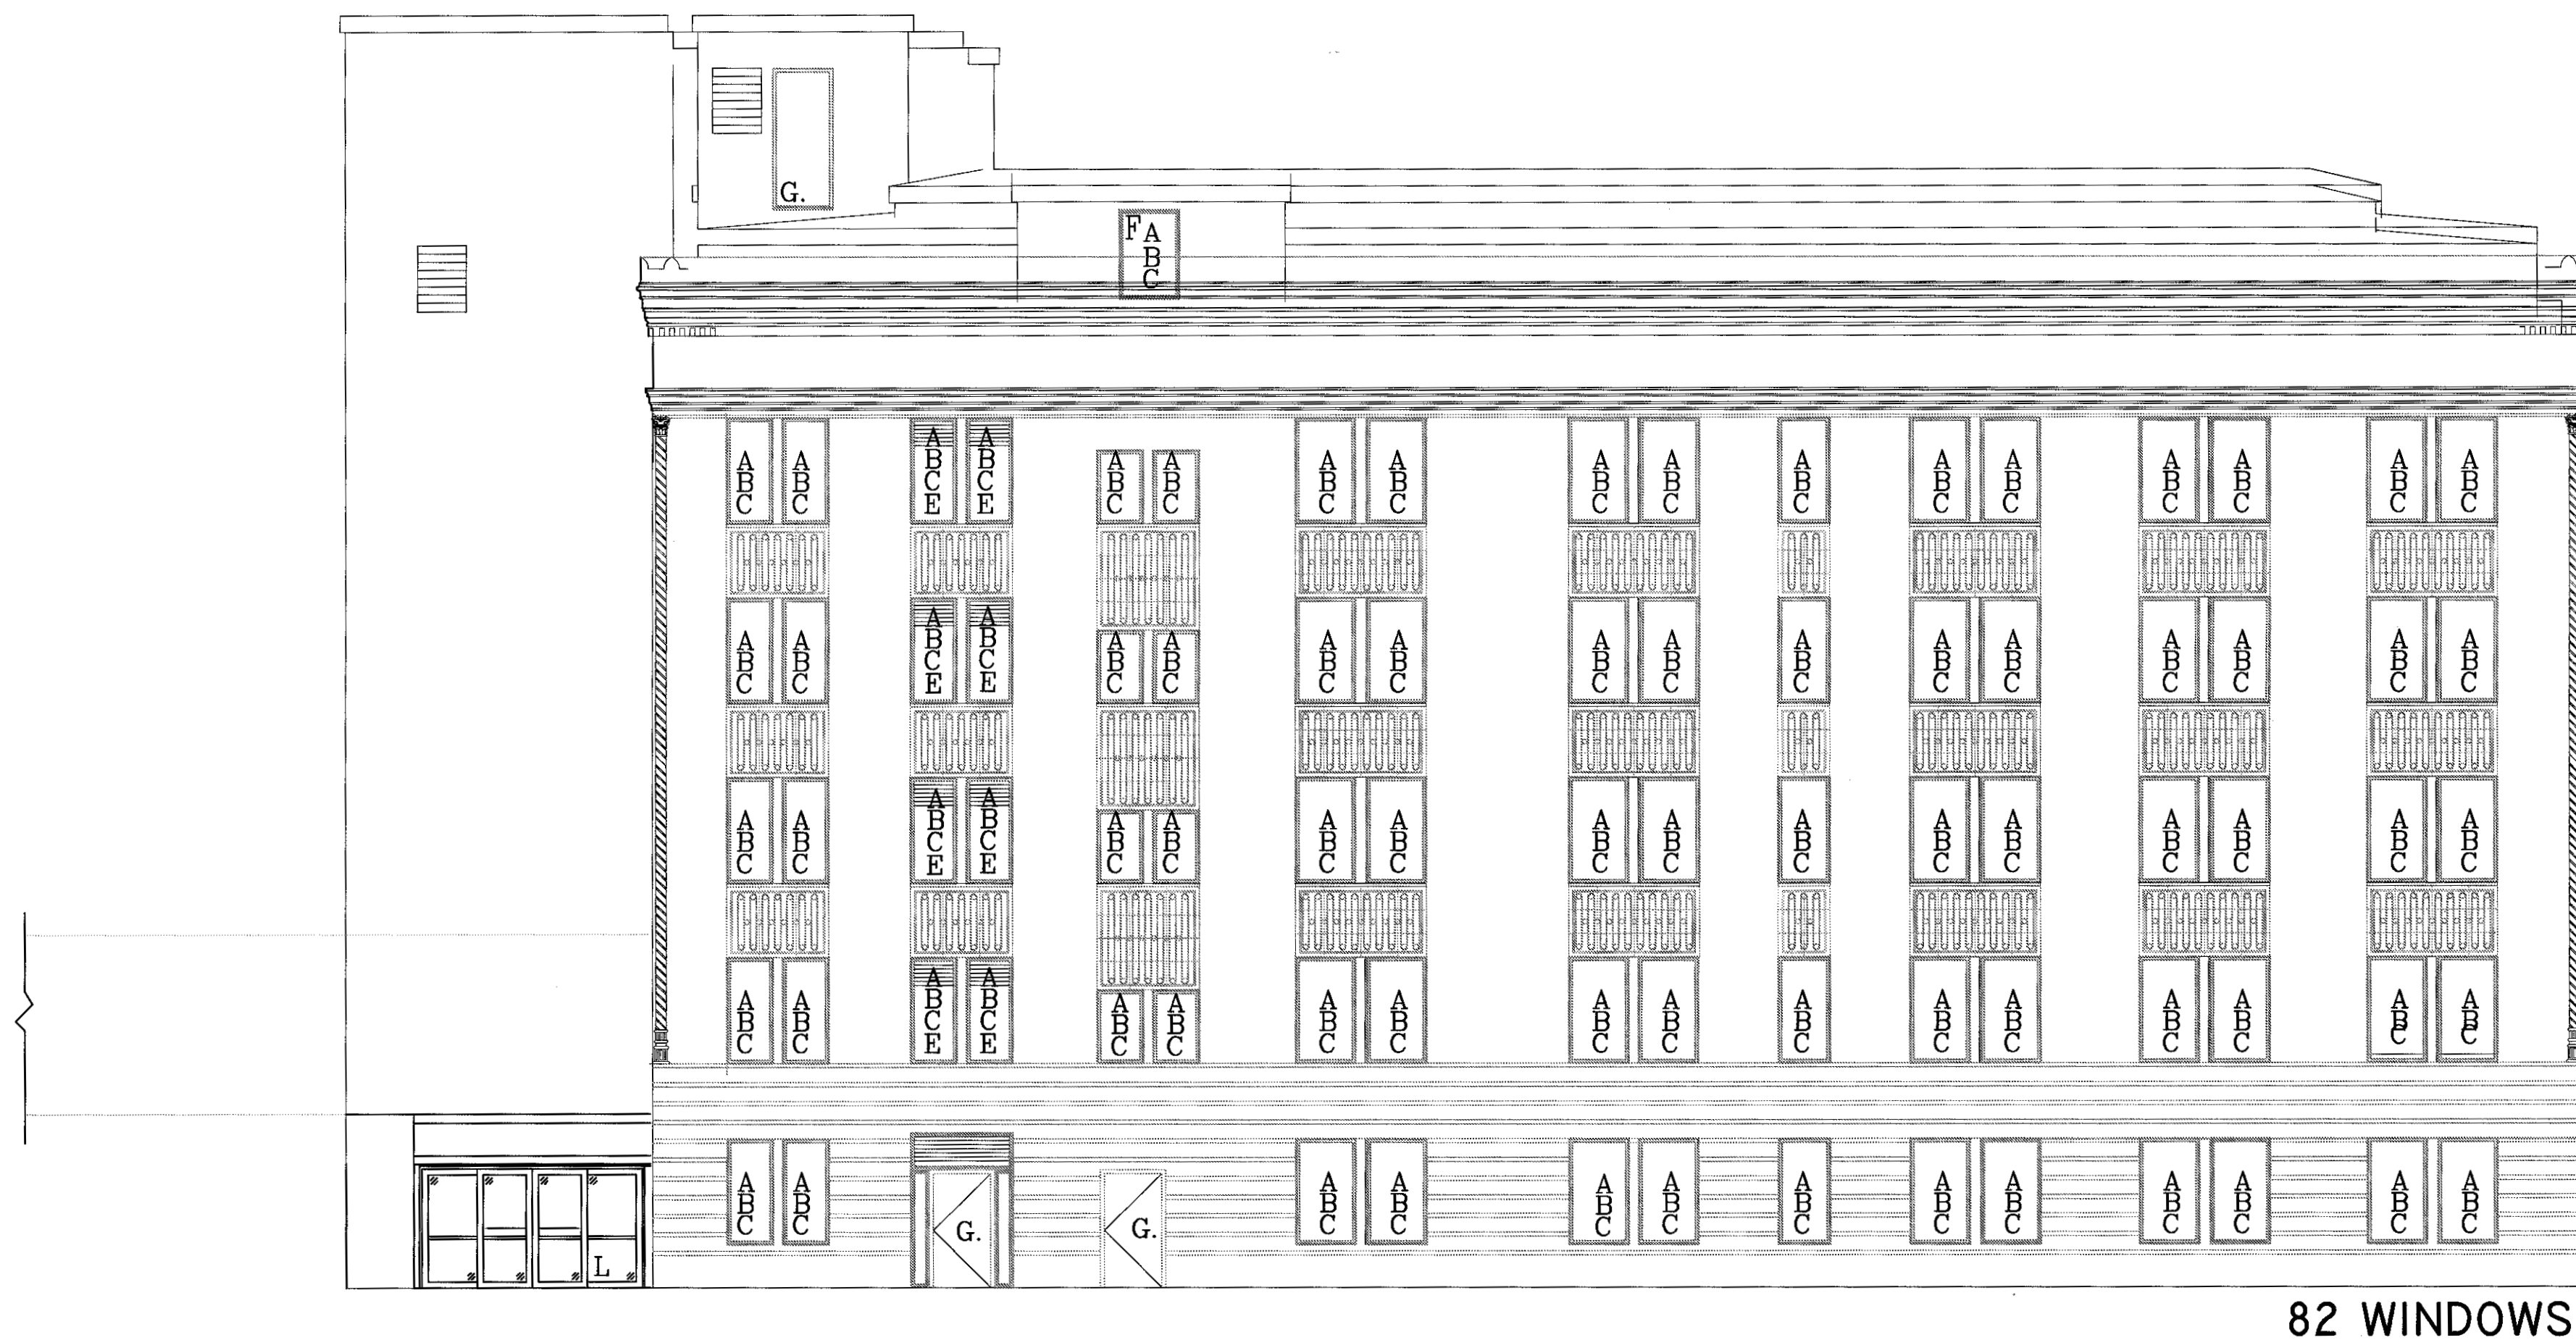

1 BLDG. I A WING SOUTH ELEVATION
AI.2 SCALE: 1/8" = 1'-0"

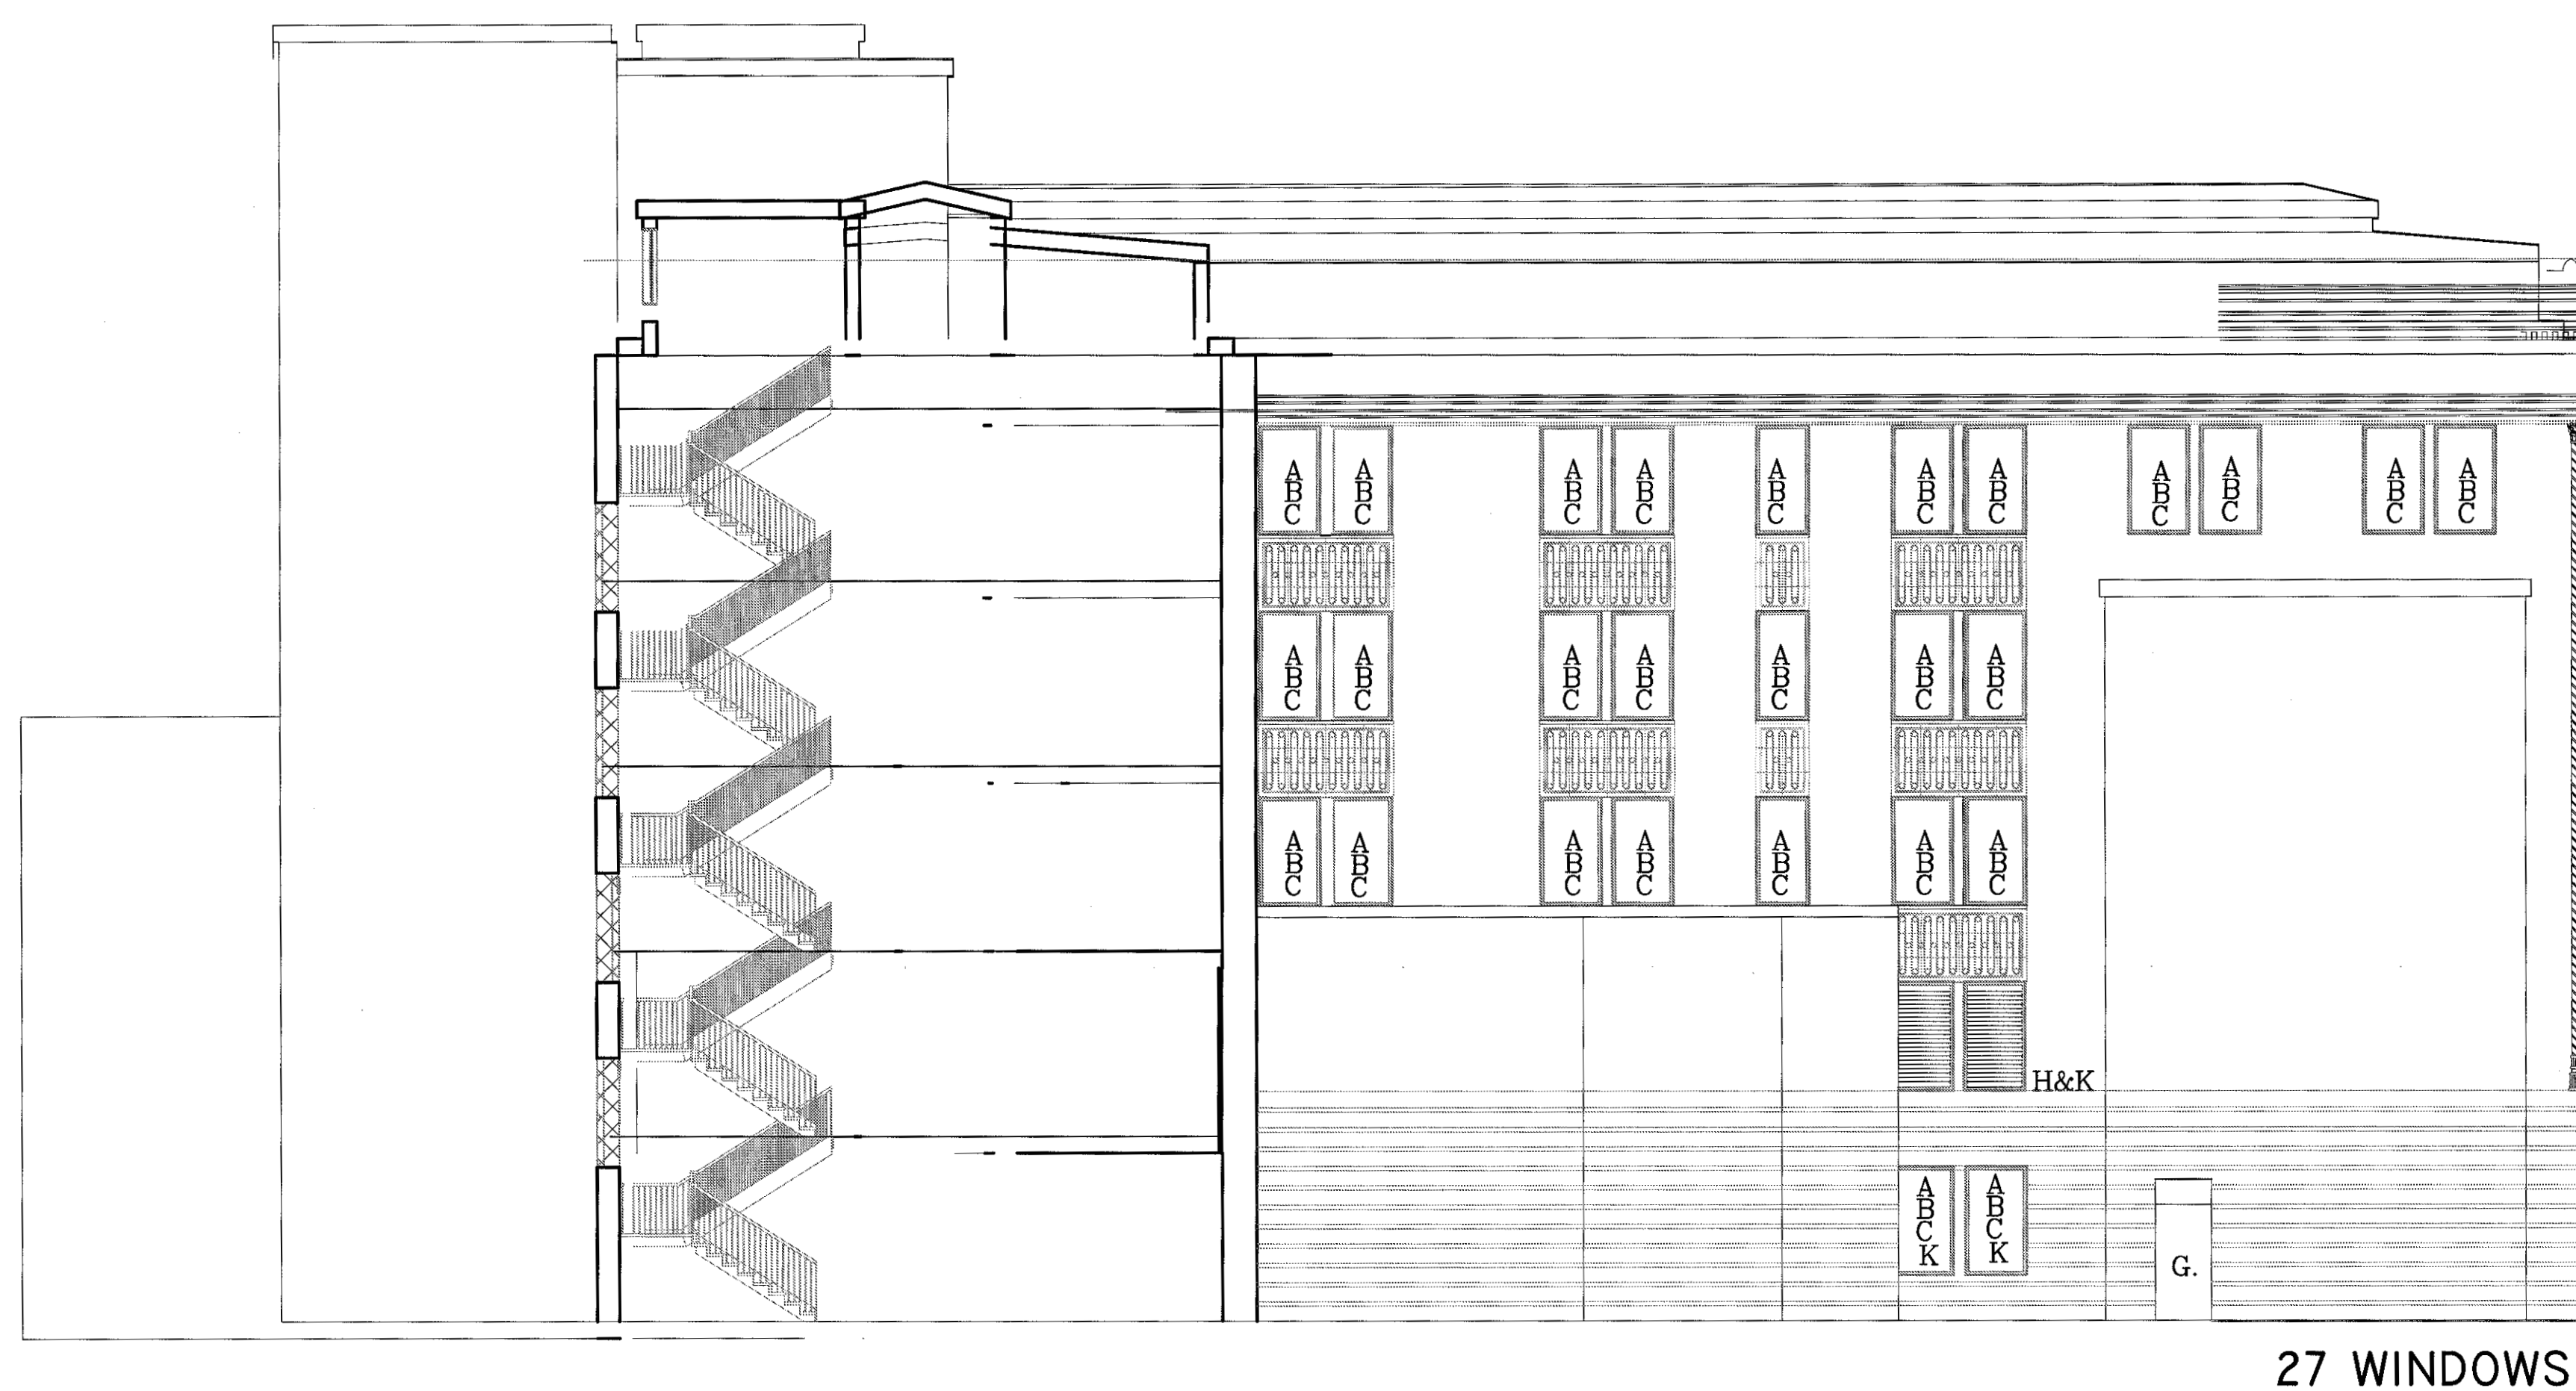

2 BLDG. I B WING SOUTH ELEVATION
AI.2 SCALE: 1/8" = 1'-0"

* NOTE SIZES MUST BE VALIDATED BY THE CONTRACTOR



REMOVE RUST, PRIME, & PAINT LINTELS
LOCATED BY CHAPEL SOUTH B-WING



REPLACE PENTHOUSE WINDOW
A WING SOUTH PENTHOUSE ELEVATION



REPLACE ENTIRE LOUVER
SEE CONSTRUCTION NOTES H
LOCATED BY CHAPEL SOUTH B-WING



CLEAN, PRIME, & PAINT STEEL DOORS
LOCATED SOUTH A-WING



LOUVERS IN WINDOWS ATTACH TO DUCT



REMOVE LARGE WINDOW FRAME COMPLETELY
LOCATED NEAR CHAPEL SOUTH B-WING



VIEW OF A-WING SOUTH SIDE



PAINT DOOR & RAILINGS
SEE CONSTRUCTION NOTES G
LOCATED SOUTH A-WING


ENVIRONMENTAL CONSIDERATIONS

- REMOVE ALUMINUM WINDOW BUT LEAVE HEAD JAMB AND SILL IN PLACE FOR ALL WINDOWS.
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- KEEP WINDOW FRAMES THAT ARE COVERED WITH ALUMINUM IN PLACE & WRAP THOSE . INTERIOR WOOD MOLDINGS WITH ALUMINUM PANNING WHEN POSSIBLE FOR ALL WINDOWS.
- THE BUILDING WILL REMAIN FULLY FUNCTIONING AS A HOSPITAL DURING CONSTRUCTION.
- CONTRACTOR NEEDS TO OPERATE A SMOKE BARRIER' PROTECTION FOR ALL LEVELS.
- CONTRACTOR NEED TO PROVIDE BINS FOR RECYCLABLES, DISPOSE DEBRIS DAILY OFF OF PROPERTY, & PROTECT PLANTS & VEGETATION FROM DAMAGE.
- CONTRACTOR NEEDS TO FILE HAZARDS LOG DAILY.

CONSTRUCTION NOTES

- REMOVE RUST, CLEAN, PRIME, AND PAINT STEEL WINDOW LINTELS
- INSTALL NEW BLAST-RESISTANT ENERGY EFFICIENT .30 U VALUE PAINTED ALUMINUM WINDOWS.
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- REMOVE RUST PRIMER & ALKYD PAINT STEEL DOOR, STAIRS AND HAND RAILINGS.
- REMOVE & INSTALL NEW ALUMINUM LOUVER PAINT FINISH TO MATCH WINDOWS.
- FOR THE RESTROOM, KEEP DUCT THROUGH SPANDREL & GALVANIZE THE DUCT. THE DUCT REQUIRES A UNIQUE FIT THROUGH THE NEW PAINTED ALUMINUM WINDOW.
- REMOVE EXSTG. SMALL STEEL WINDOW REPLACE WITH ALUMINUM FIXED WINDOW.
- REMOVE HEAVY GAGE STEEL FRAME & INSTALL NEW ALUMINUM WINDOWS WITH 3" PANNING THE PANNING SHOULD MATCH THE WINDOWS.
- INSTALL NEW BLAST-RESISTANT LAMINATE COATING ON THE REAR STOREFRONT OF A-WING.

LEGEND

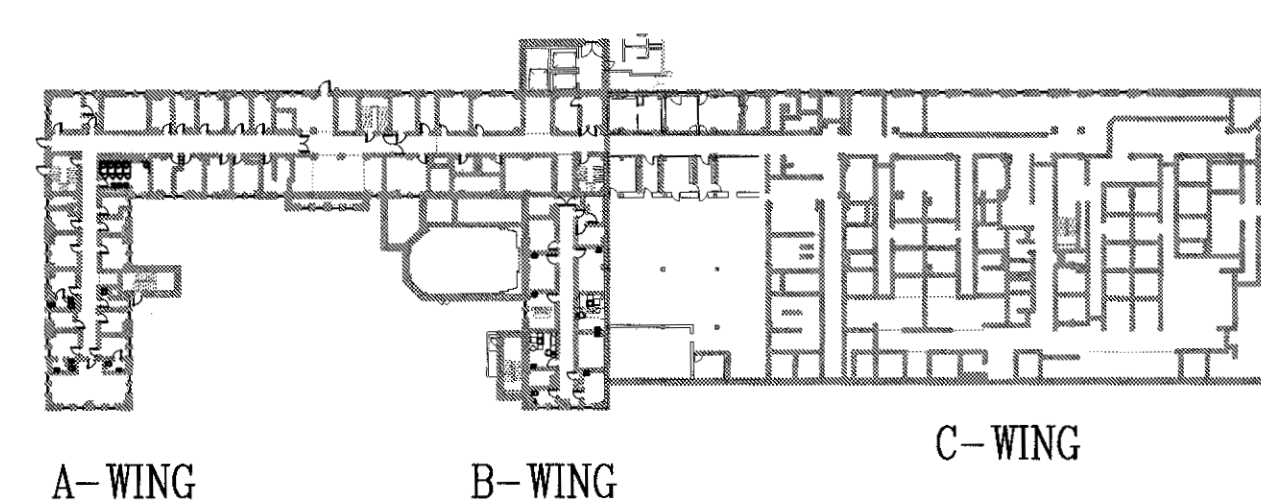

REVISIONS:	DATE:	Dept. of Veterans Affairs Jack C. Montgomery Medical Center 1011 Honor Height Drive Muskogee, Oklahoma 74401		APPROVED:	APPROVED: President A.F.G.E. 2250	APPROVED: Energy Engineer	APPROVED: Medical Center Director	DRAWING TITLE	PROJECT TITLE	DATE
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				APPROVED:	APPROVED:	APPROVED: Industrial Hygienist	APPROVED: Chief of Engineering Service	BUILDING NO. Building #1	AUTOCAD FILE NAME 62312102A1.2	DWG. 4 OF 31
								DESIGNED BY PROUD VETERANS	DRAWN BY NTG	Department of Veterans Affairs
								CHECKED BY BW		



BLDG. I A & B WING WEST ELEVATION
SCALE: 1/8" = 1'-0"



REMOVE & REPLACE FIVE SMALL STEEL WINDOWS
WEST VIEW OF A-WING



REMOVE & REPLACE THREE WINDOWS
IN ELEVATOR SHAFT WEST VIEW OF B-WING

ENVIRONMENTAL CONSIDERATIONS

- REMOVE ALUMINUM WINDOW BUT LEAVE HEAD JAMB AND SILL IN PLACE FOR ALL WINDOWS.
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- REMOVE WALL EXHAUSTER. INSTALL NEW WINDOW WITH INTEGRATED LOUVER. INSTALL CEILING EXHAUSTER INSTALL DUCT FROM EXHAUSTER TO INTEGRATED WINDOW LOUVER.
- INSTALL TWO NEW BLAST-RESISTANT THERMAL PANE .37 U VALUE PAINTED ALUMINUM WINDOWS IN PENTHOUSE/ ELEVATOR TOWER.
- REMOVE RUST, PRIME, & USE ALKYD PAINT ON STEEL DOOR, STAIRS & HAND RAILINGS.
- FOR THE RESTROOMS LOCATED ON THE 2ND FLOOR NEAR THE ELEVATOR, KEEP DUCT THROUGH SPANDREL, GALVANIZE THE DUCT, & INSTALL OPAQUE SPANDREL GLAZING.
- ON THE 2ND FLOOR OF B-WING, A PARAPET WALL PROTRUDES IN FRONT OF THE 3RD WINDOW.
- REMOVE EXSTG. SMALL STEEL WINDOW REPLACE WITH ALUMINUM FIXED WINDOW.
- INSTALL NEW BLAST-RESISTANT LAMINATE COATING ON A-WING REAR STOREFRONT. REMOVE & INSTALL NEW HEAVY GAGE BLAST RESISTANT STOREFRONT SLIDER DOORS.
- WHEN INSTALLING NEW PAINTED ALUMINUM WINDOWS, INSTALL WATER TIGHT FLASHING & REPAIR DAMAGE CEMENT PLASTER.
- ELECTRIC CONDUITS WHICH LAY ACROSS WINDOW HINDERS CONSTRUCTION



REMOVE & REPLACE TWO WINDOW EXHAUSTERS
SEE CONSTRUCTION NOTE H.
LOCATED ON THE 2ND FLOOR OF A-WING
NEAR THE ELEVATORS ABOVE THE ENTRANCE



VIEW SHOWS CONNECTING HALLWAY BETWEEN
THE TWO BUILDINGS



REPLACE TWO WINDOWS IN ELEVATOR TOWER
SEE CONSTRUCTION NOTE F.
WEST VIEW OF B-WING




REPLACE EXSTG. SMALL STEEL WINDOW.
SEE CONSTRUCTION NOTE J.


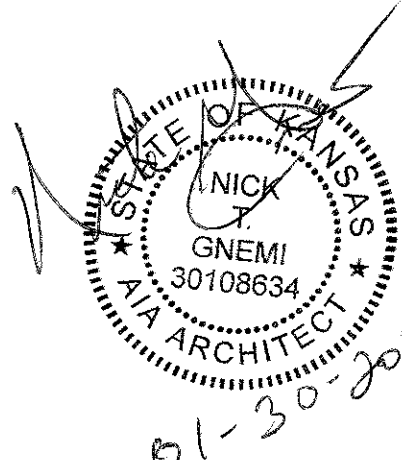


ELECTRIC CONDUITS LAY ACROSS WINDOW
HINDERS THE CONSTRUCTION PROCESS
ALSO REMOVE RUST, PRIME, & PAINT DOOR
SEE CONSTRUCTION NOTE M.



ROOF PROTRUDES IN FRONT OF STAIRWELL WINDOW
HINDERS THE CONSTRUCTION PROCESS
WEST VIEW OF B-WING

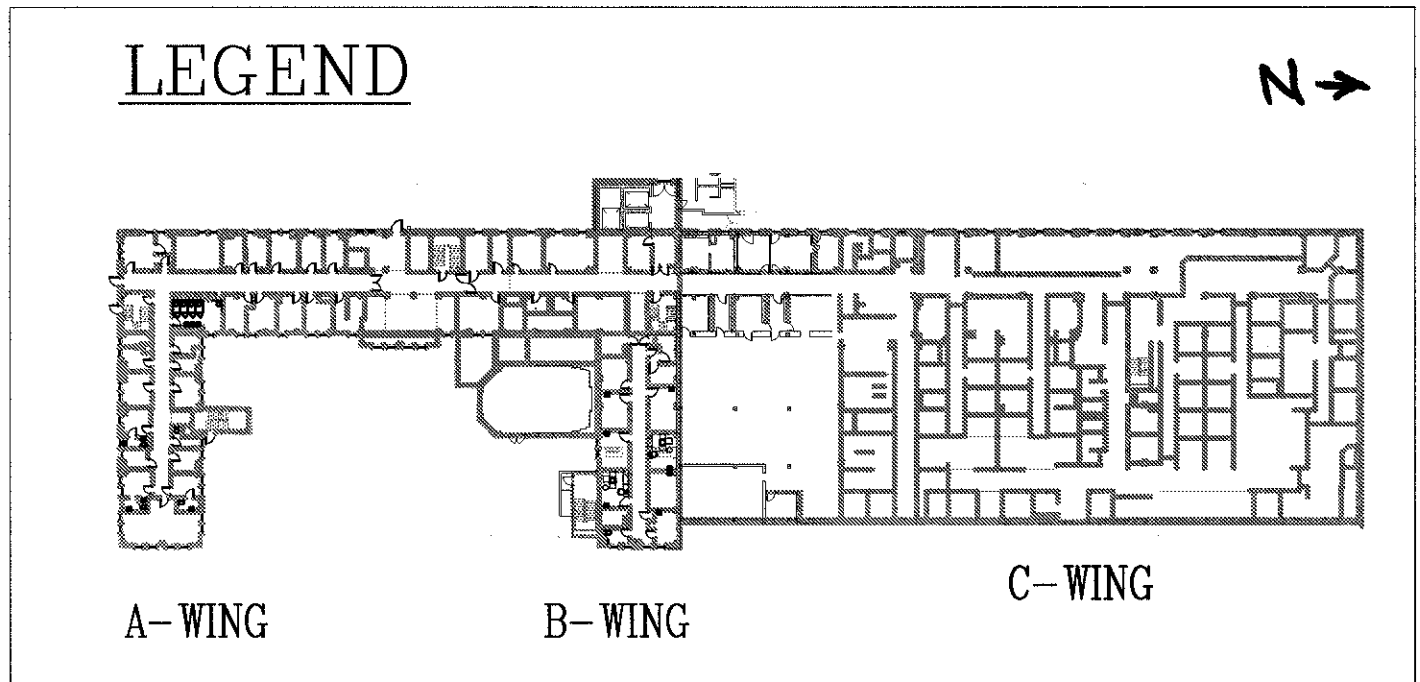

REVISIONS:	DATE:	 Dept. of Veterans Affairs Jack C. Montgomery Medical Center 1011 Honor Height Drive Muskogee, Oklahoma 74401		APPROVED:	APPROVED: President A.F.G.E. 2250	APPROVED: Energy Engineer	APPROVED: Medical Center Director	DRAWING TITLE	PROJECT TITLE	DATE	
				APPROVED:	APPROVED:	APPROVED: Safety Manager	APPROVED: Associate Director	A & B WING WEST ELEVATION	REPLACE WINDOWS BUILDING #1	27 DECEMBER 2012	
				APPROVED:	APPROVED:	APPROVED: Infection Control Nurse	APPROVED: Chief of Staff	PROJECT NO. 623-12-102	CONTRACT NO. VA256612C0232	SCALE: 1/8" = 1'-0"	
				APPROVED:	APPROVED:	APPROVED: Industrial Hygienist	APPROVED: Chief of Engineering Service	AUTOCAD FILE NAME: 62312102A1.4	DESIGNED BY: PROUD VETERANS	DRAWN BY: JA	CHECKED BY: NTG
								BUILDING NO. Building #1	LOCATION Jack C. Montgomery VA Medical Center	DRAWING NO. A1.4	DWG. 6 OF 31

Department of Veterans Affairs



REMOVE 3 COURSES OF BRICK & REPLACE WINDOW LOCATED ON C-WING. SEE DETAIL 2/A1.5



REMOVE 3 COURSES OF BRICK & REPLACE WINDOW LOCATED ON C-WING. SEE DETAILS 2/A1.5





REMOVE 3 COURSES OF BRICK & REPLACE WINDOW LOCATED ON C-WING. SEE DETAILS 2/A1.5



REMOVE 3 COURSES OF BRICK & REPLACE WINDOW LOCATED ON C-WING. SEE DETAL 2/A1.5




REPAIR INTERIOR WINDOW HEADER THAT HAS WATER DAMAGE LOCATED IN THE WAITING ROOM

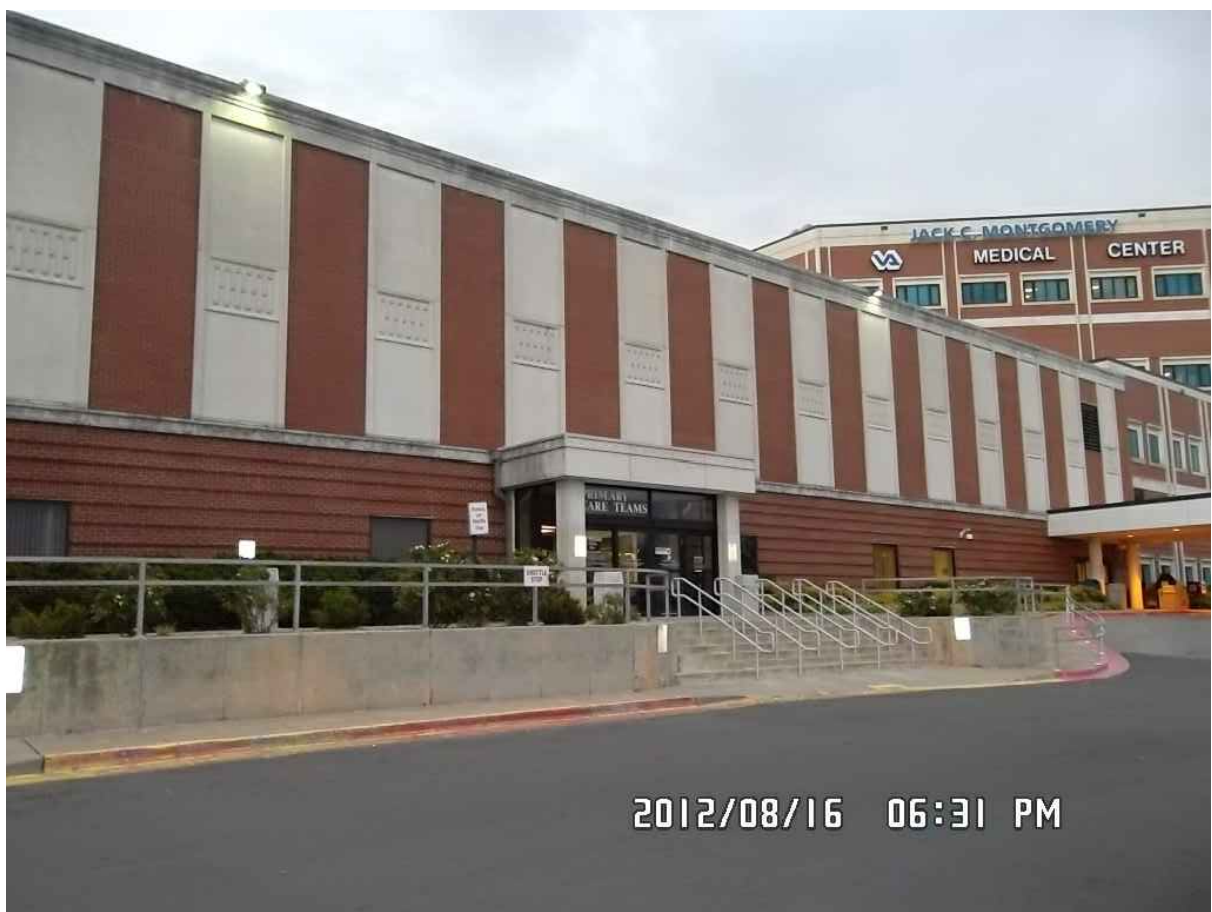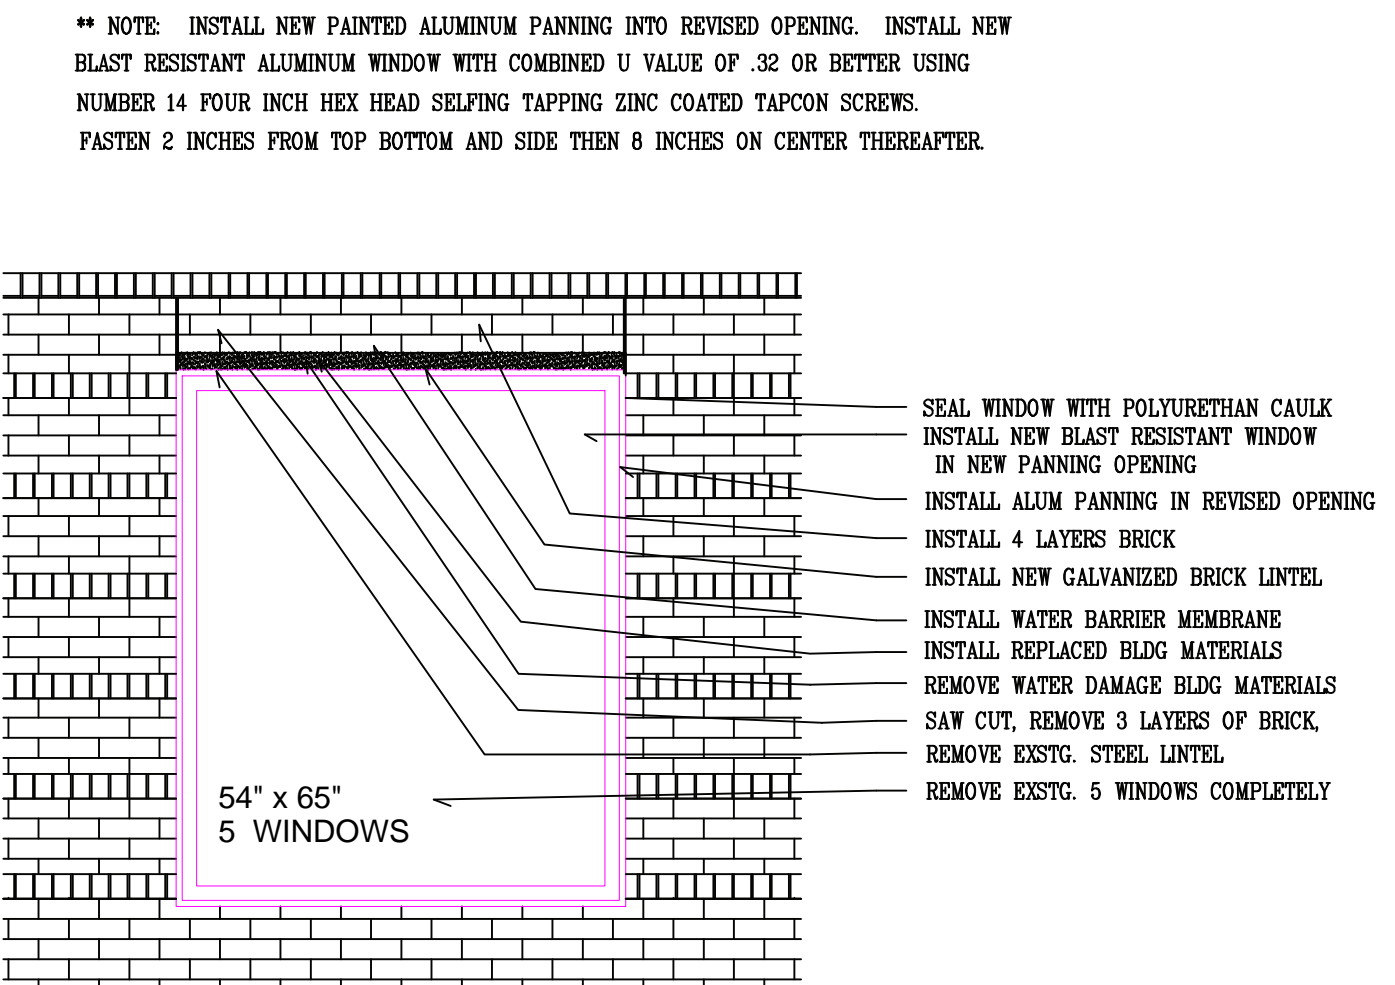

REPLACE PRIMARY CARE STOREFRONT ENTRANCE C WING EAST ELEVATION SOUTH END



DO NOT DISTURB THE VEGETATION DURING CONSTRUCTION C WING EAST ELEVATION. SEE CALLOUTS 5

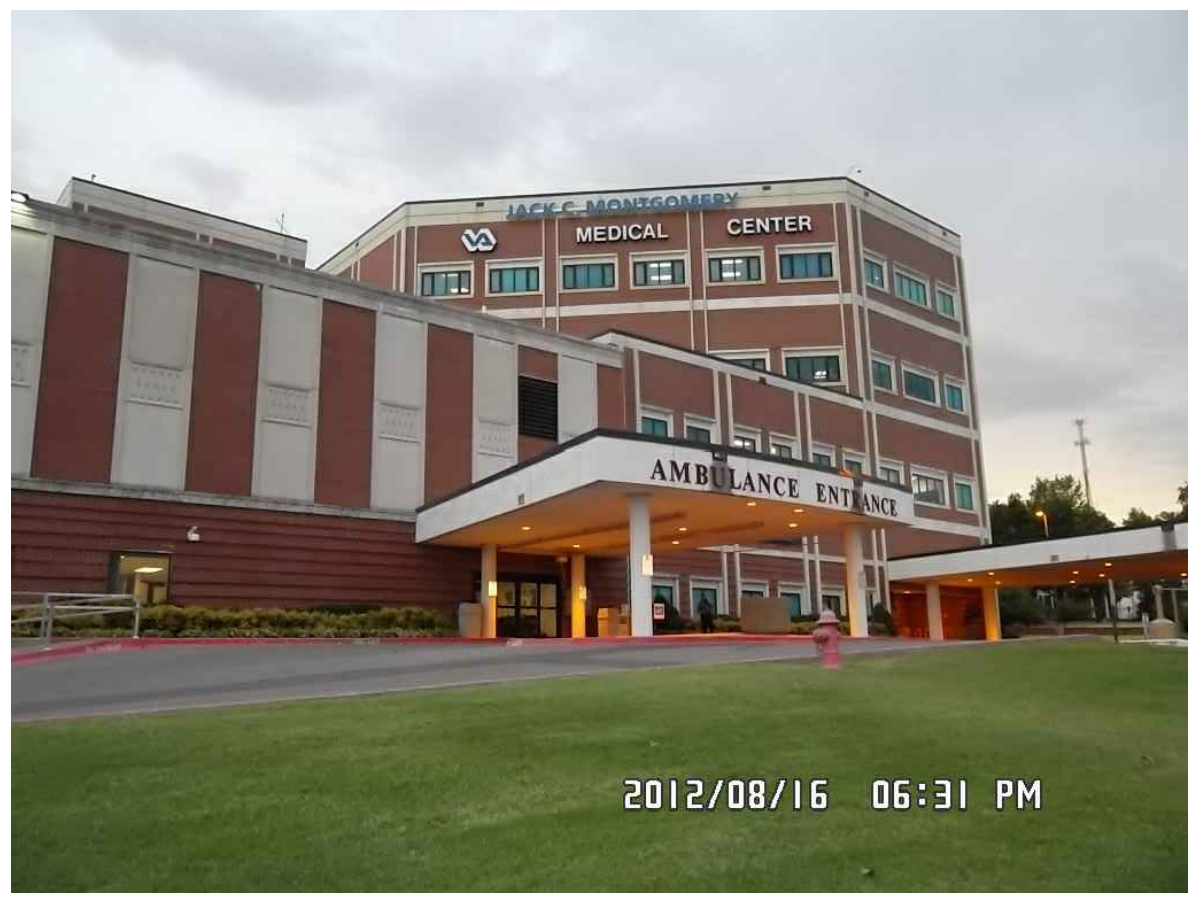


REPLACE EMERGENCY STOREFRONT ENTRANCE C WING EAST ELEVATION NORTH END

DEMOLITION ELEVATION NOTES

1. REMOVE THREE COURSES OF EXISTING FACE BRICK TO EXPOSE EXISTING LINTEL. INSTALL WATER BARRIER ON WALL & INSTALL THREE WATER EXIT WICKS. INSTALL 4 COURSES OF NEW BRICK, INSTALL NEW GALVANIZED LINTEL. THE LINTEL SHALL BE PAINTED TO MATCH THE NEW WINDOW COLOR. ON INTERIOR REPLACE WATER DAMAGE SHEETROCK WITH DURAROCK CEMENT BOARD. USE TAPPING COMPOUND & FINISH SMOOTH WITH INTERIOR PAINT.
2. REPLACE 5 EXISTING WINDOWS WITH NEW BLAST RESISTANT WINDOW OF .32 U VALUE MIN. ACCORDING TO THE TYPICAL DETAILS, FLASHING, WEEP HOLES, & CAULKING AS REQUIRED. REMOVE ANY DAMAGED INDIVIDUAL FACE BRICK WITH NEW FACE BRICK THAT MATCH THE EXISTING BRICK IN COLOR & TEXTURE OR FROM SALVAGED BRICK.
3. REPLACE THREE EXISTING STOREFRONTS WITH NEW BLAST RESISTANT STOREFRONT ACCORDING TO THE MANUFACTURES TYPICAL DETAILS, FLASHING, & CAULKING AS REQUIRED. SEE STOREFRONT DRAWINGS & DETAILS ON DRAWING SHEET A8.3 PAGE 27 OF 32.
4. REMOVE RUST, PRIMER AND PAINT STEEL DOORS ON 4th FLOOR C WING PENTHOUSE 3 DOUBLE DOORS AND 1 SINGLE DOOR.
5. DURING CONSTRUCTION MINIMIZE DISTURBANCE OF SHRUBBERY, FLOWERS, & PLANT LIFE IF ANY PLANT LIFE GETS DESTROYED, IT MUST BE REPLACED. SMOKING IS PROHIBITED NEAR ANY ENTRANCES OR EXITS.

2 EAST C WING WINDOW REPLACEMENT


AI.5 SCALE: 1/2" = 1'-0"

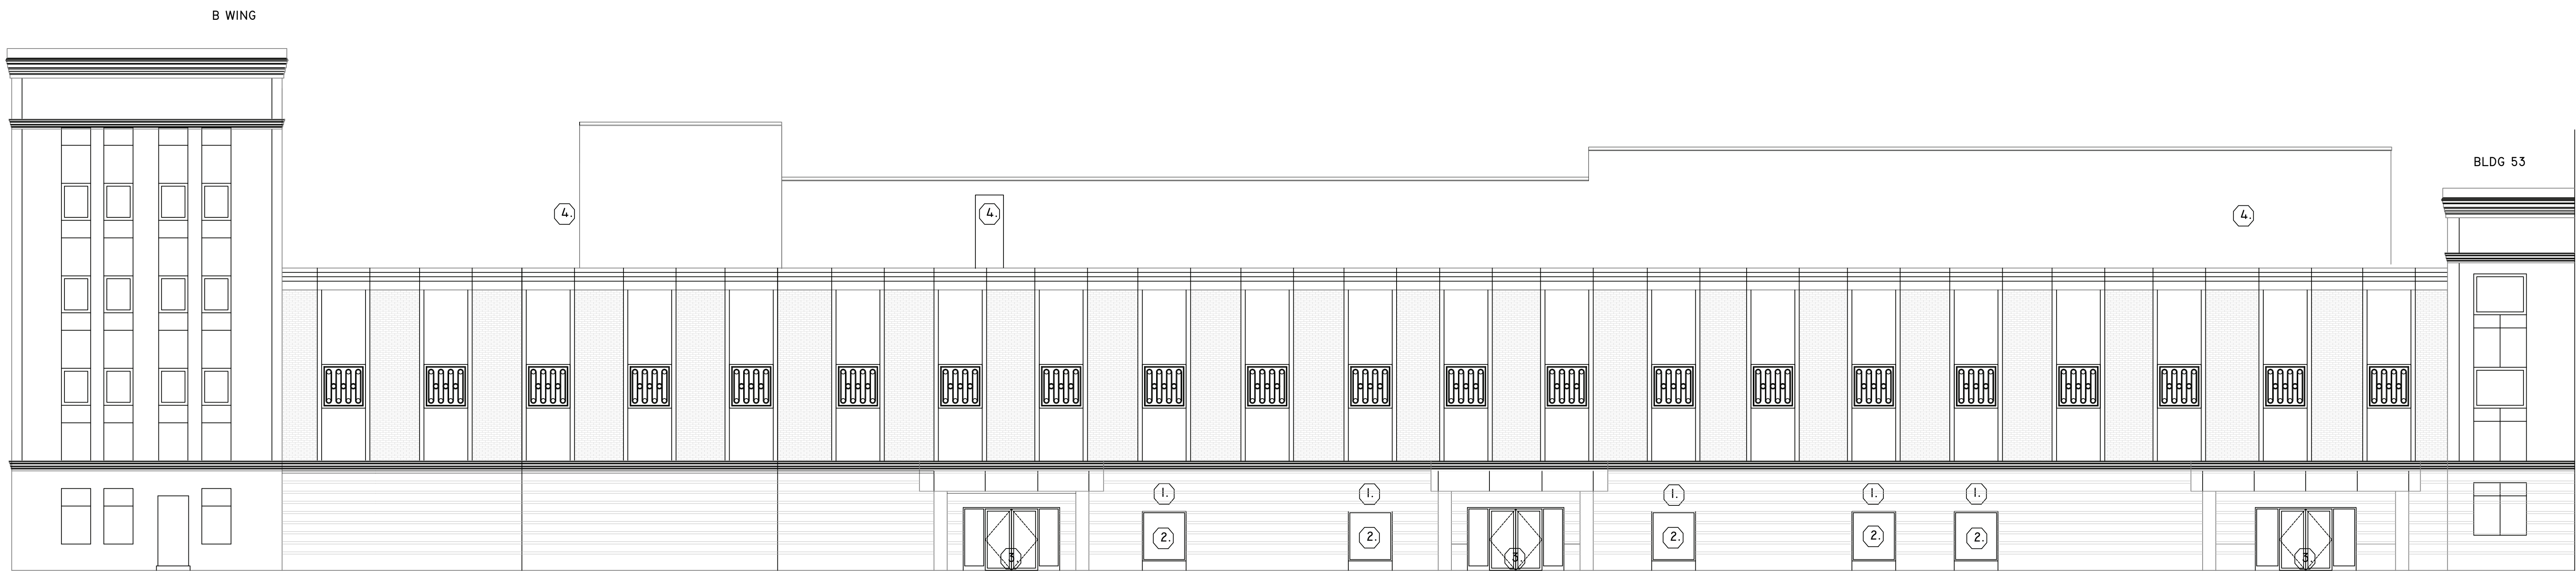


1 BLDG. 1 C WING EAST ELEVATION

AI.5 SCALE: 1/8" = 1'-0"

5 WINDOWS 54" X 65"

REVISIONS:	DATE:	<div></div> <div>Dept. of Veterans Affairs Jack C. Montgomery Medical Center 1011 Honor Height Drive Muskogee, Oklahoma 74401</div>	APPROVED:	APPROVED: President A.F.G.E. 2250	APPROVED: Energy Engineer	APPROVED: Medical Center Director	DRAWING TITLE		PROJECT TITLE			DATE	Department of Veterans Affairs
DETAIL 2/A1.5 ADDED	23 MAY 2013		APPROVED:	APPROVED:	APPROVED: Safety Manager	APPROVED: Associate Director	BLDG 1 C WING EAST ELEVATION		REPLACE WINDOWS BUILDING #1			SCALE	
			APPROVED:	APPROVED:	APPROVED: Infection Control Nurse	APPROVED: Chief of Staff	PROJECT NO.	CONTRACT NO.	DESIGNED BY:	DRAWN BY:	CHECKED BY:	DRAWING NO.	
			APPROVED:	APPROVED:	APPROVED: Industrial Hygienist	APPROVED: Chief of Engineering Service	BUILDING NO.	AUTOCAD FILE NAME:	LOCATION			<div>A1.5A</div>	
							Building #1	62312102A1.5	Jack C. Montgomery VA Medical Center			DWG. 7 OF 31	

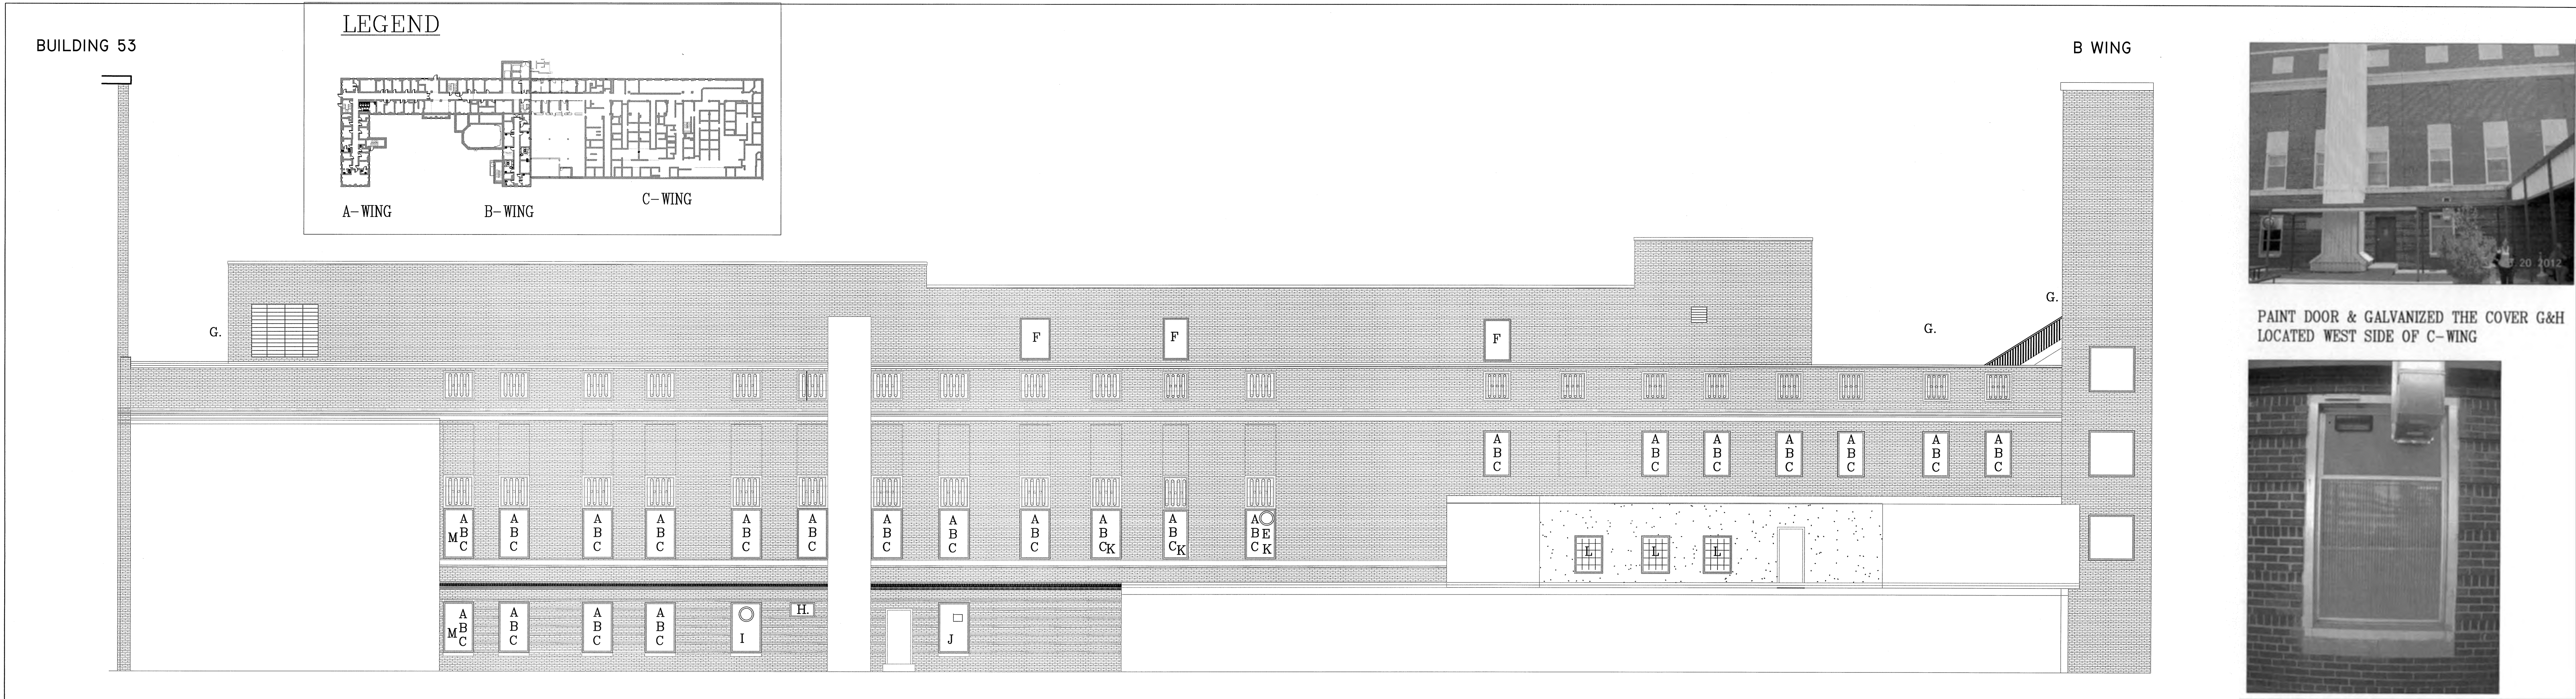

C WING WEST ELEVATION


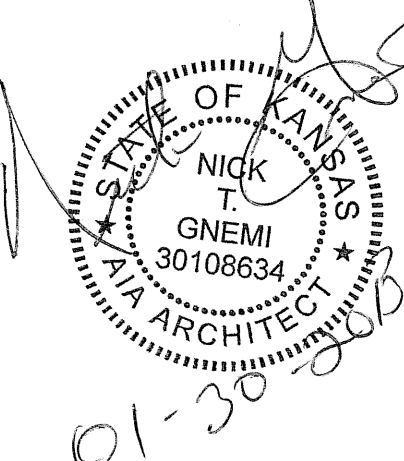
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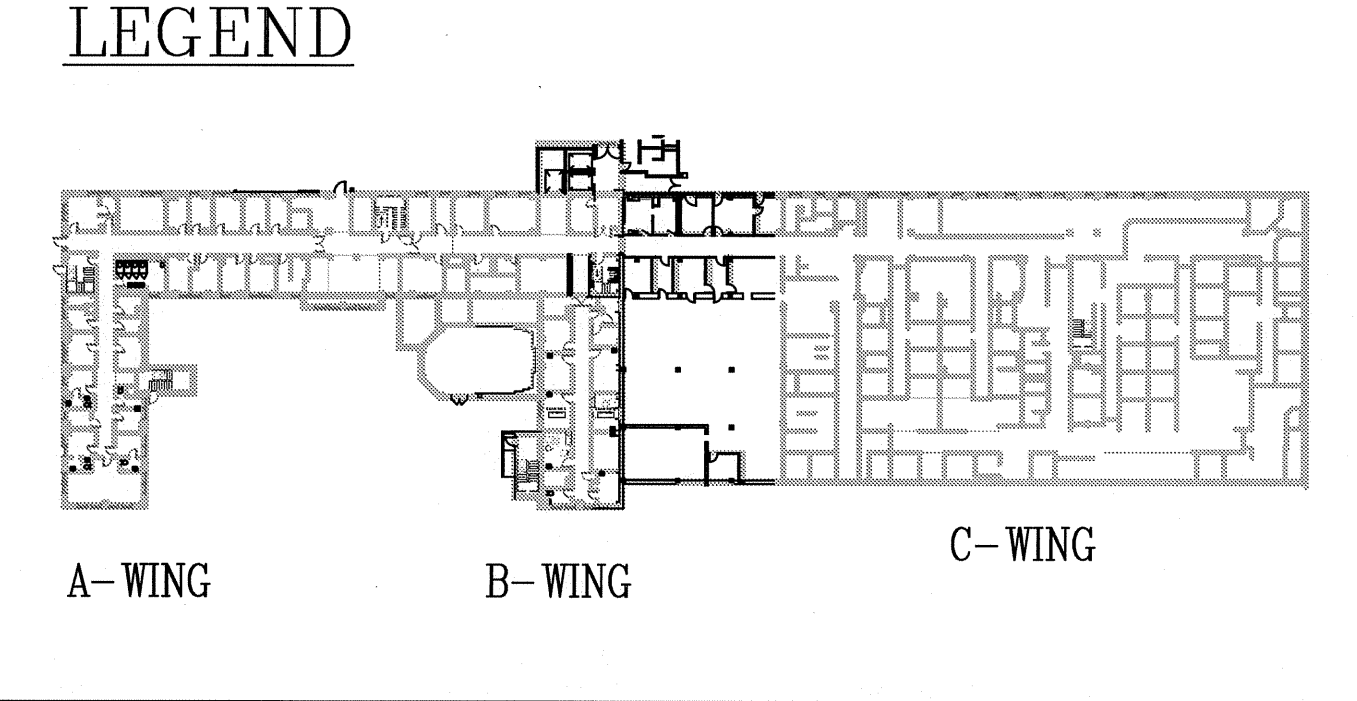
ENVIRONMENTAL CONSIDERATIONS

- I. REMOVE ALUMINUM WINDOW BUT LEAVE HEAD JAMB & SILL IN PLACE FOR ALL WINDOWS.
- II. REMOVE & DISPOSE THE TRANSIT PANEL, WHICH IS FREE FROM ANY FRIABLE ASBESTOS.
- III. TAKE CAUTION OF ORIGINAL WOOD WINDOWS & INTERIOR TRIM. THE WOOD HAS BEEN PAINTED WITH LEAD BASED PAINT. CAREFULLY DISPOSE THE WOOD IN A DOUBLE BAG.
- IV. KEEP WINDOW FRAMES THAT ARE COVERED WITH ALUMINUM IN PLACE & WRAP THOSE INTERIOR WOOD MOLDINGS WITH ALUMINUM PANNING WHEN POSSIBLE FOR ALL WINDOWS.
- V. THE BUILDING WILL REMAIN FULLY FUNCTIONING AS A HOSPITAL DURING CONSTRUCTION.
- VI. CONTRACTOR NEEDS TO OPERATE A SMOKE BARRIER' PROTECTION FOR ALL LEVELS.
- VII. CONTRACTOR NEED TO PROVIDE BINS FOR RECYCLABLES, DISPOSE DEBRIS DAILY OFF OF PROPERTY, & PROTECT PLANTS & VEGETATION FROM DAMAGE.
- VIII. CONTRACTOR NEEDS TO FILE HAZARDS LOG DAILY.

CONSTRUCTION NOTES

- A. REMOVE RUST, CLEAN, PRIME, AND PAINT STEEL WINDOW LINTELS
- B. INSTALL NEW BLAST-RESISTANT ENERGY EFFICIENT .30 U VALUE PAINTED ALUMINUM WINDOWS.
- C. INSTALL NEW WATER RESISTANT SHEETROCK FROM WALL TO WINDOW. FINISH COMPLETELY WITH LATEX PRIME & SHERWIN WILLIAMS PROM MAR 200 LATEX PAINT & INSTALL BLAST CLIP & TRIM.
- D. DISPOSE OF EXISTING WINDOW BLINDS OR SHADES AND INSTALL NEW WINDOW TREATMENTS FOR ALL WINDOW TYPES EXCEPT STAIRWELLS.
- E. REMOVE WALL EXHAUSTER. INSTALL NEW WINDOW WITH INTEGRATED LOUVER. INSTALL CEILING EXHAUSTER INSTALL DUCT FROM EXHAUSTER TO INTEGRATED WINDOW LOUVER.
- F. INSTALL THREE NEW BLAST-RESISTANT THERMAL PANE .37 U VALUE PAINTED ALUMINUM WINDOWS IN PENTHOUSE MECHANICAL ROOM.
- G. REMOVE RUST PRIMER & ALKYD PAINT STEEL DOOR, STAIRS AND HAND RAILINGS.
- H. PRIME & USE GALVANIZED PAINT ON THE COVER.
- I. KEEP EXHAUSTER THROUGH SPANDREL IN NEW WINDOW
- J. KEEP DUCT THROUGH SPANDREL IN NEW WINDOW & GALVANIZE THE DUCT.
- K. ADD ALUMINUM FLASHING TO THREE WINDOWS AT THE SILL IN THE PARAPET AREA.
- L. THREE WINDOWS REQUIRE AN 8" CENTER GRID IN THE THERMAL PANE.
- M. TWO WINDOWS UP AGAINST BUILDING 53.

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				APPROVED:	APPROVED:	APPROVED: Safety Manager	APPROVED: Associate Director			PROJECT NO. 623-12-102	
				APPROVED:	APPROVED:	APPROVED: Infection Control Nurse	APPROVED: Chief of Staff	AUTOCAD FILE NAME: 62312102A1.6	LOCATION Jack C. Montgomery VA Medical Center	DRAWING NO. A1.6	
				APPROVED:	APPROVED:	APPROVED: Industrial Hygienist	APPROVED: Chief of Engineering Service			DWG. 8 OF 31	



REMOVE RUST, PRIME, & PAINT DOORS
LOCATED NORTH OF A-WING 100C-1





REMOVE RUST, PRIME, & PAINT DOOR
LOCATED SOUTH OF A-WING 1AS1-1



REMOVE HEAVY GAGE FRAME
LOCATED SOUTH OF A-WING 1B104-L



REMOVE HEAVY GAGE FRAMES
REMOVE RUST, PRIME, & PAINT DOORS
INSTALL NEW CONCRETE PLAQUE
LOCATED EAST OF B-WING 1B104-L

REVIEWS:	DATE:	 Dept. of Veterans Affairs Jack C. Montgomery Medical Center 1011 Honor Height Drive Muskogee, Oklahoma 74401	 STATE OF OKLAHOMA JACK C. MONTGOMERY MEDICAL CENTER 1011 HONOR HEIGHT DRIVE MUSKOGEE, OKLAHOMA 74401	APPROVED:	APPROVED: President A.F.G.E. 2250	APPROVED: Energy Engineer	APPROVED: Medical Center Director	DRAWING TITLE		PROJECT TITLE			DATE
				APPROVED:	APPROVED:	APPROVED: Safety Manager	APPROVED: Associate Director	BUILDING A & B FIRST FLOOR PLAN		REPLACE WINDOWS BUILDING #1			SCALE
				APPROVED:	APPROVED:	APPROVED: Infection Control Nurse	APPROVED: Chief of Staff	PROJECT NO. 623-12-102	CONTRACT NO. VA256612C0232	DESIGNED BY PROUD VETERANS	DRAWN BY ALEX	CHECKED BY NTG	DRAWING NO.
				APPROVED:	APPROVED:	APPROVED: Industrial Hygienist	APPROVED: Chief of Engineering Service	BUILDING NO. Building #1	AUTOCAD FILE NAME: 62312102A.1	LOCATION Jack C. Montgomery VA Medical Center			A2.1 DWG. 9 of 31